
BALTIMORE COUNTY
DEPARTMENT OF PERMITS, APPROVALS & INSPECTIONS
111 WEST CHESAPEAKE AVENUE
TOWSON TOWSON TO The applicant is authorized to affirm that there are no 410-887-3391 current violations at this site pursuant to Section SIGN USE PERMIT 112.7 BCQ Permit Fees are Non-Refundable; Make Check Payable to "Baltimore County, Maryland" Initials\ PROPERTY ADDRESS 825 Duraney Dailey To ZIP CODE 2)204 **ZONING** HISTORIC DISTRICT Yes No PHONE NO. OWNER'S NAME TOWSON TO LL MAILING ADDRESS PO DOX 617905 Ch: Cago IL 60661 APPLICANT/OWNER'S AGENT GODD (Leasther PHONE NO.410-255-6400 PHONE NO. 410 - 255 - 6400 SIGN COMPANY NAME GODILE TAX ACCOUNT NO. 2200 /016 / 232 TYPE OF SIGN: ☐ Window Sign Temporary Signs in the Last Year: ☐ Yes ☒ No Temporary- Including Real Estate/Construction/Event Face Change Only Non-Illuminated Permanent Changeable Copy ☐ Wall Freestanding Pylon Size: feet x feet = Illuminated (separate electrical permit required) Monument square feet Height: feet (freestanding signs) Property Line/Street Right-of-Way Setbacks: front 22, sides 620 and 620, and rear 630. NOTE: A construction plan, drawn to scale and clearly showing that all requirements have been met, must be attached; a site plan also must be attached for freestanding signs. Table of Sign Regulations: 450.4.Attachment 1, 1.- An Electronic Changeable Copy Sign may only have a maximum Frequency of one instantaneous message change per 15 second cycle. 450.6.B.3 Changeable copy signs must operate at a constant intensity and not give the appearance of movement by flashing, blinking, strobing, scrolling, oscillating, or alternating lights. PROHIBITIONS: including roof signs (Sections 450.5.B.7 and 450.6.A, Baltimore County Zoning Regulations): Signs cannot impair motorist's clear view of traffic or government signs. All signs are subject to Section 102.5, BCZR. Signs cannot imitate or resemble government signs, except for private traffic control and notice signs. Signs cannot be placed in or project into or above street right of way or governmental property. Sign or framework cannot obstruct window or opening for light and air or access to building, fire hydrant, or stand pipe. Vehicle cannot be parked for the purpose of displaying an attached sign. Except for flags exempted, flags, pennants, ribbons, streamers, tethered balloons, laser projections, and similar objects are prohibited. Portable signs are prohibited, except for A-frame and sandwich board signs issued a use permit in B.M. - C.T. zones. 7. There can be no display or simulation of moving parts or message, except for an outdoor advertising sign with tri-vision, a changeable copy sign, or a thermometer, barometer, weather vane, barber pole, or clock. No sign may emit sound Work Description (including number of signs, special conditions, materials, locations and size): Installation of (6) Six total Freestanding directional Signs 4-double sided 8111/214 = 113 to 12-00 x 7.75-9359.57. 7.33×7-51 sa ft OWNER/AGENT CERTIFICATION I solemnly affirm under the penalties of perjury and upon personal knowledge that the contents of the above are true and further agree to locate the proposed sign such that it will not violate Baltimore County laws and regulations. Signature Require Planning Signature Date Authority under Section 500.4, BCZR PAI Approval (SIGN ONL/Y) Copies: White-Office; Yellow- Applicant (keep this Copy for your permanent records) **REV 10/14** Signature

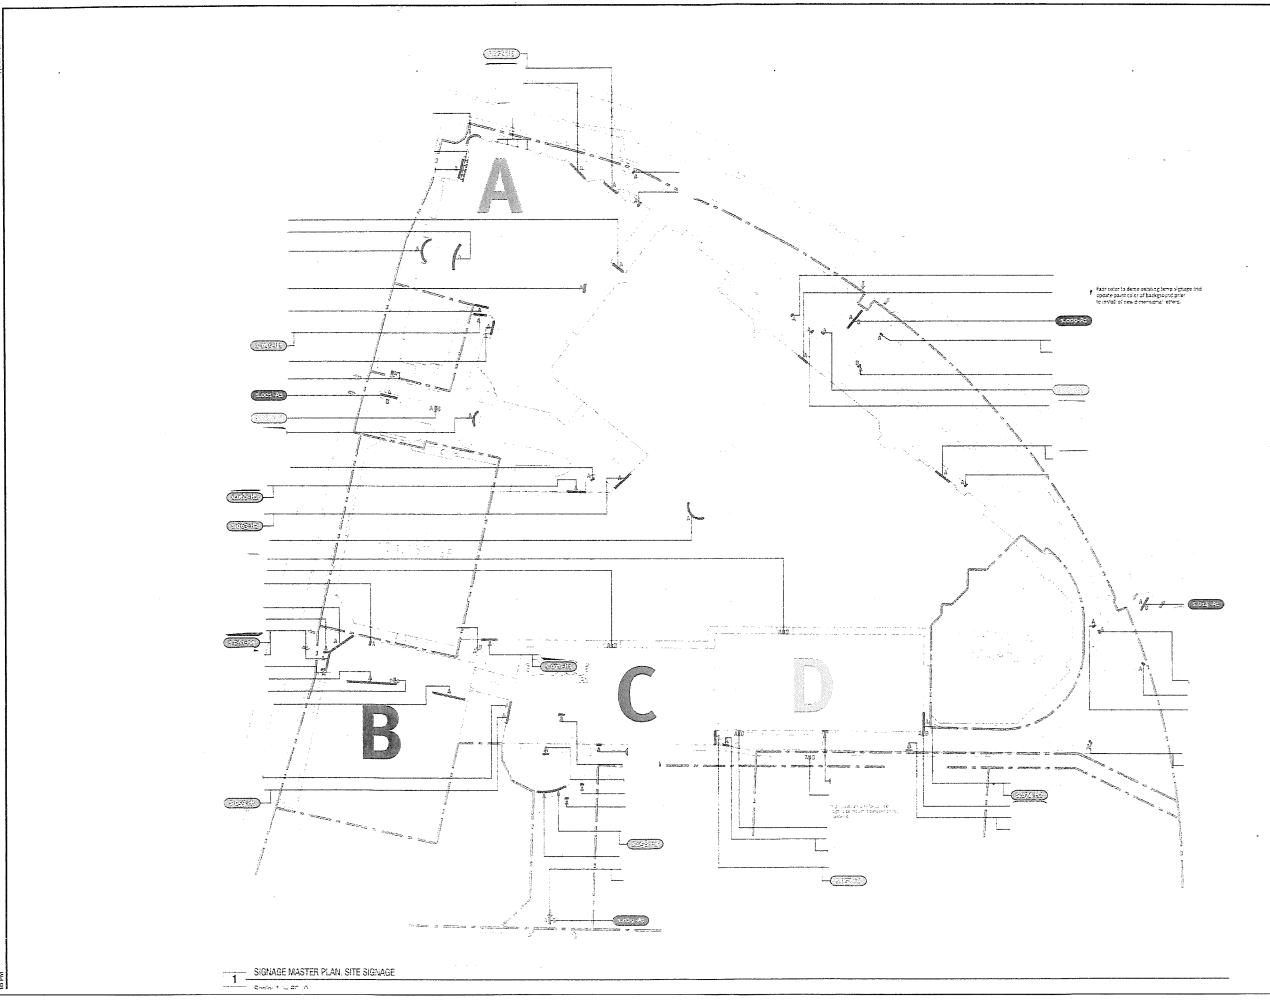

TOWSON TOWN CENTER

825 Dulaney Valley Rd, Towson, MD 21204

> Design Intent For Reference Only

NOT FOR TON

ARROWSTREET ARCHITECTURE & DESIGN

10 POST OFFICE SQUARE
SUITE 700N
BOSTON MA 02109
617.623.5555
WWW.aitowstreel.com


Desired House	40000
Project Number	16035
Author	JH:JG
Checker	
Issue date	01/15/2017

Revisi

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	01/15/2017	Design Intent
7	27-30-77	Debge Intent
2	27-17-17	Design intent
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Drawing Title

SIGNAGE LOCATION PLAN, SITE SIGNAGE

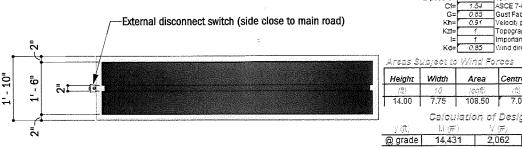

SCALE: 3/8" = 1'

Ultimate Wind Speed=	115	IBC-2012/2015 Ultimate (Blank for IBC 2009 or older)
Normal Wind Speed≃	90]IBC-2009/2012 Nominal
Exposure=	C	open terrain, scattered buildings <30Ft
Cf=	1.54	ASCE 7-05 / ASCE 7-10 Force Coefficient
G=	0.85	Gust Factor
K3h≃	0.91	Velocity pressure Coefficent @ height
K zt=	1	Topographic factor
l=	1	Importance factor
Kd=	0.85	Wind directionality factor
Areas Subject to	Wind Fo	orces

of Cols

Height	Width	Area	Centroid	Wind	Pounds	lbs. Total	TOS
(8)	10	(sqft)	(# <u>1</u>)	(psf)	(05)		
14.00	7.75	108.50	7.0	19	15	1627.5	14

Calculation of Design Forces at Critical Heights

Column Support Design Table								
	Column Type	Column Size	Length	Start Elev	End Elev	Sleeve Depth	\$ act	fb
	(P,TS)		(ft)	(ft)	(ft)	(in)	(in^3)	(ksi)
	P	6"(.280)				N/A	8.50	20.4

Designed Per IBC 2012 MD Edition Designed Per Maryland Building Performance

Snow Loads

Ground Snow Load 20 psf Snow Exposure Factor Snow Load Importance 1s= 1.1 Thermal Factor 1.0

Wind Loads

Gust Factor

Ultimate Design Wind Speed Nominal Design Wind Speed 89.1 mph Risk Cat (3-Sec Peak Gust MPH*) Wind Importance Factor Wind Exposure

Exterior components designed In accordance with applicable provisions of the ASCE 7-10

Gable

A VISUAL SOLUTIONS COMPANY.

7440 Fort Smallwood Road Baltimore, Maryland 21226 410.255.6400

		ectmle: /son Towl	n Center	
		ermle: son Towr	n Center	
٢		state /son, MD		
		ving date /19/17	SALES REP MG	PROJECT MGR. MG
			REVISION HISTORY	
	NO.	DATE	DESCR	RIPTION
il				
		<u> </u>		
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Murdoch Engineering 2 Hummingbird Ct. Howell, New/Jersey 07731 (9,73)-570₁8<u>2</u>15 ee Mwdoch 7127117 lere Murdoch, P.E. Professional Engineer

Maryland P.E. License #41030 PROFESSIONAL CERTIFICATION:

I hereby certify that these documents were prepared or approved by me and that I am a duly licensed professional engineer under the laws of the state of Maryland. License No. 41030, expiration date 8/17/19

initian Contact.

Initian Contacts Concrete
Intacts Concr

Şign Type A1 -D/F Illuminated Site ID. Pylon


≰Construction/Engineering

PROJECT NO. TASK NO.

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W. UNAL

72951-1	1366	647	4	
DWG. NO).		SHEET	
0043MR	0		1 of 3	



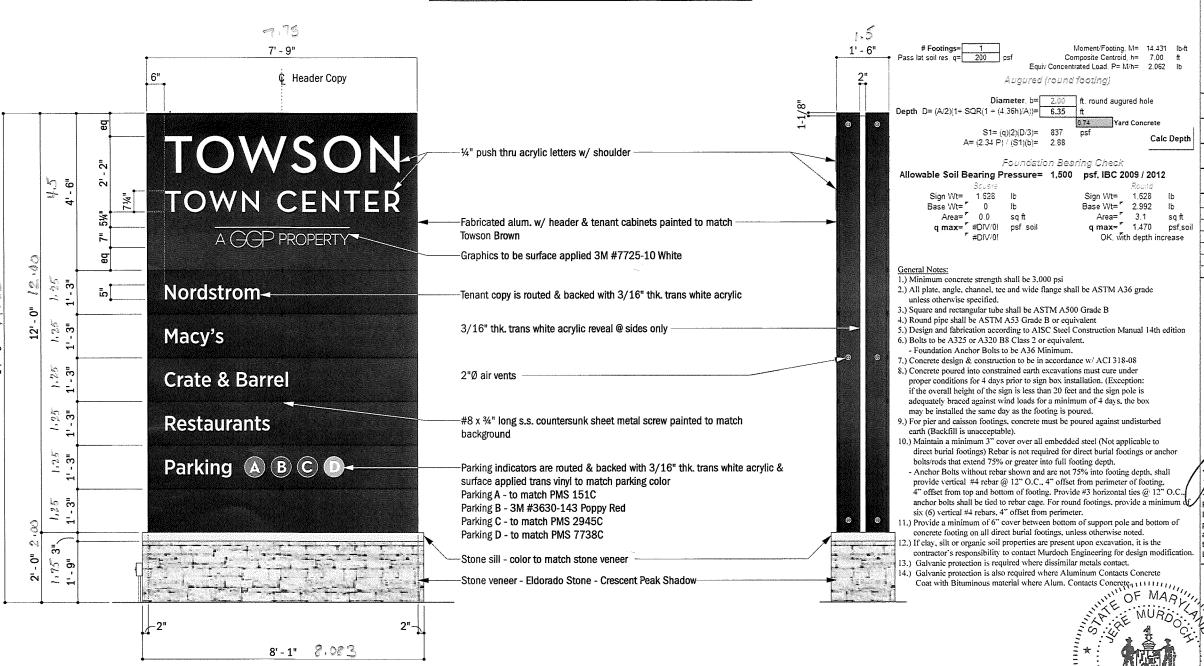



Designed Per Maryland Building Performance Snow Loads Ground Snow Load Snow Exposure Factor 20 psf 1.0 Snow Load Importance


Designed Per IBC 2012 MD Edition

1.1 Thermal Factor

Wind Loads

Ultimate Design Wind Speed 115 mph Nominal Design Wind Speed 89.1 mph Risk Cat (3-Sec Peak Gust MPH*) Wind Importance Factor Wind Exposure 0.85

Exterior components designed In accordance with

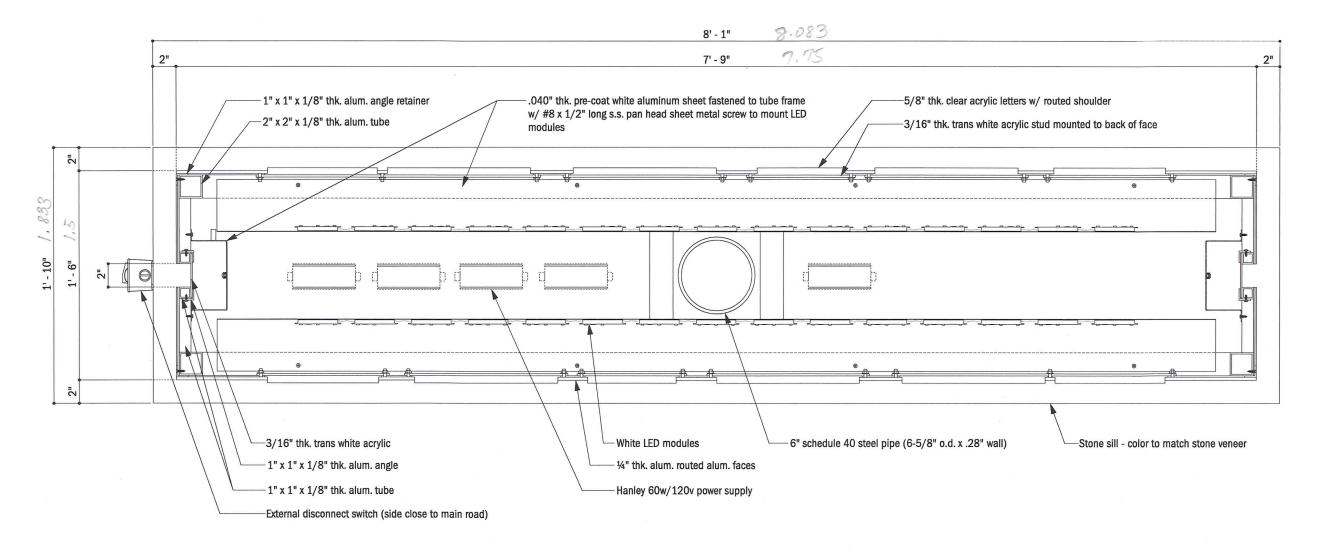





A VISUAL SOLUTIONS COMPANY.

7440 Fort Smallwood Road Baltimore, Maryland 21226 410.255.6400

ORDE	RTITLE: SON TOWN	Center	
Tow	son, MD		
	ING DATE 19/17	SALES REP MG	PROJECT MGR MG
	F	REVISION HISTORY	· -
NO.	DATE	DESC	RIPTION
I'I'E	OF M	ARY'''	

Murdoon Engineering
2 Hummingbird Ct.
Howell, New Jersey 07731 (973)-570-8215

Yeve Mardoch 7127117 Jere Murdoch, P.E. Professional Engineer

Maryland P.E. License #41030 PROFESSIONAL CERTIFICATION: I hereby certify that these documents were

prepared or approved by me and that I am a duly licensed professional engineer under the laws of the state of Maryland. License No. 41030, expiration date 8/17/19

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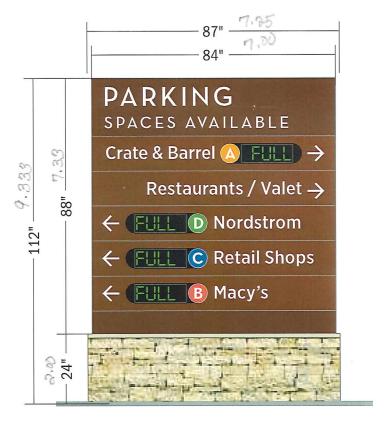
SIGN TYPE: Sign Type A1 -D/F Illuminated Site ID. Pylon

DWG. TYPE:

Constructi	on/Engin	eering
PROJECT NO.	TASK NO.	QTY.
72951-1	136647	
DWG. NO		SHEET
0043MR0		3 of 3









Fairmount Entrance



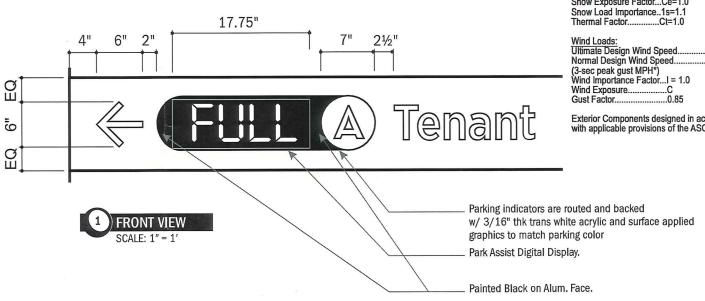

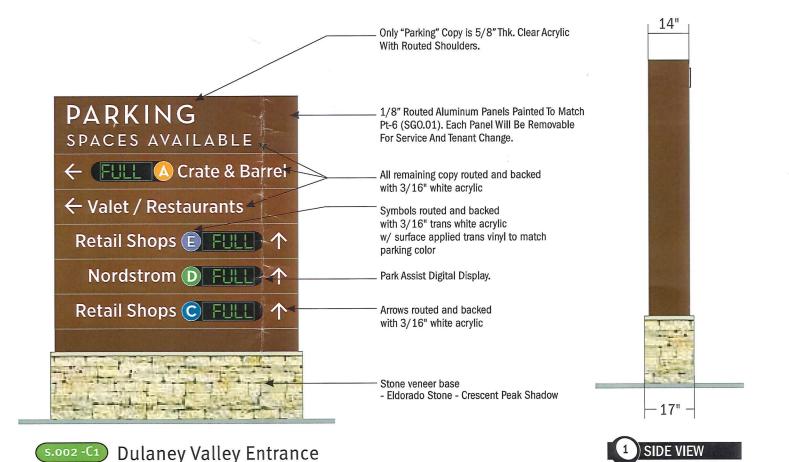

Designed per Maryland Building Performance Standards IBC 2012- w/ the Department of Housing and Community Development (DHCD) modifications

Snow Loads: Ground Snow Load......Pg-30 psf Snow Exposure Factor...Ce=1.0

Exterior Components designed in accordance with applicable provisions of the ASCE 7-10



A VISUAL SOLUTIONS COMPANY.

7440 Fort Smallwood Road Baltimore, Maryland 21226 410 255 6400

PROJECT TITLE: Towson Town Center ORDER TITLE: Towson Town Center CITY/STATE

Towson, MD DRAWING DATE SALES REP PROJECT MGR. 07/19/17 MG REVISION HISTORY

NO. DATE DESCRIPTION

Murdoch Engineering 2 Hummingbird Ct. Howell, New Jersey 07731 (973)-570-8215

7/19/2017

Jere Murdoch, P.E. Professional Engineer Maryland P.E. License #41030

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SIGN TYPE:

SCALE: 3/8" = 1"

Sign Type: C1 Major Vehicular Directional

DWG.TYPE: Construction/Engineering


PROJECT NO. TASK NO. QTY. 72951-1 136647 2 DWG. NO. SHEET 0043MR0 1 of 3



- Minimum concrete strength shall be 3,000 psi, unless otherwise noted.
- 2. All plate, angle, channel, tee and wide flange shall be ASTM A36 grade unless otherwise specified.
- Square and rectangular tube shall be ASTM A500 Grade B
 Round pipe shall be ASTM A53 Grade B or equivalent
 Design and fabrication according to AISC Steel Construction Manual 14th edition
- Concrete design & construction to be in accordance with ACI 318-05

SCALE: 3/8" = 1

Concrete poured into constrained earth excavations must cure under

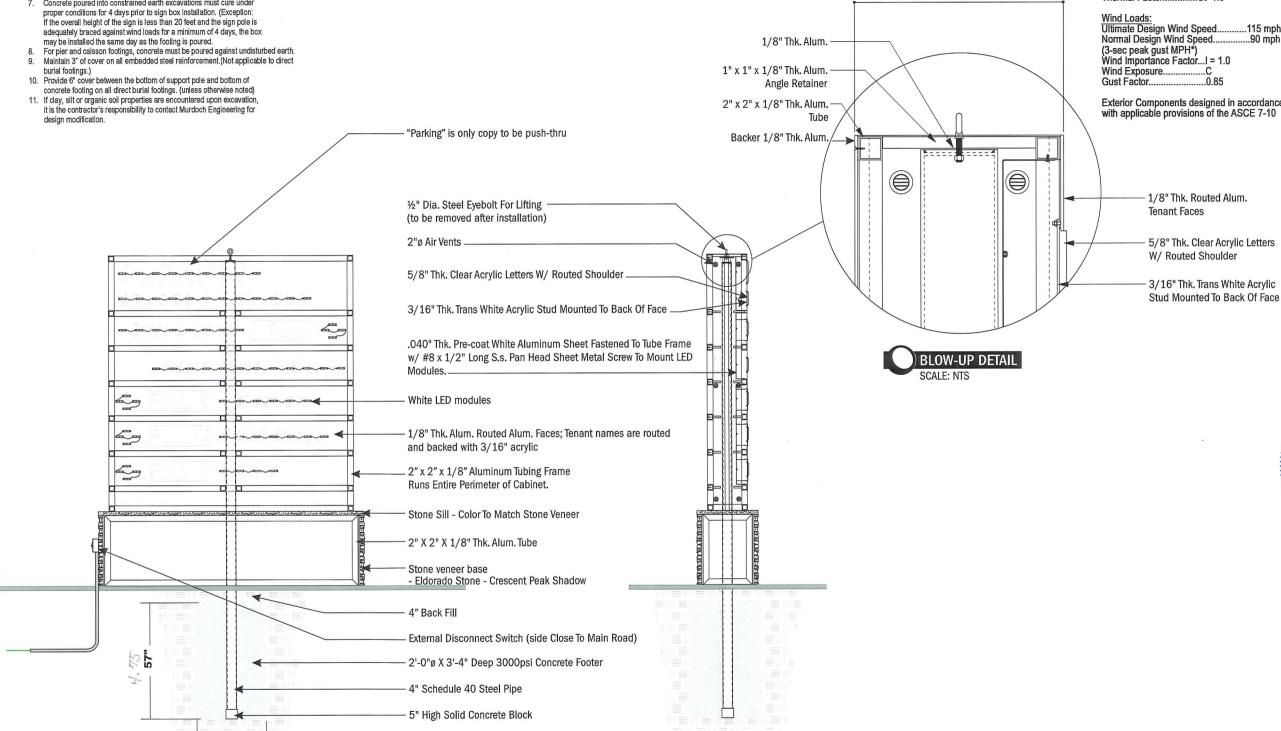

Designed per Maryland Building Performance Standards IBC 2012- w/ the Department of Housing and Community Development (DHCD) modifications.

Snow Loads: Ground Snow Load......Pg-30 psf Snow Exposure Factor...Ce=1.0 Snow Load Importance..1s=1.1 Thermal Factor......Ct=1.0

1' - 2"

Ultimate Design Wind Speed...... ...115 mph Normal Design Wind Speed..... (3-sec peak gust MPH*) Wind Importance Factor...I = 1.0 Wind Exposure.....

Exterior Components designed in accordance with applicable provisions of the ASCE 7-10

> PROJECT TITLE: 1/8" Thk. Routed Alum. **Towson Town Center**

ORDER TITLE: Towson Town Center

CITY/STATE Towson, MD

DRAWING DATE SALES REP PROJECT MGR. 07/19/17 MG MG REVISION HISTORY

••••••

Gable

A VISUAL

SOLUTIONS

7440 Fort Smallwood Road Baltimore, Maryland 21226

COMPANY.

410.255.6400

NO. DATE DESCRIPTION

ESSIONA

Murdoch Engineering 2 Hummingbird Ct. Howell, New Jersey 07731 (973)-570-8215

7/19/2017

Jere Murdoch, P.E. Professional Engineer Maryland P.E. License #41030

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SIGN TYPE: Sign Type: C1 Major Vehicular Directional

DWG.TYPE:

Construction/Engineering


PROJECT NO. TASK NO. QTY. 72951-1 136647 DWG. NO. SHEET 0043MR0 2 of 3

Designed per Maryland Building Performance Standards IBC 2012- w/ the Department of Housing and Community Development (D-ICD) modifications.

Snow Loads:
Ground Snow Load.......Pg-30 psf
Snow Exposure Factor...Ce=1.0
Snow Load Importance..1s=1.1
Thermal Factor.......Ct=1.0 Thermal Factor.....Ct=1.0

Wind Loads:
Ultimate Design Wind Speed.......115 mph
Normal Design Wind Speed......90 mph
(3-sec peak gust MPH*)
Wind Importance Factor...I = 1.0

Exterior Components designed in accordance with applicable provisions of the ASCE 7-10

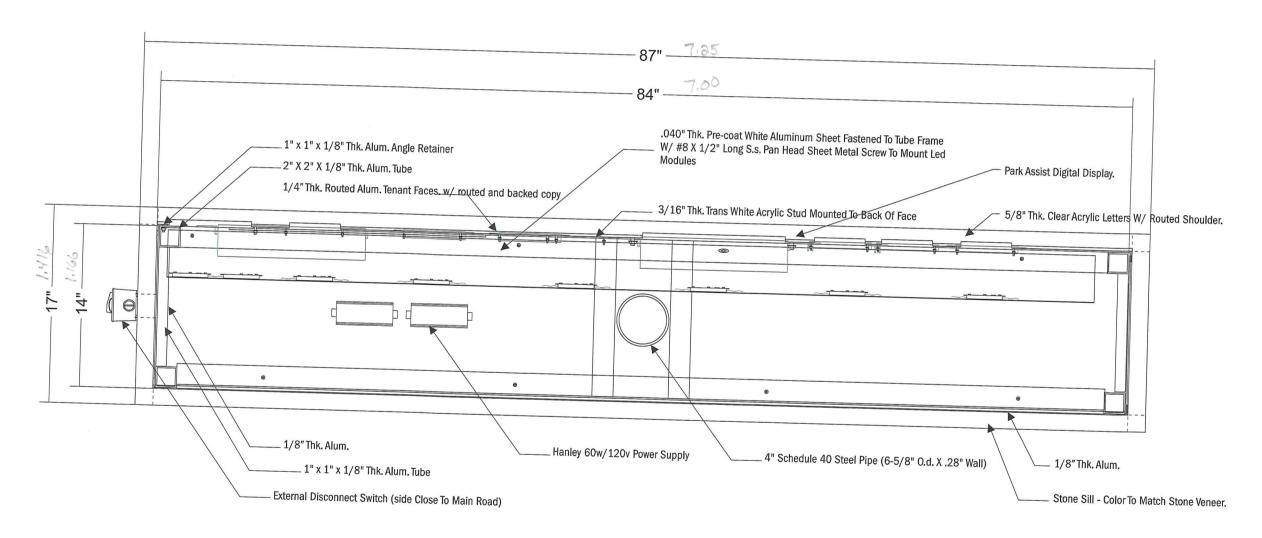





A VISUAL SOLUTIONS COMPANY.

7440 Fort Smallwood Road Baltimore, Maryland 21226 410.255.6400

PROJECT TITLE: Towson Town Center ORDER TITLE: Towson Town Center CITY/STATE Towson, MD DRAWING DATE 07/19/17 SALES REP MG PROJECT MGR. MG REVISION HISTORY NO. DATE DESCRIPTION



Murdoch Engineering 2 Hummingbird Ct. Howell, New Jersey 07731 (973)-570-8215

7/19/2017

Jere Murdoch, P.E. Professional Engineer Maryland P.E. License #41030

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SIGN TYPE: Sign Type: C1 Major Vehicular Directional DWG. TYPE: Construction/Engineering PROJECT NO. TASK NO. QTY. 72951-1 136647 DWG. NO. SHEET

0043MR0 3 of 3