***** ***** MARYLAND

6.

BALTIMORE COUNTY DEPARTMENT OF PERMITS, APPROVALS & INSPECTIONS 111 WEST CHESAPEAKE AVENUE

TOWSON, MD 21204 410-887-3391 B A 18475/

The applicant is authorized to affirm that there are no current violations at this site pursuant to Section 112.7 BCC

SIGN USE PERMIT

Permit Fees are Non-Refundable; Make Check Payable to "Balt	mittais
PROPERTY ADDRESS 4313 E Denezer Rd	ZIP CODE <u>Z/236</u>
BUSINESS NAME Chase BOOK	zoning DC16
OWNER'S NAME WARC PH CENTRO PHON	
MAILING ADDRESS 900 North Michigan	Ave Chicago ZL 60611
APPLICANT/OWNER'S AGENT GARY Brent	PHONE NO. 410-507-0053
SIGN COMPANY NAME NUS SIGN COMPA	ch'co phone no. <u>301-831-1550</u>
TYPE OF SIGN: Window Sign	TAX ACCOUNT NO. <u>220 / 002/ 9669</u>
Temporary- Including Real Estate/Construction/Event	Temporary Signs in the Last Year: 🗌 Yes 🏹 No
Permanent Changeable Copy Wall F	ace Change Only Non-Illuminated
Freestanding Pylon Monument Illuminate	d (separate electrical permit required)
Size: feet x square feet	Height: feet (freestanding signs)
Property Line/Street Right-of-Way Setbacks: front, sides	and, and rear
NOTE: A construction plan, drawn to scale and clearly showing that	t all requirements have been met, must be attached; a site plan also
must be attached for freestanding signs.	
	Changeable Copy Sign may only have a maximum Frequency of one
instantaneous message change per 15 second cycle. 450.6.B.3 Changeable copy signs must operate at a	constant intensity and not give the appearance of movement by
 Signs cannot imitate or resemble government signs, except Signs cannot be placed in or project into or above street rig Sign or framework cannot obstruct window or opening for Vehicle cannot be parked for the purpose of displaying an an except for flags exempted, flags, pennants, ribbons, stream prohibited. Portable signs are prohibited, except for A-frame and sands 	ernment signs. All signs are subject to Section 102.5, BCZR. for private traffic control and notice signs. the of way or governmental property. light and air or access to building, fire hydrant, or stand pipe. attached sign. ters, tethered balloons, laser projections, and similar objects are wich board signs issued a use permit in B.M. – C.T. zones. the essage, except for an outdoor advertising sign with tri-vision, a
Work Description (including number of signs, special condition Install illuminated waterish "Choice"	ins, materials, locations and size):
Installed non-illuminated directionals Strutuat = 78.92'	CORNER LOT CORNER LOT
	CERTIFICATION onal knowledge that the contents of the above are true and further
agree to locate the proposed sign such that it will not violate Bal	timore County laws and regulations.
5-20-19	GO Det
Signature	Print/Type Name
Require Planning Signature DMUllum	Date 5 22 19
this Copy for your permanent records)	Soriey under Section 500.4, BCZR PAI Approval (SIGN ONLY) Initials Date



Permits, Approvals & Inspections

111W. Chesapeake Avenue Towson, MD 21204 Report Generated On: 5/22/2019

Permit Processing Commerical Permit & Development Report

Page 1 of 1

Property Information

Premise Address:

Tax Account Number: 2200029169

Election District: 11

Owner Name(s): W ARC PH CENTRE OWNER VIII LLC and C/O WALTON STREET CAPITAL LLC

PDM #:

Address: SUITE 1900 900 NORTH MICHIGAN AVE


Zoning District(s): BL CCC

CHICAGO,IL 60611 EBENEZER RD

Elevation Range: 188ft - 226ft

	223/10004 N 2 (244)												
Affected Overlays	Instructions: Begin review process with Zoning Review, Room 111	- Bldg.	ts.	Add / Ext. Alts.	sb	Ma	militario de construire.	Ret.Walls/Bulk		of Occup.	Tower Antenna	Plumb	Agency
	Potential Overlay Issues	Com	Interior Alts.	Ext.	Piers/Pilings	Grading/SW	S	Nalls	D D	of O	er An	- లన	
Contact Agency	Growth Tier 1: Served by public sewer and inside URDL	New	Inter	Add	Piers	Grao	Tanks	Ret.\	Razing	Chg.	Towe	Signs Elect.	Initial & Date
Planning	Commercial Design Review Areas - Perry Hall	Х		X							WANTED AND	X	FIWAC
Jefferson Building	Commercial Revitalization Districts - Perry Hall	X		X	Janes .			-	canve same un	maneumar .	-	X	BMW
Room 101 Phone: 410-887-3211	NO DRP Reg.					ACTIVITIES AND ACTIVI		the equation of the state of th		groph waterdood		agai principlea	5/22/19.
DEPS-Sed. Control Jefferson Building 4th Floor	Note: All Razing Permits must be sent to Sediment Control for review.				3 0050000		- Accessed to the Acc						
Phone: 410-887-3226			A STATE OF THE STA	Contract of the Contract of th	Section (and order		and the control of					-
PAI-Public Services County Office Building	Note: All permits for Grading, New Buildings & Building Additions must be sent to Public Services.												GENS/22/
Room 119 Phone: 410-887-3751			nem spanish and spanish	Party Colonia Service	name and distance of	Aug Farancia (Aug Farancia)	man a company of the			Substitution and the second			
Zoning Review County Office Building Room 111 Phone: 410-887-3391	Zoning Cases: R-1956-3805; R-1952-2346; 1967-0158-A; 1963-5894-X; 1963-0011-X; 1977-0131-SPHX; 1985-0006-X; 1993-0349-XA; 1990-0318-XA; 1997-0083-X; 2018-0351-SPHA; 1993-0124-SPHX	X		X	X	X	X			X	X	X	Fred Again
				Andreas and the Andreas endealers	AND THE PERSON NAMED IN COLUMN 2 IS NOT THE PERSON NAMED IN COLUMN	And the second second second second					and the second		370
				and the second second	The second second second	Africa de la constitución de processo de la constitución de la constit	Comment of State Control of Contr						
			and the second second		Name and Address of the Party o					7			
			Wilderson and State of State o	national control of the control of t	and security special	and the state of t		10000			Control Control		*
			The state of the s				Appropriate the second						

Notice: This report is not inclusive as additional issues may arise which would affect the ability to obtain a building permit. This Report is solely for Departmental use and nothing herein creates any right which would accrue to the applicant. Form171C

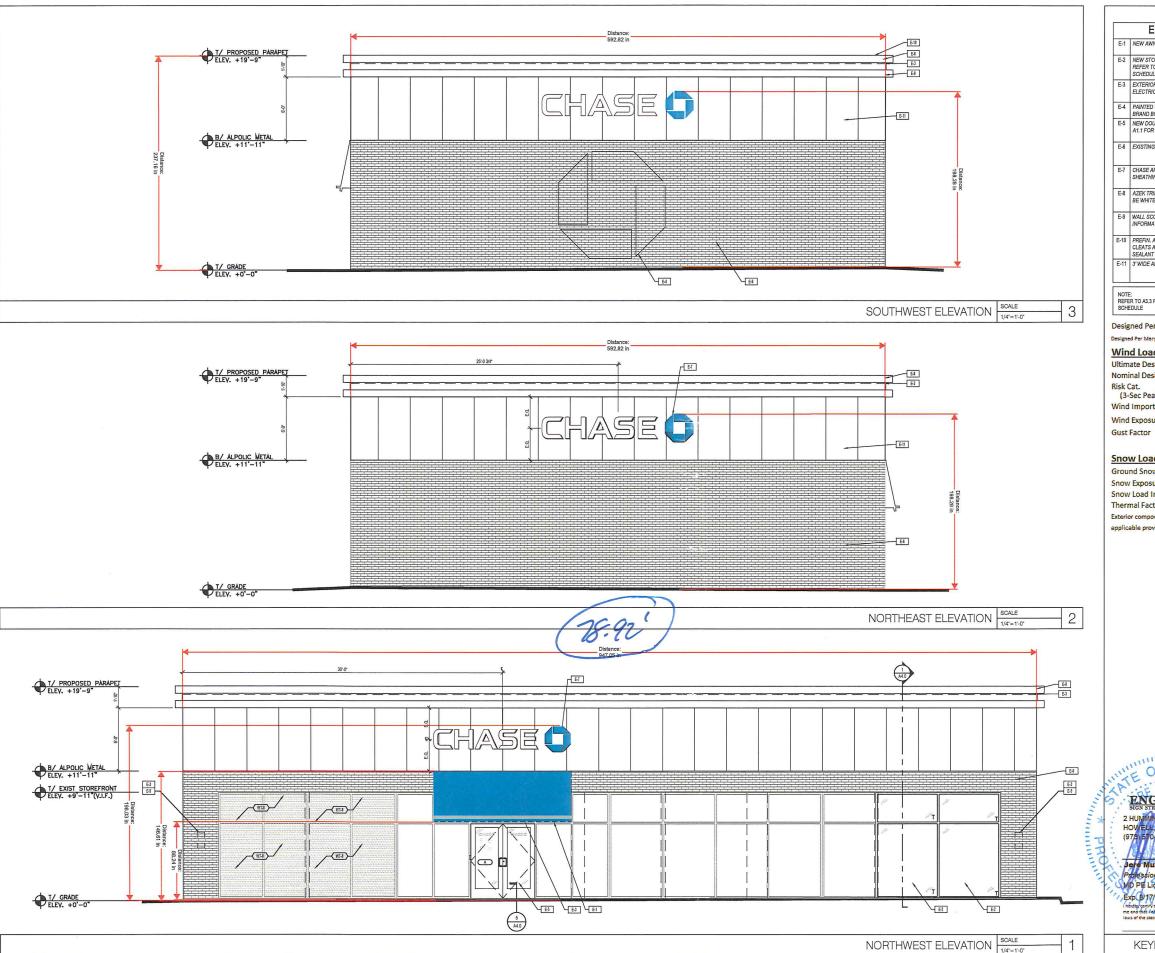

5 S



ELEVATION NOTES

Designed Per Maryland Building Performance Standards

Wind Loads

Ultimate Design Wind Speed 115 mph Nominal Design Wind Speed 89.1 mph Risk Cat. (3-Sec Peak Gust MPH*) Wind Importance Factor 1= 1 Wind Exposure C 0.85

Snow Loads

Ground Snow Load Pg- 25 psf Snow Exposure Factor Ce= 1.0 Snow Load Importance 1s= 1.1 Thermal Factor Ct= 1.0 Exterior components designed in accordance with applicable provisions of the ASCE 7-10

OF MAROOCE
ENGINEERING
SIGN STRUMBER PROFESSIONAL 2 HUMMINGBIRD CT. HOV/ELL, NJ-07731 (975) 570-8215 3/15/2019 Jero Murdoch, PE Professional Engineer MD PE Lic. #41030 Exp. 8/17/2019 KEYNOTES SCALE 3

 \triangleleft JPMORGAN CHASE, PERRY HALL



KENNETH J. MACKENZIE, AIA LICENSE #: 15386

THESE DRAWINGS ARE NOT COMPLETE WITH SEPARATE TYPE WRITTEN SPECIFICATIONS I WHICH ARE PART OF THE CONTRACT DOC

PROFESSIONAL CERTIFICATION, I HEREBY CERTITHAT THESE DOCUMENTS WERE PREPARED OF APPROVED BY ME, AND THAT I AM A DILICANSE PROFESSIONAL ARCHITECT UNDER TUCKNEE NO. 15396

EXPRATION DATE: 03/21/2020

EXPIRATION DATE: 03/21/2020 ISSUE DATE DESCRIPTION

2019.02.18 PERMIT SET

PROJECT INFORMATION

PROJECT INFO
PROJECT NO:
DATE:
PROTOTYPE:
DRAWN BY:
CHECKED BY:
VERSION: 02/18/2019 A.NICASIO R.PILI/ D.SNYDER

> **EXTERIOR ELEVATIONS**

SHEET TITLE

A2.0




Northwest Elevation

DIMENSIONS TO BE FIELD VERIFIED

NOTE: Building painted by others.

NOTE: Installation of awning

dependent on the storefront manufacture approving mounting points on the mullion.

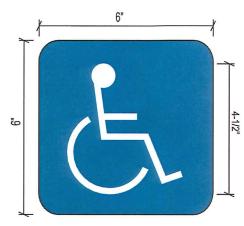


ADA-EP
HANDICAPPED ENTRANCE PLAQUE
SCALE: NTS


CUST-VIN
MATCHING BLUE VINYL BACKER

SCALE: NTS



SIGN E06 MOUNTS BACK-TO-BACK WITH I01.

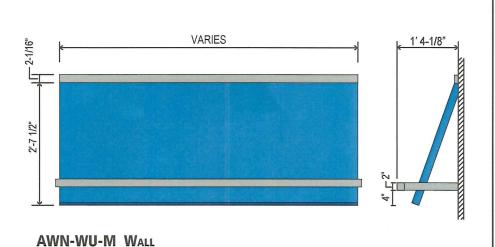

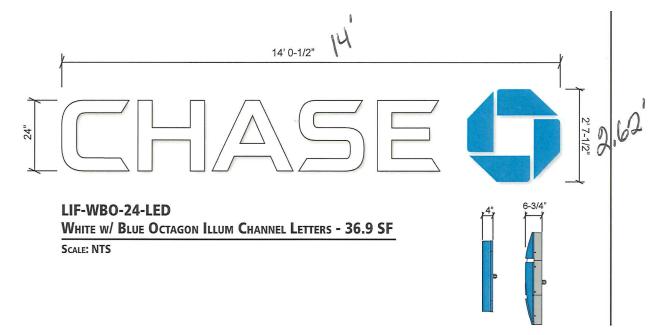

MURDOCH

ENGINEERING
SIGN STRVETHE PROFESSIONALS

2 HUMMINGERD OT. Project 1820670 W. (975) \$70.907781 G. (975) \$70.907781 G. (975) \$70.907781 G. (975) \$70.90781 G.

Designed Per IBC 2015 MD Edition
Designed Per Maryland Building Performance Standar

Snow Loads

Ground Snow Load Pg- 25 p
Snow Exposure Factor Ce= 1.0
Snow Load Importance 1s= 1.1
Thermal Factor Ct= 1.0
Exterior components designed in accordance with

applicable provisions of the ASCE 7-10

PHILADELPHIASIGN
BRINGING THE WORLD'S BRANDS TO LIFE

Non-Illuminated Metal Awning - No Descriptor

SCALE: NTS

TITLE Chase New Builds DWG BY RS DATE 08/31/18

ADDRESS CHS.NB.407 Perry Hall Ebenezer Rd. 4313 Ebenezer Rd. Nottingham, MD 21236

DWG NUM B79826

SHEET 7

THIS IS AN ORIGINAL UNPUBLISHED

DRAWING CREATED BY P.S.C.O. IT

IS SUBMITTED FOR YOUR PERSONAL

USE IN CONJUNCTION WITH A PROJECT

BEING PLANNED FOR YOU BY P.S.C.O.


IT IS NOT TO BE SHOWN TO ANYONE

OUTSIDE YOUR ORGANIZATION NOR

IS IT TO BE USED, COPIED, REPRODUCED,


OR EXHIPTED IN ANY EASHION.



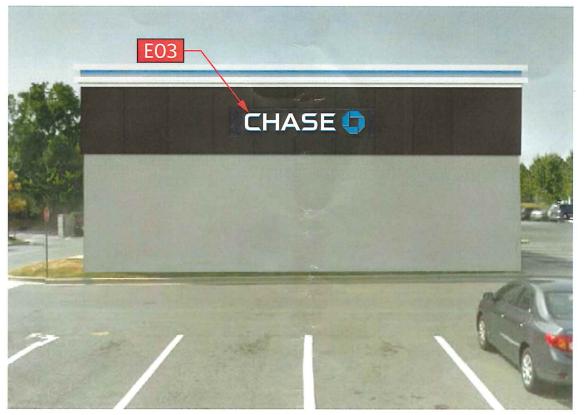

Northeast Elevation

DIMENSIONS TO BE FIELD VERIFIED

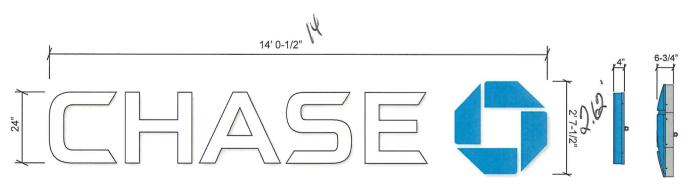

LIF-WBO-24-LED WHITE W/ BLUE OCTAGON ILLUM CHANNEL LETTERS - 36.9 SF

SCALE: NTS

Designed Per IBC 2015 MD Edition

Wind Loads Ultimate Design Wind Speed 115 mph Nominal Design Wind Speed 89.1 mph Risk Cat. (3-Sec Peak Gust MPH*) Wind Importance Factor ect: 1820670 Wind Exposure Gust Factor 0.85 3/15/2019 Snow Loads Ground Snow Load Pg- 25 psf


Snow Exposure Factor Ce= 1.0 1s= Snow Load Importance 1.1 Ct= 1.0 Thermal Factor applicable provisions of the ASCE 7-10



TITLE	Chase New Builds	DWG BY RS	DATE	08/31/18	
ADDRESS	CHS.NB.407 Perry Hall Ebenezer Rd. 4313 Ebenezer Rd.		DWG NUM	B79826	
	Nottingham, MD 21236		SHEET	8	


THIS IS AN ORIGINAL UNPUBLISHED DRAWING CREATED BY P.S.C.O. IT IS SUBMITTED FOR YOUR PERSONAL USE IN CONJUNCTION WITH A PROJECT DES IN CONJUNCTION THIS HAPKUSET BEING PLAINNED FOR YOU BY P.S.C.O. IT IS NOT TO BE SHOWN TO ANYONE OUTSIDE YOUR ORGANIZATION NOR IS IT TO BE USED, COPIED, REPRODUCED, OR EXHIBITED IN ANY FASHION.



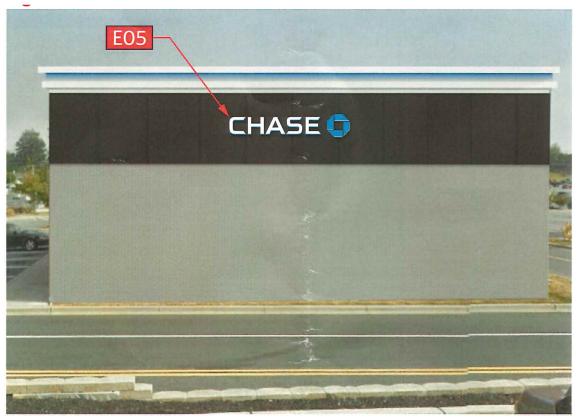

Southwest Elevation

DIMENSIONS TO BE FIELD VERIFIED

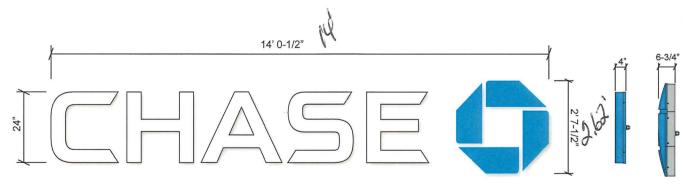

LIF-WBO-24-LED White w/ Blue Octagon Illum Channel Letters - 36.9 SF SCALE: NTS

Designed Per Maryland Building Performance Standards Wind Loads Ultimate Design Wind Speed

Risk Cat. (3-Sec Peak Gust MPH*) Wind Importance Factor oject: 1820670 Wind Exposure

3/15/2019 Snow Loads

C Gust Factor 0.85 Ground Snow Load Pg- 25 psf Snow Exposure Factor Ce= 1.0 Snow Load Importance 1s= 1.1 Ct= 1.0 Thermal Factor Exterior components designed In accordance with

applicable provisions of the ASCE 7-10

89.1 mph

Designed Per IBC 2015 MD Edition


Nominal Design Wind Speed



TITLE	Chase New Builds	DWG BY RS	DATE	08/31/18	
CHS.NB.407 Perry Hall Ebenezer Rd. 4313 Ebenezer Rd.			DWG NUM	B79826	
	Nottingham, MD 21236		SHEET	10	

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The Exterior Cabinet Finish Shall Be Painted To Match All Exposed Fastener Heads

(1) SO Amp\120 Volt Circuits

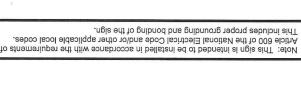FIGCILICSI LOSO

Electrical Regimts

atloV 0S1 @ aqmA 02.8

5. Full Size Drilling Template Furnished With Sign. 4. Mounting Hardware By Sign Installer. 3. Sign Shall Be U.L. Listed. By Sign Installer, Where Allowed By Local Codes. 2. Letter To Letter Wiring & Final Primary Hook-up

Speol wonz Gust Factor Wind Exposure Wind Importance Factor (3-Sec Peak Gust MPH*) Nominal Design Wind Speed

2,-7 1/2"

± "₽\E 8 →

spreamed Per Maryland building Performance Standards

Ultimate Design Wind Speed Wind Loads

applicable provisions of the ASCE 7-10

Thermal Factor

Snow Load Importance

Snow Exposure Factor

Ground Snow Load

exterior components designed in accordance with

0.1 =10

I.I =SI

0.1 =9J

Pg- 25 psf

28.0

nqm 1.98 TT2 mbp

> Designed Per IBC 2015 MD Edition Exp. 8/17/2019 MD HE INC. #41030

2 HUMMIN GBIRD CT. HOWELL NJ 07731 SYS-075 (879)

B82318

рме иливек:

ENGINEER SEAL:

5 OF 10 SHEET:

Number: Date: **KEVISION:**

DKC

:УВ ИМАЯО

3/1/18 :3TAQ

LOCATION:

NOTTINGHAM, MD 21236 4313 EBENEZEK KD'

ENG DEPT

By:

REPRODUCED, OR EXHIBITED IN ANY FASHION.

ORGANIZATION NOR IS IT TO BE USED, COPIED,

BE SHOWN TO ANYONE UNISIDE YOUR

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CREATED BY PSCO. IT IS SUBMITTED FOR YOUR

THIS IS AN ORIGINAL UNPUBLISHED DRAWING

SITE SIGNAGE

SIGN TYPE:

CHS'NB'401

лов илмвек:

CHASE

CUSTOMER:

moo.ngissidqləbslidq.www Fax: 856.829.8549 Phone: 856.829.1460

Раїтуга, Йем Јегѕеу 08065 707 West Spring Garden Street

BRINGING THE WORLD'S BRANDS TO LIFE PHILADELPHIASIGN

By Others. 1. Sufficient Primary Circuit In Vicinity Of Sign STANDARD LETTER NOTES: 2CALE: 1-1/2" = 1'-0" OF OCTAGON OCTAGON CABINET SIDE VIEW **OF OCTAGON** SIDE NIEM OF SIDE NIEM 2CALE: 1-1/2" = 1'-0" CHANNEL LETTER SIDE NIEM OF Segment Typ. Acrylic Face Translucent Blue .125" Thermoformed-Acrylic Return Typ. Face Adhered To Chase Mickel Gloss Finish Finish White Acrylic Matthews #MP-19891 巾 .125" #7328 P95 Matte Returns & Back To Match Paint Exterior Of Octagon To Acrylic Face Typ. Blue Semi-Gloss Finish Diffuser Film Adhered #WP-00366 Chase Envision #3735-50 To Match Matthews 23/4"-Second Surface 3M Letter Returns & Back Acrylic Return With Paint Exterior Of Alum. 125" Translucent Blue-2CALE: 3/4" = 1'-0" QTY: 3 LIF-WBO-24-LED (E02, E03, E14) "43 1/4"4" 3/4" FRONT ELEVATION Match Building Typ. Alum. Bridge Paint To-OPEN-Location Typ.


-Mounting

14,-0 1/5,,-

10,-8 1/4"-

Scope of Work

36.95₽	WHITE WI BLUE OCTAGON ILLUM CHANNEL LETTERS	LIF-WBO-24-LED	Eld
5.7sF	DOUBLE-FACED MON-ILLUMINATED DIRECTIONAL	D-2-RE	Ш
5.7sF	лаиоттэви Оом-Іггимиматер Directional	D-2-RE	E10
TBD	Мои-Іггимилатер Мета Аминие - Ио Безсянтоя	M-UW-NWA _M-UW-NWA	E04
36.95	WHITE WI BLUE OCTAGON ILLUM CHANNEL LETTERS	FIE-WBO-24-LED	E03
36.95	WHITE WI BLUE OCTAGON ILLUM CHANNEL LETTERS	FIE-WBO-24-LED	E05
TBD	ACRYLIC FACE W/ LOGO AS VINYL 1ST & ZND SURFACE	V-A-TM 1	E01.
TBD	ACRYLIC FACE WI LOGO AS VINYL 1ST & ZND SURFACE	V-A-TM	EOI

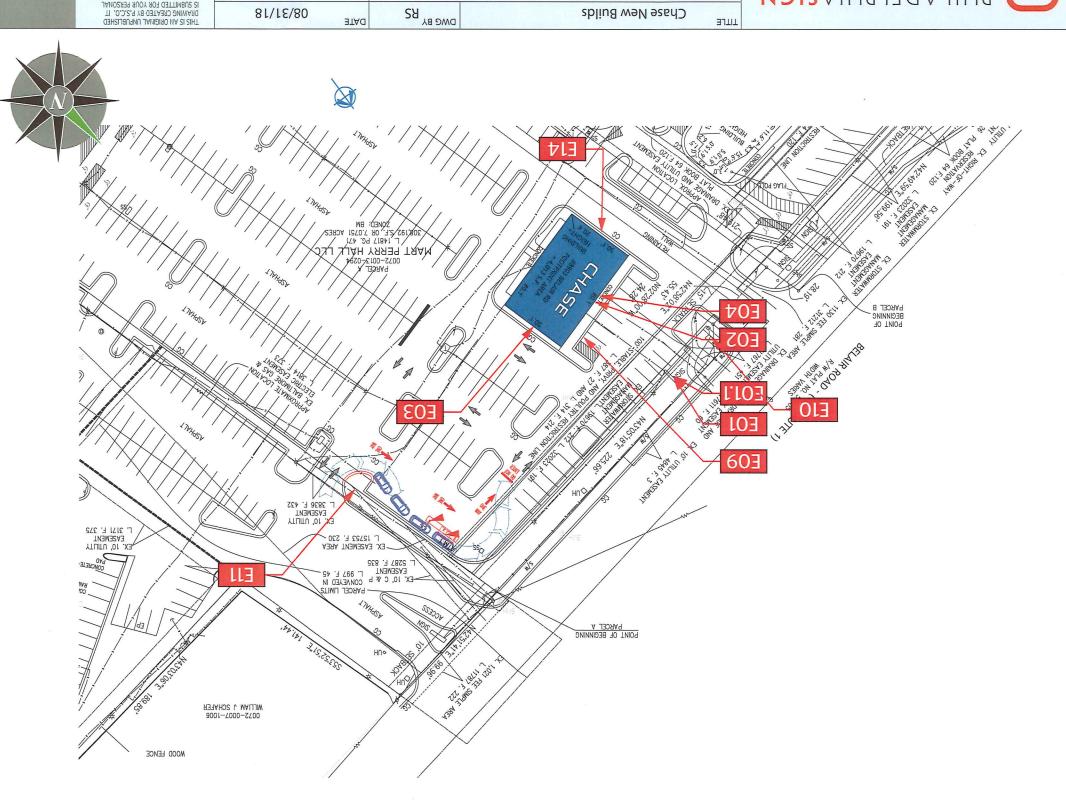



Interior Signs

Exterior Signs

879826 DMG NNW


81/18/80


Nottingham, MD 21236 ADDRESS CHS.NB.407 Perry Hall Ebenezer Rd. 4313 Ebenezer Rd.

Chase New Builds

BRINGING THE WORLD'S BRANDS TO LIFE PHILA DELPHIA SIGN



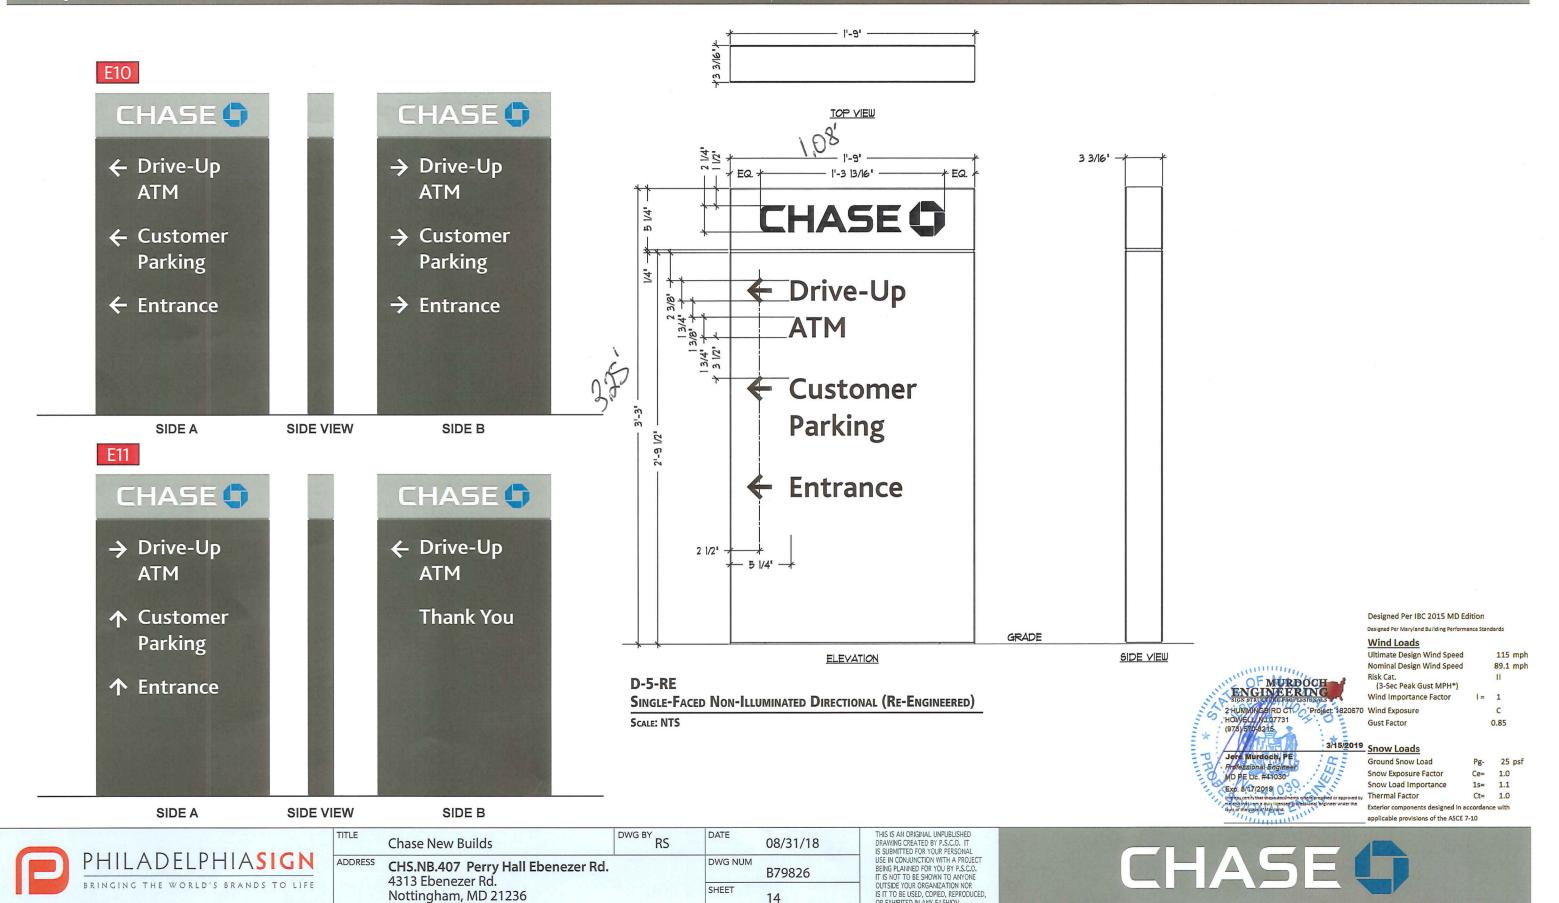

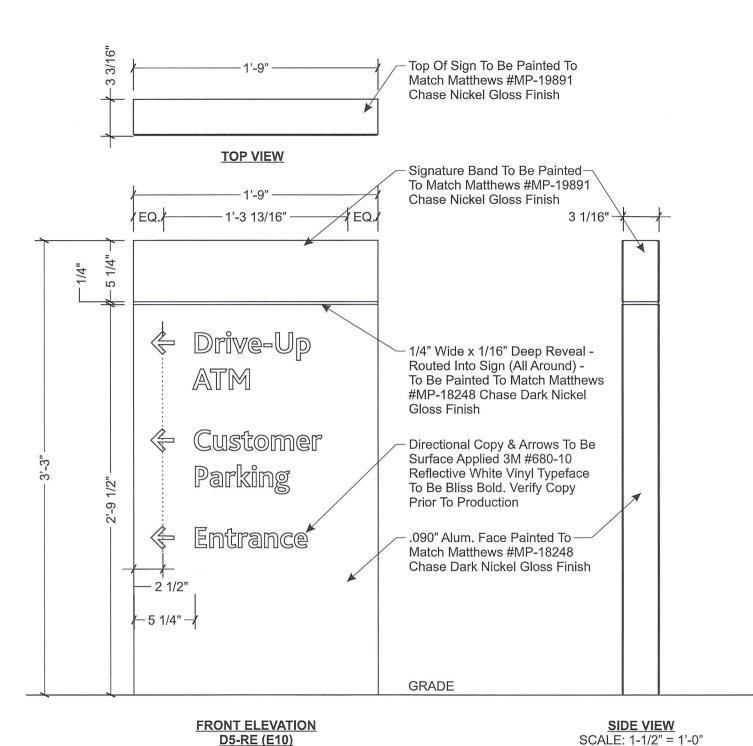

QTY: 1

SCALE: 1-1/2" = 1'-0"

All Exposed Painted Surfaces Shall Be Coated With Matthews #282-208SP VOC Gloss Clear, With Minimum 2 Mils Dry Film Thickness (DFT) Per Matthews Application Specifications.

Verify All Copy Prior To Production Of Directional Sign

⇒ Drive-Up ATM

→ Customer Parking

→ Entrance

REAR ELEVATION SCALE: 1-1/2" = 1'-0" PHILADELPHIASIGN
BRINGING THE WORLD'S BRANDS TO LIFE

707 West Spring Garden Street Palmyra, New Jersey 08065

Phone: 856.829.1460 Fax: 856.829.8549 www.philadelphiasign.com

CUSTOMER:

CHASE

JOB NUMBER:

CHS.NB.407

SIGN TYPE:

SITE SIGNAGE

LOCATION:

4313 EBENEZER RD. NOTTINGHAM, MD 21236

DATE:

3/1/19

DRAWN BY:

......

REVISION:

By:

ENG DEPT

SHEET:

8 OF 10

DWG NUMBER:

B82318

ENGINEER SEAL:



Designed Per IBC 2015 MD Edition

Designed Per Maryland Building Performance Standar

Wind Loads

Snow Loads

 Ground Snow Load
 Pg 25 psf


 Snow Exposure Factor
 Ce=
 1.0

 Snow Load Importance
 1s=
 1.1

 Thermal Factor
 Ct=
 1.0

Exterior components designed in accordance with applicable provisions of the ASCE 7-10

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SCALE: 1-1/2" = 1'-0"

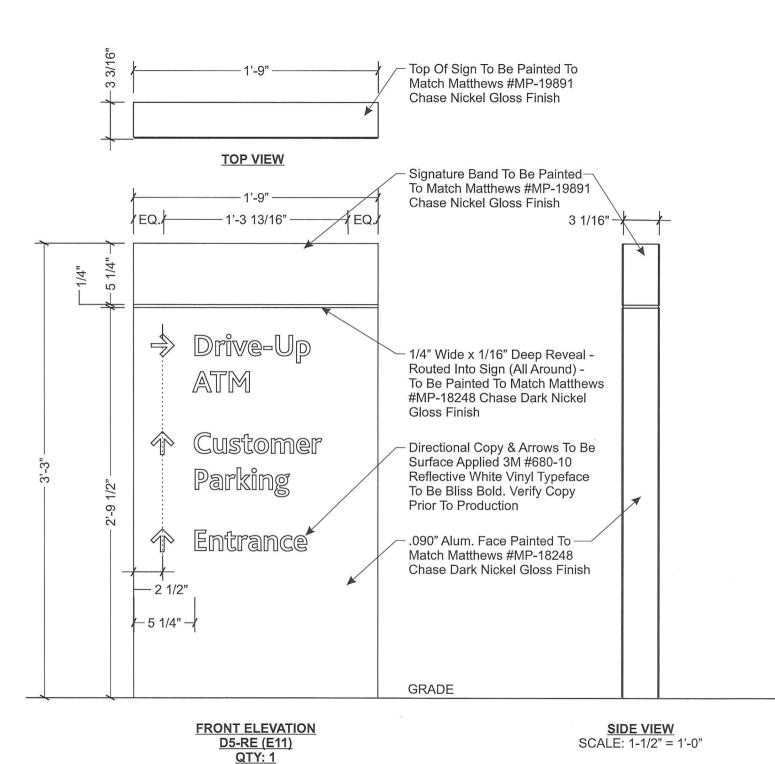All Exposed Painted Surfaces Shall Be Coated With Matthews #282-208SP VOC Gloss Clear, With Minimum 2 Mils Dry Film Thickness (DFT) Per Matthews Application Specifications.

Verify All Copy Prior To Production Of Directional Sign

♦ Drive-Up

Thank You

REAR ELEVATION SCALE: 1-1/2" = 1'-0"



707 West Spring Garden Street Palmyra, New Jersey 08065

Phone: 856.829.1460 Fax: 856.829.8549 www.philadelphiasign.com

CUSTOMER:

CHASE

JOB NUMBER:

CHS.NB.407

SIGN TYPE:

SITE SIGNAGE

LOCATION:

4313 EBENEZER RD. NOTTINGHAM, MD 21236

DATE: 3/1/19

DRAWN BY: DRC

REVISION:

SHEET:

By:

ENG DEPT

9 OF 10

DWG NUMBER:

B82318

ENGINEER SEAL:



MD PE Lio. #41030

2 HUMININGBIRD CT. Project: 1820670


3/15/2019

Snow Loads

Ground Snow Load	Pg-	25 p
Snow Exposure Factor	Ce=	1.0
Snow Load Importance	1s=	1.1
Thermal Factor	Ct=	1.0
Exterior components designed to	accordance	a with

applicable provisions of the ASCE 7-10

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707 West Spring Garden Street Palmyra, New Jersey 08065

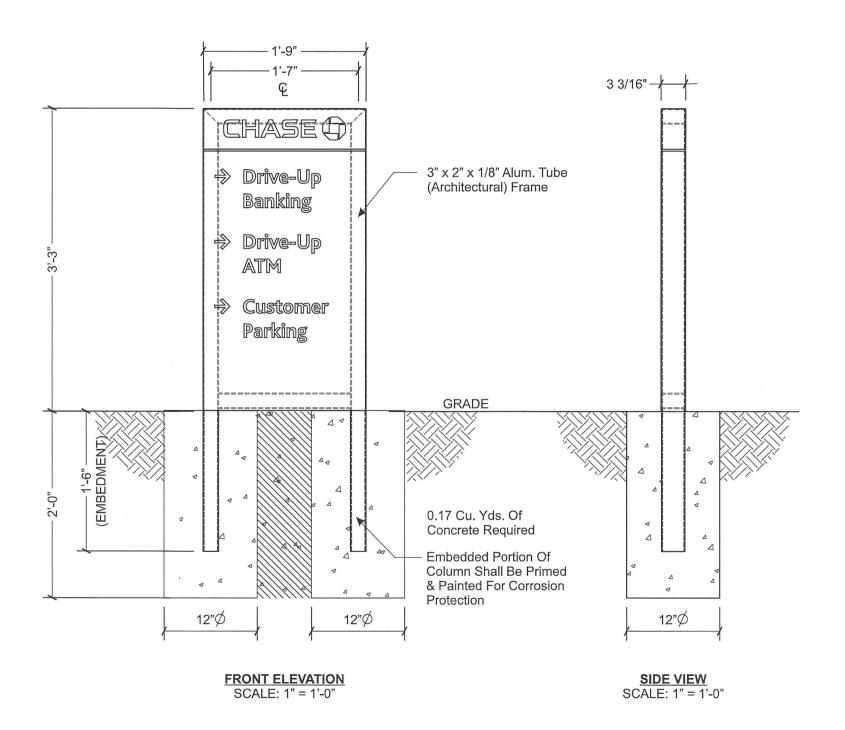Phone: 856.829.1460 Fax: 856.829.8549 www.philadelphiasign.com

CUSTOMER:

CHASE

JOB NUMBER:

CHS.NB.407

SIGN TYPE:

SITE SIGNAGE

LOCATION:

4313 EBENEZER RD. NOTTINGHAM, MD 21236

DATE:

3/1/19

DRAWN BY:

DRC

REVISION:

SHEET:

Number: Date:

ENG DEPT

By:

10 OF 10

DWG NUMBER:

B82318

ENGINEER SEAL:



Designed Per IBC 2015 MD Edition

Designed Per Maryland Building Performance Standards

Wind Loads

| Ultimate Design Wind Speed | 115 mph | 89.1 mph | 89.1 mph | 88.1 mph | 88.2 mph | 88.2 mph | 88.3 mph | 88.

Snow Loads

applicable provisions of the ASCE 7-10

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