

BALTIMORE COUNTY

DEPARTMENT OF PERMITS, APPROVALS & INSPECTIONS

111 WEST CHESAPEAKE AVENUE TOWSON, MD 21204

410-887-3391

SIGN USE PERMIT

The applicant must affirm
by initials below that there
are no current violations at
this site, pursuant to
Section 112.7, B.C.C.
Initials: 63

Permit Fees are Non-Refundable; Make Check Payable to "Baltimore County, Maryland"
PROPERTY ADDRESS 1330 York Rd ZIP CODE Z1030
BUSINESS NAME Chase ZONING BL
OWNER'S NAME YOULD THOSE NO. HISTORIC DISTRICT Yes No.
MAILING ADDRESS POBOX 1220 Winston-Salem MC27102
APPLICANT/OWNER'S AGENT GORG BROOK PHONE NO. 460-507-0053
SIGN COMPANY NAMEDUS SIGN CONNECTION PHONE NO. 301-831-7530
TYPE OF SIGN: Window Sign TAX ACCOUNT NO. 080/800/0625
Temporary-Including Real Estate/Construction/Event Temporary Signs in the Last Year: Yes No
Permanent Changeable Copy Wall Face Change Only Non-Illuminated
Freestanding Pylon Monument Illuminated (separate electrical permit required)
Size: 2.42 feet x 11.70 feet = 28.31 square feet Height: 11.70 feet (freestanding signs)
Property Line/Street Right-of-Way Setbacks: front
NOTE: A construction plan, drawn to scale and clearly showing that all requirements have been met, must be attached.
A site plan must also be attached for freestanding signs.
Table of Sign Regulations: 450.4.1 An Electronic Changeable Copy Sign may only have a maximum frequency of one instantaneous message change per 15 second cycle. 450.6.B.3 - Changeable copy signs must operate at a constant intensity and not give the appearance of movement by flashing, blinking, strobing, scrolling, oscillating, or alternating lights.
PROHIBITIONS: including roof signs (Sections 450.5.B.7 and 450.6.A, Baltimore County Zoning Regulations): 1. Signs cannot impair motorist's clear view of traffic or government signs. All signs are subject to Section 102.5, BCZR. 2. Signs cannot imitate or resemble government signs, except for private traffic control and notice signs. 3. Signs cannot be placed in or project into or above street right of way or governmental property. 4. Sign or framework cannot obstruct window or opening for light and air or access to building, fire hydrant, or stand pipe. 5. Vehicle cannot be parked for the purpose of displaying an attached sign. 6. Except for flags exempted, flags, pennants, ribbons, streamers, tethered balloons, laser projections, and similar objects are prohibited. 7. Portable signs are prohibited, except for A-frame and sandwich board signs issued a use permit in B.M. – C.T. zones. 8. There can be no display or simulation of moving parts or message, except for an outdoor advertising sign with tri-vision, a changeable copy sign, or a thermometer, barometer, weather vane, barber pole, or clock. 9. No sign may emit sound
Work Description (including number of signs, special conditions, materials, locations and size):
Install (1) illuminated pylonsign-Chase corner Lot?
OWNERD A CENTRAL CENTRAL CATAON
OWNER/AGENT CERTIFICATION I solemnly affirm under the penalties of perjury and upon personal knowledge that the contents of the above are true and further agree to locate the proposed sign such that it will not violate Baltimore County laws and regulations. Signature OWNER/AGENT CERTIFICATION I solemnly affirm under the penalties of perjury and upon personal knowledge that the contents of the above are true and further agree to locate the proposed sign such that it will not violate Baltimore County laws and regulations. Print/Type Name
Require Planning Signature Date
Copies: White-Office; Yellow- Applicant (keep this Copy for your permanent records) REV 04/17/2019 Authority under Section 500.4, BCZR PAI Approval (SIGN ONLY) Initials Date



Permits, Approvals & Inspections

111 W. Chesapeake Avenue Towson, MD 21204 Report Generated On: 11/5/2019

Permit Processing Commerical Permit & Development Report

Property Information

Premise Address:

Tax Account Number:

0808000625

Election District: 8

Page 1 of 1

Owner Name(s): YORK AT SHAWAN LLC and C/O BRANCH BANKING & TRUST CO

PDM #: 08-0839

Zoning District(s): BL

MI IM

WINSTON-SALEM,NC 27102 11330 YORK RD

Address: REAL ESTATE SERVICES PO BOX 1220


Elevation Range: 306ft - 324ft

Affected Overlays Instructions: Begin review process with Zoning Review, Room 111. Vew Com Bldg. Chg. of Occup. Interior Alts. Acknowledgment Potential Overlay Issues Initial & Date **Contact Agency** Growth Tier 1: Served by public sewer and inside URDL Note: All Razing Permits must be sent to Sediment Control for review. **DEPS-Sed. Control** Note: All permits for Grading, New Buildings & Building Additions must **PAI-Public Services** be sent to Public Services. County Office Building Room 119 Phone: 410-887-3751 Zoning Cases: 2005-0332-SPH; R-1960-4846 Χ X X X X XXX **Zoning Review** County Office Building Room 111 Phone: 410-887-3391

Notice: This report is not inclusive as additional issues may arise which would affect the ability to obtain a building permit. This Report is solely for Departmental use and nothing herein creates any right which would accrue to the applicant. Form: 171.00

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ADDITIONAL APPROVAL REQUIRED

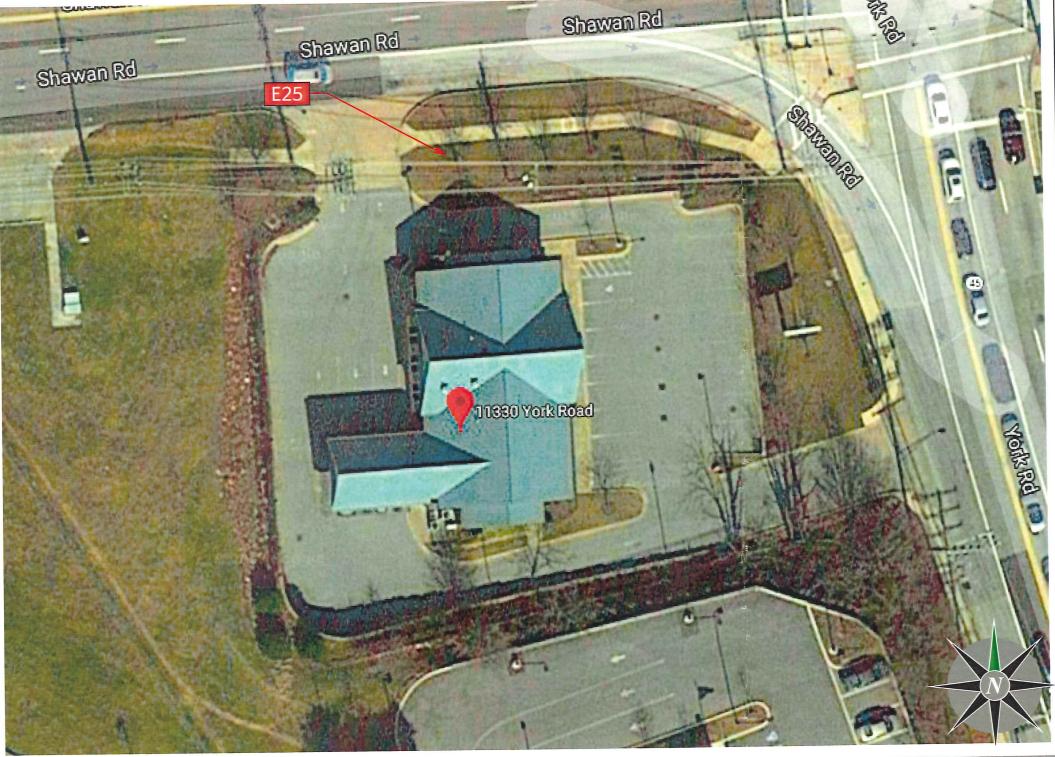

So	cope	of Wo	rk _				
	P-25	150		LE-FACED ILLUM	MINATED PYLON		25sF

Interior Signs Exterior Signs



TITLE	Chase New Builds	DWG BY MMS	DATE	10/29/18	
ADDRESS	Hunt Valley - York Road		DWG NUM	B80684	
	11330 York Road Cockeysville, MD 21030		SHEET	4	

THIS IS AN ORIGINAL UNPUBLISHED DRAWING CREATED BY P.S.C.O. IT IS SUBMITTED FOR YOUR PERSONAL


ADDITIONAL APPROVAL REQUIRED





ΓLE	Chase New Builds	DWG BY MMS	DATE	10/29/18
DDRESS	Hunt Valley - York Road		DWG NUM	B80684
	11330 York Road Cockeysville, MD 21030		SHEET	7



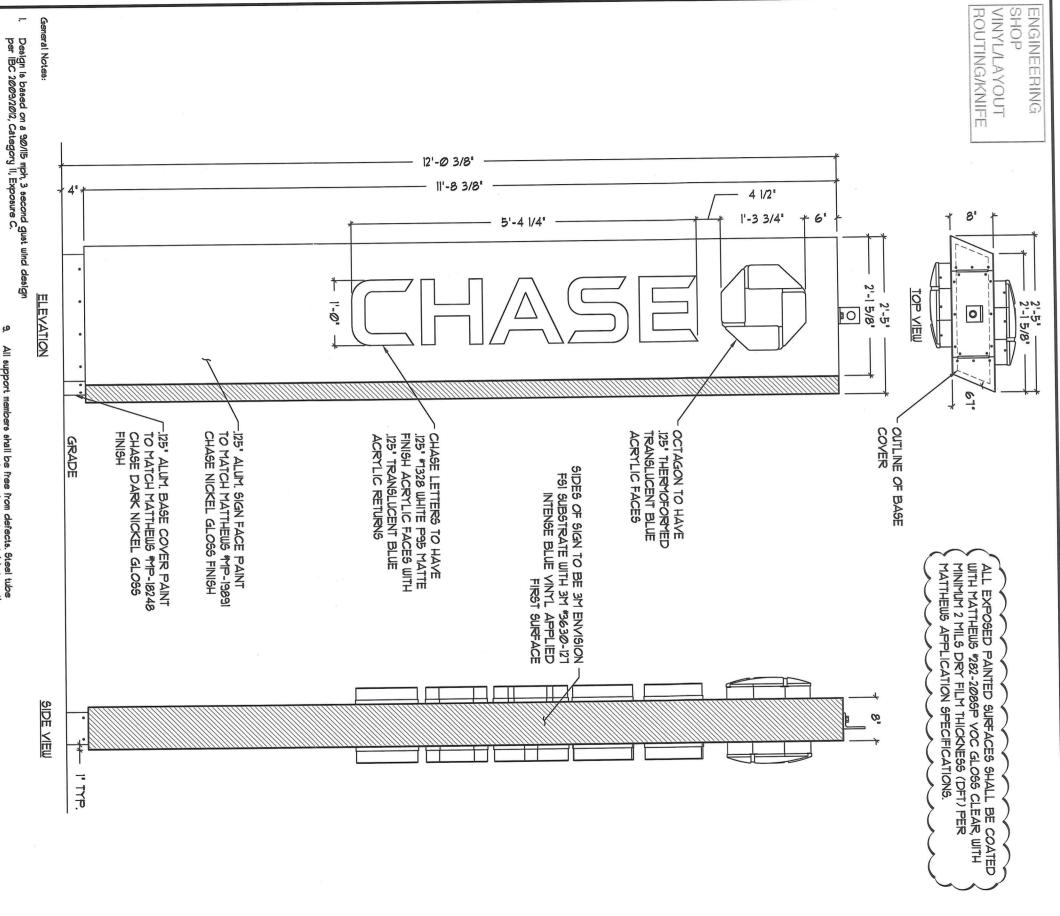

Design is based on a 90/115 mph, 3 second gust per IBC 2009/2012, Category II, Exposure C.

soil bearing pressure minimum of 2000 psf. Caleson foundation is based on a presumptive safe lateral soil bearing pressure minimum of 150 psf per foot of depth isolated lateral bearing footings subject to short-term lateral loads and not adversely affected by a 1/2 motion at grade are permitted to be designed using tuice the tabulated value of the corresponding soil class.

A soil report was not provided. Foundation analysis assumes soil classification 4. Allowable bearing pressure should be verified prior to placement of concrete, in the event that the stated requirements are not met and conditions appear deleterious, cease and secure excavation and immediately contact JP MORGAN CHASE.

Foundation shall not be placed at the top of, or on the side of a slope exceeding 3:1, or adjacent to a fill slope unless re-evaluated by a competent Professional Engineer. Do not place foundation in fill.

Concrete shall be mixed to attain a minimum 28 day compressive strength of 3000 psi.

6. Steel reinforcing bars has excendence with ASTM ASP, Welding of reinforcing bars is prohibited.

All voids between column baseplate and foundation surface shall be completely filled with high-strength, non-shrink grout.

Anchor boits shall meet ASTM FIB34 Grade 36. Exposed surfaces shall be galivanized or coated to prevent

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ALL EXPOSED FASTENER HEADS SHALL BE PAINTED TO MATCH THE EXTERIOR CABINET FINISH

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All support members shall be free from defects. Steel tube shall meet ASTM ASOO Grade B with a minimum yield strength of 46000 psi. Steel angle, channel and plate shall meet ASTM ASO. Extruded aluminum shapes shall be 6061-76 alloy. Aluminum sheet shall be 3003-114 alloy. Aluminum plate shall be 5052-1134 alloy.

Aluminum sheet shall be 3003-114 alloy. Aluminum plate shall be 5052-1134 alloy.

Melds shall be made with E100xx electrodes for steel 4 with a 4000 series filler for aluminum by persons qualified in accordance with AIMS standards within the past two years. All structural boits shall conform to ASTM A325, and be zinc coated unless noted otherwise. When used with structural boits, heavy hex nute shall conform to ASTM A563, and washers shall conform to ASTM A564, and washers shall conform to ASTM A564, and washers shall conform

this job site before, during or after installation of this structure. It is the responsibility of the contractors and installers to ensure that the installation and erection of this structure is performed using methods that are in full compliance with OSHA regulations.

Any deviation from this design or from any part of this drawing, including the General Notes, without prior written consent from JP Morgan Chase voids this drawing in Its entirety.

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4. entirety.

This design is prototypical and should not be used for site specific applications unless reviewed and deemed suitible for use at that site by a competent Professional Engineer.


GRAPHICS DEPICTED ARE FOR ILLUSTRATIVE PURPOSES ONLY!
USE ONLY APPROVED ARTWORK FOR PRODUCTION.

DESIGNATION: P-25 LED PYLON SIGN These documents represent prototypical design drawings SHT.

The intended application is strongly discouraged.

Disclosure or reproduction of any of the information contained within these documents without the warrance of the owner is strictly are in the owner in the owner is strictly are in the owner i 3/25/09 Drawing No. B224095 \triangleright 5/1/09 ADDED LATO A MENNE PRESPONTANT TO FACE PANEL
AND LATO A MENNE PRESENTANT TO FACE PANEL
ADD LED CALL AND COAT NOTE
CAMMED CALLAGE COAT NOTE
CAMMED CALLAGE DEFFIH TO 3' FROM' 3'
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BALTIMORE COUNTY DEPARTMENT OF PERMITS, APPROVALS & INSPECTIONS 111 WEST CHESAPEAKE AVENUE

TOWSON, MD 21204 410-887-3391

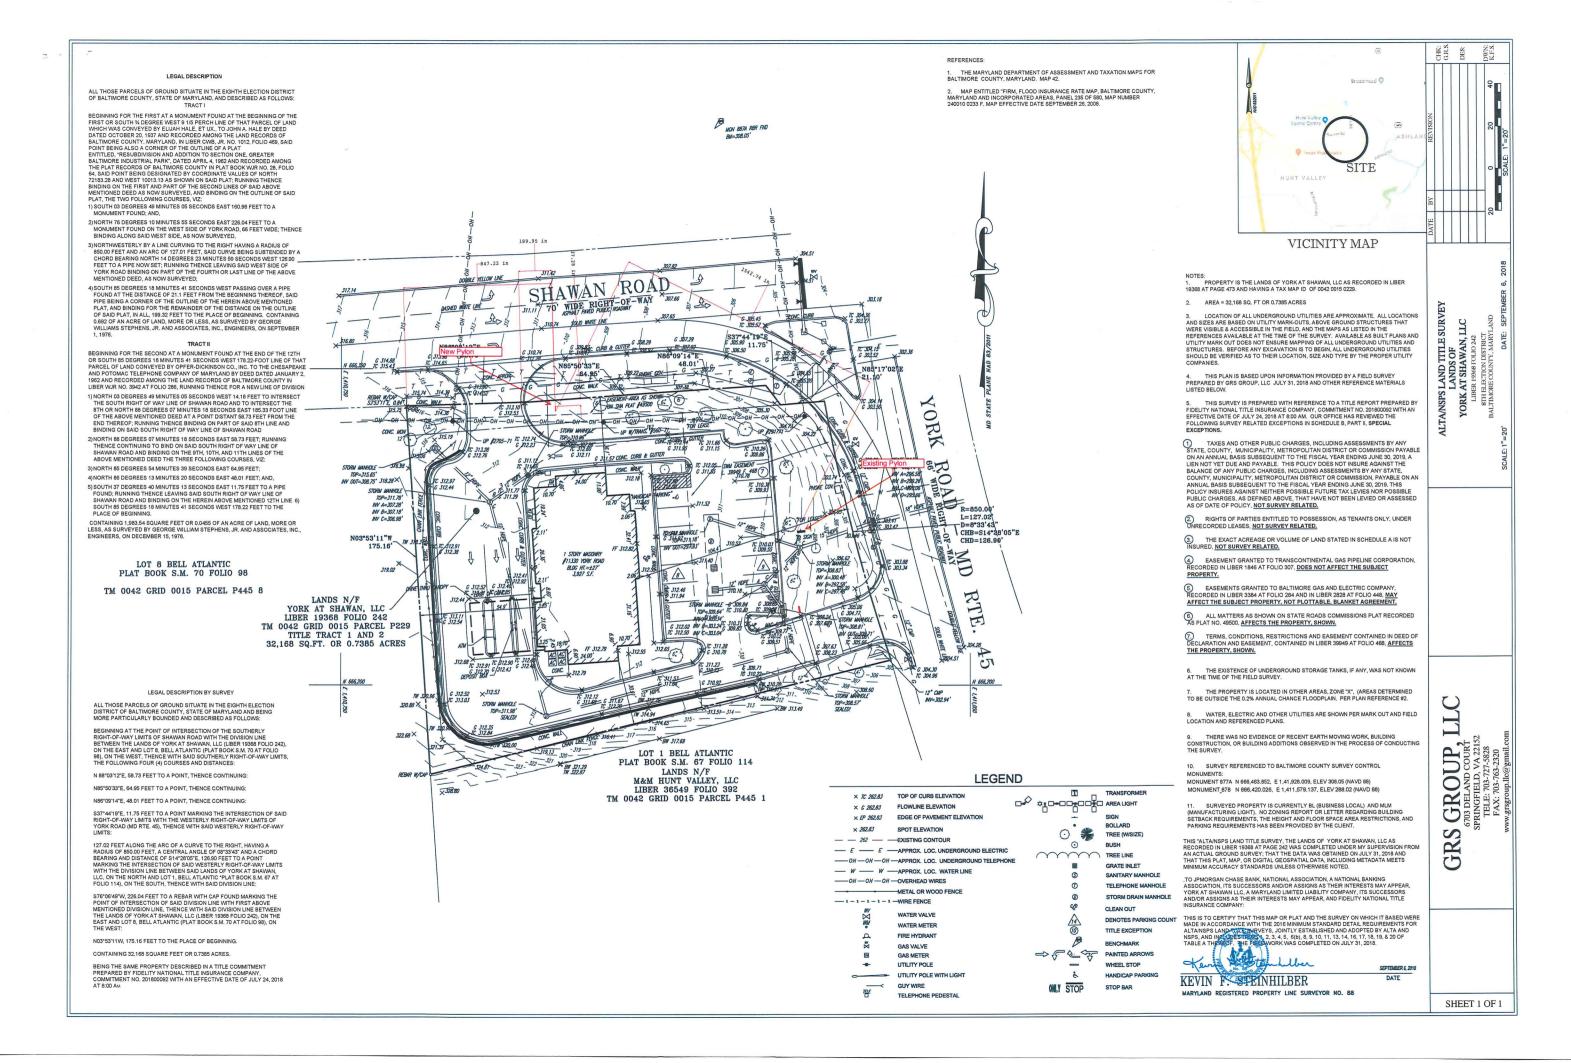B _	
A _	184752

The applicant is authorized

to affirm that there are no current violations at this site pursuant to Section

SIGN USE PERMIT 112.7 BCC

Permit Fees are Non-Refundable; Make Check Payable to "Baltimore County,	Hittais (
PROPERTY ADDRESS 11330 YOFK Rd	
BUSINESS NAME Chase Bank	zoning_MLIM
OWNER'S NAME YORK A+ Showence PHONE NO	HISTORIC DISTRICT 🗌 Yes 🔁 No
MAILING ADDRESS PO BOX 1220 Winston - Sala	
APPLICANT/OWNER'S AGENT GONG Brent	PHONE NO. <u>410-501-\$23</u>
SIGN COMPANY NAME DUS Sign Connection	
TYPE OF SIGN: Window Sign TAX ACCO	DUNT NO. <u>080 / 800 / 0625</u>
	emporary Signs in the Last Year: 🗌 Yes 🔀 No
Permanent Changeable Copy Wall Face Change Onl	y Non-Illuminated
Freestanding Pylon Monument Illuminated (separate elec	etrical permit required)
Size: See feet x See feet = square feet H	leight: feet (freestanding signs)
Property Line/Street Right-of-Way Setbacks: front, sidesand _	, and rear
NOTE: A construction plan, drawn to scale and clearly showing that all requirement	ts have been met, must be attached; a site plan also
must be attached for freestanding signs.	
Table of Sign Regulations: 450.4. Attachment 1, 1 An Electronic Changeable Constantaneous message change per 15 second cycle. 450.6.B.3 Changeable copy signs must operate at a constant intens flashing, blinking, strobing, scrolling, oscillating, or alternating lig PROHIBITIONS: including roof signs (Sections 450.5.B.7 and 450.6.A, Baltimon 1. Signs cannot impair motorist's clear view of traffic or government signs. As 2. Signs cannot imitate or resemble government signs, except for private traffications. Signs cannot be placed in or project into or above street right of way or government signs or framework cannot obstruct window or opening for light and air or a 5. Vehicle cannot be parked for the purpose of displaying an attached sign. 6. Except for flags exempted, flags, pennants, ribbons, streamers, tethered ball prohibited. 7. Portable signs are prohibited, except for A-frame and sandwich board signs 8. There can be no display or simulation of moving parts or message, except to changeable copy sign, or a thermometer, barometer, weather vane, barber p 9. No sign may emit sound	sity and not give the appearance of movement by thts. ore County Zoning Regulations): All signs are subject to Section 102.5, BCZR. fic control and notice signs. vernmental property. access to building, fire hydrant, or stand pipe. Illoons, laser projections, and similar objects are s issued a use permit in B.M. – C.T. zones. for an outdoor advertising sign with tri-vision, a pole, or clock.
Work Description (including number of signs, special conditions, materials, I Installa) illuminated lega = 5,25 x 5,25 = 27, 56 5,64 Installa) illuminated walls in "Chaz" = 2,19 x 11,71 = 6 Installa) illuminated walls in "Chaz" = 1,31 x 7 = 9,1 Installa) non-illuminated directiones igns " 3,25 x" Stant cat = 75 OWNER/AGENT CERTIFICAT	75 CORNER LOT
I solemnly affirm under the penalties of perjury and upon personal knowledge agree to locate the proposed sign such that it will not violate Baltimore County	that the contents of the above are true and further
5-20-19	2 Dest
Signature Date Print/T	ype Name
Require Planning Signature	Date
Copies: White-Office; Yellow- Applicant (keep this Copy for your permanent records) REV 10/14 Authority under Section this Copy for your permanent records)	n 500.4, BCZR PAI Approval (SIGN ONLY) State Date



Permits, Approvals & Inspections

111W. Chesapeake Avenue Towson, MD 21204 Report Generated On: 5/22/2019

Permit Processing Commerical Permit & Development Report

Page 1 of 1

Property Information

Tax Account Number: 0808000625

Election District: 8

Owner Name(s): YORK AT SHAWAN LLC and C/O BRANCH BANKING & TRUST CO

PDM #: 08-0839

Address: REAL ESTATE SERVICES PO BOX 1220

Zoning District(s): BL

WINSTON-SALEM, NC 27102

ML IM


Premise Address: 11330 YORK RD


Elevation Range: 306ft - 324ft

									۳9	C. O.				
Affected Overlays	Instructions: Begin review process with Zoning Review, Room 111.	Bldg.	s.	Alts.	gs	3	ST TO	Bulk	-	conb.	enna		Plumb	Agency
Contact Agency	Potential Overlay Issues Growth Tier 1: Served by public sewer and inside URDL	New Com Bldg	Interior Alts.	Add / Ext. Alts.	Piers/Pilings	Grading/SW	Tanks	Ret.Walls/Bulk	Razing	Chg. of Occup	Tower Antenna	Signs	∞ŏ	Acknowledgmen Initial & Date
DEPS-Sed. Control Jefferson Building 4th Floor Phone: 410-887-3226	Note: All Razing Permits must be sent to Sediment Control for review.				0 5000000	33 3000000	- C.C.	0. 2002000	60 500 600 5	103230291			- 2000000	***************************************
PAI-Public Services County Office Building Room 119 Phone: 410-887-3751	Note: All permits for Grading, New Buildings & Building Additions must be sent to Public Services.					0.000000	20050000		a sercius					
Zoning Review County Office Building Room 111 Phone: 410-887-3391	Zoning Cases: R-1960-4846; 2005-0332-SPH	X		X										
8	SSUES may arise which would affect the ability to obtain a building porosit. This December and the solution December 1				TE 00 10 10 10 10 10 10 10 10 10 10 10 10				Pi-Fe-scoonside.co.do					

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.125" Alum, Back Blue Sloan Prism LED-#701269-BLSJ1-MB Typ. Interior Surfaces Of All Aluminum Returns & Backs Shall Be Painted Spraylat Starbrite White Unless Otherwise Noted. 3/16" Translucent Blue Acrylic Face 1/2" Seal-Tite Straight Conduit Connector

115 mph

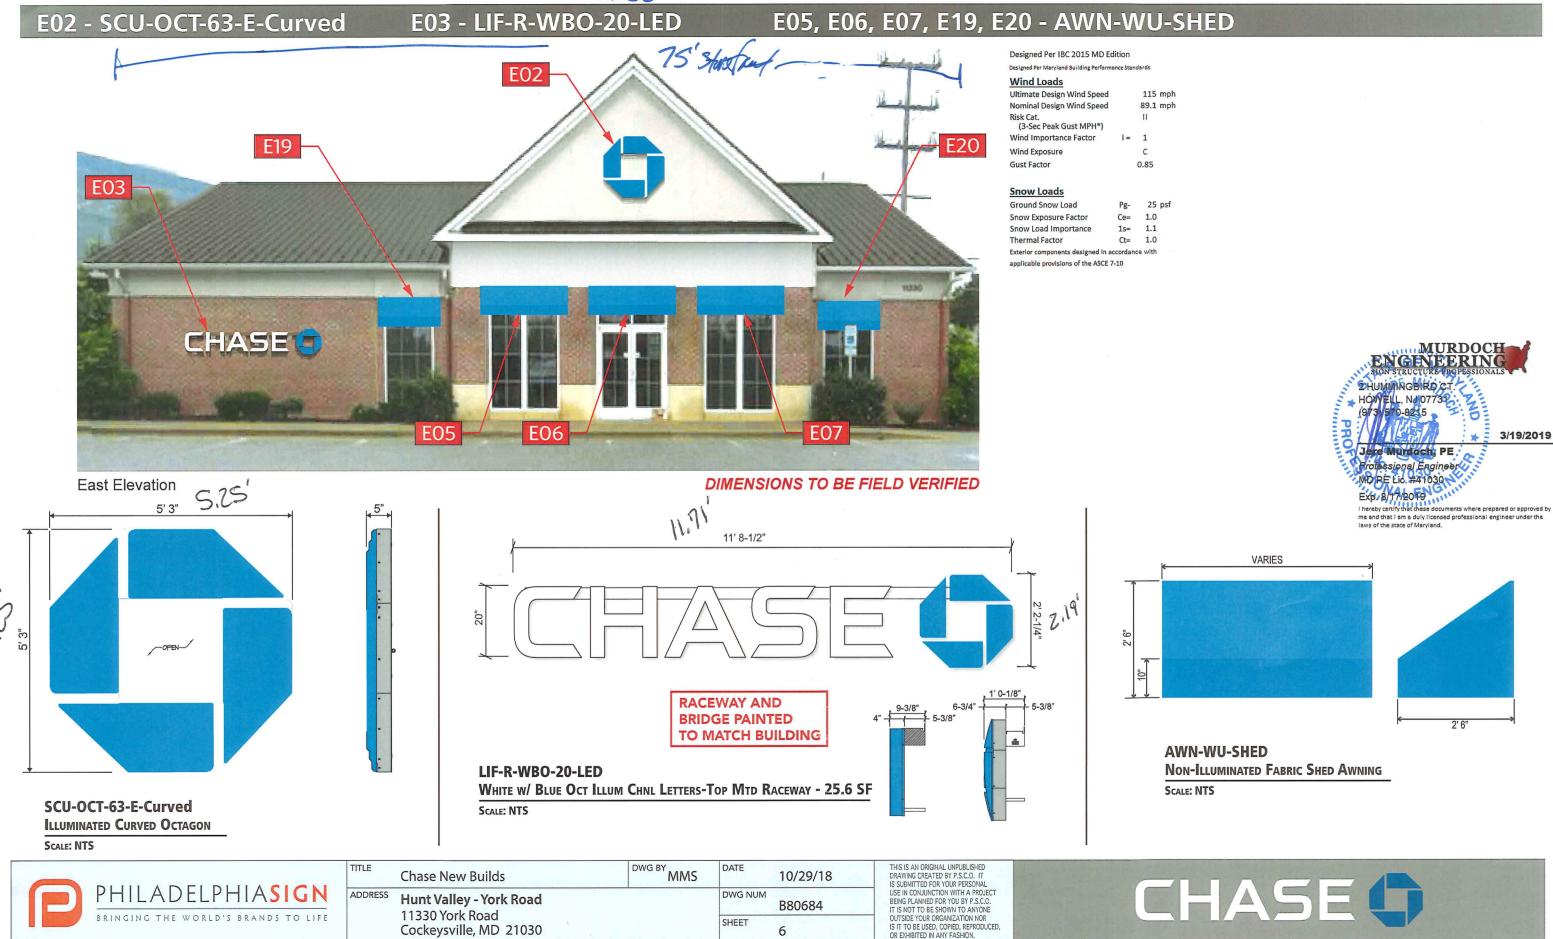89.1 mph

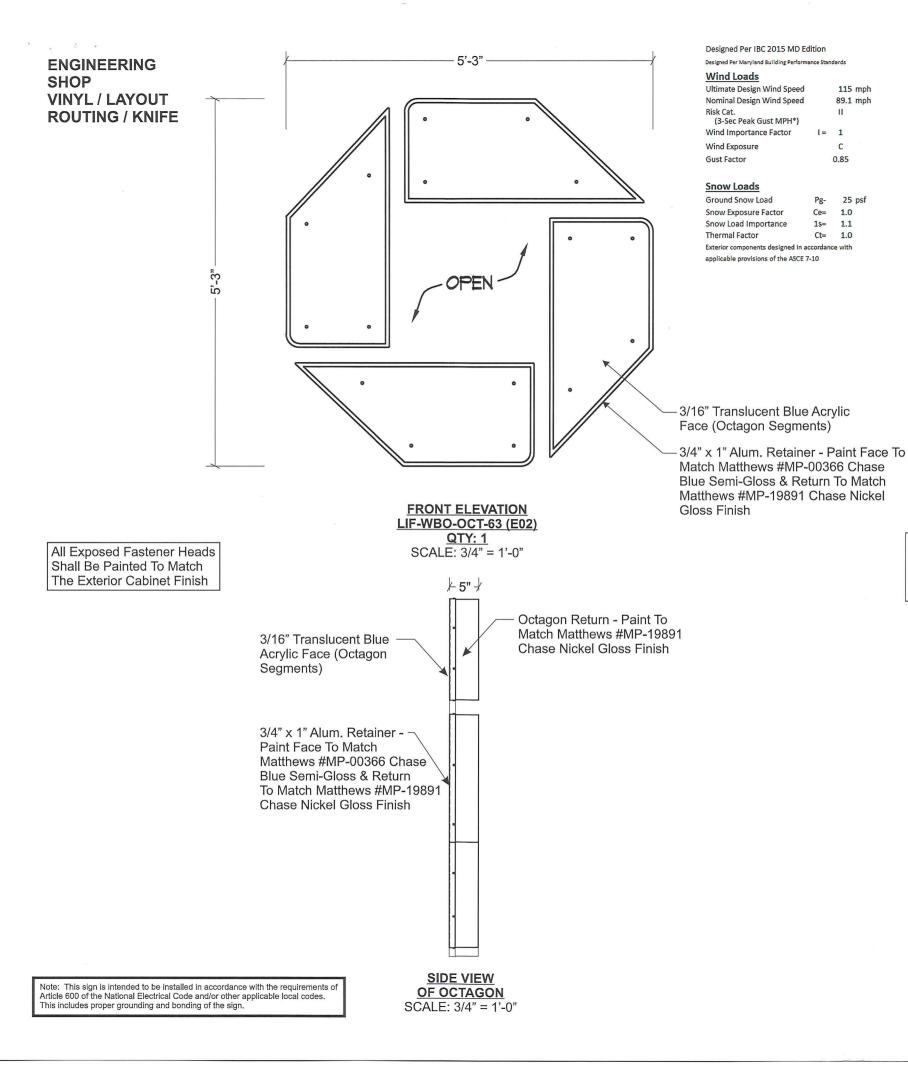0.85

Ce= 1.0

1s= 1.1

Ct= 1.0

25 psf

STANDARD LETTER NOTES:

SECTION

THROUGH OCTAGON

SCALE: 1-1/2" = 1'-0"

Formed .050" Alum.

1/4" Dia. Drain

Hole Typ.

Est. Electrical Load

2.4 Amps @ 120 Volts

Electrical Reg'mts

(1) 20 Amp/120 Volt Circuits

Drain Hole Cover Typ.

1. Sufficient Primary Circuit In Vicinity Of Sign By Others.

Letter To Letter Wiring & Final Primary Hook-up
By Sign Installer, Where Allowed By Local Codes.

3. Sign Shall Be U.L. Listed.

4. Mounting Hardware By Sign Installer. 5. Full Size Drilling Template Furnished With Sign. PHILADELPHIASIGN BRINGING THE WORLD'S BRANDS TO LIFE

707 West Spring Garden Street Palmyra, New Jersey 08065

Phone: 856.829.1460 Fax: 856.829.8549 www.philadelphiasign.com

CUSTOMER:

CHASE

JOB NUMBER:

CHS.NB.408

SIGN TYPE:

SITE SIGNAGE

LOCATION:

11330 YORK RD.

COCKEYSVILLE, MD 21030

DATE:

2/26/19

DRAWN BY:

DRC

REVISION:

Number: Date:

SHEET:

2 OF 22

DWG NUMBER:

B82286

ENGINEER SEAL:

MURDOCH

HUMMINGBIRD CT

HOWELL NJ 07730 (973/377-8215


***** 3/19/2019


By:

ENG DEPT

Jere Murdoch, PE Professional Engineer MO RE Lic. #41030 Exp. 8/17/2019 EN

hereby certify that these abcuments where prepared or approved by me and that I am a duly licensed professional engineer under the laws of the state of Maryland.

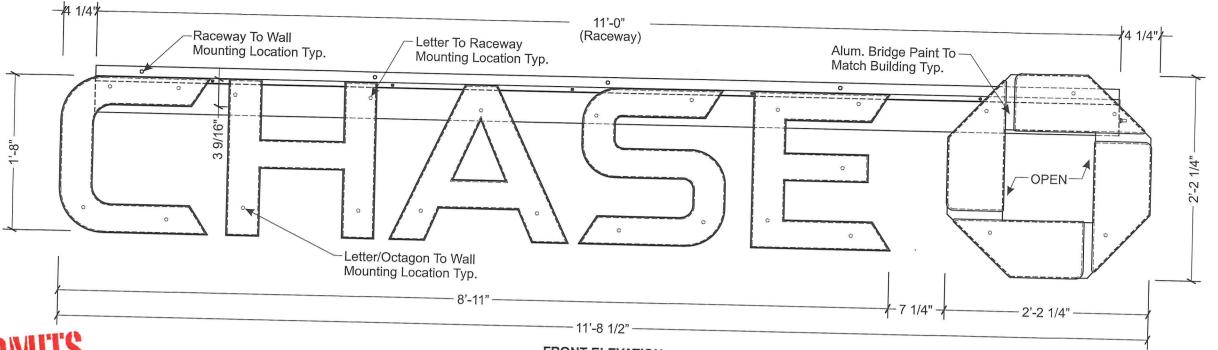

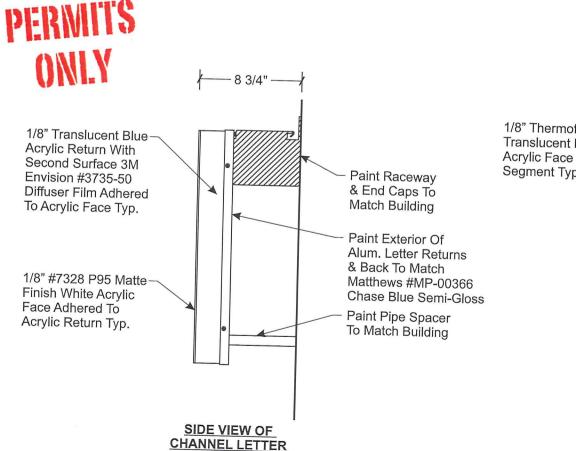

SCALE: 1-1/2" = 1'-0'

FRONT ELEVATION LIF-R-WBO-20-LED (E03) QTY: 1

SCALE: 1" = 1'-0"

10 3/8" Paint Raceway & End Caps To 1/8" Thermoformed Match Building Translucent Blue 20 Amp Disconnect Switch With Sealing Segment Typ. **Boot UL Label** Disconnect Switch Shall Be Installed So That Its Travel Is Horizontal Alum. Octagon Returns & Back - Paint To Match Matthews #MP-19891 Chase Nickel Gloss Finish

SIDE VIEW

OF OCTAGON

SCALE: 1-1/2" = 1'-0"

Ground Snow Load Snow Load Importance Thermal Factor

Exterior components designed in accordance with applicable provisions of the ASCE 7-10 3D VIEW OF **OCTAGON CABINET**



3D VIEW OF OCTAGON

STANDARD LETTER NOTES:

- 1. Sufficient Primary Circuit In Vicinity Of Sign By Others.
- 2. Letter To Letter Wiring & Final Primary Hook-up By Sign Installer, Where Allowed By Local Codes.

Designed Per IBC 2015 MD Edition

Ultimate Design Wind Speed

Nominal Design Wind Speed

(3-Sec Peak Gust MPH*)

Wind Importance Factor

Wind Loads

Wind Exposure

Snow Loads

Snow Exposure Factor

Gust Factor

Risk Cat.

Designed Per Maryland Building Performance Standards

- 3. Sign Shall Be U.L. Listed.
- 4. Mounting Hardware By Sign Installer.
- 5. Full Size Drilling Template Furnished With Sign.



707 West Spring Garden Street Palmyra, New Jersey 08065

Phone: 856.829.1460 Fax: 856.829.8549 www.philadelphiasign.com

CUSTOMER:

CHASE

JOB NUMBER:

CHS.NB.408

SIGN TYPE:

SITE SIGNAGE

LOCATION:

11330 YORK RD.

COCKEYSVILLE, MD 21030

DATE:

115 mph

89.1 mph

0.85

Pg- 25 psf

Ce= 1.0

1s= 1.1

Ct= 1.0

2/26/19

DRAWN BY: DRC

REVISION:

Number: Date:

By:

ENG DEPT

SHEET:

5 OF 22

DWG NUMBER:

B82286

ENGINEER SEAL:

MURDOCH

2 HUMMINGBIRD CT.

2 3/19/2019

Jere Murdoch, PE

MD PE DO #41030 Exp. 8/17/2019

I hereby certify that these documents where prepared or approved by me and that I am a duly licensed professional engineer under the laws of the state of Maryland.

THIS IS AN ORIGINAL UNPUBLISHED DRAWING CREATED BY PSCO. IT IS SUBMITTED FOR YOUR PERSONAL USE IN CONJUNCTION WITH A PROJECT BEING PLANNED FOR YOU BY PSCO. IT IS NOT TO BE SHOWN TO ANYONE OUTSIDE YOUR ORGANIZATION NOR IS IT TO BE USED, COPIED, REPRODUCED, OR EXHIBITED IN ANY FASHION.

Note: This sign is intended to be installed in accordance with the requirements of Article 600 of the National Electrical Code and/or other applicable local codes. This includes proper grounding and bonding of the sign.

Electrical Load (2.4) Amps @ 120 Volts

Paint Pipe Spacer To Match Building

> Electrical Reg'mts (1) 20 Amp/120 Volt Circuits

E08, E09, E10, E21, E22 - AWN-WU-SHED



Designed Per IBC 2015 MD Edition

Designed Per Maryland Building Performance Standards


Wind Loads


| Ultimate Design Wind Speed | 115 mph | 89.1 mph | 889.1 mph | 88

Snow Loads

applicable provisions of the ASCE 7-10

DIMENSIONS TO BE FIELD VERIFIED

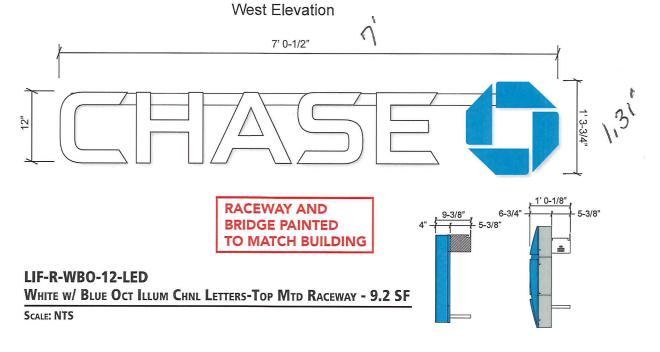


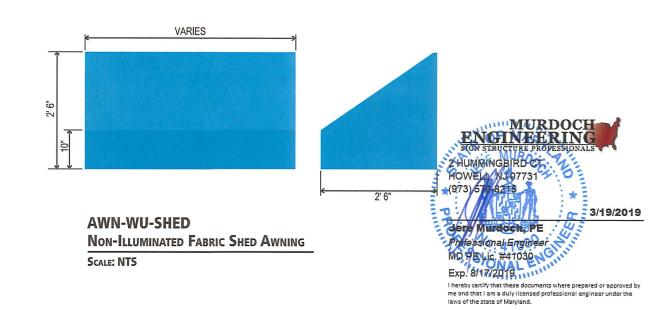



TITLE	Chase New Builds	DWG BY MMS	DATE	10/29/18	
ADDRESS	Hunt Valley - York Road 11330 York Road	·	DWG NUM	B80684	
	Cockeysville, MD 21030	SHEE	SHEET	7	




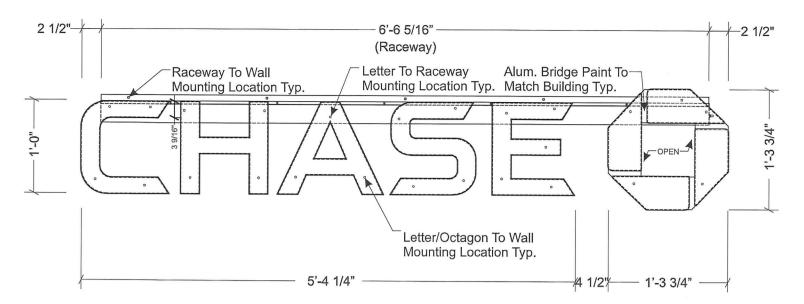

FRONT ELEVATION LIF-R-WBO-12-LED (E04) QTY: 1 SCALE: 1" = 1'-0"

SCALE: 1-1/2" = 1'-0"

- 8 3/4" — — 10 3/8" Paint Raceway & End Caps To Match Building 1/8" Thermoformed-Translucent Blue 1/8" Translucent Blue-20 Amp Disconnect Acrylic Face Acrylic Return With Switch With Sealing Second Surface 3M Segment Typ. **Boot** Paint Raceway Envision #3735-50 **UL Label** & End Caps To Diffuser Film Adhered Match Building To Acrylic Face Typ. Disconnect Switch Shall Be Installed So That Its Paint Exterior Of Travel Is Horizontal Alum. Letter Returns & Back To Match Matthews #MP-00366 Alum. Octagon Returns 1/8" #7328 P95 Matte-& Back - Paint To Chase Blue Semi-Gloss Finish White Acrylic Match Matthews Face Adhered To Paint Pipe Spacer #MP-19891 Chase Acrylic Return Typ. To Match Building Nickel Gloss Finish Paint Pipe Spacer To Match Building SIDE VIEW OF **SIDE VIEW CHANNEL LETTER OF OCTAGON**

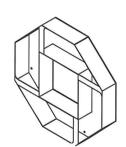

Designed Per IBC 2015 MD Edition

Ultimate Design Wind Speed

Nominal Design Wind Speed

(3-Sec Peak Gust MPH*) Wind Importance Factor

Wind Loads

Wind Exposure

Snow Loads

Thermal Factor

Ground Snow Load

Snow Exposure Factor

Snow Load Importance

applicable provisions of the ASCE 7-10

Gust Factor

Risk Cat.

Designed Per Maryland Building Performance Standards

3D VIEW OF OCTAGON CABINET



3D VIEW OF OCTAGON

STANDARD LETTER NOTES:

1. Sufficient Primary Circuit In Vicinity Of Sign

By Others.

2. Letter To Letter Wiring & Final Primary Hook-up

By Sign Installer, Where Allowed By Local Codes.

3. Sign Shall Be U.L. Listed.

4. Mounting Hardware By Sign Installer.

5. Full Size Drilling Template Furnished With Sign.



707 West Spring Garden Street Palmyra, New Jersey 08065

Phone: 856.829.1460 Fax: 856.829.8549 www.philadelphiasign.com

CUSTOMER:

115 mph

89.1 mph

0.85

Ce= 1.0

1s= 1.1

Ct= 1.0

25 psf

CHASE

JOB NUMBER:

CHS.NB.408

SIGN TYPE:

SITE SIGNAGE

LOCATION:

11330 YORK RD.

COCKEYSVILLE, MD 21030

DATE:

2/26/19

DRAWN BY:

DRC

REVISION: Number: Date:

SHEET:

7 OF 22

DWG NUMBER: B82286

ENGINEER SEAL:



Ву:

ENG DEPT

3/19/2019

Jere Murdoch, P.B. Professional Engineer

MD PE Ld. #41030 Exp. 8/17/2019

I hereby certify that these documents where prepared or approved by me and that I am a duly licensed professional engineer under the laws of the state of Maryland.

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Note: This sign is intended to be installed in accordance with the requirements of Article 600 of the National Electrical Code and/or other applicable local codes. This includes proper grounding and bonding of the sign.

SCALE: 1-1/2" = 1'-0'

Electrical Load 1.60 Amps @ 120 Volts

Electrical Req'mts

(1) 20 Amp/120 Volt Circuits 5. Fu

Site Plan



Sc	ope of Work		
E01	PYL.REFURB	REFACE AND REFURBISH EXISTING PYLON	TBD
E02	SCU-OCT-63-E-CURVED	ILLUMINATED CURVED OCTAGON	
E03	LIF-R-WBO-20-LED	WHITE W/ BLUE OCT ILLUM CHNL LETTERS - TOP MTD RACEWAY	25.6 sF
E04	LIF-R-WBO-12-LED	WHITE W/ BLUE OCT ILLUM CHNL LETTERS - TOP MTD RACEWAY	9.2sF
E05	AWN-WU-SHED	Non-Illuminated Fabric Shed Awning (No Branding)	TBD
E06	AWN-WU-SHED	Non-Illuminated Fabric Shed Awning (No Branding)	TBD
E07	AWN-WU-SHED	Non-Illuminated Fabric Shed Awning (No Branding)	TBD
E08	AWN-WU-SHED	Non-Illuminated Fabric Shed Awning (No Branding)	TBD
E09	AWN-WU-SHED	Non-Illuminated Fabric Shed Awning (No Branding)	TBD
E10	AWN-WU-SHED	Non-Illuminated Fabric Shed Awning (No Branding)	TBD
E11	D-5-RE	Double-Faced Non-Illuminated Directional (No Branding)	5.7 SF
E12	D-5-RE	Double-Faced Non-Illuminated Directional (No Branding)	5.7 sF
E13	DU-C-A	ILLUM DRIVE UP LANE DESIGNATOR "ATM"	3.1sF
E14	TC-CL-W	Non-Illuminated Clearance Sign	2.1sr
E15	TC-P-ADA-V-RE	Pole Mounted ADA Parking Retulatory Sign w/ Van Access	2sF
E16	SUR-TTW-U-4-TP	ILLUMINATED THIN PROFILE ATM SURROUND	
E19	AWN-WU-SHED	Non-Illuminated Fabric Shed Awning (No Branding)	TBD
E20	AWN-WU-SHED	Non-Illuminated Fabric Shed Awning (No Branding)	TBD
E21	AWN-WU-SHED	Non-Illuminated Fabric Shed Awning (No Branding)	TBD
E22	AWN-WU-SHED	Non-Illuminated Fabric Shed Awning (No Branding)	TBD
ı			

Interior Signs







TITLE	Chase New Builds	DWG BY MMS	DATE	10/29/18	
ADDRESS	Hunt Valley - York Road		DWG NUM	B80684	
	11330 York Road Cockeysville, MD 21030		SHEET	3	1




E11, E12 - D-5-RE (NO BRANDING)

NOTE: Per city code no branding allowed.

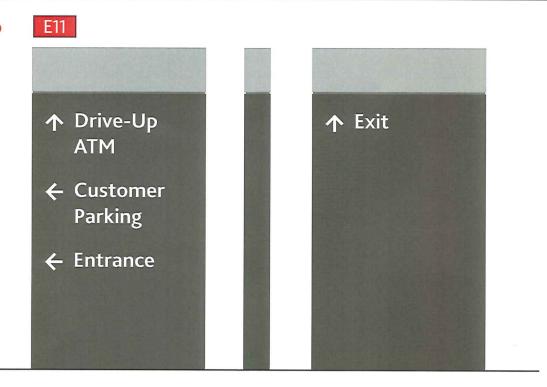

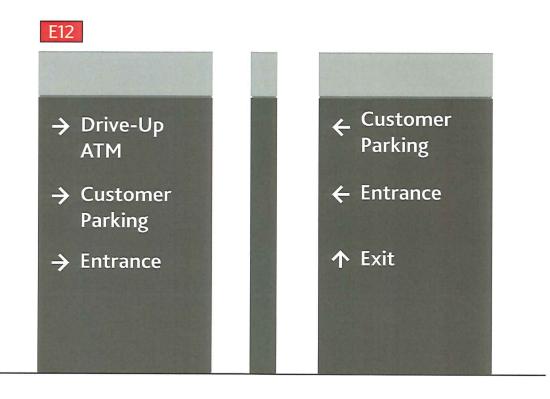

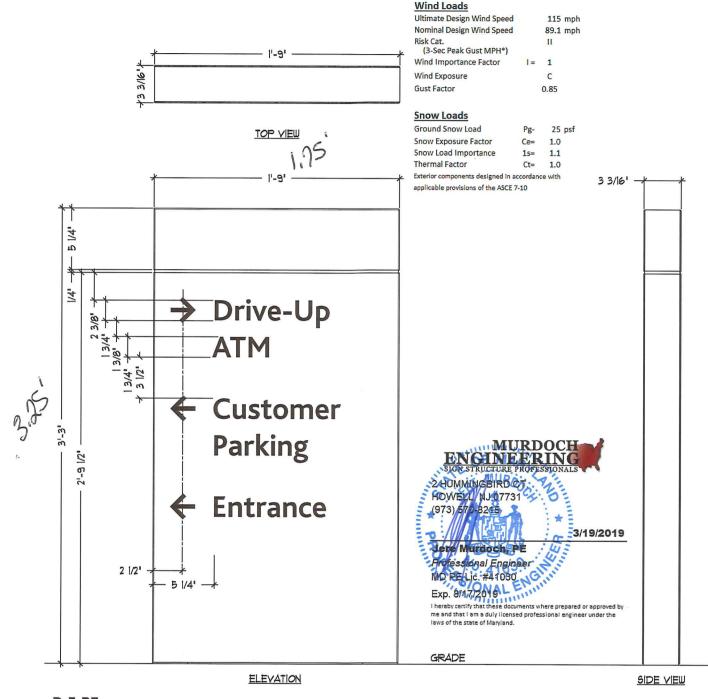

Designed Per IBC 2015 MD Edition
Designed Per Maryland Building Performance Standard.

D-5-RE
DOUBLE-FACED NON-ILLUMINATED DIRECTIONAL (RE-ENGINEERED) (NO BRANDING)
SCALE: NTS



TITLE	Chase New Builds	DWG BY MMS	DATE	10/29/18	
ADDRESS	Hunt Valley - York Road 11330 York Road		DWG NUM	B80684	
	Cockeysville, MD 21030		SHEET	8	



3/16" 3

FRONT ELEVATION

D5-RE (E11)

QTY: 1

SCALE: 1-1/2" = 1'-0"

All Exposed Painted Surfaces Shall Be Coated With Matthews #282-208SP VOC Gloss Clear, With Minimum 2 Mils Dry Film Thickness (DFT) Designed Per IBC 2015 MD Edition

Designed Per Maryland Building Performance Standards

Wind Loads

REAR ELEVATION

SCALE: 1-1/2" = 1'-0"

Ultimate Design Wind Speed 115 mph Nominal Design Wind Speed 89.1 mph Risk Cat. (3-Sec Peak Gust MPH*) Wind Importance Factor 1 = 1

Wind Exposure C Gust Factor 0.85

Pg- 25 psf Snow Exposure Factor Ce= 1.0 Snow Load Importance 1s= 1.1 Thermal Factor Ct= 1.0 Exterior components designed In accordance with

CUSTOMER: CHASE

JOB NUMBER:

CHS.NB.408

SIGN TYPE:

SITE SIGNAGE

PHILADELPHIASIGN

BRINGING THE WORLD'S BRANDS TO LIFE

707 West Spring Garden Street

Palmyra, New Jersey 08065

www.philadelphiasign.com

Phone: 856.829.1460

Fax: 856.829.8549

LOCATION:

11330 YORK RD.

COCKEYSVILLE, MD 21030

DATE:

2/26/19

DRAWN BY:

DRC

REVISION: Number: Date:

By:

ENG DEPT

SHEET:

14 OF 22

DWG NUMBER:

B82286

ENGINEER SEAL:

ENCINEERING

2 HUMMINGBIRD CTO

HOWELL, NJ 07731 (973) 570-8215


3/19/2019

Jere Murdoch, PE Professional Engineer

MD PE 41030 NO Exp. 8/17/2019

I hereby certify that these documents where prepared or approved by me and that I am a duly licensed professional engineer under the laws of the state of Maryland.

THIS IS AN ORIGINAL UNPUBLISHED DRAWING CREATED BY PSCO. IT IS SUBMITTED FOR YOUR PERSONAL USE IN CONJUNCTION WITH A PROJECT BEING PLANNED FOR YOU BY PSCO. IT IS NOT TO BE SHOWN TO ANYONE OUTSIDE YOUR ORGANIZATION NOR IS IT TO BE USED, COPIED, REPRODUCED, OR EXHIBITED IN ANY FASHION.

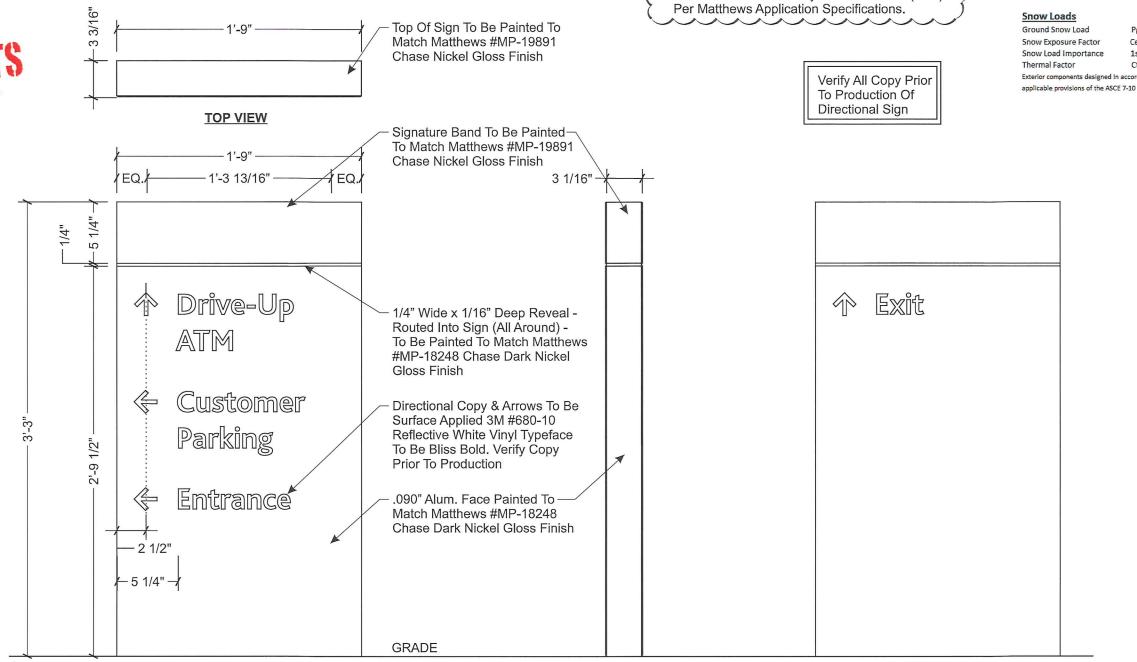

SIDE VIEW

SCALE: 1-1/2" = 1'-0"

Note: This sign is intended to be installed in accordance with the requirements of Article 600 of the National Electrical Code and/or other applicable local codes. This includes proper grounding and bonding of the sign.

PERMITS ONLY 3/16"

3

5 1/4"

1/2"

2'-9

- 2 1/2"

– 5 1/4" –

1/4"

EQ.

All Exposed Painted Surfaces Shall Be Coated With Matthews #282-208SP VOC Gloss Clear, With Minimum 2 Mils Dry Film Thickness (DFT) Per Matthews Application Specifications.

Verify All Copy Prior To Production Of Directional Sign Designed Per IBC 2015 MD Edition

Designed Per Maryland Building Performance Standards

Wind Loads

Ultimate Design Wind Speed 115 mph
Nominal Design Wind Speed 89.1 mph
Risk Cat. (3-Sec Peak Gust MPH*)
Wind Importance Factor I = 1

Wind Importance Factor I = 1
Wind Exposure C
Gust Factor 0.85

Snow Loads

 Ground Snow Load
 Pg 25 psf

 Snow Exposure Factor
 Ce=
 1.0

 Snow Load Importance
 1s=
 1.1

 Thermal Factor
 Ct=
 1.0

Exterior components designed in accordance with

applicable provisions of the ASCE 7-10

← Customer

Entrance

î Exit

Parking

FRONT ELEVATION

D5-RE (E12)

QTY: 1

SCALE: 1-1/2" = 1'-0"

TOP VIEW

-1'-9"

1'-3 13/16"

Drive-Up

Customer

Entrance

EQ.

<u>SIDE VIEW</u> SCALE: 1-1/2" = 1'-0"

Top Of Sign To Be Painted To

Signature Band To Be Painted— To Match Matthews #MP-19891

1/4" Wide x 1/16" Deep Reveal -

To Be Painted To Match Matthews #MP-18248 Chase Dark Nickel

Directional Copy & Arrows To Be

Surface Applied 3M #680-10 Reflective White Vinyl Typeface

To Be Bliss Bold. Verify Copy

.090" Alum. Face Painted To-

Match Matthews #MP-18248

Chase Dark Nickel Gloss Finish

Prior To Production

Routed Into Sign (All Around) -

Gloss Finish

GRADE

3 1/16"

Match Matthews #MP-19891

Chase Nickel Gloss Finish

Chase Nickel Gloss Finish

REAR ELEVATION SCALE: 1-1/2" = 1'-0"

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Phone: 856.829.1460 Fax: 856.829.8549 www.philadelphiasign.com

CUSTOMER:

CHASE

JOB NUMBER:

CHS.NB.408

SIGN TYPE:

SITE SIGNAGE

LOCATION:

11330 YORK RD.

COCKEYSVILLE, MD 21030

DATE:

2/26/19

DRAWN BY:

REVISION:

Number: Date:

SHEET:

15 OF 22

DWG NUMBER:

ENGINEER SEAL:

OFMURDOCH ENGINEERING

2 HUMMINGBIRD CT. HOWELY NJ 97731 (973) 57 / 82 15 7

3/19/2019

Bv:


ENG DEPT

Jera Murdoch, PB Professional Engineer MD PE Lic, #41030

Exp. 8/17/2019

I hereby certify that these documents where prepared or approved by me and that I am a duly licensed professional engineer under the laws of the state of Maryland.

PERMITS ONLY

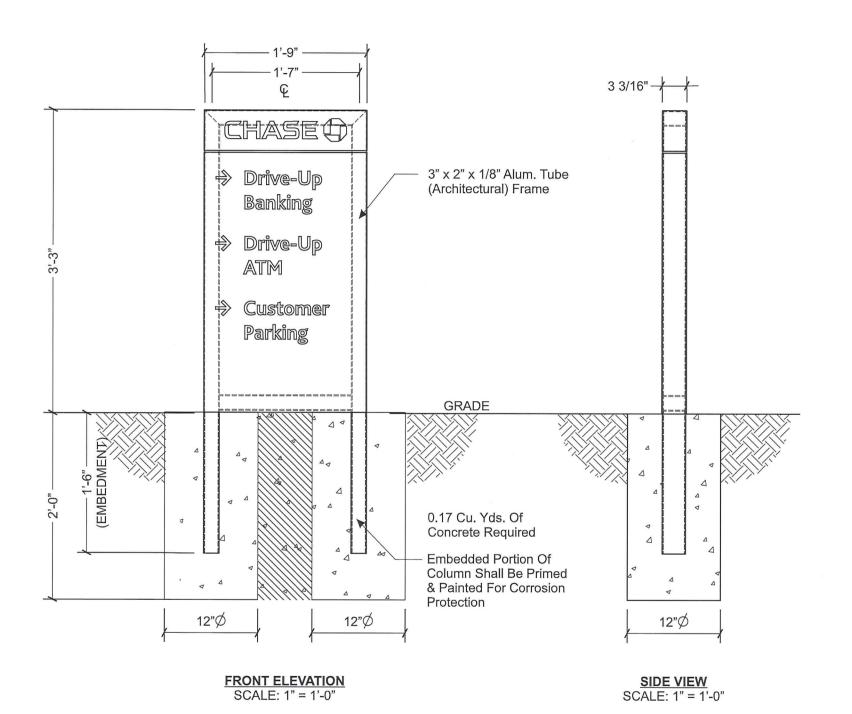

Note: This sign is intended to be installed in accordance with the requirements of Article 600 of the National Electrical Code and/or other applicable local codes. This includes proper grounding and bonding of the sign.

Designed Per IBC 2015 MD Edition

Designed Per Maryland Building Performance Standards

Wind Loads

Snow Loads

 Ground Snow Load
 Pg 25 psf

 Snow Exposure Factor
 Ce=
 1.0

 Snow Load Importance
 1s=
 1.1

 Thermal Factor
 Ct=
 1.0

 Exterior components designed In accordance with

applicable provisions of the ASCE 7-10

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Ву:

ENG DEPT

SHEET:

16 OF 22

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Jere Murdden PE Professional Engineer MD PE Lic: #41030

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