# FULLERTON FIRE STATION #8 - RENOVATION & ADDITION 4401 FITCH AVENUE, NOTTINGHAM, MARYLAND, 21236

# **BID/PERMIT**

TAG	DESCRIPTION
(101A)	DOOR TAG
NUMBER OF SHELVES	CASEWORK TAG
ASEWORK CABINET DEPTH  402  30.00  84.00  ABINET CABINET DEPTH  CABINET HEIGHT	AS OUTLINED IN THE ARCHITECTURAL WOODWORK INSTITUTE (AWI) STANDARDS
(1t)	SPECIALTY EQUIPMENT TAG
1 A	COLUMN LINE DESIGNATION TAG
REFERENCE 0'-0"	LEVEL ELEVATION TAG
PT	NORTH ARROW TAG T = TRUE NORTH P = PROJECT NORTH
ROOM 101	ROOM NAME & NUMBER TAG
1 A101	SECTION TAG
1 A101	CALLOUT / DETAIL
0'-0"	SPOT ELEVATION TAG
DRAWING TITLE DRAWING SCALE	DETAIL / DRAWING TITLE TAG
CLG-12 TYPE 1'-0" HEIGHT	CEILING TAG
99	PARTITION TAG
?	MATERIAL TAG
Û	WINDOW TAG
6:12	ROOF SLOPE ANNOTATION
1 A101	ELEVATION TAG

PATTERN	DESCRIPTION
	BRICK
	CMU MASONRY
	CONCRETE SECTION
	POROUS FILL
	EARTH
	PLYWOOD
	GYPSUM BOARD SECTION
	RIGID INSULATION
	BATT INSULATION
	END GRAIN LUMBER
	WOOD BLOCK OR SHIM
	FINISH WOOD

	_				
SYMBOL! &	5 - AND	FIN - FIN FL -	FINISH FINISHED FLOOR	PSF - PSI -	POUNDS PER SQUARE FOOT POUNDS PER SQUARE INCH
<b>x</b> @	- AND - AT	FL -	FLOOR	PT -	PRESSURE TREATED
)	- DIAMETER	FLEX -	FLEXIBLE	PTD -	PAINTED
]	- SQUARE	FLUOR -	FLUORESCENT	PVC -	POLYVINYL CHLORIDE
		FND -	FOUNDATION	PVMT -	PAVEMENT
_	- ANCHOR BOLT	FPM - FRT -	FEET PER MINUTE FIRE RETARDANT TREATED	PWT -	PREFABRICATED WOOD TRUS
	- ABOVE	FSK -	FOIL SCRIM KRAFT	R	
ACOUST		FT -	FEET, FOOT	R -	RADIUS
ACT	<ul> <li>ACOUSTIC CEILING TILE</li> </ul>	FT -	FLOOR TRANSITION	RCP -	REFLECTED CEILING PLAN
	- ABOVE FINISH FLOOR	FTG -	FOOTING	REINF -	REINFORCING, REINFORCED
	- AUTHORITY HAVING JURISDICTION			RES -	RESINOUS
ALUM AP	- ALUMINUM		CACE CALICE	REQD -	REQUIRED REVISION
APPROX	<ul><li>ACCESS PANEL</li><li>APPROXIMATELY</li></ul>	GA - GALV -	GAGE, GAUGE GALVANIZED	REV - RGD -	RIGID
ARCH		GALV -	GLASS, GLAZING	RM -	ROOM
		GND -	GROUND	RO -	ROUGH OPENING
В		GRTG -	GRATING	RST -	REINFORCING STEEL
3.C.	- BOTTOM CHORD	GWB -	GYPSUM WALL BOARD	_	
	- BLOCK			S	CAAADT DOADD
	- BUILDING			SB -	SMART BOARD
BLKG BLKHD	- BLOCKING - BULKHEAD	H - HC -	HIGH / HEIGHT HANDICAPPED	SCD - SCHED -	SEE CIVIL DRAWINGS SCHEDULE
	- BEAM	HD -	HEAD	SD -	STORM DRAIN
	- BOTTOM OF	HM -	HOLLOW METAL	SED -	SEE ELECTRICAL DRAWINGS
	- BASIS OF DESIGN	HORIZ -	HORIZONTAL	SECT -	SECTION
ВОТ	- BOTTOM	HR -	HOUR	SF -	SQUARE FOOT
J	- BULLET RESISTANT	HT -	HEIGHT	SI -	SQUARE INCH
BRNG	- BEARING			SIM -	SIMILAR
_		I		SLP -	SLOPE
	- CENTER LINE	ID - IN -	INSIDE DIAMETER INCH	SMD - SPCI -	SEE MECHANICAL DRAWINGS SPECIAL
Ĺ CFCI	- CENTER LINE - CONTRACTOR FURNISHED,	IN - INFO -	INCH INFORMATION	SPCL - SPEC -	SPECIAL SPECIFICATIONS
CI CI	CONTRACTOR FORMSTILLED,	INSUL -	INSULATION	SPLY -	SUPPLY
CFOI	- CONTRACTOR FURNISHED,		missis more	SQ -	SQUARE
	OWNER INSTALLED	J		SS -	STAINLESS STEEL
CFLS	<ul> <li>COUNTER FLASHING</li> </ul>	JB -	JUNCTION BOX	SSD -	SEE STRUCTURAL DRAWINGS
CJ	- CONTROL JOINT	JM -	JAMB	ST -	STREET
CL	- CLOSET	JST -	JOIST	STD -	STANDARD
	- CEILING	JT -	JOINT	STL -	STEEL
	<ul> <li>CONCRETE MASONRY UNIT</li> <li>CONDUIT</li> </ul>	ı		STOR - STRUCT -	STORAGE STRUCTURAL
	- COLUMN	LG -	LONG	SURF -	SURFACE
	- COORDINATE	LL -	LIVE LOAD	SUSP -	SUSPENDED
CONC	- CONCRETE	LSC -	LIFE SAFETY CODE	SW -	SWITCH
CONSTR	- CONSTRUCTION	LTG -	LIGHTING	SYS -	SYSTEM
CONT					
C.T. / CT			AAA CUUNIE		
CPT	- CARPET / CARPET TILE	MACH -	MACHINE	T & B - T.B	TOP AND BOTTOM
	- COUNTERSUNK - CUBIC	MAT'L - MAX -	MATERIAL MAXIMUM	T.B T.B.D	TACK BOARD TO BE DETERMINED
	- CUBIC FOOT	MBT -	MARBLE THRESHOLD	TEMP -	TEMPERATURE
CU YD		MECH -	MECH	THK -	THICK
		MEP -	MECHANICAL / ELECTRICAL /	THRES -	THRESHOLD
			PLUMBING	T&G -	TONGUE & GROOVE
D	- DEEP / DEPTH	MFGR -	MANUFACTURER	T0 -	TOP OF
	- DEGREE	MH -	MANHOLE	TOB -	TOP OF BEARING POINT
	- DIAMETER	MIN - MO -	MINIMUM	TOC -	TOP OF CONCRETE
	- DIMENSION - DEAD LOAD	MSNRY -	MASONRY OPENING MASONRY	TOF - TOM -	TOP OF FOOTING TOP OF MASONRY
	- DAMPER	M.T	METAL THRESHOLD	TOP -	TOP OF PAVEMENT, PARAPET
DN	- DOWN	MTL -	METAL	TOS -	TOP OF STEEL
DR	- DOOR	MTD -	MOUNTED	TRTD -	TREATED
DS	- DOWNSPOUT			T.S	TRANSITION STRIP
DTL	- DETAIL			TYP -	TYPICAL
DWG	- DRAWING	NA -	NOT APPLICABLE		
<b>=</b>		NIC - NO -	NOT IN CONTRACT NUMBER	<b>U</b> UGND -	UNDERGROUND
	- EACH	NO - NTS -	NOT TO SCALE	UGND - UL -	UNDERWRITERS LAB
	- EXTERIOR INSULATON AND	1413 -	NOT TO JUNE	UNO -	UNLESS NOTED OTHERWISE
	FINISHING SYSTEM	0		UON -	UNLESS OTHERWISE NOTED
ELEC	- ELECTRICAL	O/C -	ON CENTER		
EL	- ELEVATION	OD -	OUTSIDE DIAMETER	V	
	- ELEVATION	OFIC -	OWNER FURNISHED,	VB -	VAPOR BARRIER
ELMA		050:	CONTRACTOR INSTALLED	VCT -	
EJ ENIT	- EXPANSION JOINT	OFOI -	OWNER FURNISHED,	VERT -	
ENT EQ	- ENTRANCE, ENTRY	OPNG -	OWNER INSTALLED OPENING	VIF - VOL -	VERIFY IN FIELD VOLUME
	- EQUAL - ESTIMATE	OPNG -	OPPOSITE	VOL -	V OLUIVIL
	- EACH WAY	OPP HND-	OPPOSITE HAND	W	
	- EXISTING	OV -	OVER	W -	WIDE / WIDTH
	- EXTERIOR	OVHD -	OVERHEAD	W/ -	WITH
EXP	- EXPOSED			W/0 -	WITHOUT
EXP JT				W.B	WHITEBOARD
_		P.LAM -	PLASTIC LAMINATE	WD -	WOOD
	EALIDENIJEIT	PLY -	PLYWOOD	WR -	WATER RESISTANT
: -D	- FAHRENHEIT	PLYWD -	PLYWOOD	WTRPRF -	WATERPROOF
FD F.E.	<ul><li>FLOOR DRAIN</li><li>FIRE EXTINGUISHER</li></ul>	PNLBD -	PANELBOARD PAINT	WWF -	WELDED WIRE FABRIC WELDED WIRE MESH
.E.	- FIRE EXTINGUISHER - FIRE EXTINGUISHER CABINET	PNT/ PT  - POLYISO -	PAINT POLYISOCYANURATE	WWM -	AAEFDED AAIKE IAIE2H
FFC	I INL LATINGUIDHER CADINET				
	- FINICHED ELOOR	PRE			
FF .	<ul> <li>FINISHED FLOOR</li> <li>FINISHED FLOOR ELEVATION</li> </ul>	PRESS - PROJ -	PRESSURE PROJECT		
F F EL	<ul> <li>FINISHED FLOOR</li> <li>FINISHED FLOOR ELEVATION</li> <li>FINISHED GRADE</li> </ul>	PRESS - PROJ - PROP -	PROJECT PROPERTY		

# 09/20/24

PROJECT TEAM

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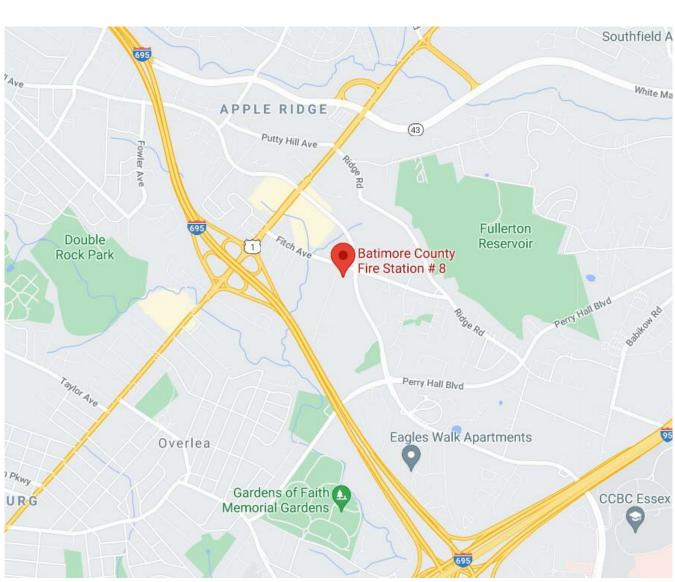
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### **CORRELATION AND INTENT OF THE CONTRACT DOCUMENTS**

MANUAL IS TO INCLUDE ALL ITEMS NECESSARY FOR THE PROPER EXECUTION AND COMPLETION OF THE EITHER DOCUMENT NOT CLARIFIED BY ADDENDUM, THE BETTER QUALITY OR GREATER QUANTITY OF



SUBDIVISION: FULLERTON

**VICINITY MAP** NOT TO SCALE

	<b>DRAWING INDEX</b>
SHEET NUMBER	SHEET NAME
GENERAL	/ CODE
G000	COVER SHEET
G001	CODE ANALYSIS
G002	CODE PLANS
G003	TYPICAL ACCESSIBILITY GUIDELINES
CIVIL - GE	
C1.00	PLOT PLAN
C1.01	GENERAL NOTES
CIVIL - DE	MOLITION
C2.00	EXISTING CONDITIONS & DEMOLITION PLAN
CIVIL - NE	W WORK
C3.00	SITE & GRADING PLAN
C3.01	SITE DETAILS
C3.02	UTILITY PLAN
C3.03	STORM DRAIN PROFILES
ARCHITEC AD100 AD101	ARCHITECTURAL SITE DIAGRAMS  DEMOLITION PLANS
AD101 AD102	DEMOLITION PLANS DEMOLITION - AREA OF WORK
ARCHITEC	TURAL - NEW WORK
A100	REFERENCE PLAN
A101	DIMENSION PLAN
A102	BUILDING ASSEMBLY TYPES & DETAILS
A103	FINISH PLAN, SCHEDULE & DETAILS
A200	BUILDING ELEVATIONS
A300	BUILDING SECTIONS
A400	WALL SECTIONS STAIR DETAILS
A401 A500	ROOF PLAN
A501 A600	ROOF DETAILS DOOR/WINDOW SCHEDULE & DETAILS
	DOOR/WINDOW SCHEDULE & DETAILS  DOOR/WINDOW SCHEDULE & DETAILS
A601 A700	ENLARGED PLANS & INT. ELEVATIONS
	INTERIOR ELEVATIONS
A702 A800	REFLECTED CEILING PLAN
	10.000
A900	TYPICAL ADA SIGNAGE DETAILS
	RAL - NEW WORK
S101	STRUCTURAL PLANS
S201	STRUCTURAL GENERAL NOTES & SCHEDULES

STRUCTURAL SECTIONS & DETAILS

SHEET NUMBER	SHEET NAME
S402	STRUCTURAL SECTIONS & DETAILS
MECHANI	CAL - GENERAL
M001	MECHANICAL LEGEND, ABBREVIATIONS & DETAILS
MECHANI	CAL - DEMOLITION
MD100	MECHANICAL - FIRST FLOOR AND ROOF PLAN - DEMOLITION
	CAL - NEW WORK
M100	MECHANICAL - FIRST FLOOR AND ROOF PLAN - NEW WORK
M400	MECHANICAL SECTIONS
M500	MECHANICAL DETAILS I
M501	MECHANICAL DETAILS II
M600	MECHANICAL SCHEDULES I
M601	MECHANICAL SCHEDULES II
PLUMBIN	G - GENERAL
P001	PLUMBING LEGEND, ABBREVIATIONS & DETAILS
DITIMBINI	
FEOIVIDIIN	G - NEW WORK
P100	G - NEW WORK PLUMBING - FIRST FLOOR PART PLANS - NEW WORK
	1
P100	PLUMBING - FIRST FLOOR PART PLANS - NEW WORK
P100 P101	PLUMBING - FIRST FLOOR PART PLANS - NEW WORK PLUMBING - BASEMENT FLOOR PLAN AND SITE PLAN
P100 P101 P500 P600	PLUMBING - FIRST FLOOR PART PLANS - NEW WORK PLUMBING - BASEMENT FLOOR PLAN AND SITE PLAN PLUMBING RISER DIAGRAMS
P100 P101 P500 P600 ELECTRIC	PLUMBING - FIRST FLOOR PART PLANS - NEW WORK PLUMBING - BASEMENT FLOOR PLAN AND SITE PLAN PLUMBING RISER DIAGRAMS PLUMBING SCHEDULES
P100 P101 P500 P600 ELECTRICA	PLUMBING - FIRST FLOOR PART PLANS - NEW WORK PLUMBING - BASEMENT FLOOR PLAN AND SITE PLAN PLUMBING RISER DIAGRAMS PLUMBING SCHEDULES  AL - GENERAL ELECTRICAL SYMBOLS & ABBREVIATIONS
P100 P101 P500 P600 ELECTRICA E001	PLUMBING - FIRST FLOOR PART PLANS - NEW WORK PLUMBING - BASEMENT FLOOR PLAN AND SITE PLAN PLUMBING RISER DIAGRAMS PLUMBING SCHEDULES  AL - GENERAL ELECTRICAL SYMBOLS & ABBREVIATIONS  AL - DEMOLITION
P100 P101 P500 P600 ELECTRICA E001 ELECTRICA ED100	PLUMBING - FIRST FLOOR PART PLANS - NEW WORK PLUMBING - BASEMENT FLOOR PLAN AND SITE PLAN PLUMBING RISER DIAGRAMS PLUMBING SCHEDULES  AL - GENERAL ELECTRICAL SYMBOLS & ABBREVIATIONS  AL - DEMOLITION POWER & SYSTEMS - FIRST & BASEMENT FLOOR PLANS - DEMOLITION
P100 P101 P500 P600 ELECTRICA E001	PLUMBING - FIRST FLOOR PART PLANS - NEW WORK PLUMBING - BASEMENT FLOOR PLAN AND SITE PLAN PLUMBING RISER DIAGRAMS PLUMBING SCHEDULES  AL - GENERAL ELECTRICAL SYMBOLS & ABBREVIATIONS  AL - DEMOLITION POWER & SYSTEMS - FIRST & BASEMENT FLOOR PLANS - DEMOLITION POWER & SYSTEMS - ROOF PLAN - DEMOLITION
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P100 P101 P500 P600 ELECTRICA E001 ELECTRICA ED100 ED101 ED102	PLUMBING - FIRST FLOOR PART PLANS - NEW WORK PLUMBING - BASEMENT FLOOR PLAN AND SITE PLAN PLUMBING RISER DIAGRAMS PLUMBING SCHEDULES  AL - GENERAL ELECTRICAL SYMBOLS & ABBREVIATIONS  AL - DEMOLITION POWER & SYSTEMS - FIRST & BASEMENT FLOOR PLANS - DEMOLITION POWER & SYSTEMS - ROOF PLAN - DEMOLITION
P100 P101 P500 P600 ELECTRICA E001 ELECTRICA ED100 ED101 ED102	PLUMBING - FIRST FLOOR PART PLANS - NEW WORK PLUMBING - BASEMENT FLOOR PLAN AND SITE PLAN PLUMBING RISER DIAGRAMS PLUMBING SCHEDULES  AL - GENERAL ELECTRICAL SYMBOLS & ABBREVIATIONS  AL - DEMOLITION POWER & SYSTEMS - FIRST & BASEMENT FLOOR PLANS - DEMOLITION POWER & SYSTEMS - ROOF PLAN - DEMOLITION LIGHTING - FIRST FLOOR PLAN - DEMOLITION
P100 P101 P500 P600  ELECTRICA E001  ELECTRICA ED100 ED101 ED102  ELECTRICA	PLUMBING - FIRST FLOOR PART PLANS - NEW WORK PLUMBING - BASEMENT FLOOR PLAN AND SITE PLAN PLUMBING RISER DIAGRAMS PLUMBING SCHEDULES  AL - GENERAL ELECTRICAL SYMBOLS & ABBREVIATIONS  AL - DEMOLITION POWER & SYSTEMS - FIRST & BASEMENT FLOOR PLANS - DEMOLITION POWER & SYSTEMS - ROOF PLAN - DEMOLITION LIGHTING - FIRST FLOOR PLAN - DEMOLITION
P100 P101 P500 P600  ELECTRICA E001  ELECTRICA ED100 ED101 ED102  ELECTRICA	PLUMBING - FIRST FLOOR PART PLANS - NEW WORK PLUMBING - BASEMENT FLOOR PLAN AND SITE PLAN PLUMBING RISER DIAGRAMS PLUMBING SCHEDULES  AL - GENERAL ELECTRICAL SYMBOLS & ABBREVIATIONS  AL - DEMOLITION POWER & SYSTEMS - FIRST & BASEMENT FLOOR PLANS - DEMOLITION POWER & SYSTEMS - ROOF PLAN - DEMOLITION LIGHTING - FIRST FLOOR PLAN - DEMOLITION  AL - NEW WORK POWER & SYSTEMS - FIRST & BASEMENT FLOOR PLANS - NEW WORK
P100 P101 P500 P600  ELECTRICA E001  ELECTRICA ED100 ED101 ED102  ELECTRICA E100 E101	PLUMBING - FIRST FLOOR PART PLANS - NEW WORK PLUMBING - BASEMENT FLOOR PLAN AND SITE PLAN PLUMBING RISER DIAGRAMS PLUMBING SCHEDULES  AL - GENERAL ELECTRICAL SYMBOLS & ABBREVIATIONS  AL - DEMOLITION POWER & SYSTEMS - FIRST & BASEMENT FLOOR PLANS - DEMOLITION POWER & SYSTEMS - ROOF PLAN - DEMOLITION LIGHTING - FIRST FLOOR PLAN - DEMOLITION  AL - NEW WORK POWER & SYSTEMS - FIRST & BASEMENT FLOOR PLANS - NEW WORK POWER & SYSTEMS - ROOF PLAN - NEW WORK
P100 P101 P500 P600  ELECTRICA E001  ELECTRICA ED100 ED101 ED102  ELECTRICA E100 E101 E102	PLUMBING - FIRST FLOOR PART PLANS - NEW WORK PLUMBING - BASEMENT FLOOR PLAN AND SITE PLAN PLUMBING RISER DIAGRAMS PLUMBING SCHEDULES  AL - GENERAL ELECTRICAL SYMBOLS & ABBREVIATIONS  AL - DEMOLITION POWER & SYSTEMS - FIRST & BASEMENT FLOOR PLANS - DEMOLITION POWER & SYSTEMS - ROOF PLAN - DEMOLITION LIGHTING - FIRST FLOOR PLAN - DEMOLITION  AL - NEW WORK POWER & SYSTEMS - FIRST & BASEMENT FLOOR PLANS - NEW WORK POWER & SYSTEMS - ROOF PLAN - NEW WORK LIGHTING - FIRST FLOOR PLAN - NEW WORK

THIS LIST OF ABBREVIATIONS IS A GUIDE TO ABBREVIATIONS WHICH MAY BE USED IN THESE DOCUMENTS. ABBREVIATIONS
NOT LISTED MAY ALSO BE USED.

SEAL	PROFESSIONAL CERTIFICATION		AS-BUILT / REVISION		AS-BUILT / REVISION BY		BY	DATE	P.W.A. NO.	KEY SHEET	POSITION SHT DRAWING SCAL		IG SCALE			
OF MARY	I HEREBY CERTIFY THAT THESE DOCUMENTS WERE PREPARED OR APPROVED BY ME, AND THAT I AM A DULY LICENSED PROFESSIONAL ARCHITECT UNDER THE LAWS OF THE STATE OF MARYLAND.  LICENSE NO. 15505 EXPIRATION DATE: 08-18-2026		BID/PERMIT			09/20/24	-	MSW	27NE21	PLAN SCALE:	As indicated	APPROVED BY:	Mihai T. F	Petrisor		
							R.O.W NO.	-	-			_		DIRECT		
- 1/10/14							_	† -	-	PROFILE SCALE:	<u>-</u>	DATE:	DATE: 10/03/202	2024		
								-	-					-		
	ARCHITECT:	DGN BY:	BUREAU OF ENGINEERING AND CONSTRUCTION		HIGH	IWAYS	STRUCTURES	STORM DRAINS	SEWER	WATER	FIELD ENGINEER	PROPE	ERTY MANAG	EMENT		
ACHITECHIN	PRINCIPAL ARCHITECT  MANNS WOODWARD STUDIOS	DWN BY:	REVIEWED BY:									APPROVED BY:	Steve Ga			
DATE: 09/20/24	10839-D PHILADELPHIA ROAD WHITE MARSH, MARYLAND 21162 (P) 410-344-1460	CHKD BY:	DATE REVIEWED:									DATE:10	/04/2024	СН		

BALTIMORE COUNTY OFFICE OF BUDGET AND FINANCE, PROPERTY MANAGEMENT

FULLERTON FIRE STATION #8 - RENOVATION & ADDITION

COVER SHEET

4401 FITCH AVENUE, NOTTINGHAM, MARYLAND, 21236

SHEET DESIGNATION | CONTRACT NUMBER G000 JOB ORDER NUMBER 241**-**220**-**0054**-**0012 DRAWING NUMBER 2022-2320

FILE NO.: 8

#### CODE ANALYSIS - SUMMARY APPLICABLE CODES SQUARE FOOTAGE TOTALS PROJECT 2018 **EXISTING FOOTPRINT** 7,749 GSF FULLERTON FIRE NFPA 101: LIFE SAFETY STATION #8 INTERNATIONAL EXISTING BUILDING CODE 2015 RENOVATION & ADDITION INTERNATIONAL BUILDING CODE 2015 FIRST FLOOR 7,749 GSF 2015 PARTIAL BASEMENT 1,120 NSF INTERNATIONAL MECHANICAL CODE NATIONAL ELECTRIC CODE 2020 **EXISTING BUILDING** 8,869 GSF NATIONAL STANDARD PLUMBING CODE 2015 2015 **PROPOSED ADDITION** 194 GSF INTERNATIONAL ENERGY CODE

#### PROJECT DESCRIPTION

THE PROPOSED PROJECT IS A RENOVATION AND ADDITION TO THE EXISTING BALTIMORE COUNTY STATION 8 FIRE STATION. THE EXISTING BUILDING IS A SINGLE STORY STRUCTURE WITH PARIETAL BASEMENT. THE PROJECT PROPOSES AN INTERIOR RENOVATION TO THE CORE OF THE BUILDING BY DEMOLISHING THE EXISTING LOCKER ROOMS AND ADDING FIVE SINGLE OCCUPANT TOILET AND SHOWER ROOMS WITHIN THE EXISTING BUNK ROOM AND SHOWER LOCKER AREA. TO MAKE UP FOR THE REDUCED BUNK ROOM SPACE, THE PROJECT LOOKS TO ADD A SMALL 8'X24' (194 SF) ADDITION TO THE REMAINING BUNK ROOM AREA TO ACCOMMODATE FOR THE LOSS OF EXISTING BUNK ROOM SPACE. IN ADDITION TO THE ABOVE WORK THE PROJECT WILL ALSO UPDATE THE BUILDINGS EXISTING MECHANICAL SYSTEM WITHIN THE BUNK ROOM, KITCHEN, AND ADMINISTRATIVE AREAS OF THE BUILDING.

STATION 8'S FIRST FLOOR IS APPROXIMATELY 7,749 GSF. THE TOTAL FIRST FLOOR WORK AREA IS 2,857 SF (EXCLUSIVE OF THE 194 SF ADDITION) AND CONSTITUTES 37% OF THE BUILDING FOOTPRINT. THE STRUCTURE IS AN ASSUMED TYPE IIB CONSTRUCTION TYPE THAT IS NON-SPRINKLERED. THE EXISTING USE AND EXISTING OCCUPANT LOAD WILL REMAIN AS IS AND WILL NOT CHANGE OR INCREASE.

WORK AREA SF & PERCENTAGE - IEBC 501.2	COMPLIANCE METHOD - IEBC 301 & 504
LEVEL 1 ALTERATION - 1,212 SF OF 7,749 GSF TOTAL = 16% OF TOTAL BUILDING FOOTPRINT.	301.1.2 - WORK AREA COMPLIANCE METHOD.
LEVEL 2 ALTERATION - 1,645 SF OF 7,749 GSF TOTAL = 21% OF TOTAL BUILDING FOOTPRINT GSF.	PROVISIONS OF CHAPTERS 7, 8, AND 9.
TOTAL WORK AREA = 37% OF TOTAL BUILDING FOOTPRINT AND THEREFORE THE WORK AREA IS LESS THAN 50% OF THE BUILDING AREA.	
COMPLIANCE - IEBC 801.3	MEANS OF EGRESS - IEBC 805.1
ALL NEW CONSTRUCTION ELEMENTS, COMPONENTS, SYSTEMS, AND SPACES SHALL COMPLY WITH THE REQUIREMENTS OF THE IBC.	THIS SECTION DOES NOT APPLY TO THIS PROJECT BECAUSE THERE IS ONLY A SINGLE TENANT WITHIN THE WORK AREA.
ACCESSIBILITY - IEBC 806 & 705	STRUCTURE - IEBC 807.3
ALL NEW WORK SHALL COMPLY WITH THE ACCESSIBILITY REQUIREMENTS. ALL EXISTING ELEMENTS TO REMAIN CURRENTLY COMPLY.	THE MINIMUM DESIGN LOADS ON EXISTING ELEMENTS OF A STRUCTURE THAT DO NOT SUPPORT ADDITIONAL LOADS AS A RESULT OF AN ALTERATION SHALL BE THE LOADS APPLICABLE AT THE TIME THE BUILDING WAS CONSTRUCTED.
ELECTRICAL - IEBC 808	MECHANICAL - IEBC 809
ALL NEWLY INSTALLED ELECTRICAL EQUIPMENT & WIRING SHALL COMPLY WITH THE REQUIREMENTS OF NFPA 70.	ALL NEWLY INSTALLED MECHANICAL WORK SHALL COMPLY WITH THE INTERNATIONAL MECHANICAL CODE.
PLUMBING - IEBC 810	ENERGY CONSERVATION - IEBC 811 & 707
ALL NEWLY INSTALLED PLUMBING WORK SHALL COMPLY WITH THE INTERNATIONAL PLUMBING CODE.	THE ALTERATIONS SHALL COMPLY TO THE ENERGY REQUIREMENTS OF THE IECC AS THEY RELATE TO NEW CONSTRUCTION ONLY.
ADDITIONS - IEBC 1102	
NEW ADDITION SHALL NOT EXCEED THE HEIGHT AND AREA LIMITATIONS BEYOND THAT PERMITTED UNDER CHAPTER 5 OF THE IBC.	

INTERNATIONAL BUILDING CO	DE 2015						
EXISTING USE CLASSIFICATIONS - CH. 3	MEANS OF EGRESS CAPACITY 1005.3.2						
B - BUSINESS - FIRE DEPARTMENT ADMINISTRATION R2 - RESIDENTIAL - DORMITORY	FACTOR: 0.2 INCHES PER OCCUPANT						
S-2 - STORAGE - APPARATUS BAY/ANCILLARY SPACES	NUMBER OF EXITS & ACCESS DOORWAYS - 1006						
EXISTING USE CLASSIFICATIONS TO REMAIN UNALTERED.	PER TABLE 1006.3.1 AN OCCUPANT LOAD OF 560 PER STORY REQUIRES A MINIMAL OF 3 EXITS FROM STORY.						
CONSTRUCTION TYPE - CH.6	EXIT SEPARATION DISTANCE - 1016.2						
IIB							
BUILDING HEIGHT & AREA - CH.5	MEANS OF EGRESS ARE NOT PROHIBITED THROUGH ADJOINING OR INTERVENING ROOMS OR SPACES THAT ARE						
EXISTING BUILDING HEIGHT WILL NOT BE INCREASED	OF A HIGHER HAZARD THAN THE ORIGINAL ROOM OF EGRESS.						
EXISTING STORY QUANTITY WILL NOT BE INCREASED	COMMON PATH OF EGRESS - TABLE 1006.2.1						
BUILDING AREA SHALL BE INCREASED VIA <b>194 GSF</b> PROPOSED ADDITION	ALLOWABLE 75 FEET ACTUAL 31 FEET						
FIRE DEC. DEO. C. FOR DI D.C. FI FMENTS. TADI F. CO.4	TRAVEL DISTANCE - TABLE 1017.2						
FIRE-RES. REQ.S FOR BLDG ELEMENTS - TABLE 601	ALLOWABLE 200 FEET						
PER TABLE 602 NO FIRE RATING IS REQUIRED FOR ANY BUILDING ELEMENT UNLESS NOTED OTHER WISE.	ACTUAL 98 FEET						
	DEAD-END CORRIDORS - 1020.4						
	ALLOWABLE 20 FEET ACTUAL 15 FEET						

SUBDIVISION: FULLERTON


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		MARYLAND. LICENSE NO. 15505 EXPIRATION D.	ATE: 08-18-2026					-	-	-	PROFILE SCALE:	-	DATE:	10/03/2024
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BALTIMORE COUNTY OFFICE OF BUDGET AND FINANCE, PROPERTY MANAGEMENT

FULLERTON FIRE STATION #8 - RENOVATION & ADDITION


CODE ANALYSIS

4401 FITCH AVENUE, NOTTINGHAM, MARYLAND, 21236

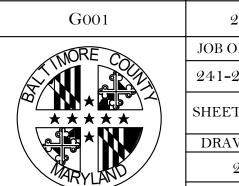



ELECTION DIST. NO.: 14C5

SHEET DESIGNATION | CONTRACT NUMBER 22221 PFO JOB ORDER NUMBER 241-220-0054-0012 SHEET 2 of 58 DRAWING NUMBER 2022-2321 FILE NO.: 8

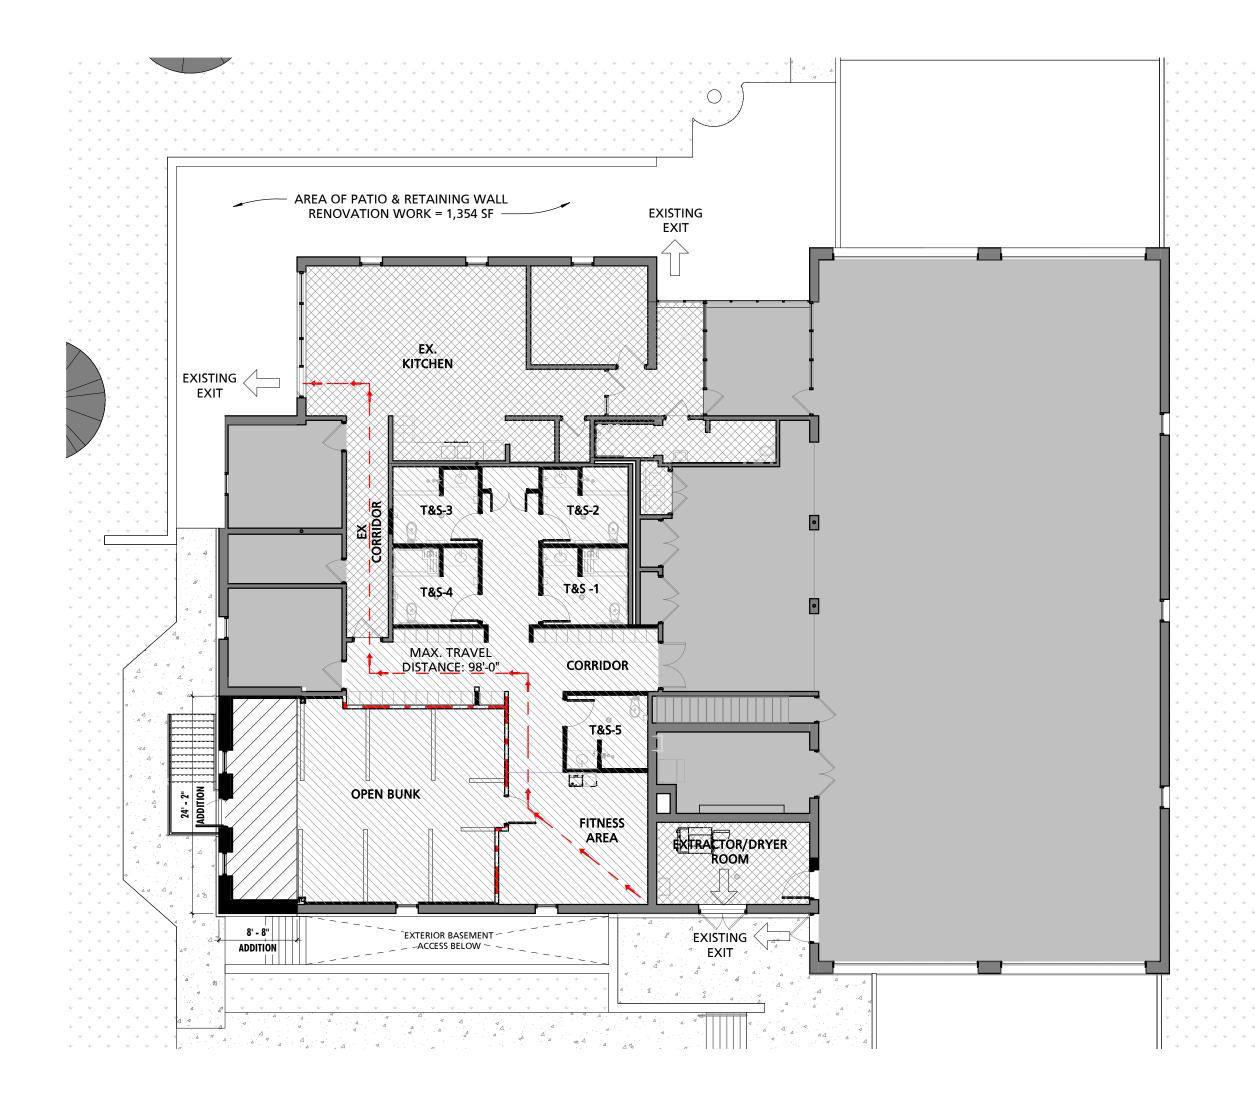




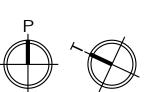

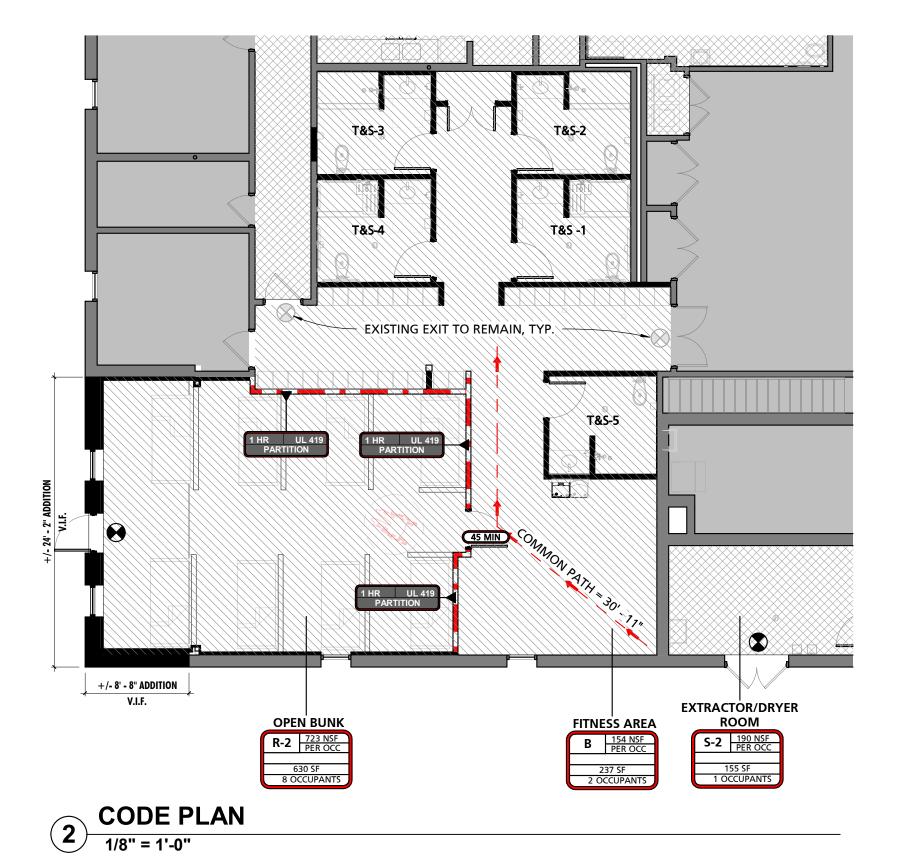

SUBDIVISION: FULLERTON

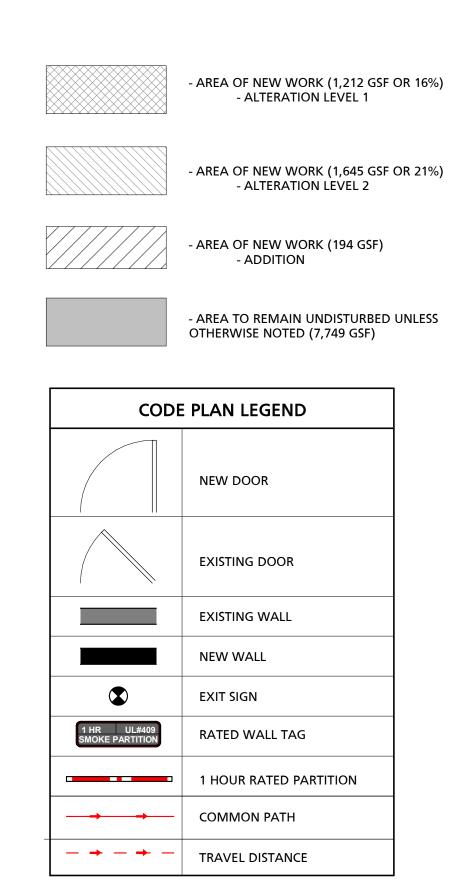

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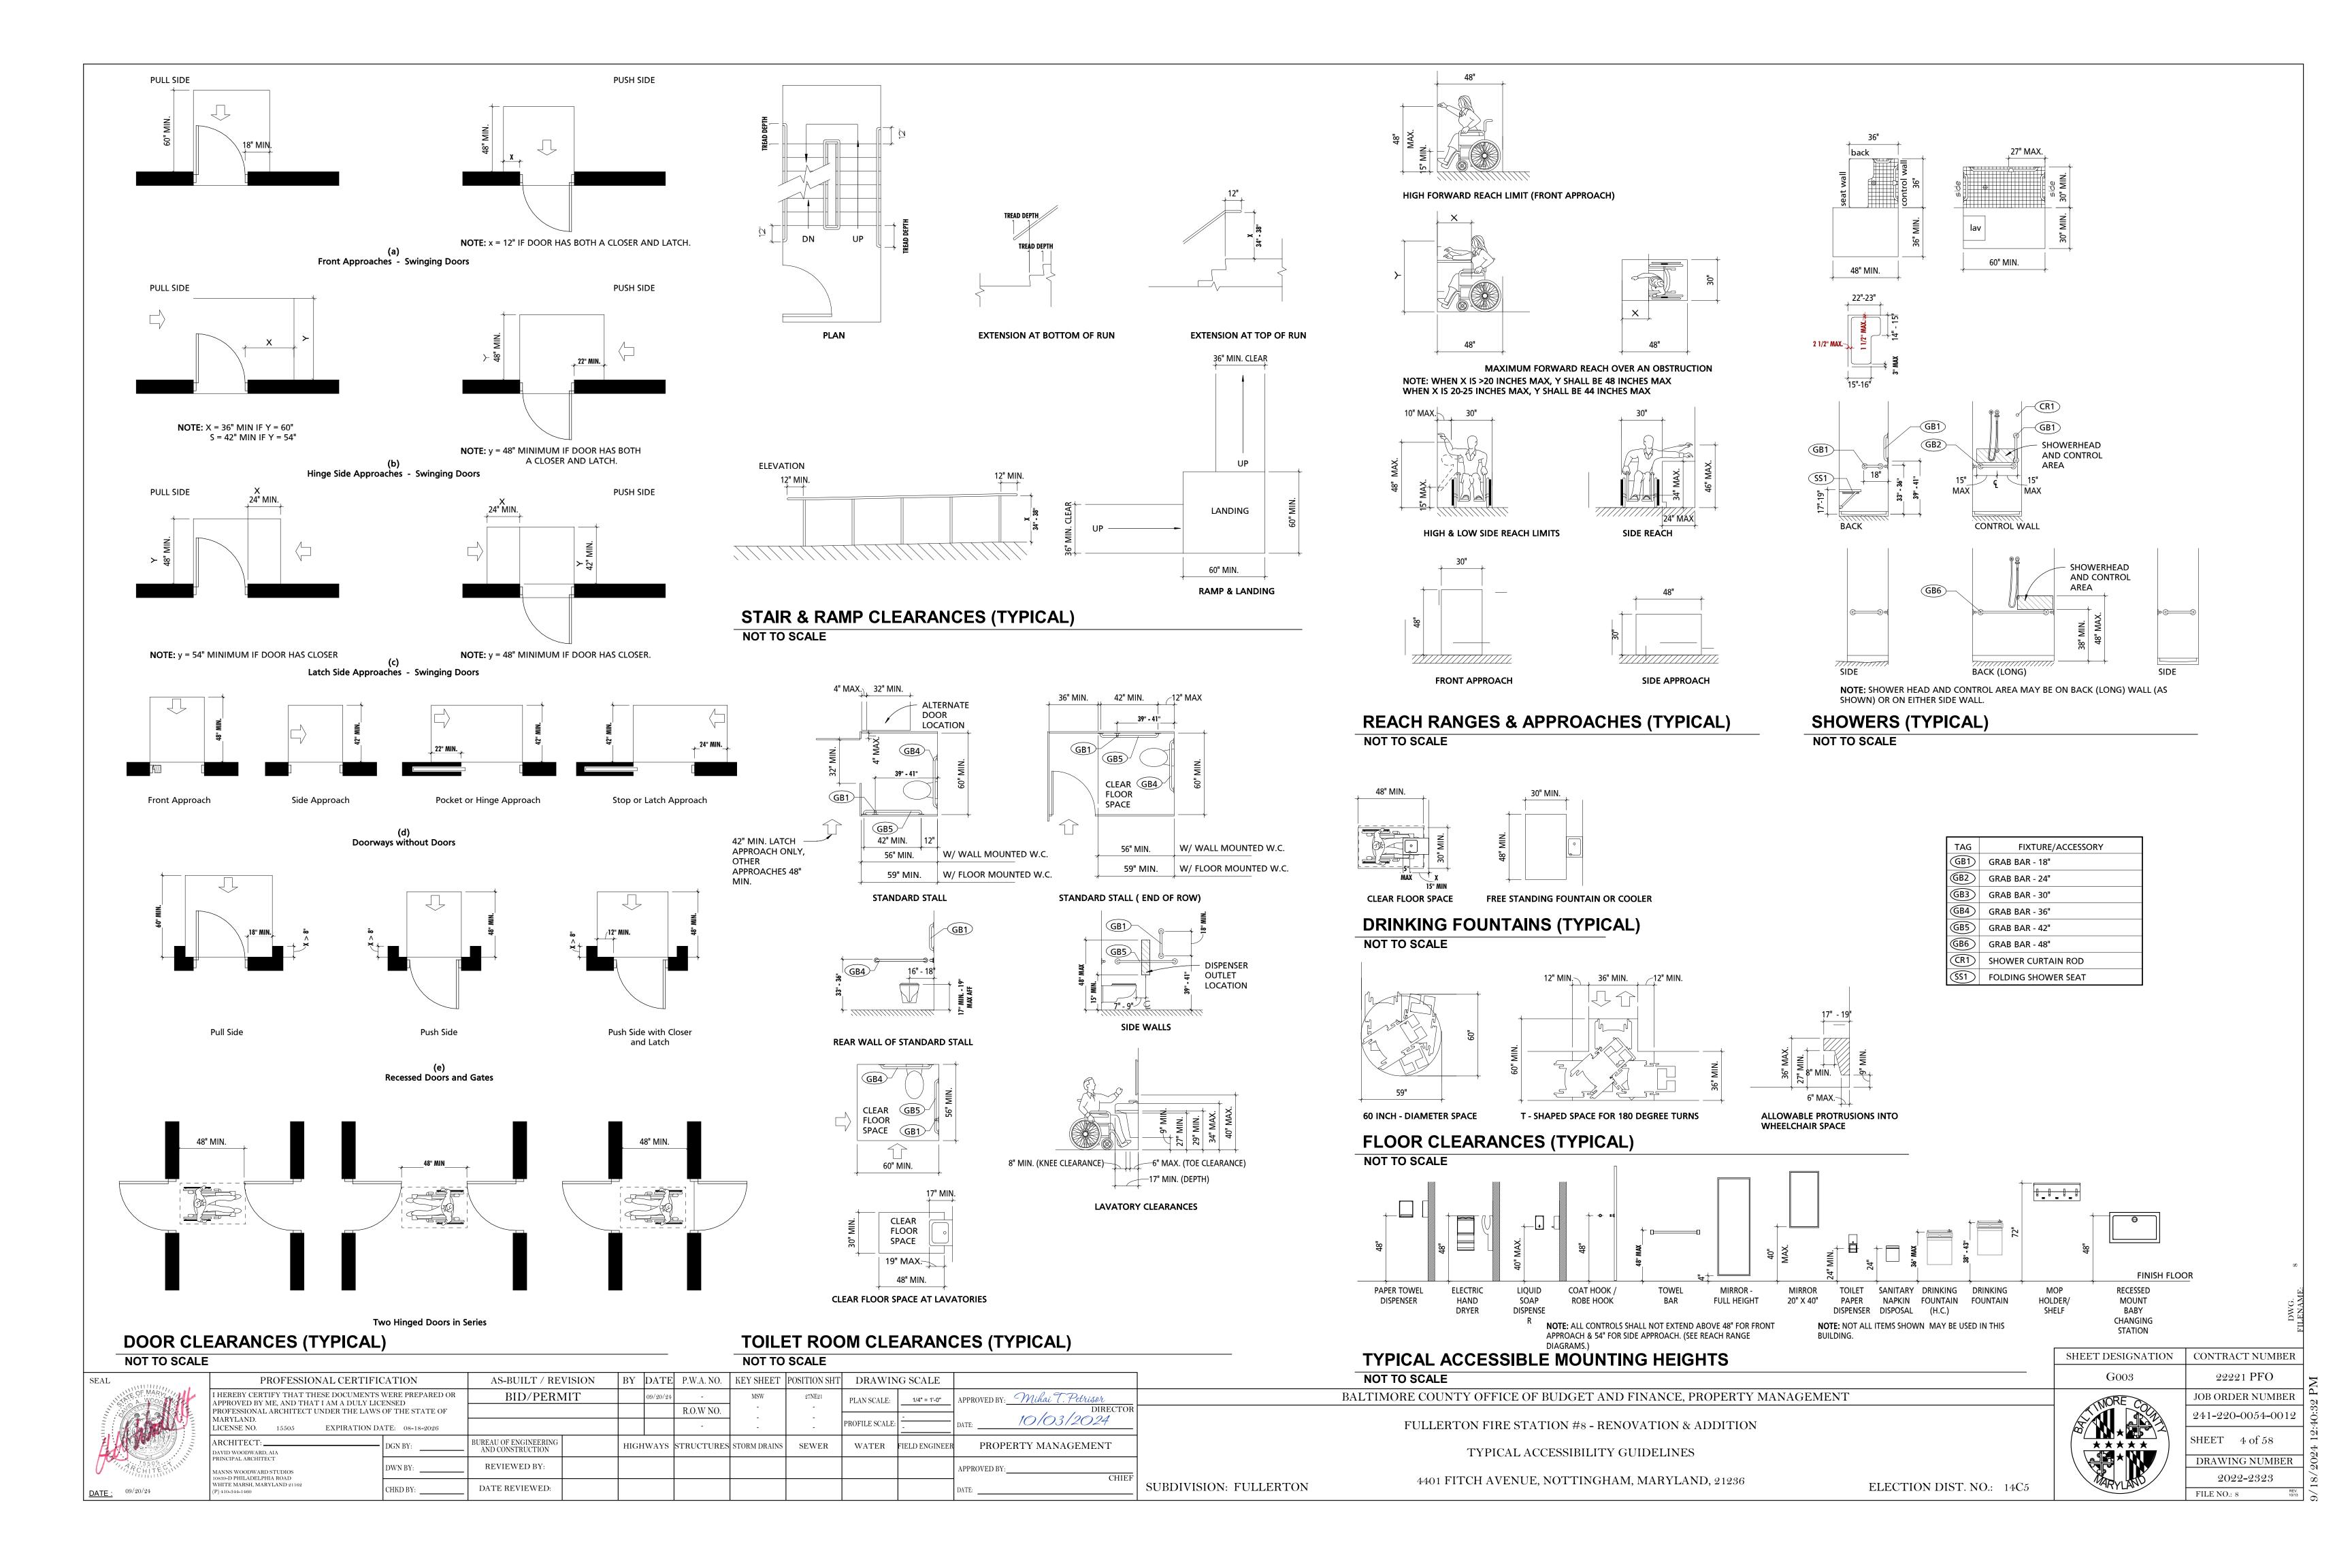
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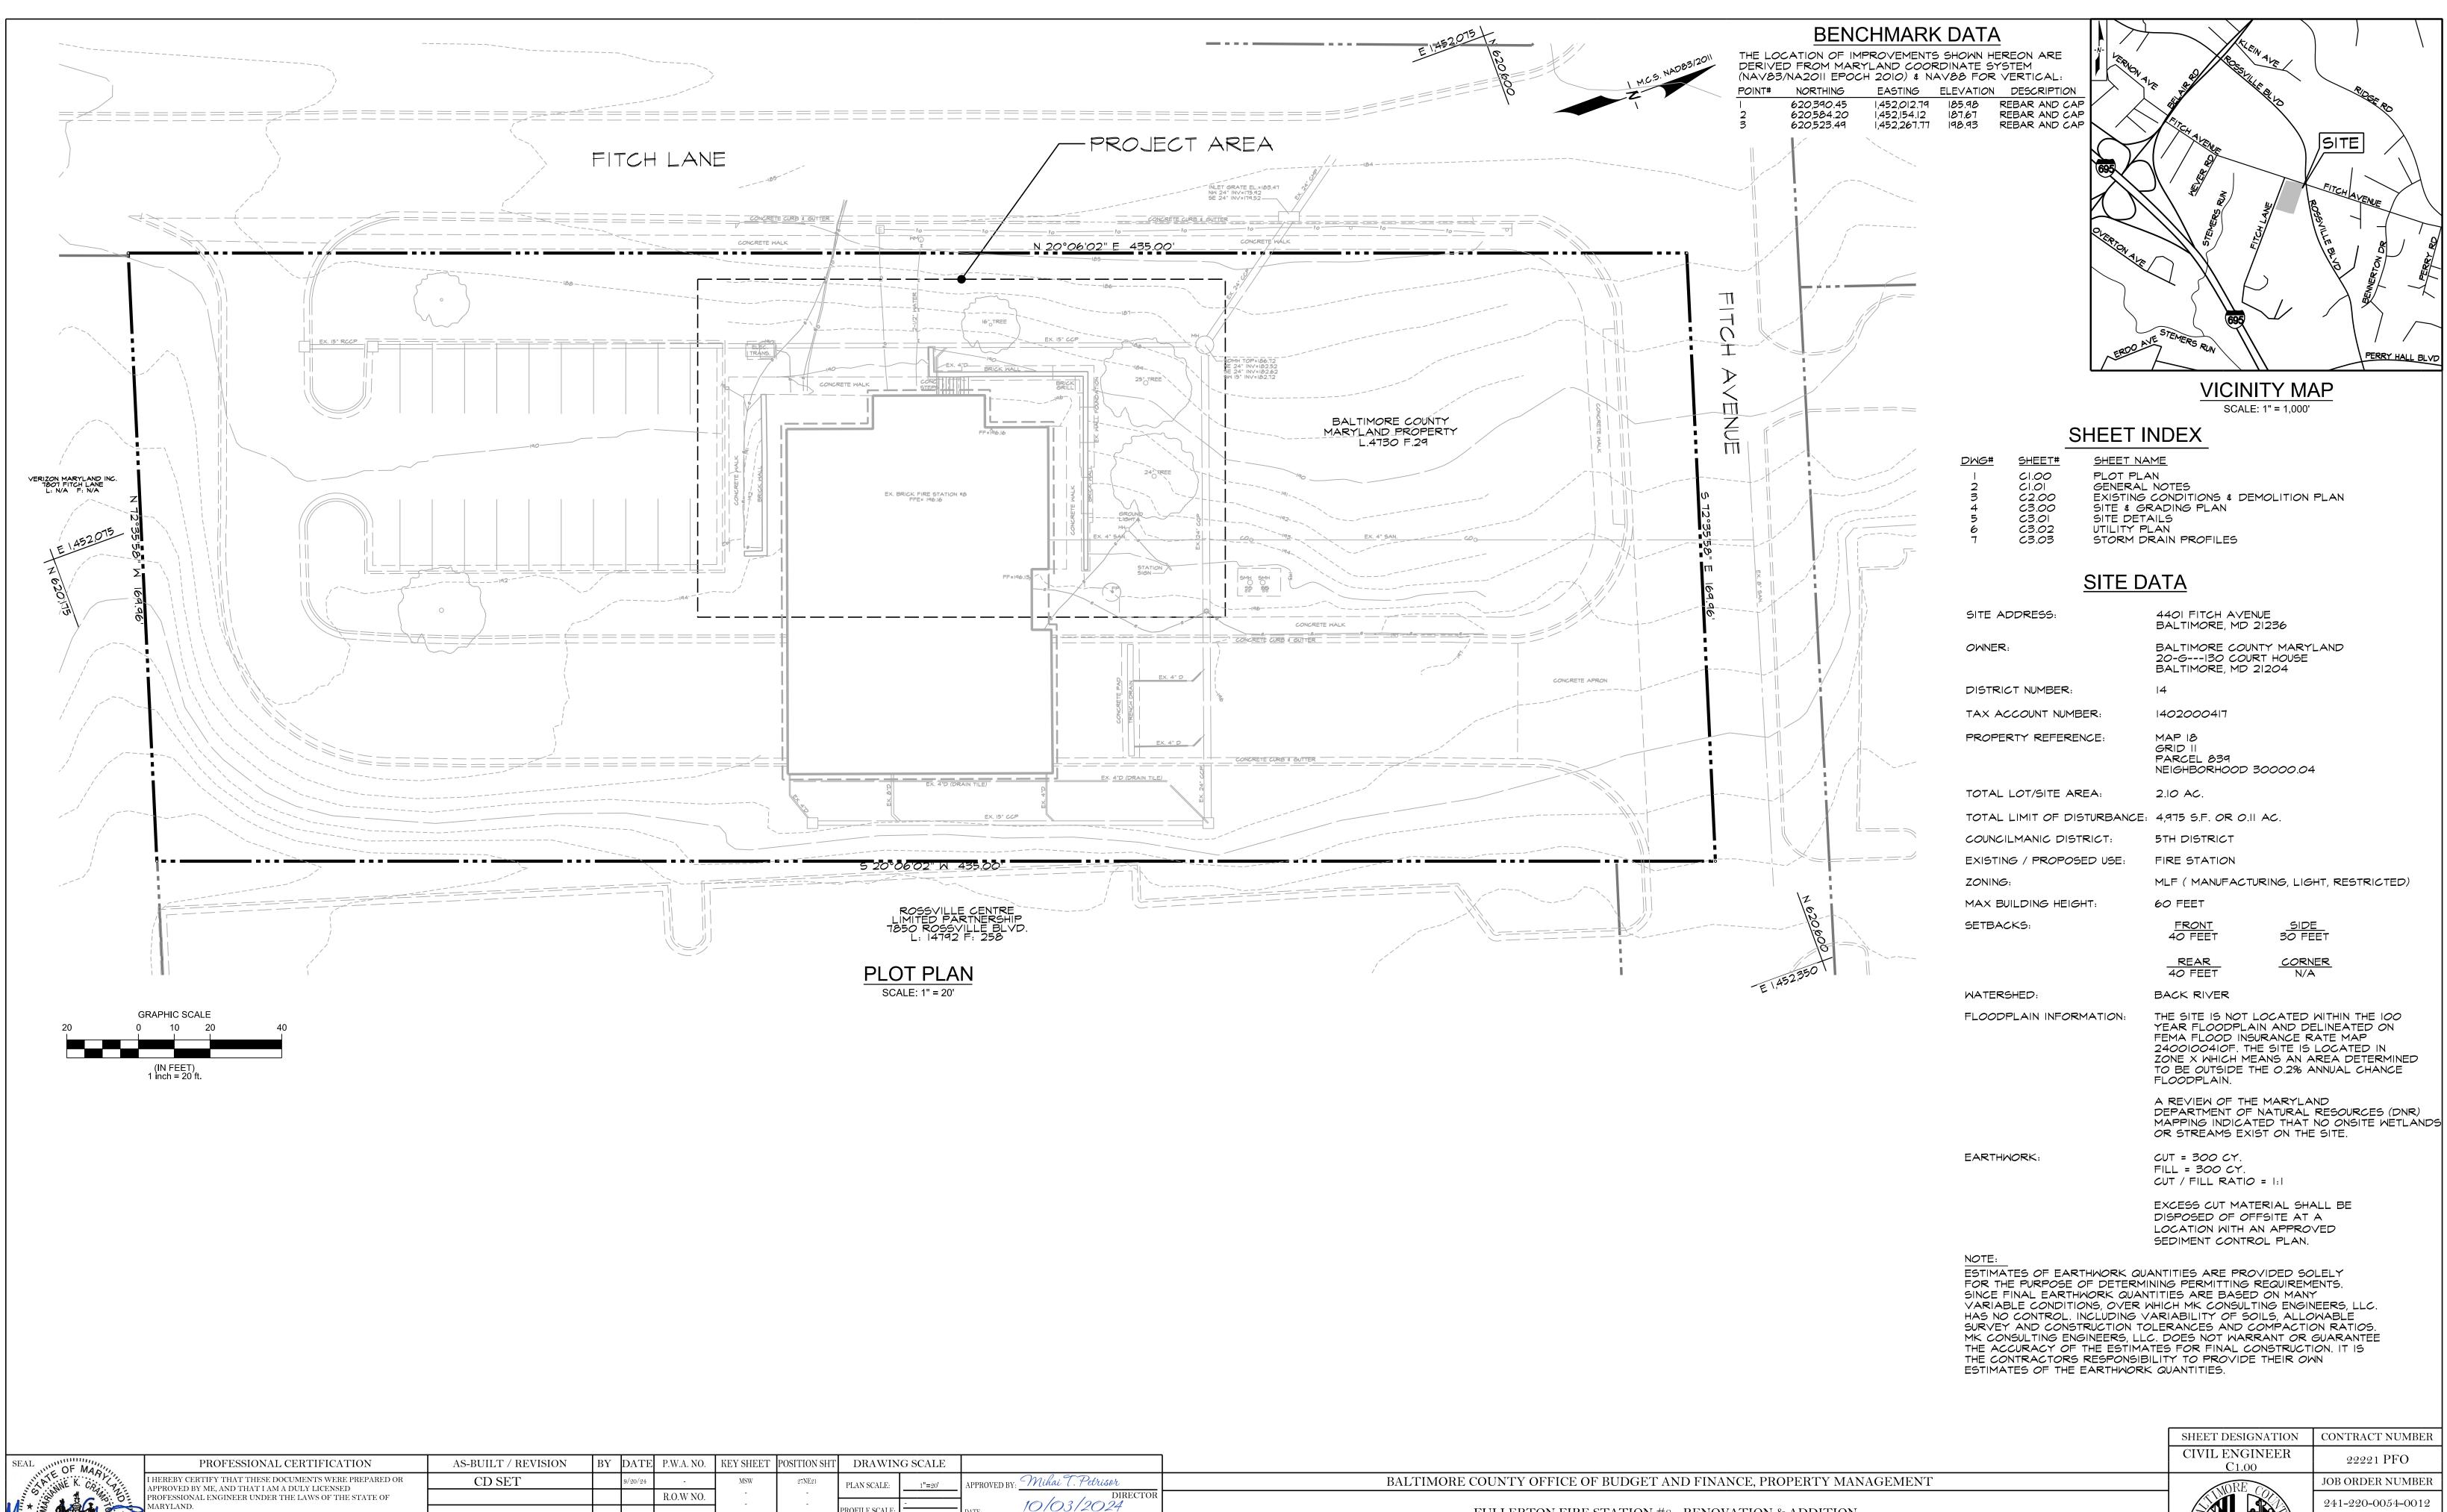
BALTIMORE COUNTY OFFICE OF BUDGET AND FINANCE, PROPERTY MANAGEMENT

FULLERTON FIRE STATION #8 - RENOVATION & ADDITION

CODE PLANS

4401 FITCH AVENUE, NOTTINGHAM, MARYLAND, 21236





LICENSE NO. 25058

ARIANNE CRAMPTON, PE

OO CLIPPER MILL ROAD, SUITE 201

CIVIL ENGINEER \_

LTIMORE, MD 21211

ONALEN

EXPIRATION DATE: 11-17-24

DWN BY: SG

CHKD BY: MC

BUREAU OF ENGINEERING

AND CONSTRUCTION

REVIEWED BY:

DATE REVIEWED:

HIGHWAYS STRUCTURES STORM DRAINS

SEWER

WATER

PROPERTY MANAGEMENT

SUBDIVISION: FULLERTON

PPROVED BY:

COUNTY OFFICE OF BUDGET AND FINANCE, PROPERTY MANAGEMENT

FULLERTON FIRE STATION #8 - RENOVATION & ADDITION

PLOT PLAN

4401 FITCH AVENUE, NOTTINGHAM, MARYLAND, 21236

ELECTION DIST. NO.: 14C5

C1.00

JOB ORDER NUMBER

241-220-0054-0012

SHEET 5 of 58

DRAWING NUMBER

2022-2324

FILE NO.: 8

### **GENERAL NOTES**

- I. THE CONTRACTOR SHALL NOTIFY "MISS UTILITY" (I-800-257-7777) AT LEAST FIVE (5) WORKING DAYS PRIOR TO STARTING ANY WORK.
- 2. EXISTING UTILITY INFORMATION SHOWN HEREON IS BASED ON THE BEST AVAILABLE INFORMATION, WHICH INCLUDES A FIELD SURVEY CONDUCTED BY PRECISION MAPPING AND SURVEYING, DURING APRIL, 2022. AS-BUILT WATER, WASTEWATER AND STORM DRAIN PLANS FROM BALTIMORE COUNTY DEPARTMENT OF PUBLIC WORKS AND BALTIMORE GAS AND ELECTRIC COMPANY PLANS.
- 3. OBSTRUCTIONS SHOWN ON THIS DRAWING ARE FOR THE CONVENIENCE OF THE CONTRACTOR ONLY. MK CONSULTING ENGINEERS, LLC. DOES NOT WARRANT OR GUARANTEE THE CORRECTNESS OR THE COMPLETENESS OF THE INFORMATION GIVEN. THE CONTRACTOR MUST VERIFY ALL SUCH INFORMATION TO HIS OWN SATISFACTION. IN THE EVENT THAT INFORMATION IS IN CONFLICT WITH INFORMATION OUTLINED, THE CONTRACTOR SHALL IMMEDIATELY NOTIFY THE ARCHITECT PRIOR TO STARTING ANY WORK.
- 4. TOPOGRAPHIC INFORMATION SHOWN HEREON IS BASED ON AVAILABLE AS-BUILT PLANS PROVIDED BY BALTIMORE COUNTY DEPARTMENT OF PUBLIC WORKS AND BALTIMORE COUNTY DPW, A SUPPLEMENTAL SURVEY CONDUCTED BY PRECISION MAPPING AND SURVEYING DURING APRIL, 2022.
- 5. REMOVAL OF ANY SIDEWALK AND/OR CURB AND GUTTER SHALL BE TO THE NEAREST JOINT. NO PATCHING SHALL BE PERMITTED.
- 6. ADJUST TOP OF CURB GRADES TO PROVIDE SMOOTH TRANSITION.
- 7. SAWCUT EXISTING PAVING AS NEEDED TO INSTALL NEW CONSTRUCTION.
- 8. STRIP & RESURFACE EXISTING PAVING AS NEEDED TO PROVIDE SMOOTH TRANSITION TO EX. SURFACE
- 9. IT SHALL BE DISTINCTLY UNDERSTOOD THAT FAILURE TO MENTION SPECIFICALLY ANY WORK WHICH WOULD NORMALLY BE REQUIRED TO COMPLETE THIS PROJECT SHALL NOT RELIEVE THE CONTRACTOR OF HIS RESPONSIBILITY TO COMPLETE SUCH WORK.
- 10. IT SHALL BE THE RESPONSIBILITY OF THE CONTRACTOR TO NOTIFY THE ENGINEER OF ANY DEVIATION FROM THIS PLAN PRIOR TO ANY CHANGE BEING MADE. ANY DEVIATION FROM THIS PLAN WITHOUT WRITTEN AUTHORIZATION FROM THE ENGINEER WILL BE THE RESPONSIBILITY OF THE CONTRACTOR.
- II. SHOULD THE CONTRACTOR DISCOVER DISCREPENCIES BETWEEN THE PLANS AND FIELD CONDITIONS, THE ENGINEER IS TO BE NOTIFIED IMMEDIATELY TO RESOLVE THE SITUATION. SHOULD THE CONTRACTOR MAKE FIELD CORRECTIONS OR ADJUSTMENTS WITHOUT NOTIFYING THE ENGINEER, THEN THE CONTRACTOR ASSUMES ALL RESPONSIBILITY FOR THOSE CHANGES.
- 12. THE CONTRACTOR SHALL NOTE THAT IN CASE OF ANY DISCREPANCY BETWEEN THE SCALED AND FIGURED DIMENSIONS SHOWN ON THESE PLANS, THE FIGURED DIMENSIONS SHALL GOVERN.
- 13. PRIOR TO BEGINNING CONSTRUCTION, THE CONTRACTOR SHALL VERIFY ALL TIE-IN ELEVATIONS.
- 14. ALL EXCAVATION SHALL BE BACKFILLED IN ACCORDANCE WITH THE PROJECT SPECIFICATIONS. IN THE EVENT THAT A PORTION OF A UTILITY IS TO BE REMOVED THE CONTRACTOR SHALL TERMINATE AND CAP TO THE LIMITS INDICATED IN ACCORDANCE WITH ALL STATE AND LOCAL REQUIREMENTS.
- 15. THE CONTRACTOR IS SOLELY RESPONSIBLE FOR THE PROTECTION OF THE SUB-GRADE UNTIL IT RECEIVES FINAL SURFACE TREATMENT AND SHALL MAINTAIN THE SUB-GRADE AS SUITABLE AND ACCEPTABLE TO THE OWNER OR OWNER'S REPRESENTATIVE AT ALL TIMES. HE SHALL BE COMPLETELY RESPONSIBLE FOR THE RESTORATION OR REPLACEMENT OF THE SUB-GRADE DUE TO MOISTURE DAMAGE, CONSTRUCTION TRAFFIC, OR ANY OTHER CAUSE. REPAIR OR REPLACEMENT OF THE SUB-GRADE SHALL BE PERFORMED AT NO ADDITIONAL COST TO THE OWNER.
- 16. UNLESS OTHERWISE NOTED, ALL CONSTRUCTION AND WORKMANSHIP SHALL BE IN ACCORDANCE WITH:

  A. BALTIMORE COUNTY DEPARTMENT OF PUBLIC WORKS STANDARD SPECIFICATIONS FOR
  - CONSTRUCTION MATERIALS, DECEMBER 2007, ERRATA & ADDENDA.

    B. NATURAL RESOURCES CONSERVATION SERVICE OF MARYLAND STANDARDS AND
  - SPECIFICATIONS, POND, CODE 378, JANUARY 2000.

    C. MARYLAND DEPARTMENT OF TRANSPORTATION STATE HIGHWAY ADMNISTRATION, JULY, 2022, STANDARD SPECIFICATIONS FOR CONSTRUCTION AND MATERIALS.
- 17. CONTRACTOR SHALL ADJUST ALL FRAMES, GRATES AND COVERS OF ALL EXISTING
- UTILITIES WITHIN THE LIMITS OF THE CONTRACT TO THE PROPOSED GRADES, AS REQUIRED
- 18. THE CONTRACTOR SHALL MAINTAIN POSITIVE DRAINAGE TO SWALES AND/ OR STORM DRAIN SYSTEMS AT ALL TIMES.19. PAVING REPAIR SHALL BE IN ACCORDANCE WITH BALTIMORE COUNTY STANDARD DETAIL R-38.
- 20. ALL NEW CONCRETE SHALL BE SHA MIX NO. 3, 3,500 PSI (MIN.) AT 28 DAYS.

AT EXTERIOR DOORS.

CLIPPER MILL ROAD, SUITE 201

LTIMORE, MD 2121

7.18.24

CONTRACTOR.

- 20. ALL NEW CONCRETE SHALL BE SHA MIX NO. 5, 5,500 PSI (MIN.) AT 26 DATS.

  21. CONSTRUCTION OF THE PROPOSED ON-SITE UTILITIES WILL BE IN ACCORDANCE WITH THE BALTIMORE
- 22. CONTRACTOR SHALL COORDINATE THE LOCATION OF THE UNDERGROUND ELECTRIC SERVICE WITH THE BALTIMORE GAS & ELECTRIC COMPANY. SEE ELECTRICAL PLANS FOR DETAILS.

COUNTY PLUMBING CODE AND BY A CONTRACTOR PRE-QUALIFIED BY BALTIMORE COUNTY.

- 23. UNLESS OTHERWISE NOTED, ALL SEWER PIPE SHALL BE PVC SDR-26 CONFORMING TO THE REQUIREMENTS OF A.S.T.M. SPECIFICATION D-3034.
- 24. SEE STRUCTURAL AND ARCHITECTURAL PLANS FOR SIZE AND LOCATIONS OF TURNED DOWN SLABS
- 25. ALL WORK IDENTIFIED AS PUBLIC AND PRIVATE ON THESE PLANS SHALL BE COMPLETED BY THE
- 26. THE AREAS BETWEEN THE SIGHT LINE AND THE CURB LINE MUST BE CLEARED, GRADED AND KEPT FREE OF ANY OBSTRUCTIONS.
- 27. THE CONTRACTOR SHALL PROVIDE A PRIVATE UTILITY LOCATOR TO LOCATE ALL EXISTING UNDERGROUND UTILITIES PRIOR TO BEGINNING ANY CONSTRUCTION.
- 28. TRENCH CRADLE AND ENCASEMENT SHALL BE PER BALTIMORE COUNTY STD. DETAIL G-8.

### DEMOLITION NOTES

- THE CONTRACTOR SHALL NOTIFY "MISS UTILITY" 1-800-257-7777 AT LEAST FIVE (5) WORKING DAYS PRIOR TO STARTING ANY WORK.
- 2. TOPOGRAPHIC INFORMATION SHOWN HEREON IS BASED ON AVAILABLE AS-BUILT PLANS PROVIDED BY BALTIMORE COUNTY DEPARTMENT OF PUBLIC WORKS AND BALTIMORE COUNTY DPW, A SUPPLEMENTAL SURVEY CONDUCTED BY PRECISION MAPPING AND SURVEYING DURING APRIL 2022
- 3. EXISTING UTILITY INFORMATION SHOWN HEREON IS BASED ON THE BEST AVAILABLE INFORMATION, WHICH INCLUDES A FIELD SURVEY CONDUCTED BY PRECISION MAPPING AND SURVEYING, DURING APRIL, 2022. AS-BUILT WATER, WASTEWATER AND STORM DRAIN PLANS FROM BALTIMORE COUNTY DEPARTMENT OF PUBLIC WORKS AND BALTIMORE GAS AND ELECTRIC COMPANY PLANS.
- 4. OBSTRUCTIONS SHOWN ON THIS DRAWING ARE FOR THE CONVENIENCE OF THE CONTRACTOR ONLY. MK CONSULTING ENGINEERS, LLC. DOES NOT WARRANT OR GUARANTEE THE CORRECTNESS OR THE COMPLETENESS OF THE INFORMATION GIVEN. THE CONTRACTOR MUST VERIFY ALL SUCH INFORMATION TO HIS OWN SATISFACTION. IN THE EVENT THAT INFORMATION IS IN CONFLICT WITH INFORMATION OUTLINED, THE CONTRACTOR SHALL IMMEDIATELY BRING IT TO THE ATTENTION OF THE ARCHITECT PRIOR TO STARTING ANY WORK.
- 5. CONTRACTOR SHALL VERIFY LOCATION AND ELEVATION OF EXISTING UTILITIES SHOWN HEREON BEFORE STARTING ANY WORK ON THESE PLANS. CONTRACTOR AGREES TO BE FULLY RESPONSIBLE FOR THE COST OF ANY AND ALL DAMAGES WHICH OCCUR AS A RESULT OF A FAILURE TO EXACTLY LOCATE AND PRESERVE ANY AND ALL EXISTING UTILITIES INDICATED TO REMAIN.
- 6. ALL WORK SHALL BE ACCOMPLISHED IN ACCORDANCE WITH THE CONTRACT DOCUMENTS.
- CONTRACTOR SHALL ADJUST ALL FRAMES, GRATES AND COVERS OF ALL EXISTING UTILITIES WITHIN THE LIMITS OF THE CONTRACT TO THE PROPOSED GRADES AS REQUIRED.
- 8. THE CONTRACTOR SHALL MAINTAIN POSITIVE DRAINAGE AWAY FROM STRUCTURES
- 9. CONTRACTOR SHALL COORDINATE ALL DISCONNECTIONS AND REMOVAL OF EXISTING GAS, ELECTRIC AND TELEPHONE SERVICES AND EQUIPMENT WITH BALTIMORE GAS & ELECTRIC, VERIZON.

ACCORDANCE WITH ALL STATE AND LOCAL REQUIREMENTS.

- IO. CONTRACTOR SHALL REMOVE AND DISPOSE OF ALL EXISTING MECHANICAL AND ELECTRICAL EQUIPMENT AND ACCESSORIES NOT REMOVED BY LOCAL UTILITY COMPANIES, OR SPECIFIED TO BE REMOVED BY OWNER.
- II. ALL EXCAVATION SHALL BE BACKFILLED IN ACCORDANCE WITH THE PROJECT SPECIFICATIONS. IN THE EVENT THAT A PORTION OF A UTILITY IS TO BE REMOVED THE CONTRACTOR SHALL TERMINATE AND CAP TO THE LIMITS INDICATED IN
- 12. IT SHALL BE DISTINCTLY UNDERSTOOD THAT FAILURE TO MENTION SPECIFICALLY ANY WORK WHICH WOULD NORMALLY BE REQUIRED TO COMPLETE THIS PROJECT SHALL NOT RELIEVE THE CONTRACTOR OF HIS RESPONSIBILITY TO COMPLETE
- 13. IT SHALL BE THE RESPONSIBILITY OF THE CONTRACTOR TO NOTIFY THE ENGINEER OF ANY DEVIATION FROM THIS PLAN PRIOR TO ANY CHANGE BEING MADE. ANY DEVIATION FROM THIS PLAN WITHOUT WRITTEN AUTHORIZATION FROM THE ENGINEER WILL BE THE RESPONSIBILITY OF THE CONTRACTOR.
- 14. SHOULD THE CONTRACTOR DISCOVER DISCREPANCIES BETWEEN THE PLANS AND FIELD CONDITIONS, THE ENGINEER IS TO BE NOTIFIED IMMEDIATELY TO RESOLVE THE SITUATION. SHOULD THE CONTRACTOR MAKE FIELD CORRECTIONS OR ADJUSTMENTS WITHOUT NOTIFYING THE ENGINEER, THEN THE CONTRACTOR ASSUMES ALL RESPONSIBILITY FOR THOSE CHANGES.
- 15. CONTRACTOR SHALL SECURE THE CONSTRUCTION AREA AT THE END OF EACH WORKING DAY AND WILL INSPECT THE SECURITY FENCING TO INSURE ITS INTEGRITY.
- 16. ALL CONSTRUCTION DEBRIS WILL BE REMOVED FROM THE SITE AND TAKEN TO AN APPROVED, PERMITTED DISPOSAL FACILITY. NO RUBBLE IS TO BE LEFT ON SITE.
- 17. CONTRACTOR SHALL INSPECT AND TAKE PICTURES OF ADJACENT BUILDING WALLS PRIOR TO THE COMMENCEMENT OF ANY DEMOLITION ON THE SITE. EXISTING WALL CRACKS (IF ANY) WILL BE NOTED.
- 18. CONTRACTOR SHALL CONTINUALLY MONITOR THE WALLS OF THE ADJACENT BUILDINGS FOR ANY SIGNS OF STRUCTURAL DISTRESS. IF ANY DISTRESS IS NOTED, CONTRACTOR SHALL STOP WORK IMMEDIATELY AND NOTIFY OWNER.
- 9. CONTRACTOR SHALL NOT EXPOSE, UNDERMINE, OR IMPACT THE ZONE OF INFLUENCE FOR FOOTINGS AND FOUNDATIONS OF ADJACENT BUILDINGS. CONTRACTOR WILL BE RESPONSIBLE FOR THE COST TO REPAIR ADJACENT BUILDINGS THAT ARE DAMAGED DUE TO HIS OPERATION.
- 20. CONTRACTOR SHALL PROVIDE THE NECESSARY MEANS TO CONTROL DUST AND MAINTAIN BALTIMORE COUNTY AIR QUALITY STANDARDS DURING THE DEMOLITION
- AND REMOVAL OF SITE DEBRIS AND THE NEW CONSTRUCTION.

  21. CONTRACTOR SHALL SAWCUT EXISTING PAVING TO MINIMIZE DAMAGE TO EXISTING
- 22. CONTRACTOR SHALL REMOVE EXISTING CURBS & CONCRETE WALKS TO THE

PAVING REMAINING.

- NEAREST JOINT. NO PATCHING WILL BE PERMITTED.

  23. THE DEMOLITION INFORMATION SHOWN ON THIS DRAWINGS IS FOR THE CONVENIENCE OF THE CONTRACTOR ONLY. IT IS THE CONTRACTORS RESPONSIBILITY TO DETERMINE THE EXACT LIMITS OF DEMOLITION AND REMOVAL OF AFFECTED SITE ITEMS.
- 24. CONTRACTOR SHALL PROVIDE 8' HIGH TEMPORARY CONSTRUCTION FENCE AROUND THE LIMITS OF DISTURBANCE AS REQUIRED. REFER TO THE EROSION AND SEDIMENT CONTROL PLANS FOR LOCATIONS OF LOD DURING PHASES.
- 25. THE CONTRACTOR SHALL PROVIDE A PRIVATE UTILITY LOCATOR TO LOCATE ALL EXISTING UNDERGROUND UTILITIES PRIOR TO BEGINNING ANY CONSTRUCTION.

### SPECIAL DEMOLITION AND CONSTRUCTION NOTES

- ALL EXISTING WALL, FOOTING, AND BUILDING INFORMATION IS TAKEN FROM RECORD DRAWINGS LABELED "FULLERTON FIRE STATION FOR BALTIMORE COUNTY" DATED 10/21/1971.
- CONTRACTOR SHALL TAKE MEASURE TO PROTECT EXISTING BUILDING, INCLUDING BUT NOT LIMITED TO WALLS, WINDOWS, DOORS, AND BUILDING FOUNDATIONS. CONTRACTOR TO TAKE CARE AND USE MEASURES TO MINIMIZE VIBRATIONS TO NOT DAMAGE EXISTING BUILDING DURING DEMOLITION AND CONSTRUCTION.

SUBDIVISION: FULLERTON

### **UTILITY NOTES**

- I. CONTRACTOR SHOULD OPEN ONLY THAT SECTION OF TRENCH THAT CAN BE BACKFILLED AND STABILIZED EACH DAY. IF TRENCH MUST REMAIN OPEN LONGER THAN ONE DAY, SILT FENCE MUST BE PLACED BELOW (DOWN SLOPE) THE TRENCH.
- 2. PLACE ALL EXCAVATED MATERIAL ON UPHILL SIDE OF THE TRENCH.
- 3. ANY SEDIMENT CONTROLS DISTURBED BY UTILITY CONSTRUCTION ARE TO BE REPAIRED IMMEDIATELY.
- 4. FIRE LINE CONSTRUCTION SHALL BE ACCOMPLISHED IN ACCORDANCE WITH N.F.P.A. 24.
- 5. UNLESS OTHERWISE NOTED, PIPE ELEVATIONS FOR WATER MAINS REFER TO TOP OF PIPE AND SANITARY SEWER ELEVATIONS REFER TO THE INVERT.
- 6. ALL WATER PIPING, TUBING, FITTINGS AND JOINING METHODS SHALL BE ACCORDING TO THE FOLLOWING APPLICATIONS:
- 4 INCHES (DN 100) TO 8 INCHES (DN 200): CLASS 250, DUCTILE IRON PIPE, DUCTILE IRON COMPACT FITTINGS AND MECHANICAL JOINTS WITH RETAINER GLANDS.
- 7. UNLESS OTHERWISE NOTED, ALL SEWER PIPE SHALL BE PVC SDR-26 CONFORMING TO THE REQUIREMENTS OF A.S.T.M. SPECIFICATION D-3034.
- 8. ALL UTILITY STRUCTURE DIMENSIONS SHALL REFER TO THE CENTERLINE OF THE "STRUCTURES"
- 9. ALL CLEANOUTS LOCATED IN PAVED AREAS SHALL HAVE COUNTERSUNK LIDS.
- IO. SEE MECHANICAL, ELECTRICAL AND PLUMBING PLANS FOR CONTINUATION OF UTILITY CONNECTIONS TO BUILDING AND SITE LIGHTING INFORMATION.
- II. CONTRACTOR SHALL CONNECT ALL ON-SITE UTILITIES TO THE PROPOSED BUILDING CONNECTIONS AS
- 12. SEE MECHANICAL, ELECTRICAL, PLUMBING PLANS FOR GAS, ELECTRIC AND UTILITIES LOCATED WITHIN 5' OF THE BUILDING FOOTPRINT.
- 13. OBSTRUCTIONS SHOWN ON THIS DRAWING ARE FOR THE CONVENIENCE OF THE CONTRACTOR ONLY. MK CONSULTING ENGINEERS, LLC. DOES NOT WARRANT OR GUARANTEE THE CORRECTNESS OR THE COMPLETENESS OF THE INFORMATION GIVEN.
- 14. THE CONTRACTOR MUST VERIFY ALL SUCH INFORMATION TO HIS OWN SATISFACTION.
- 15. CONTRACTOR SHALL CALL "MISS UTILITY" (800-257-7777) AT LEAST FIVE (5) WORKING DAYS PRIOR TO STARTING WORK.
- 16. CONSTRUCTION OF THE PROPOSED UTILITIES WILL BE IN ACCORDANCE WITH THE BALTIMORE COUNTY PLUMBING CODE AND BY A QUALIFIED CONTRACTOR.
- 17. NO WORK IS TO COMMENCE UNTIL ALL PERMITS HAVE BEEN OBTAINED.
- 18. CONTRACTOR SHALL TEST PIT FOR LOCATION OF EXISTING UTILITIES PRIOR TO STARTING CONSTRUCTION.
- 19. EXISTING CURB AND GUTTER & CONCRETE SIDEWALK SHALL BE REMOVED TO THE NEAREST JOINT. NO PATCHING SHALL BE PERMITTED.
- 20. SHOULD THE CONTRACTOR DISCOVER DISCREPANCIES BETWEEN THE PLANS AND FIELD CONDITIONS THE ENGINEER IS TO BE NOTIFIED IMMEDIATELY TO RESOLVE THE SITUATION.
- 21. CONTRACTOR SHALL COORDINATE THE LOCATION OF THE UNDERGROUND ELECTRIC SERVICE AND THE UNDERGROUND GAS SERVICE WITH THE BALTIMORE GAS, ELECTRIC COMPANY. SEE ELECTRICAL PLANS
- 22. CONTRACTOR SHALL ADJUST TOP OF EXISTING UTILITIES, I.E. MANHOLE FRAME AND COVER, INLET GRATES, ETC. TO FINISHED GRADE.
- 23. ON SITE FIRE HYDRANTS ARE TO BE PAINTED RED AND FIRE HYDRANTS STEAMER NOZZLE TO FACE DRIVE AISLES.
- 24. ALL EXCAVATION SHALL BE BACKFILLED IN ACCORDANCE WITH THE PROJECT SPECIFICATIONS. IN THE EVENT THAT A PORTION OF A UTILITY IS TO BE REMOVED, THE CONTRACTOR SHALL TERMINATE AND CAP TO THE LIMITS INDICATED IN ACCORDANCE WITH ALL STATE AND LOCAL REQUIREMENTS.
- 25. THE CONTRACTOR IS RESPONSIBLE FOR PERFORMING ALL WORK SHOWN ON THESE DRAWINGS UNLESS OTHERWISE NOTED.
- 26. IT SHALL BE THE RESPONSIBILITY OF THE CONTRACTOR TO NOTIFY THE ENGINEER OF ANY DEVIATION FROM THE PLANS PRIOR TO ANY CHANGE BEING MADE. ANY DEVIATION FROM THIS PLAN WITHOUT WRITTEN AUTHORIZATION FROM THE ENGINEER WILL BE THE RESPONSIBILITY OF THE CONTRACTOR.
- 27. PRIOR TO BEGINNING ANY UTILITY CONSTRUCTION THE CONTRACTOR SHALL VERIFY THAT ALL EXISTING UTILITIES WILL TIE IN WITH PROPOSED UTILITIES AS SHOWN.
- 28. ALL VALVES SHALL BE IN STANDARD CONCRETE VAULTS IN ACCORDANCE WITH BALTIMORE COUNTY STANDARD DETAILS.
- 29. ALL PUBLIC WORK IDENTIFIED ON THESE PLANS IS SUBJECT TO A BALTIMORE COUNTY UTILITY AGREEMENT AND SHALL BE PERFORMED BY A BALTIMORE COUNTY PREQUALIFIED CONTRACTOR HAVING PREQUALIFICATIONS AI, A2, B, FI, F2, F3 AND E.
- 30. THE CONTRACTOR SHALL PROVIDE A PRIVATE UTILITY LOCATOR TO LOCATE ALL EXISTING UNDERGROUND UTILITIES PRIOR TO BEGINNING ANY CONSTRUCTION.
- 31. TRENCH CRADLE AND ENCASEMENT SHALL BE PER BALTIMORE COUNTY STD. DETAIL G-8.

### CONCRETE RETAINING WALL NOTES

- SPECIFICATIONS TO BE PER MDOT SHA STANDARD SPECIFICATIONS FOR CONSTRUCTION AND MATERIALS.
- 2. CONCRETE SHALL BE SHA MIX NO. 3 (3500 PSI) EXCEPT AS NOTED.
- 3. REINFORCING STEEL SHALL CONFORM TO A 615, GRADE 60. ALL SPLICES, NOT SHOWN, SHALL BE LAPPED AS PER BAR LAP CHARTS. MINIMUM COVER FOR ANY BAR SHALL BE 2" UNLESS OTHERWISE NOTED, WITH THE EXCEPTION OF BARS AT THE BOTTOM AND SIDES OF ALL FOOTINGS WHICH SHALL HAVE 3" MINIMUM COVER.
- 4. ALL DIMENSIONS AFFECTED BY THE GEOMETRY AND/OR LOCATION OF THE EXISTING STRUCTURES: EXISTING STRUCTURES SHALL BE CHECKED IN THE FIELD BY THE CONTRACTOR BEFORE ANY MATERIAL IS ORDERED OR FABRICATED OR CONSTRUCTION BEGINS.
- 5. CONCRETE FORMLINER TO BE UTILIZED WHEN POURING RETAINING WALL. MODEL #1206 ROYALITE STONE, HIGH STRENGTH URETHANE ELASTOMERIC REUSABLE FORMS, AS MANUFACTURED BY CUSTOM ROCK, ST. PAUL, MN 1-800-637-2447. PATTERN SHALL CONTINUOUSLY WRAP AROUND OUTSIDE AND INSIDE CORNERS, AND BE EXPOSED ON INTERIOR AND EXTERIOR FACE OF WALL ABOVE FINISHED GRADE. FINISHED STONE PATTERN SHALL BE STAINED FOR COLORIZATION ACCORDING TO THE SPECIFICATIONS.

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	SEAL OF MARIN	PROFESSIONAL CERTIFICATION		AS-BUILT / REV	VISION	BY	DATE	P.W.A. NO.	KEY SHEET	POSITION SHT	DRAWIN	G SCALE		
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	PROFESSIONAL ENGINEER UNDER THE LAWS OF THE STATE OF						R.O.W NO.	-	-			DIR	RECTO	
	Van Market	MARYLAND. LICENSE NO. 25058 EXPIRATION DATE: 11-17-24							-	-	PROFILE SCALE:	-	DATE:	
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DATE REVIEWED:

BALTIMORE COUNTY OFFICE OF BUDGET AND FINANCE, PROPERTY MANAGEMENT

FULLERTON FIRE STATION #8 - RENOVATION & ADDITION

GENERAL NOTES

4401 FITCH AVENUE, NOTTINGHAM, MARYLAND, 21236

C1.01

SHEET DESIGNATION

CIVIL ENGINEER

22221 PFO

JOB ORDER NUMBER

241-220-0054-0012


SHEET 6 of 58


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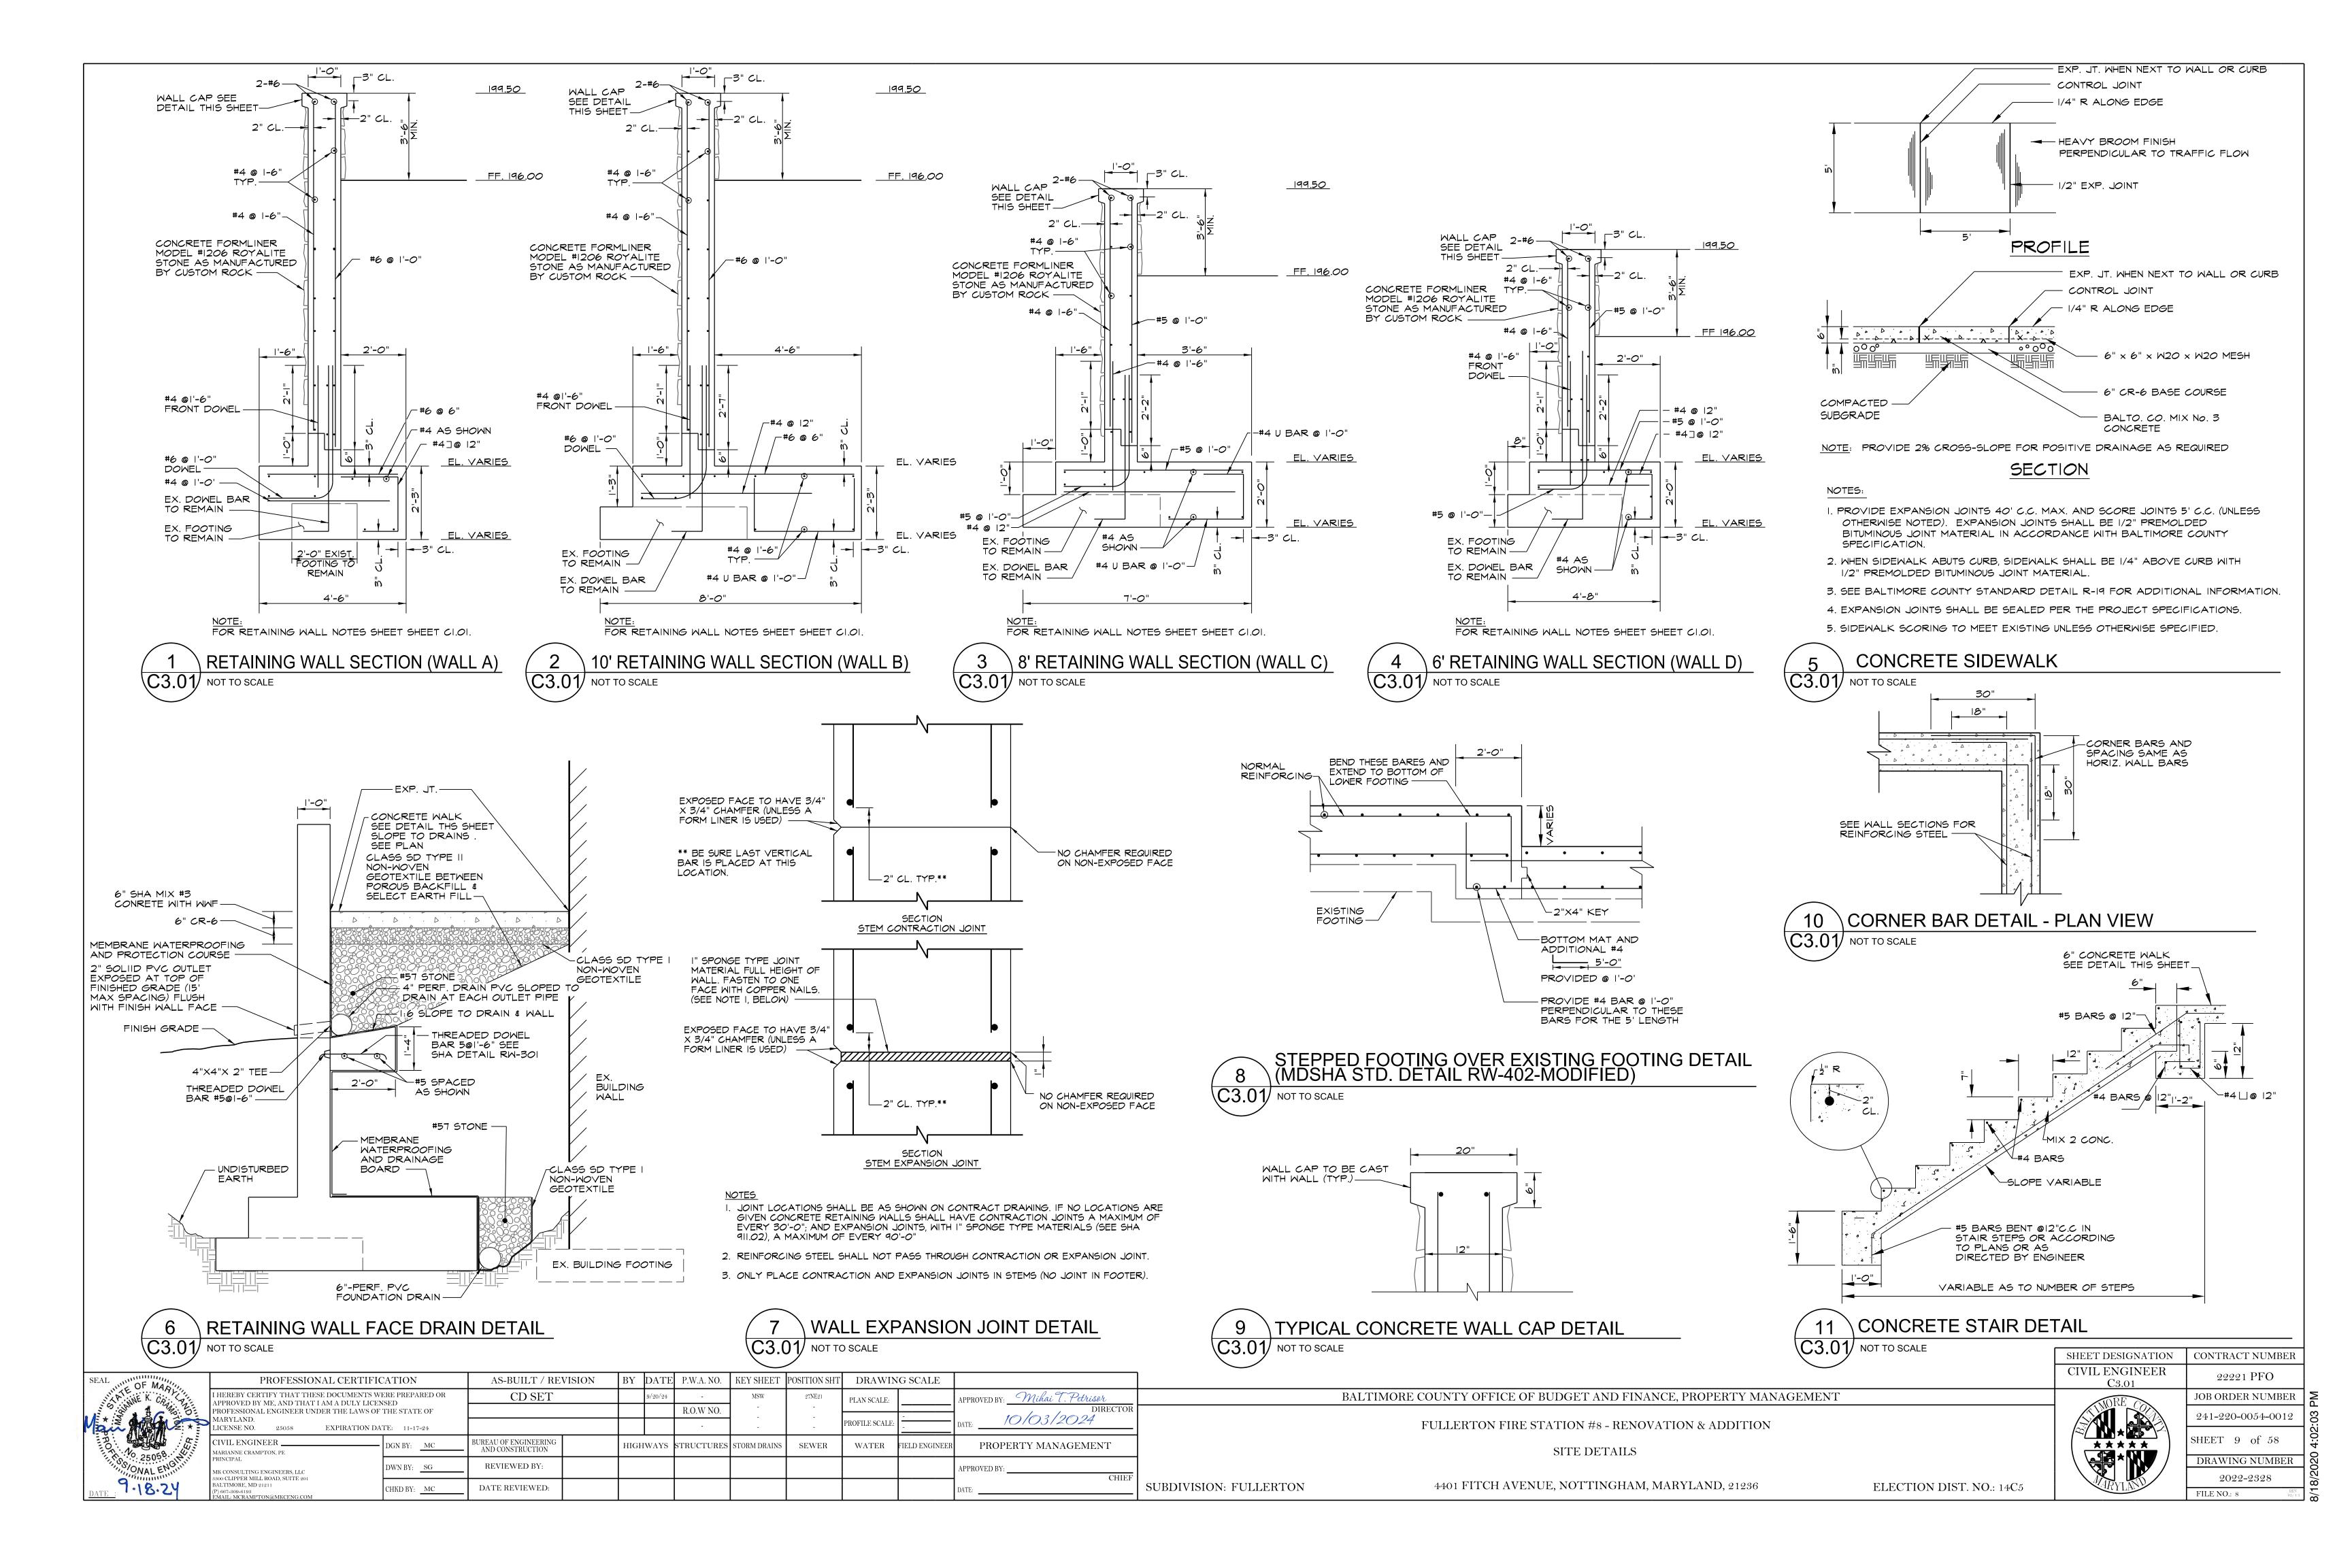
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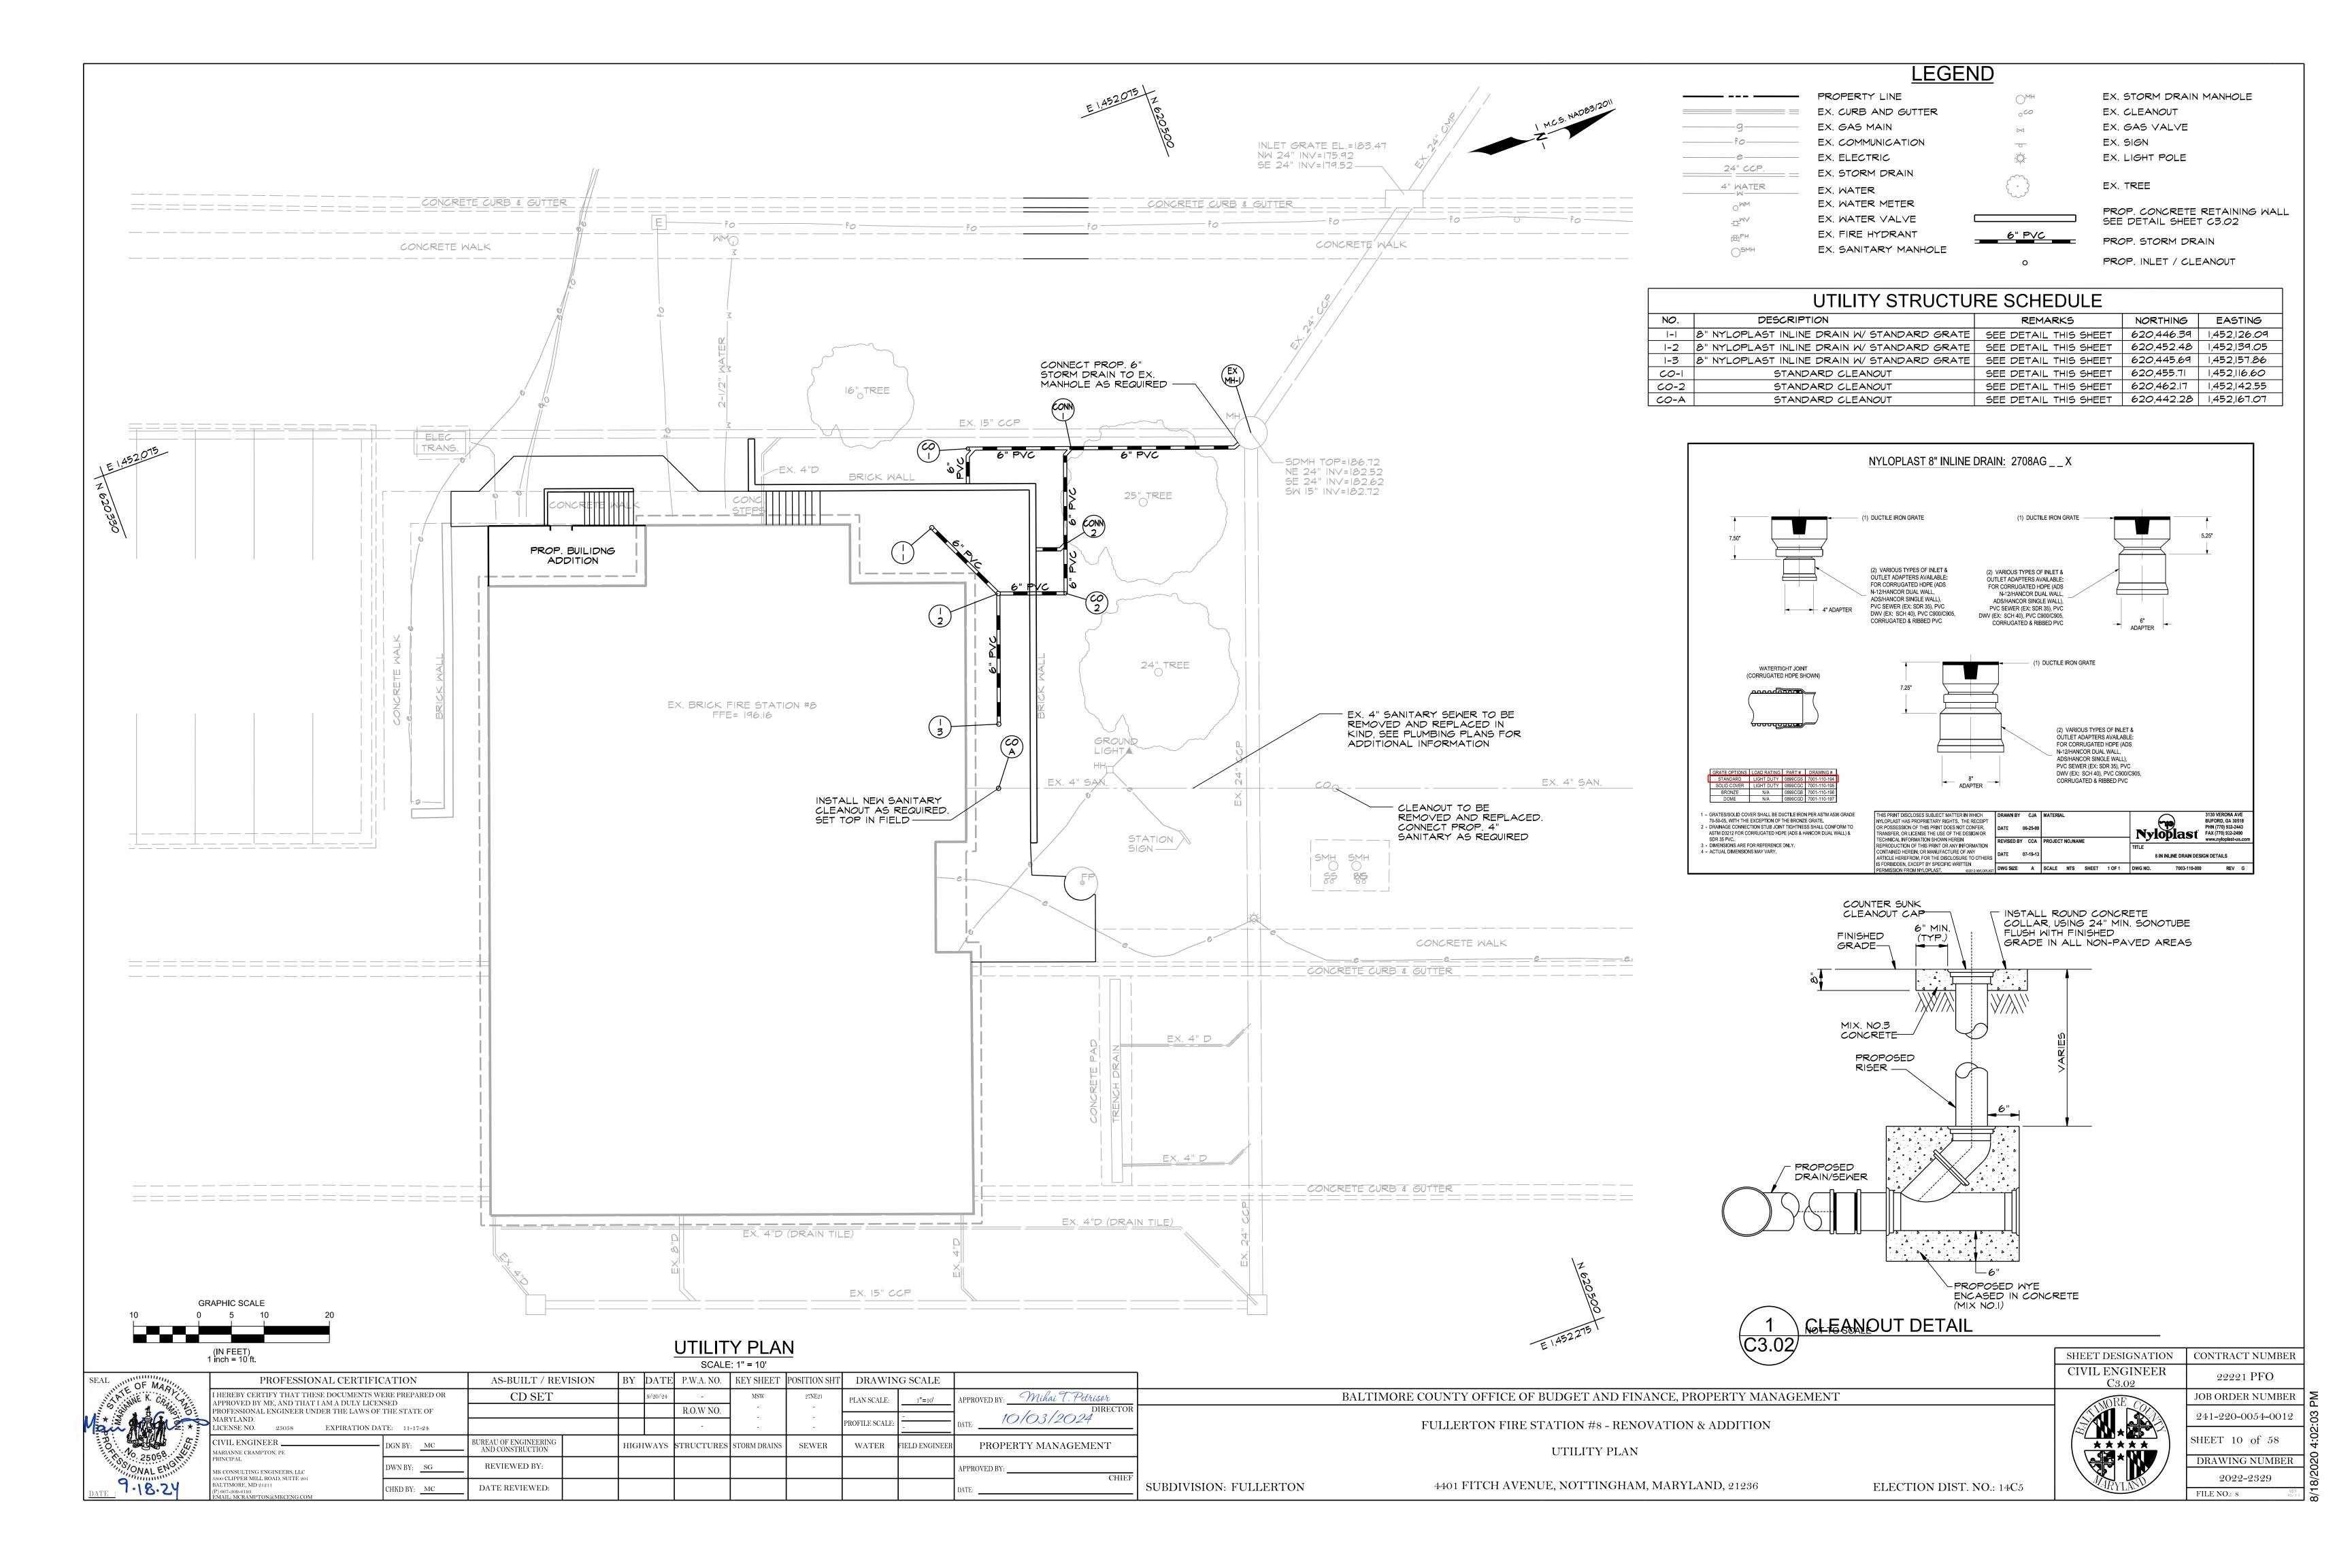
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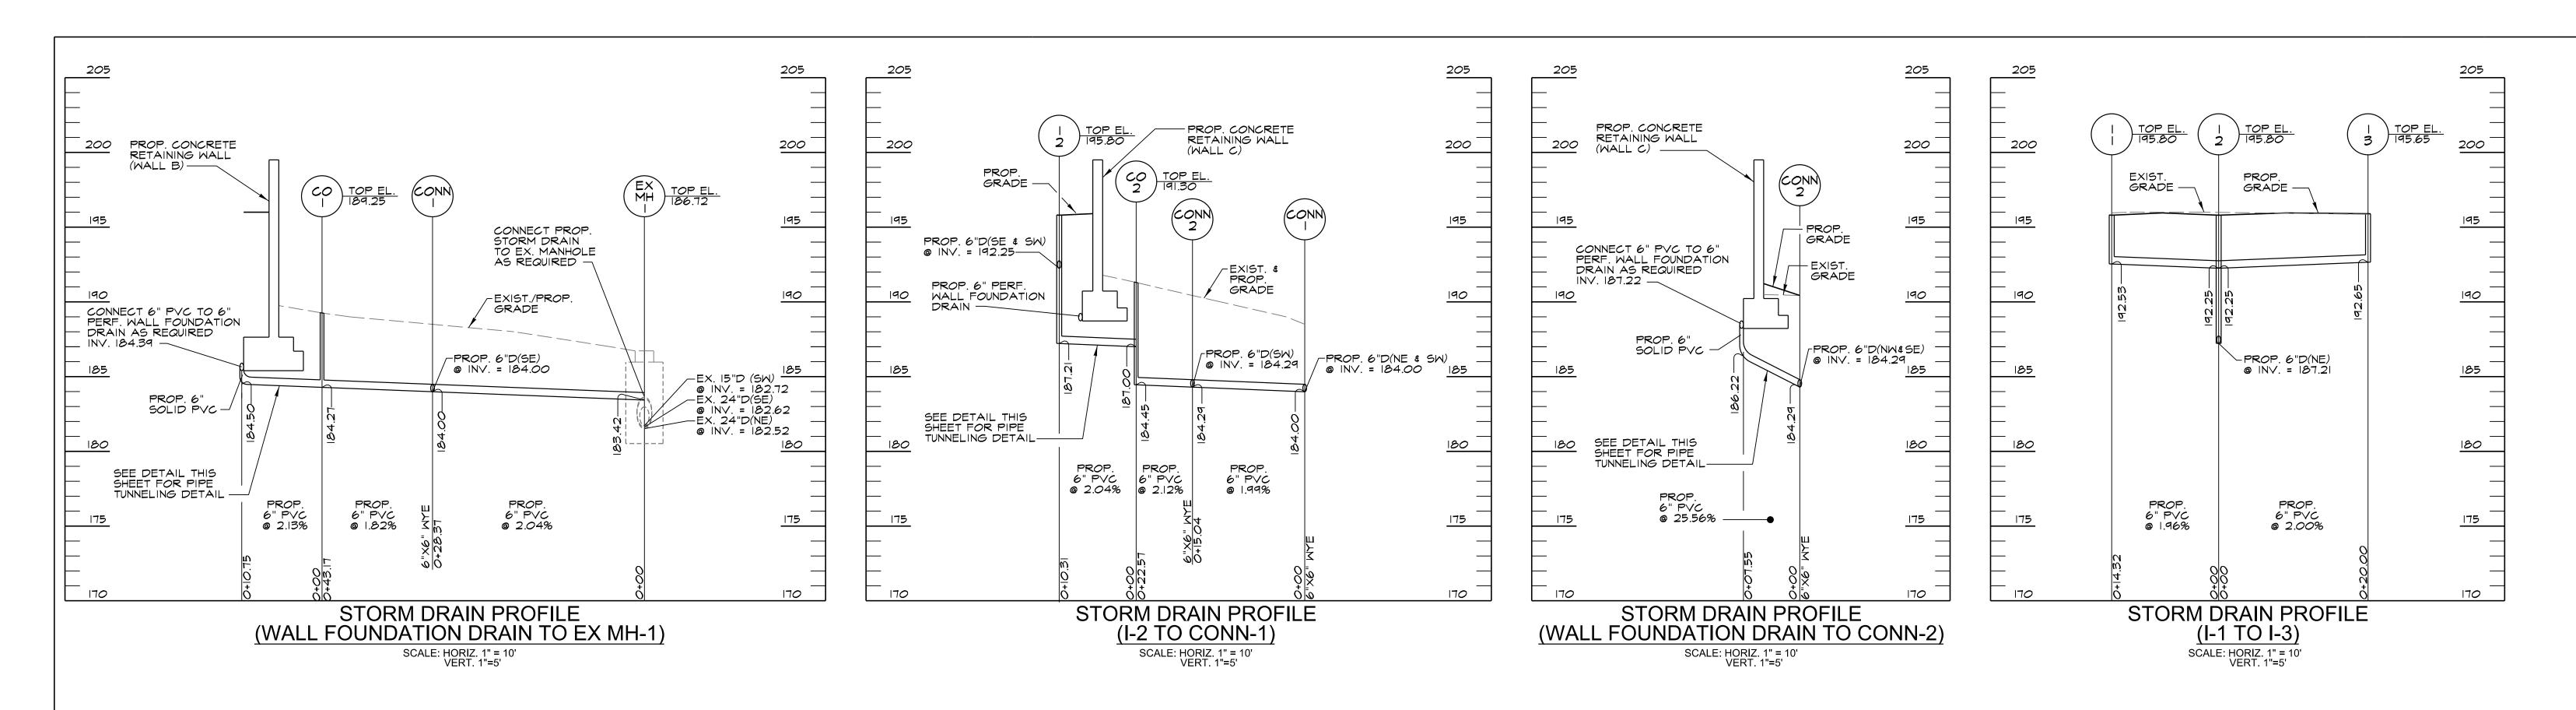
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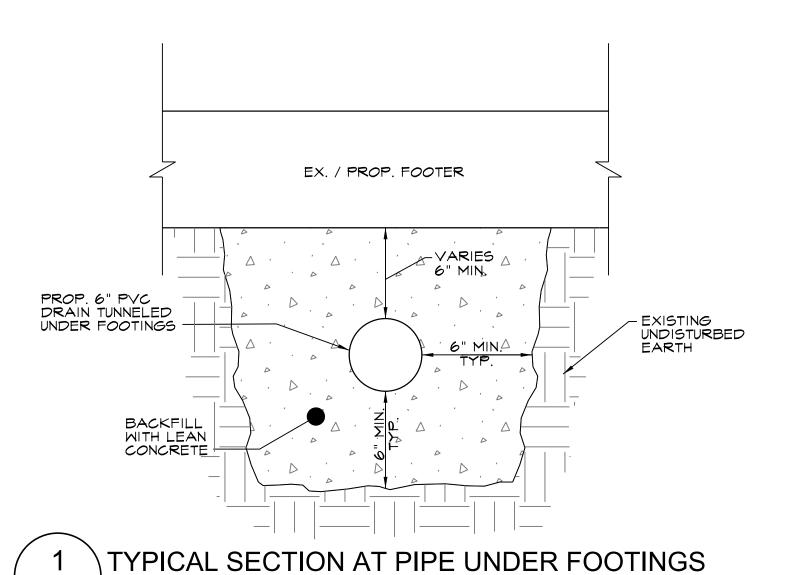






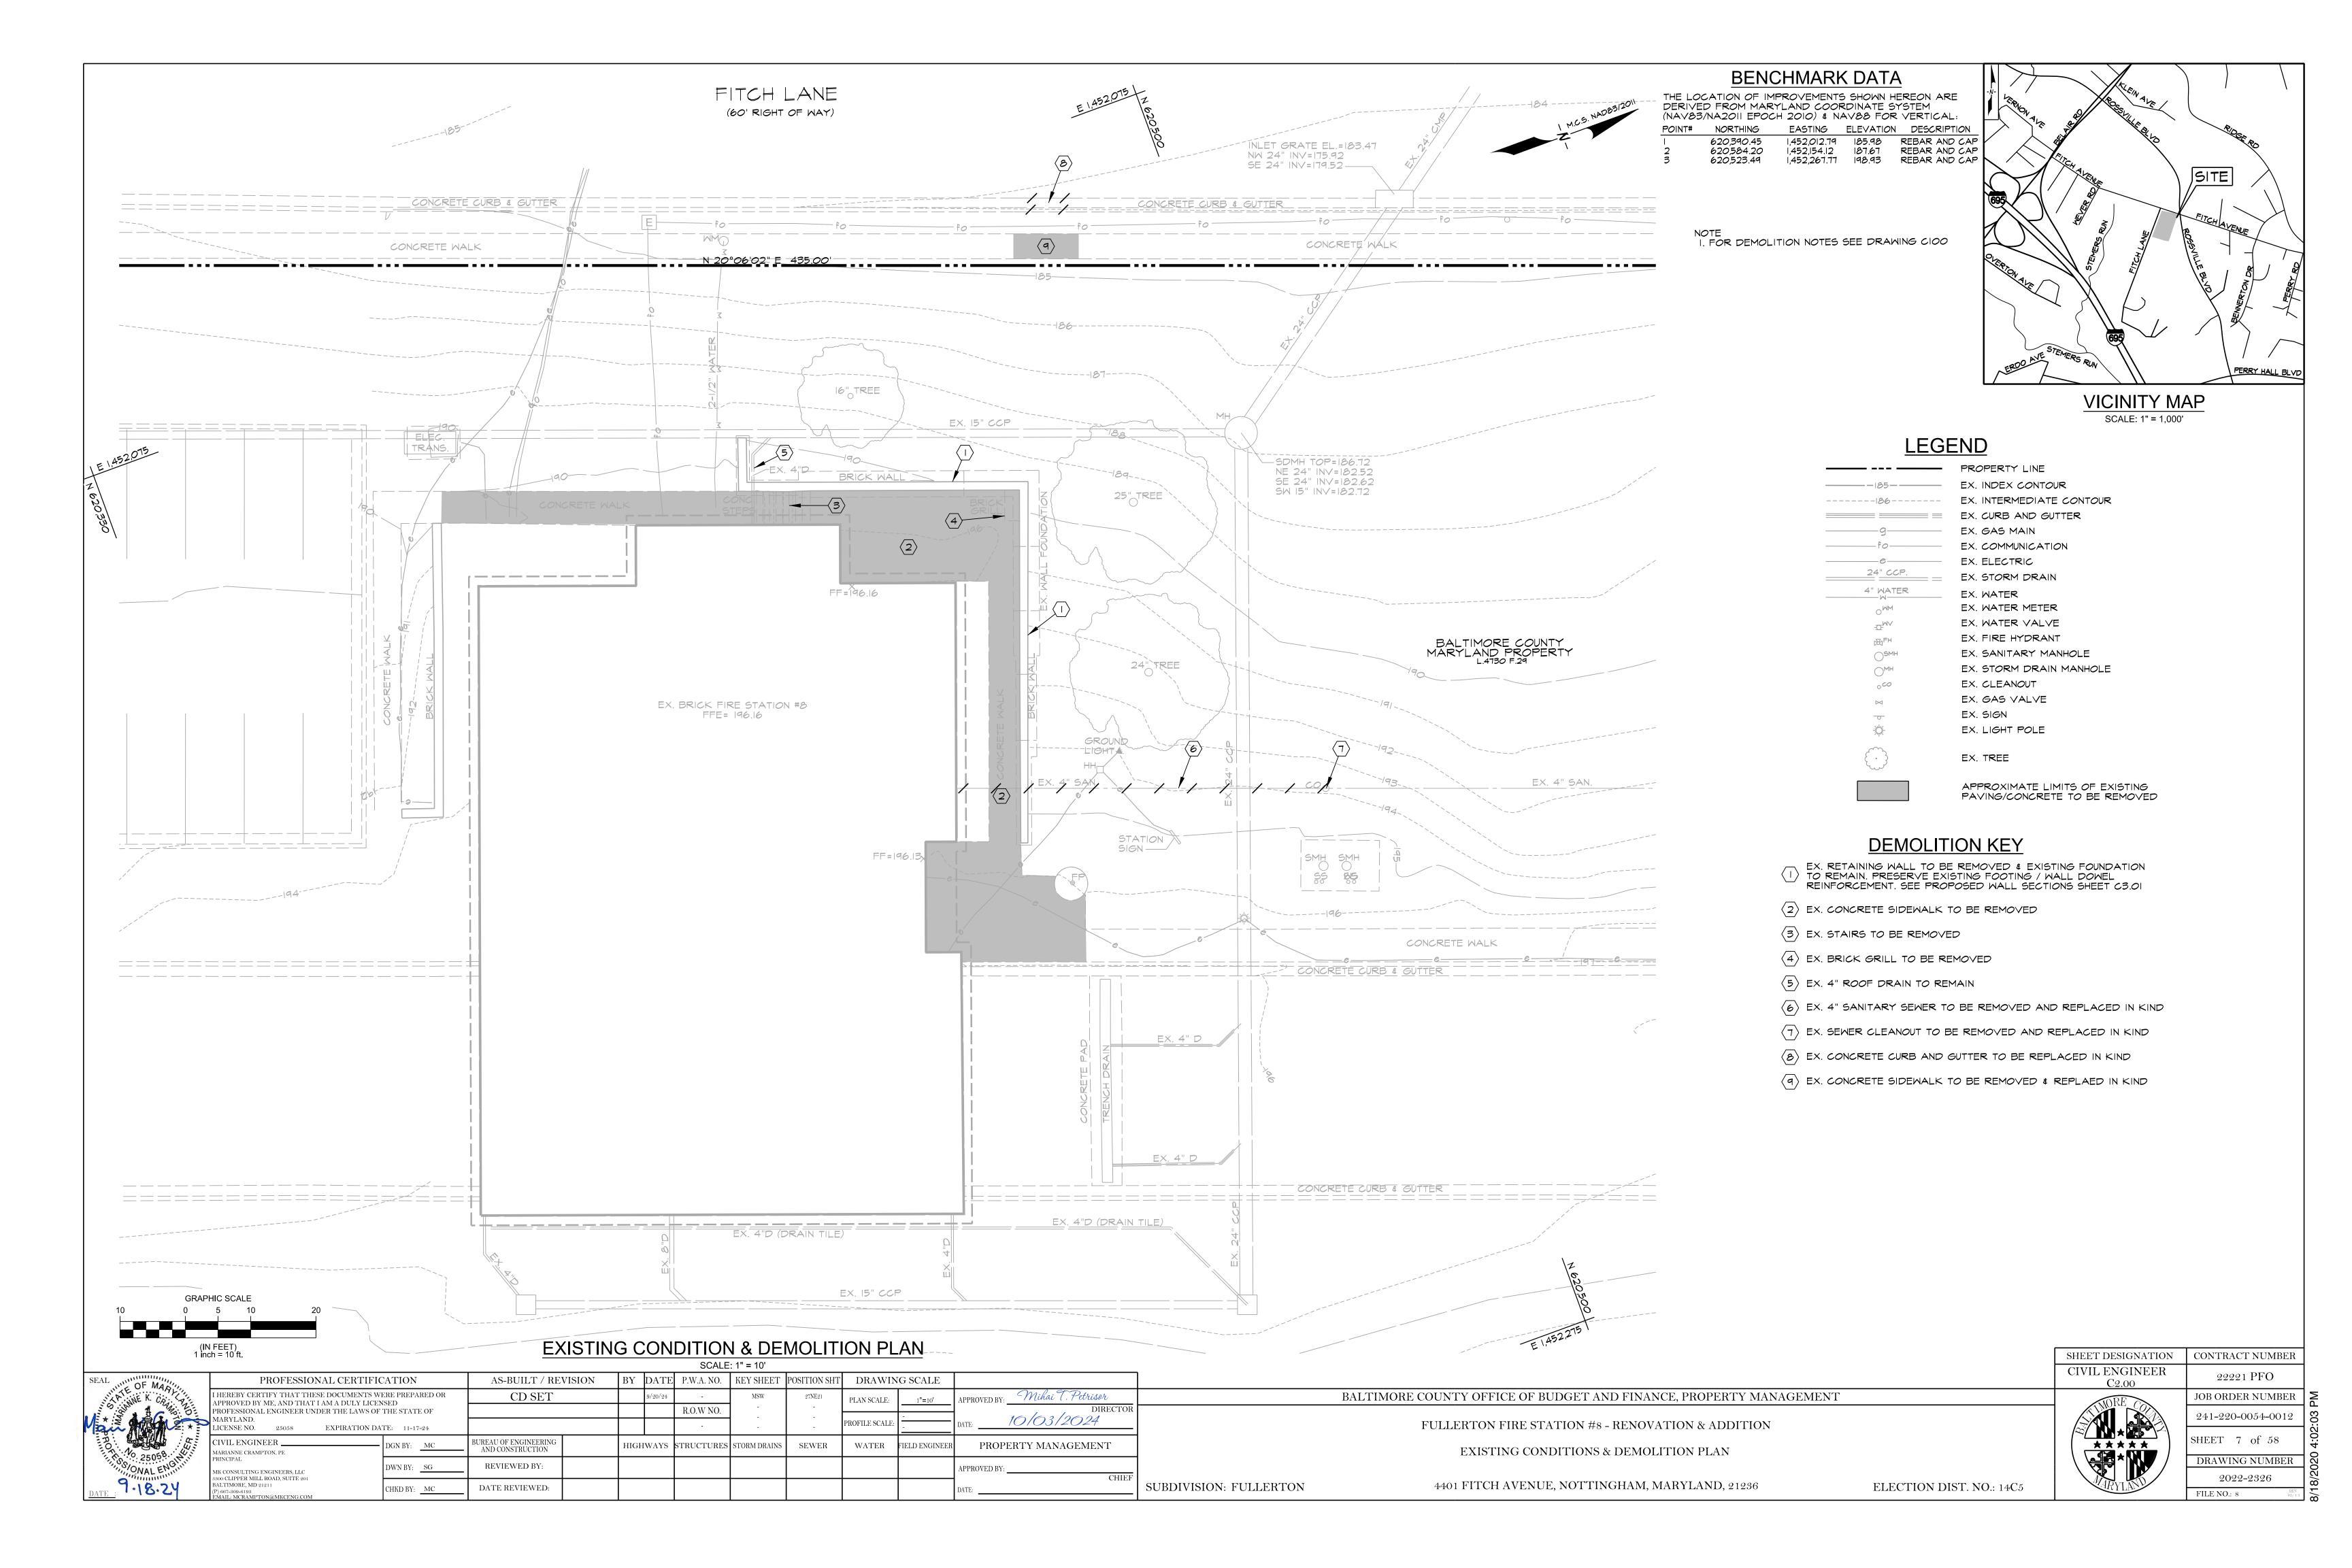

SUBDIVISION: FULLERTON

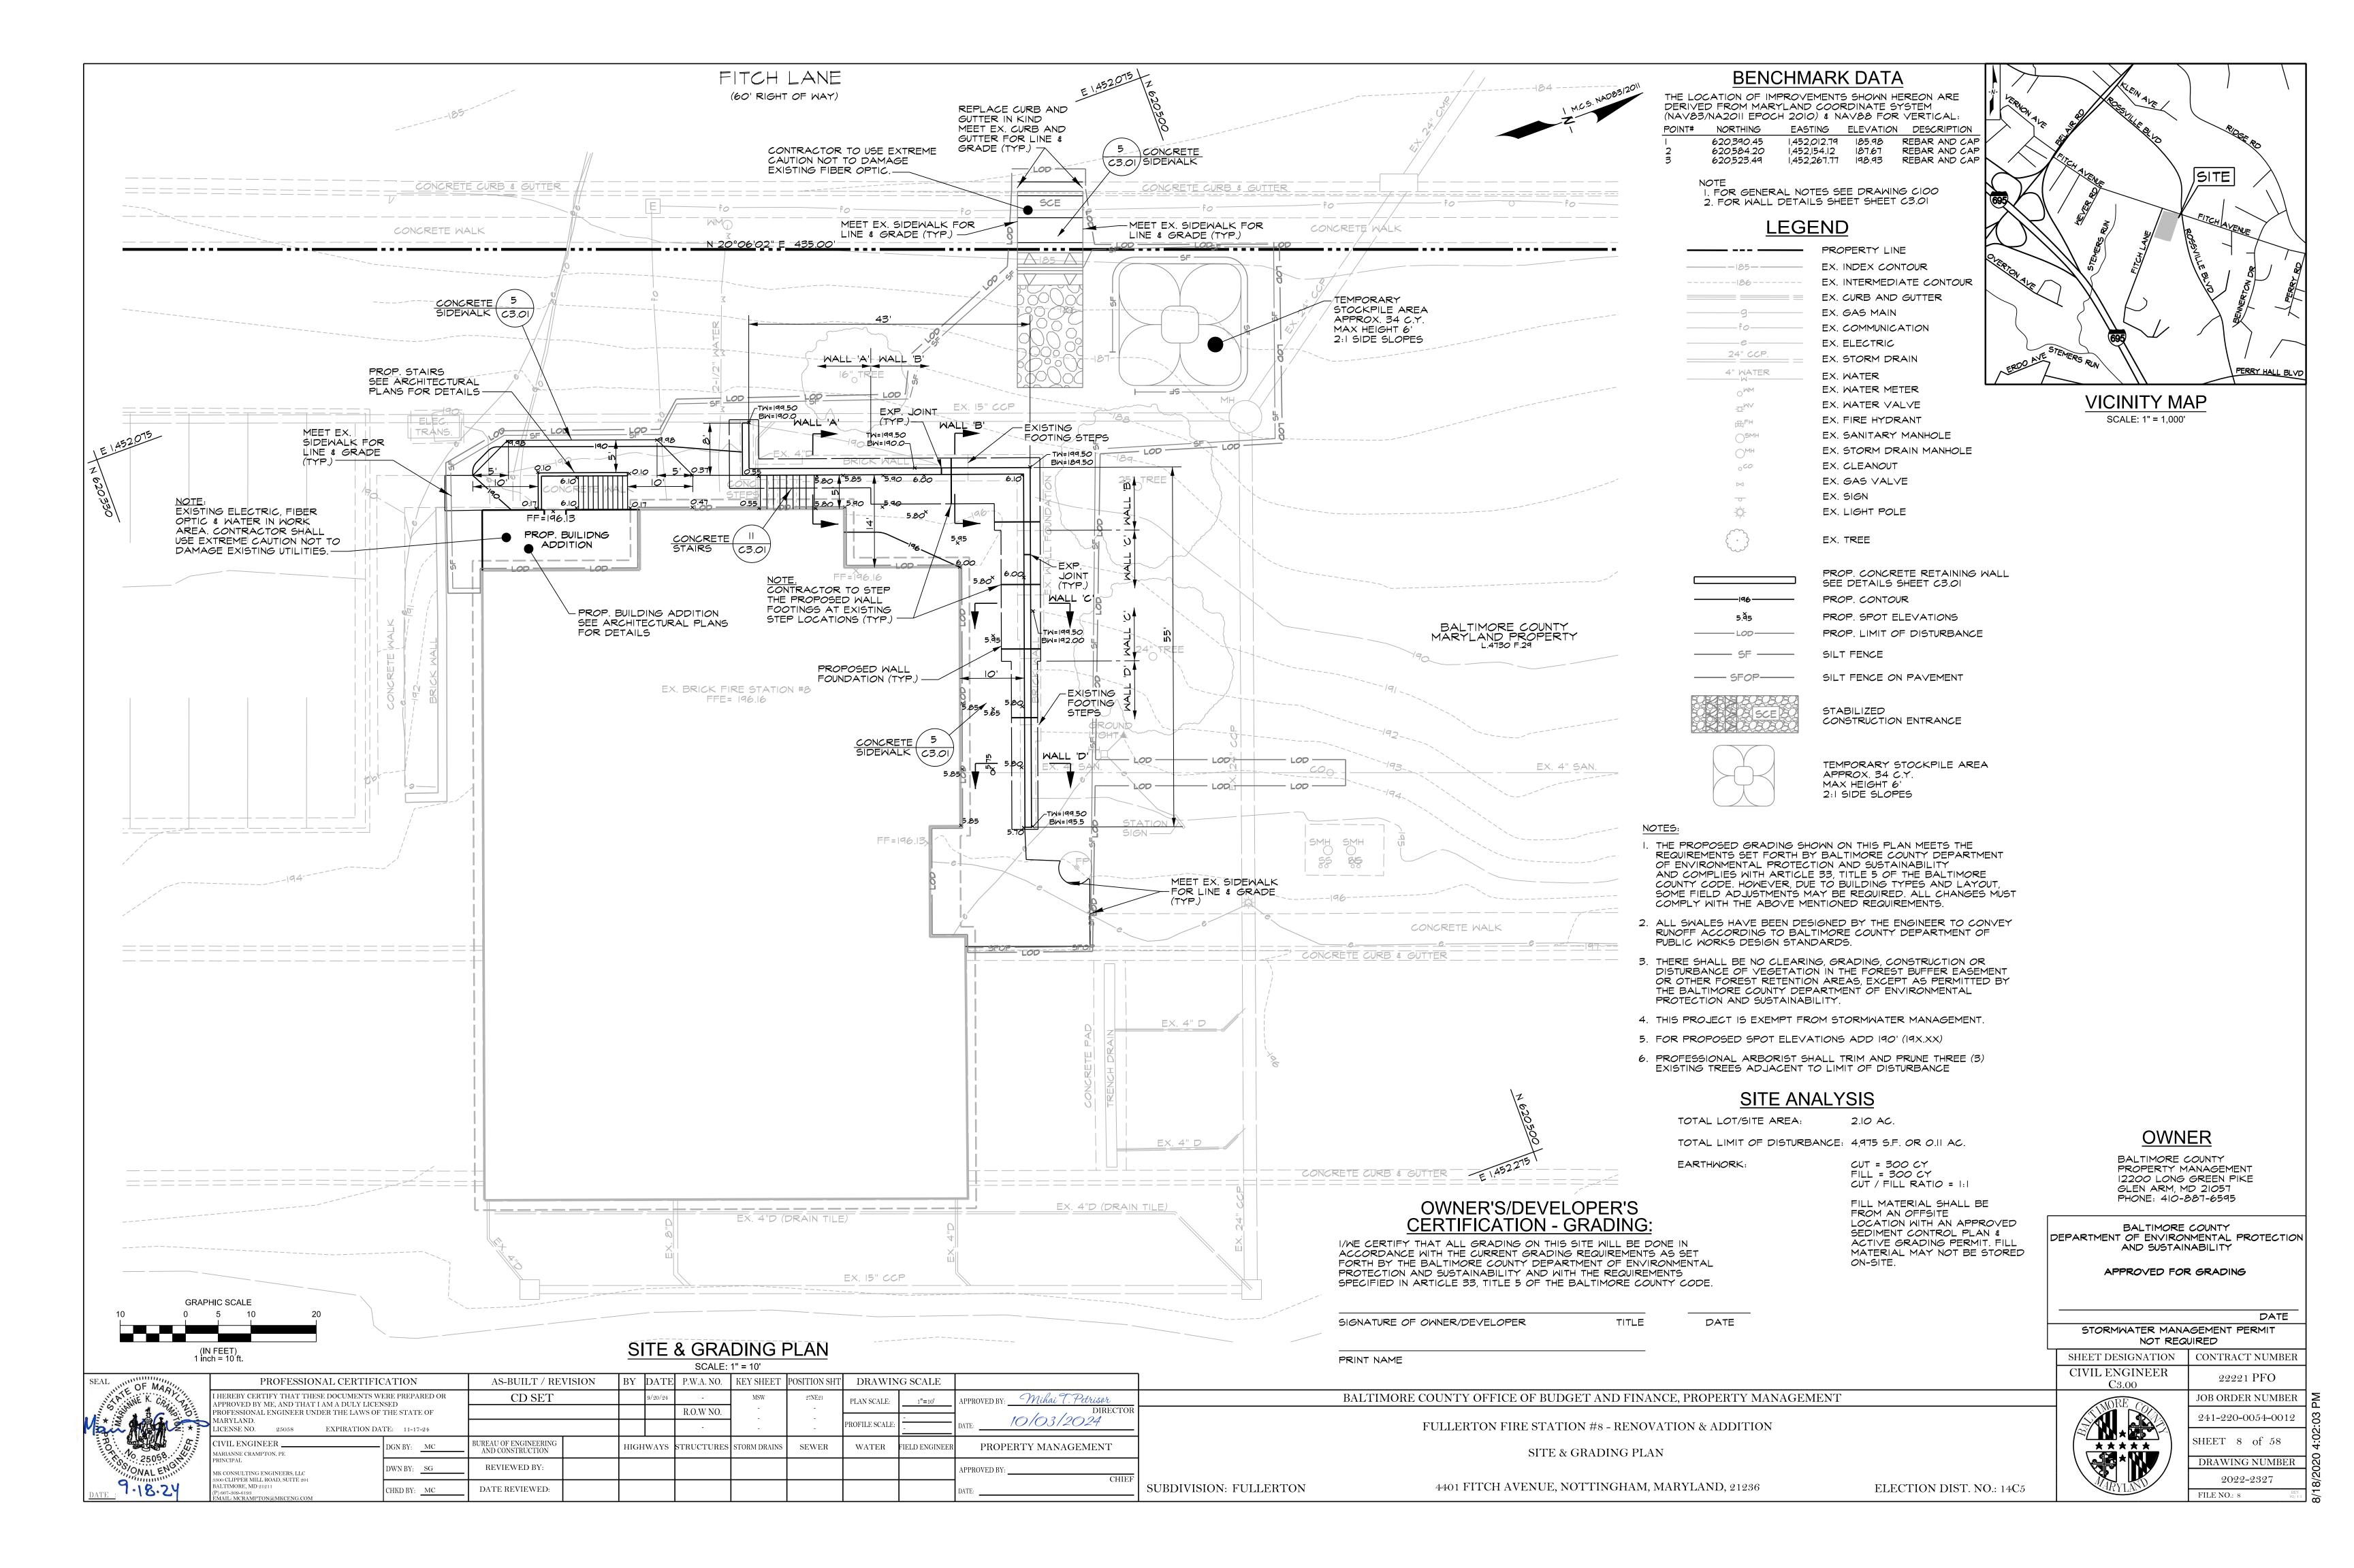

C3.03 NOT TO SCALE


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SEAL OF MAD'		PROFESSIONAL CERTIFIC	AS-BUILT / RE	VISION	BY	DATE	P.W.A. NO.	KEY SHEET	POSITION SHT	DRAWIN	G SCALE			
	S MINE K. CON STEEL	I HEREBY CERTIFY THAT THESE DOCUMENTS WERE PREPARED OR APPROVED BY ME, AND THAT I AM A DULY LICENSED		CD SET			9/20/24	-	MSW	27NE21	PLAN SCALE:		APPROVED BY:	Mihai T. Petrisor
	THE STATE OF THE S	PROFESSIONAL ENGINEER UNDER THE LAWS OF MARYLAND.						R.O.W NO.	-	-		- HORIZ. 1"=10'	10	103/2024 DIRECTO
	Man Marie	LICENSE NO. 25058 EXPIRATION DA	TE: 11-17-24					-	-	-	PROFILE SCALE:	- VERT. 1"=5'	DATE:	70072027
	100	CIVIL ENGINEER MARIANNE CRAMPTON, PE	DGN BY: MC	BUREAU OF ENGINEERING AND CONSTRUCTION		HIGH	WAYS	STRUCTURES	STORM DRAINS	SEWER	WATER	FIELD ENGINEER	PROPER'	TY MANAGEMENT
	ONAL EN	PRINCIPAL  MK CONSULTING ENGINEERS, LLC 3500 CLIPPER MILL ROAD, SUITE 201	DWN BY: SG	REVIEWED BY:									APPROVED BY:	СНІ
	DATE . 1.18.29	3500 CLIPPER MILL ROAD, SUITE 201 BALTIMORE, MD 21211 (P) 667-309-6193 EMAIL: MCRAMPTON@MKCENG.COM	CHKD BY: MC	DATE REVIEWED:									DATE:	CHI


CIVIL ENGINEER 22221 PFO JOB ORDER NUMBER 241-220-0054-0012 SHEET 11 of 58 DRAWING NUMBER 2022-2330 FILE NO.: 8

CONTRACT NUMBER

SHEET DESIGNATION

BALTIMORE COUNTY OFFICE OF BUDGET AND FINANCE, PROPERTY MANAGEMENT	
FULLERTON FIRE STATION #8 - RENOVATION & ADDITION STORM DRAIN PROFILES	
4401 FITCH AVENUE, NOTTINGHAM, MARYLAND, 21236	ELECTION DIST. NO.: 14C5

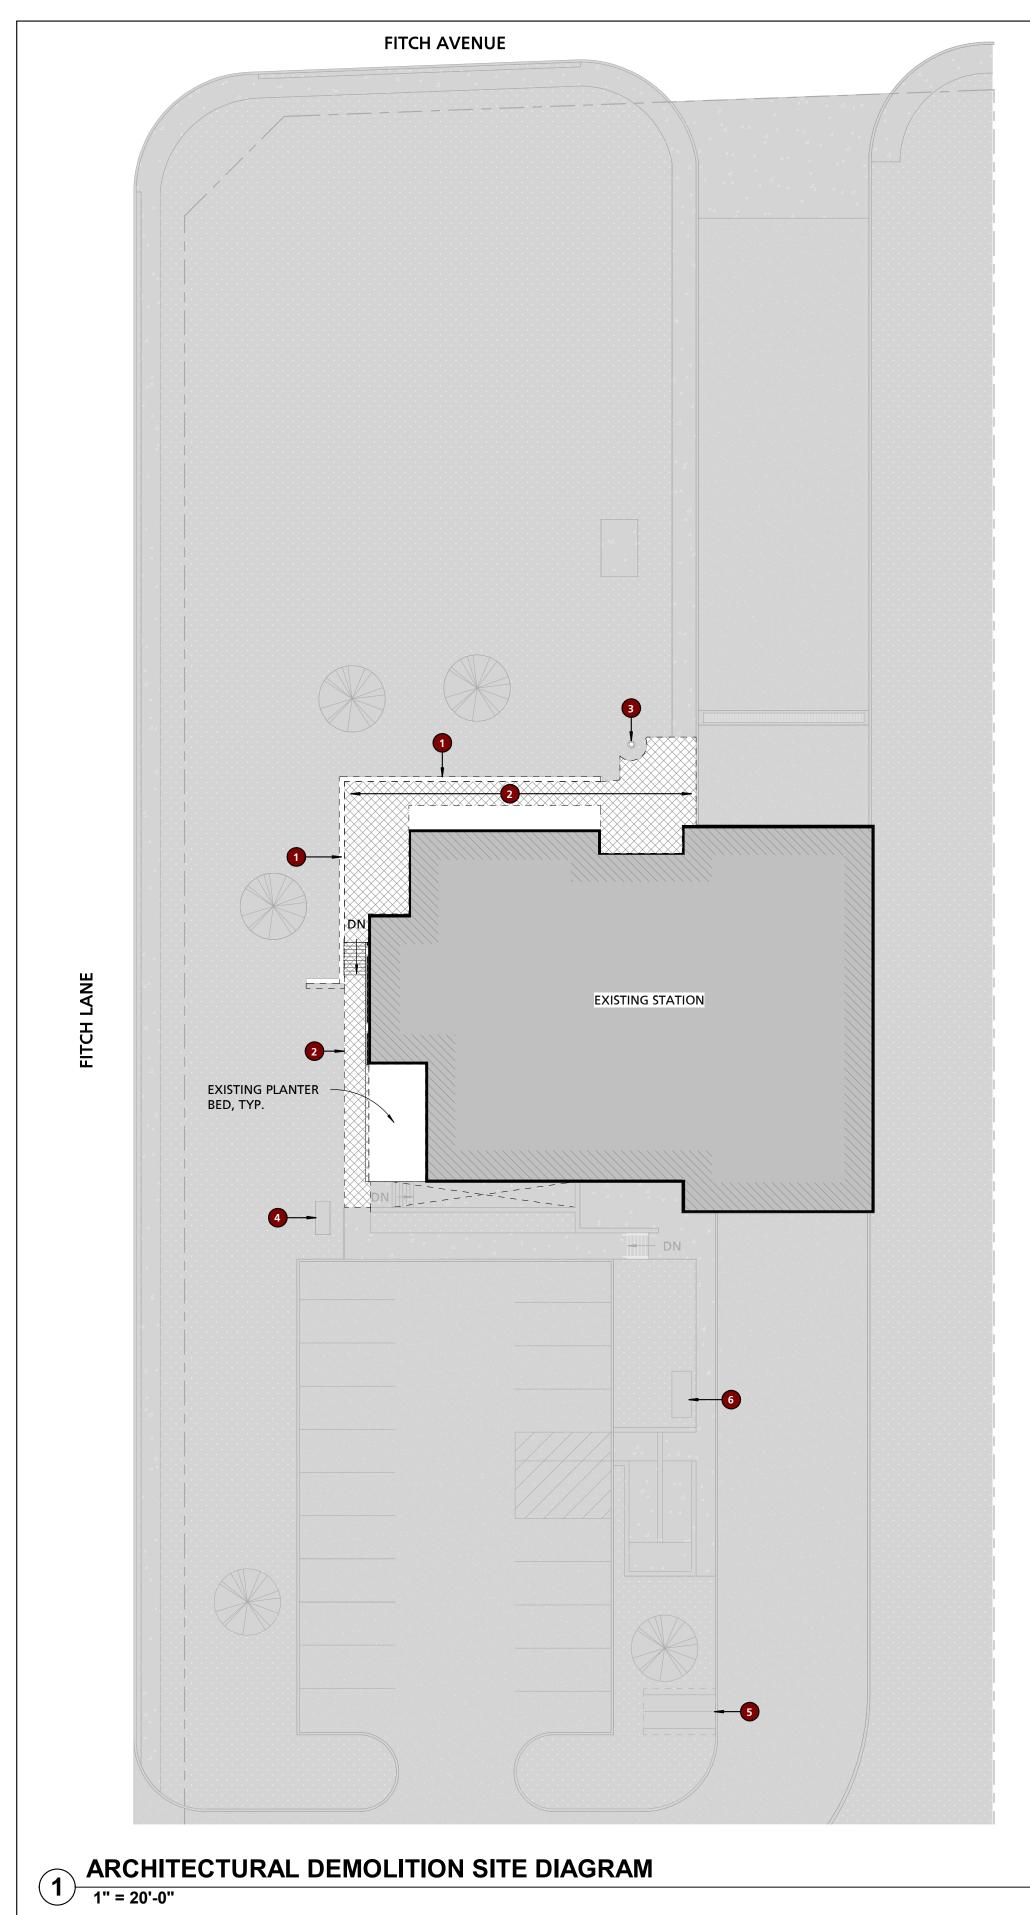

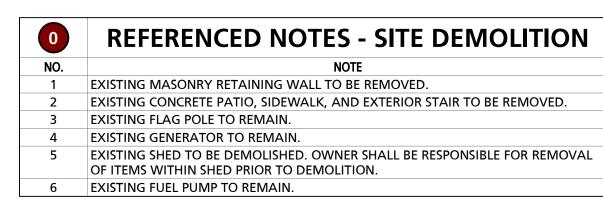

APPROVED BY: Mihai T. Petrisor

10/03/2024

PROPERTY MANAGEMENT

SUBDIVISION: FULLERTON

APPROVED BY:

**LEGEND EXISTING ELEMENTS TO REMAIN** CONCRETE PATIO TO BE REMOVED 

TRAILER 3 PRIVACY FENCE -TRAILER 2 RAMP UP TRAILER 1 TO TRAILER (14) CONTROL JOINTS EQUALLY SPACED EXISTING STATION PROPOSED ADDITION SHED LOCATION

FITCH AVENUE

**TYPICAL REFERENCE NOTES - SITE DIAGRAM** CONCRETE PATIO & CAST-IN-PLACE CONCRETE RETAINING WALL. 2 LOCATION FOR TEMPORARY LIVING FACILITY TRAILERS. CONTRACTOR TO PROVIDE TRAILERS WITH TEMPORARY WATER, SANITARY, ELECTRIC, THROUGHOUT THE DURATION OF CONSTRUCTION. 3 ALIGN CONTROL JOINTS WITH BUILDING EDGE 4 GRAVEL PAD AREA FOR STORAGE SHED. GRAVEL PAD AREA SHALL BE MADE LEVEL AS NECESSARY WITH PRESSURE TREATED 6x6 KNEE WALL. GRAVEL TO BE COMPACTED #57 STONE 5 PRE-FABRICATED WOODEN STORAGE SHED PROVIDED BY CONTRACTOR. CONTRACTOR SHALL CONFIRM FINAL LAYOUT AND LOCATION OF SHED WITH COUNTY PRIOR TO INSTALLATION OF GRAVEL PAD/SHED. 6 CONTRACTOR TO DEMO 6' OF EXISTING CURB AND REPOUR CURB AS DEPRESSED CURB. DEPRESSED CURB LOCATION TO ALIGN WITH OPENING OF STORAGE SHED. CAST IN PLACE CONCRETE STAIR 8 FRONT RESPONSE APRON MUST STAY CLEAR OF ALL CONSTRUCTION OPERATIONS DURING ENTIRE CONSTURCTION PROCCESS. 9 COUNTY TO PROVIDE TEMPORARY DATA, TELEPHONE, CABLE, AND FIREHOUSE ALERTING SYSTEM TO TEMPORARY LIVING FACILITIES. 10 EXISTING PARKING AREA MUST BE KEPT CLEAR OF ALL CONSTRUCTION ACTIVITIES TO ENSURE PARKING IS AVAILABLE TO FIRE DEPARTMENT PERSONNEL. 11 TEMPORARY WALKWAY TO BE DEMOLISHED AFTER CONSTRUCTION, REGRADED AND SEEDED TO TURN BACK INTO LAWN

#### TRAILER BASIS OF DESIGN REQUIREMENTS AS PROVIDED BY CONTRACTOR

#### TRAILER 1 - LOUNGE: APPROX. 25'x50' LOUNGE AREA FOR 11 RECLINERS SMALL KITCHENETTE (4 BURNER STOVE W/ OVEN, ONCE COMPARTMENT EXTA DEEP SINK, (2) FULL REFRIGERATOR, FREEZER, (2) MICROWAVE. 2 OFFICES TO FIT A DESK W/ COMPUTER AND PHONE, 2 CHAIRS, FILE CABINET AND BED TEMPORARY CONDUIT W/ STRINGS, SIZED PER CODE, FROM EXISTING NETWORK TO TRAILER 1 TO ACCOMODATE TELECOM REQUIREMENTS. CONTRACTOR TO COORDINATE WITH OIT. TEMPORARY CONDUIT W/ STRINGS, SIZED PER CODE, FROM EXISTING COMMAND CENTER TO TRAILER 1 TO ACCOMODATE EMERGENCY NOTIFICATION REQUIREMENTS. CONTRACTOR TO COORDINATE WITH OIT. ALERTING AND DISPATCH

#### TRAILER 2 - BUNK TRAILER:

APPROX. 20'x48' TRAILER BUNK SLEEPS 11 TOTAL

2 BUNK ROOMS WITH FLOOR TO CEILING WALLS

9 BUNK ROOMS IN COMMON AREA

TEMPORARY CONDUIT W/ STRINGS, SIZED PER CODE, FROM EXISTING NETWORK TO TRAILER 1 TO ACCOMODATE TELECOM REQUIREMENTS. CONTRACTOR TO COORDINATE WITH OIT. TEMPORARY CONDUIT W/ STRINGS, SIZED PER CODE, FROM EXISTING COMMAND CENTER TO TRAILER 1 TO ACCOMODATE EMERGENCY NOTIFICATION REQUIREMENTS. CONTRACTOR TO

COORDINATE WITH OIT. ALERTING AND DISPATCH

#### TRAILER 3 - T&S: APPROX. 7'x20'

4 PERSONAL TOILET & SHOWER STALLS


1 AUDIBLE ALARM

TEMPORARY CONDUIT W/ STRINGS, SIZED PER CODE, FROM EXISTING COMMAND CENTER TO TRAILER 1 TO ACCOMODATE EMERGENCY NOTIFICATION REQUIREMENTS. CONTRACTOR TO COORDINATE WITH OIT.

CONTRACTOR SHALL BE RESPONSIBLE FOR DELIVERY, INSTALLATION OF TEMPORARY LIVING FACILITIES IN ADDITION TO PROVIDING THE ASSOCIATED WALK WAYS, TEMPORARY UTILITIES, PRIVACY FENCE AND TEMPORARY FOUNDATION REQUIRED FOR SAID FACILITIES.

CONTRACTOR SHALL BE RESPONSIBLE FOR OBTAINING AND PROVIDING ALL REQUIRED PERMITS AND ASSOCIATED REVIEW FEES RELATED TO PROVIDING THE TEMPORARY LIVING FACILITIES.

CONTRACTOR SHALL BE RESPONSIBLE FOR CABLES AND CABLE INSTALLATION TO THE TEMPORARY LIVING FACILITIES.

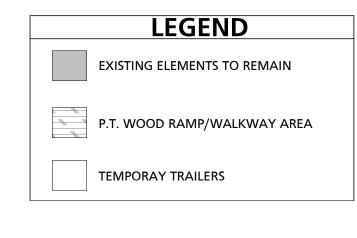

ARCHITECTURAL SITE DIAGRAM & TEMPORARY FACILITIES PLAN

AS-BUILT / REVISION BY DATE P.W.A. NO. KEY SHEET POSITION SHT DRAWING SCALE PROFESSIONAL CERTIFICATION HEREBY CERTIFY THAT THESE DOCUMENTS WERE PREPARED OR BID/PERMIT PLAN SCALE: APPROVED BY ME, AND THAT I AM A DULY LICENSED PROFESSIONAL ARCHITECT UNDER THE LAWS OF THE STATE OF R.O.W NO. MARYLAND. EXPIRATION DATE: 08-18-2026 LICENSE NO. 15505 BUREAU OF ENGINEERING AND CONSTRUCTION WATER FIELD ENGINEER HIGHWAYS STRUCTURES STORM DRAINS SEWER REVIEWED BY: 10839-D PHILADELPHIA ROAD WHITE MARSH, MARYLAND 21162 DATE REVIEWED:

BALTIMORE COUNTY OFFICE OF BUDGET AND FINANCE, PROPERTY MANAGEMENT

FULLERTON FIRE STATION #8 - RENOVATION & ADDITION

ARCHITECTURAL SITE DIAGRAMS


4401 FITCH AVENUE, NOTTINGHAM, MARYLAND, 21236

AD100

SHEET DESIGNATION | CONTRACT NUMBER

22221 PFO JOB ORDER NUMBER 241-220-0054-0012 SHEET 12 of 58 DRAWING NUMBER 2022-2331

FILE NO.: 8

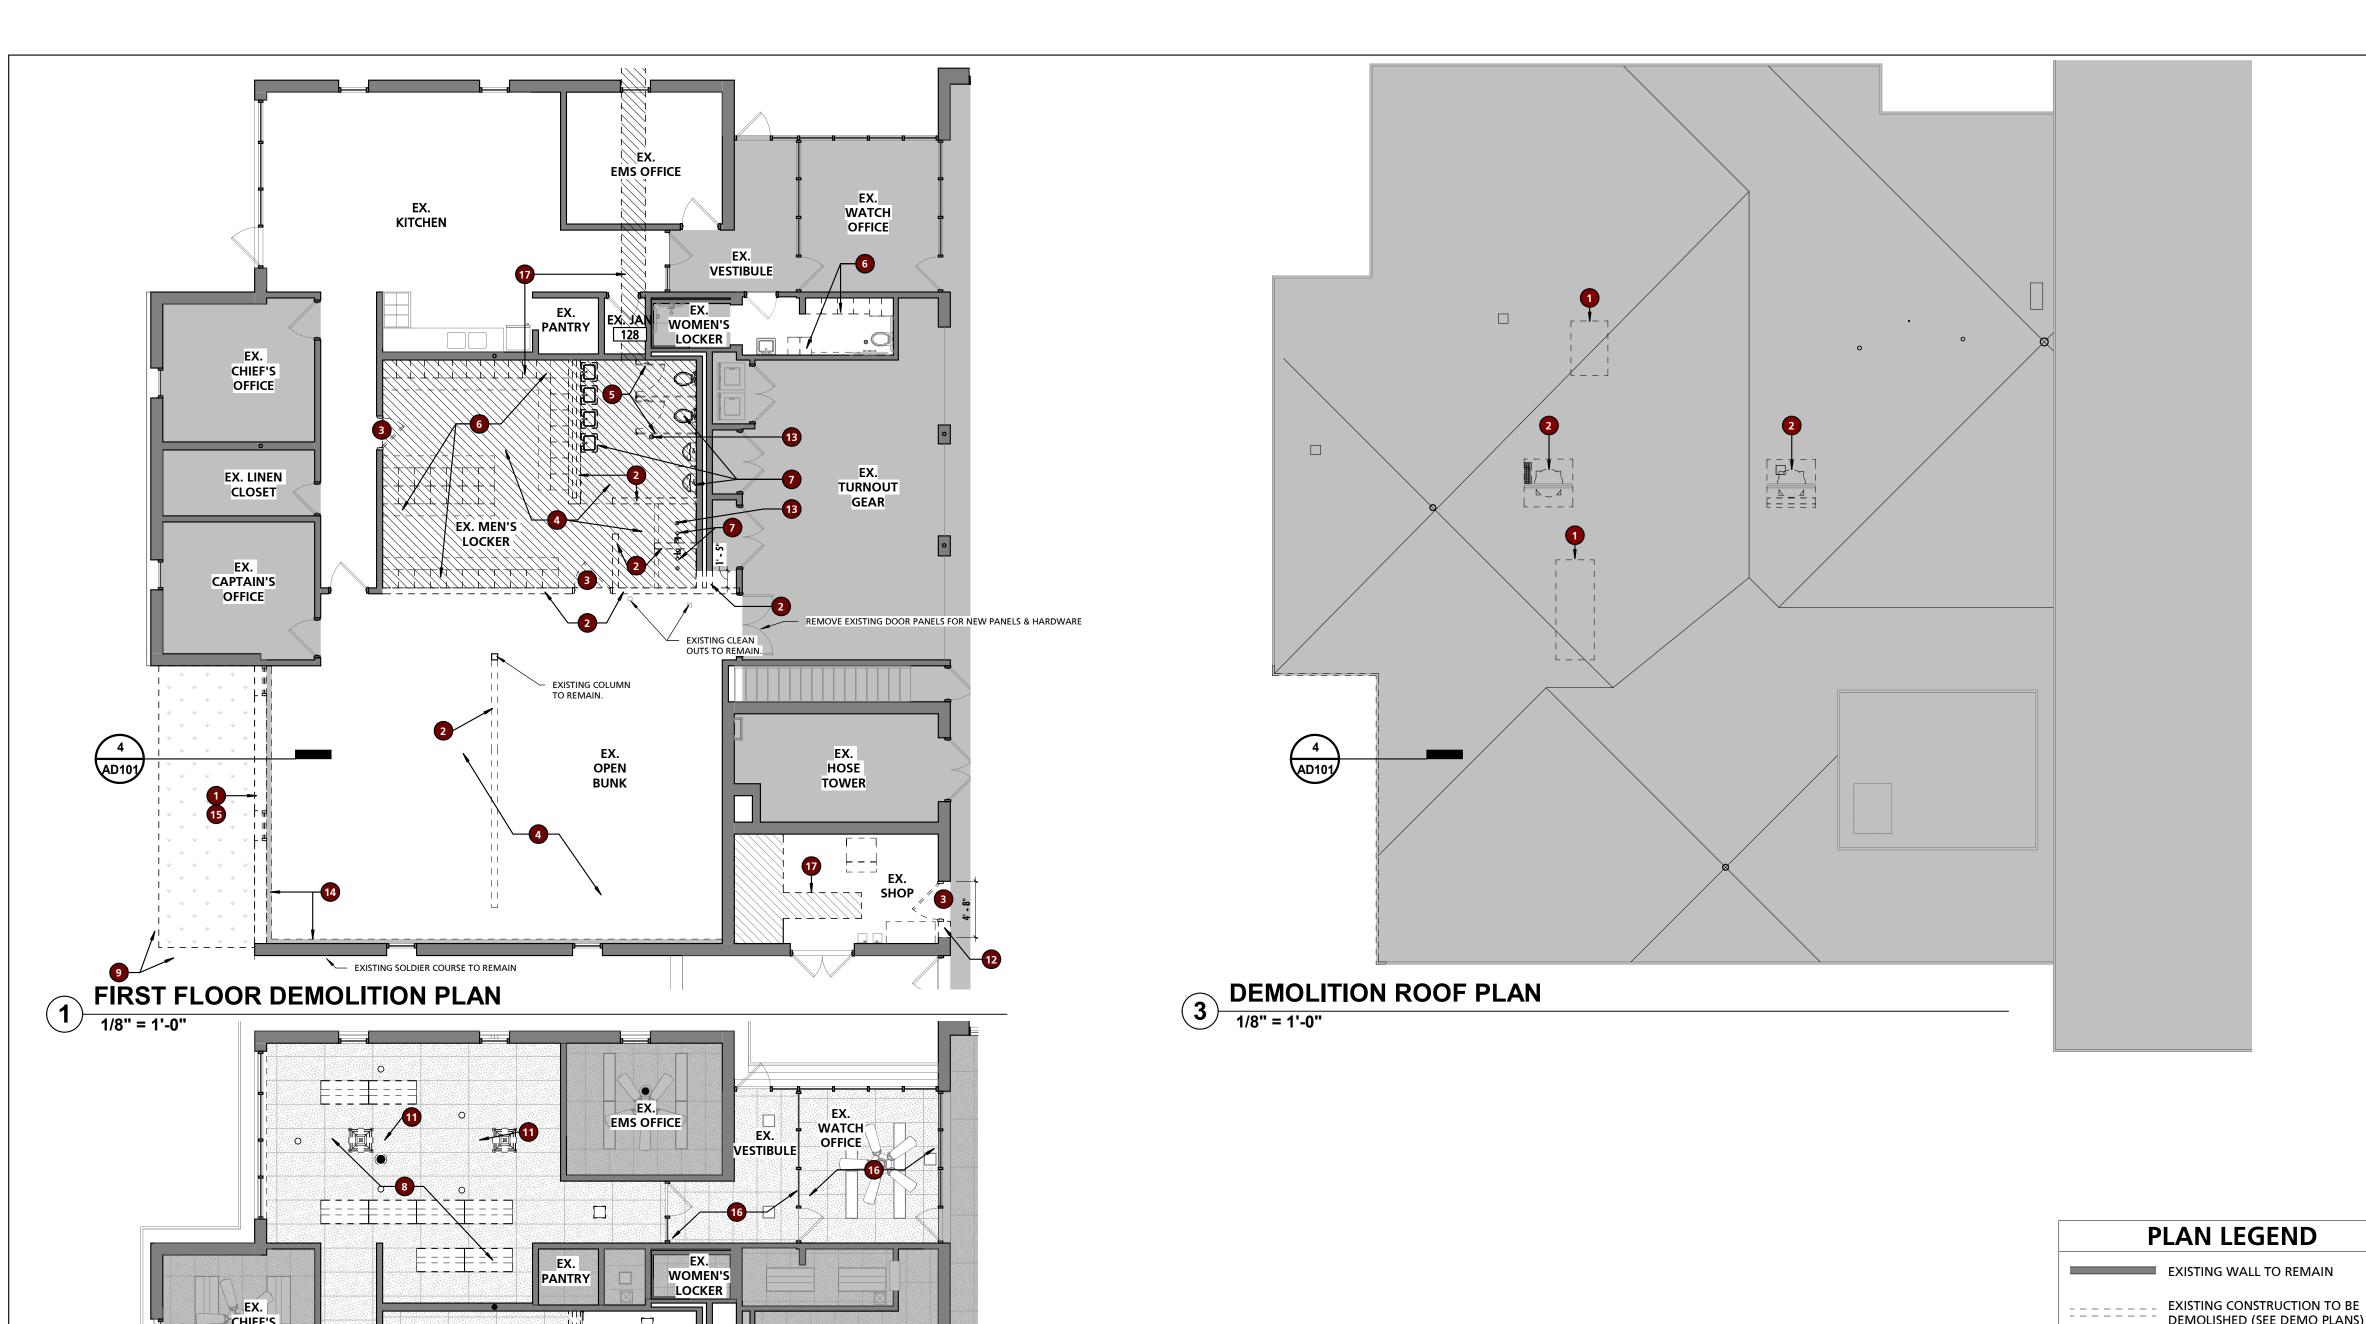

### **GENERAL DEMOLITION NOTES**

- 1 ALL BIDDERS SHALL MAKE THEMSELVES FAMILIAR WITH THE EXISTING PROJECT CONDITIONS PRIOR TO SUBMITTING A BID. THIS IS INCLUSIVE OF CONDITIONS ABOVE ACCESSIBLE CEILINGS TO DETERMINE WORKING CONDITIONS.
- PRIOR TO THE PERFORMANCE OF ANY DEMOLITION WORK THE CONTRACTOR SHALL MAKE THEMSELVES FAMILIAR WITH THE EXISTING CONDITIONS OF THE PROJECT. THE CONTRACTOR SHALL BE RESPONSIBLE FOR DESIGNING, PROVIDING, INSTALLING, AND MAINTAINING ALL TEMPORARY SUPPORT AND BRACING REQUIRED TO COMPLETE THE WORK.
- THE CONTRACTOR SHALL BE RESPONSIBLE FOR VERIFYING ALL EXISTING CONDITIONS, DIMENSIONS, CONSTRUCTION ASSEMBLIES AND THE LIKE PRIOR TO FABRICATING, INSTALLING, OR PURCHASING ANY NEW WORK. DETAILS INDICATING EXISTING MATERIALS OF CONDITIONS MAY BE SHOWN WITHIN THE DOCUMENTS BUT ARE NOT INTENDED TO FULLY DEFINE **EXISTING CONDITIONS.**
- DEMOLITION WORK MAY BE INDICATED THROUGHOUT THE CONTRACT DOCUMENTS. IT IS THE RESPONSIBILITY OF THE CONTRACTOR TO REVIEW ALL DOCUMENTS FOR ADDITIONAL DEMOLITION WORK.
- IT IS THE CONTRACTORS RESPONSIBILITY TO MAINTAIN SAFE WORKING CONDITIONS THROUGHOUT THE CONSTRUCTION SITE. THE CONTRACTOR SHALL PROVIDE TEMPORARY BARRIERS AS REQUIRED TO PROTECT PERSONS AND PROPERTY AND OTHERWISE MAINTAIN SAFE WORKING CONDITIONS.
- 6 THE CONTRACTOR SHALL MAINTAIN A CLEAR, CLEAN, USEABLE CONSTRUCTION SITE THROUGH DAILY CLEANUP OF WORK
- THE OWNER SHALL BE MAINTAINING OCCUPANCY OF THE SITE AND PORTIONS OF THE BUILDING DURING THE CONSTRUCTION PROCESS. THE CONTRACTOR SHALL COORDINATE WITH THE OWNER AND THE OWNER'S PERSONNEL THROUGHOUT THE CONSTRUCTION TO MINIMIZE, TO THE GREATEST EXTENT POSSIBLE, ANY DISRUPTIONS IN THE OWNER'S WORKING PROCEDURES. THE PHASING OF THE PROJECT SHALL BE DETERMINED BY MWS, BCPM AND AGENCY. ADDITIONALLY, THE CONTRACTOR SHALL COORDINATE WITH THE OWNER A MINIMUM OF 72 HOURS PRIOR TO ANY DISRUPTION OF SERVICES/UTILITIES REQUIRED TO COMPLETE THE WORK.
- THE CONTRACTOR SHALL PROVIDE TEMPORARY DUST AND DEBRIS BARRIERS BETWEEN AREAS TO REMAIN IN OPERATION AND WORK AREAS. BARRIERS SHALL BE PROVIDED AT, BUT NOT LIMITED TO, HVAC SUPPLY AND RETURN OPENINGS, TRANSFER VENTS, EXHAUST VENTS, AND OTHER SUCH OPENINGS. BARRIERS SHALL BE A MINIMUM OF 10 MIL PLASTIC SHEETING SECURED AND SEALED TO EXISTING CONSTRUCTION AND/OR TEMPORARY FRAMING. PLASTIC SHEETING SHALL BE OVERLAPPED A MINIMUM OF 12" AND TAPED BOTH SIDES.
- 9 THE CONTRACTOR SHALL PROVIDE PROTECTION FROM THE WEATHER FOR PORTIONS OF EXISTING CONSTRUCTION THAT ARE
- CONTRACTOR SHALL REVIEW WITH THE OWNER IF ANY ITEMS TO BE REMOVED AND/OR DEMOLISHED ARE TO BE RETAINED BY THE OWNER PRIOR TO ANY DEMOLITION WORK BEING PERFORMED. ALL ITEMS TO BE RETAINED BY THE OWNER SHALL BE REMOVED BY THE CONTRACTOR AND DELIVERED TO THE OWNER IN THE CONDITION FOUND PRIOR TO ANY WORK BEING PERFORMED. ALL OTHER ITEMS INDICATED TO BE REMOVED AND/OR DEMOLISHED SHALL BE DISPOSED OF OFF SITE BY THE CONTRACTOR IN A LAWFUL MANNER.
- 11 THE CONTRACTOR SHALL REPLACE OR REPAIR ANY ITEMS DAMAGED BY THE CONTRACTOR OR ANY OF ITS AGENTS TO A MINIMUM CONDITION MATCHING THE ITEMS' CONDITION AT THE START OF CONSTRUCTION AT NO ADDITIONAL COST TO THE
- 12 THE CONTRACTOR SHALL REPAIR ANY MATERIALS, SYSTEMS, OR FINISHES WITHIN OR OUTSIDE OF THE GENERAL WORK AREA THAT ARE REQUIRED TO BE DISTURBED TO COMPLETE THE ENTIRE SCOPE OF WORK ASSOCIATED WITH BUILDING SYSTEM
- 13 THE CONTRACTOR SHALL PREPARE ALL SURFACES AFFECTED BY DEMOLITION OPERATIONS TO RECEIVE NEW WORK AS BOTH INDICATED WITHIN THESE DRAWINGS AND SPECIFICATIONS/PROJECT MANUAL AND AS RECOMMENDED BY THE MANUFACTURERS' WRITTEN INSTRUCTIONS FOR THE INSTALLATION OF EACH RESPECTIVE PRODUCT
- 14 THE CONTRACTOR SHALL REMOVE EXISTING FINISHES AS INDICATED THROUGHOUT THE CONTRACT DOCUMENTS AND ENSURE THAT SUBSTRATE CONDITIONS ARE SMOOTH AND IN SATISFACTORY CONDITION TO RECEIVE NEW WORK.
- 15 THE CONTRACTOR SHALL REMOVE ALL ANCHORS, FASTENERS, WALL HANGERS, AND MISCELLANEOUS EXTRUSIONS AND APPURTENANCES OF ITEMS BOTH NO LONGER INSTALLED AND ITEMS REMOVED THROUGH DEMOLITION PROCEDURES. PATCH 16 THE CONTRACTOR SHALL COORDINATE ANY SAW CUTS WITHIN THE EXISTING SLABS WITHIN THE NEW WORK AREA AS
- REQUIRED TO INSTALL NEW ELECTRICAL CONDUIT, PLUMBING, AND/OR STRUCTURAL ELEMENTS. CONTRACTOR SHALL COORDINATE SIZE, LOCATION, AND DEPTH WITH THE FULL SET OF DOCUMENTS. REPLACE AND REPAIR CONCRETE AND FLASH AS REQUIRED TO CREATE A FLUSH SUBSTRATE AFTER COMPLETION OF WORK TASKS. CONTRACTOR TO LOCATE ANY IN-SLAB SERVICES. IF DAMAGED DURING DEMOLITION, CONTRACTOR TO REPLACE AT THEIR EXPENSE.

### **REFERENCED NOTES - ROOF DEMOLITION**

- CONTRACTOR TO DISSCONNECT AND REMOVE EXISTING ROOF TOP UNIT, EQUIPMENT CURB AND ALL ASSOCIATED APPURTENANCES IN THEIR ENTIRETY. PREPARE OPENING TO RECEIVE NEW WORK.
- CONTRACTOR TO DISSCONNECT AND REMOVE EXISTING ROOF TOP EXHAUST FAN, EQUIPMENT CURB AND ALL ASSOCIATED APPURTENANCES IN THEIR ENTIRETY, PREPARE OPENING TO RECEIVE NEW WORK

DEMOLISHED (SEE DEMO PLANS) NEW WALL/PARTITION **NEW DOOR EXISTING DOOR** LOW ROOF 12' - 3" ROOMS SHADED GRAY ARE NOT WITHIN THE SCOPE OF WORK, UNLESS EXISTING ROOF AND STRUCTURE OTHERWISE NOTED TO REMAIN, TYP. EXISTING PLANTER, TYP.

FIRST FLOOR

SUBDIVISION: FULLERTON

EXISTING EXTERIOR RETAINING WALL & FLOOR SLAB TO REMAIN, TYP.

0 **REFERENCED NOTES - DEMOLITION** DEMOLISH EXTERIOR WALL AS REQUIRED TO MAKE WAY FOR NEW WORK. DEMOLITION INCLUDES BUT IS NOT LIMITED TO ALL. ASSOCIATED WINDOW OPENINGS. SEE OTHER NOTES AND DRAWINGS FOR ADDITIONAL INFORMATION. REMOVE EXISTING INTERIOR WALL AND ALL ASSOCIATED APPURTENANCES IN THEIR ENTIRETY.

REMOVE EXISTING DOOR, FRAME AND HARDWARE. 4 REMOVE EXISTING FLOOR FINISHES, ASSOCIATED FASTENERS AND ADHESIVES. PATCH & GRIND SMOOTH EXISTING CONCRETE

SLAB UNDERLAYMENT. REMOVE EXISTING TOILET PARTITIONS

6 LOCKERS, BENCHES AND OTHER ITEMS SHALL BE REMOVED WITH CARE AND STORED IN A LOCATION ON PROJECT SITE DESIGNATED BY THE OWNER.

REMOVE EXISTING SINKS, TOILETS, URINALS, SHOWER HEADS AND ALL ASSOCIATED APPURTENANCES. SEE MEP DRAWINGS FOR ADDITIONAL INFORMATION

8 REMOVE EXISTING FINISHED CEILING AND ALL ASSOCIATED APPURTENANCES. SEE MEP DEMO PLANS FOR ADDITIONAL

INFORMATION REGARDING REMOVAL OF LIGHTS, HVAC REGISTERS, A/V AND ALERTING EQUIPMENT. 9 REMOVE EXISTING PLANTER BED SOLDIER COURSE

10 EXISTING SOFFIT, FASCIA & ASSOCIATED ROOF EDGE BLOCKING TO BE REMOVED AND PREPARED FOR NEW WORK.

11 REMOVE EXISTING CEILING FANS WITH CARE AND STORE IN A LOCATION ON PROJECT SITE DESIGNATED BY THE OWNER. 12 SAWCUT PORTIONS OF EXISTING WALL TO ACCOMMODATE NEW OPENINGS. COORDINATE ROUGH OPENING REQUIREMENTS

WITH BOTH MANUFACTURERS OF PRODUCT TO BE USED AND NEW WORK INDICATED WITHIN CONTRACT DOCUMENTS. 13 SAW CUT PORTION OF CONCRETE SLAB TO ACCOMMODATE REMOVAL OF EXISTING FLOOR DRAINS AND REMEDIATE SLOPED

PORTION OF FLOOR SLAB. CONTRACTOR SHALL PREPARE SURFACE FOR NEW WORK. 14 DISCONNECT AND REMOVE BASEBOARD HEATER(S). SEE MEP DRAWINGS FOR ADDITIONAL INFORMATION.

15 REMOVE LAYER OF ORGANIC SOIL AS REQUIRED TO BACKFILL STONE FILL BASE FOR NEW SLAB.

16 TEMPORARILY REMOVE CEILING FOR ASSOCIATED MEP WORK WITHIN THIS AREA. UPON COMPLETION OF WORK EXISTING

CEILING TO BE REINSTALLED. 17 SAW CUT PORTIONS OF EXISTING SLAB AS REQUIRED TO ACCOMODATE NEW WORK.

18 EXISTING BRICK RETAINING WALL, CONCRETE PATIO AND STAIR TO BE DEMOLISHED.

19 PROTECT EXISTING CONDUITS AS REQUIRED DURING DURATION OF CONSTRUCTION.

**DEMOLITION WALL SECTION** 

EXISTING RETAINING WALL TO REMAIN.

BY DATE P.W.A. NO. KEY SHEET POSITION SHT DRAWING SCALE PROFESSIONAL CERTIFICATION AS-BUILT / REVISION HEREBY CERTIFY THAT THESE DOCUMENTS WERE PREPARED OR APPROVED BY: "Mihai T. Petrisor BID/PERMIT PLAN SCALE: APPROVED BY ME, AND THAT I AM A DULY LICENSED PROFESSIONAL ARCHITECT UNDER THE LAWS OF THE STATE OF R.O.W NO. 10/03/2024 MARYLAND. PROFILE SCALE: EXPIRATION DATE: 08-18-2026 LICENSE NO. 15505 BUREAU OF ENGINEERING HIGHWAYS STRUCTURES STORM DRAINS SEWER WATER FIELD ENGINEER PROPERTY MANAGEMENT VID WOODWARD, AIA REVIEWED BY: DWN BY: APPROVED BY: ANNS WOODWARD STUDIOS 10839-D PHILADELPHIA ROAD WHITE MARSH, MARYLAND 21162 DATE REVIEWED:

EX.

TURNOUT

GEAR

EX.

HOSE

TOWER

EX. SHOP

CHIEF'S OFFICE

EX. LINEN

CLOSET

EX.

CAPTAIN'S

OFFICE

**DEMOLITION CEILING PLAN** 

<u>DATE</u>: 09/20/24

EX. MEN'S

LOCKER

CHKD BY:

BALTIMORE COUNTY OFFICE OF BUDGET AND FINANCE, PROPERTY MANAGEMENT

FULLERTON FIRE STATION #8 - RENOVATION & ADDITION

DEMOLITION PLANS

4401 FITCH AVENUE, NOTTINGHAM, MARYLAND, 21236

AD101


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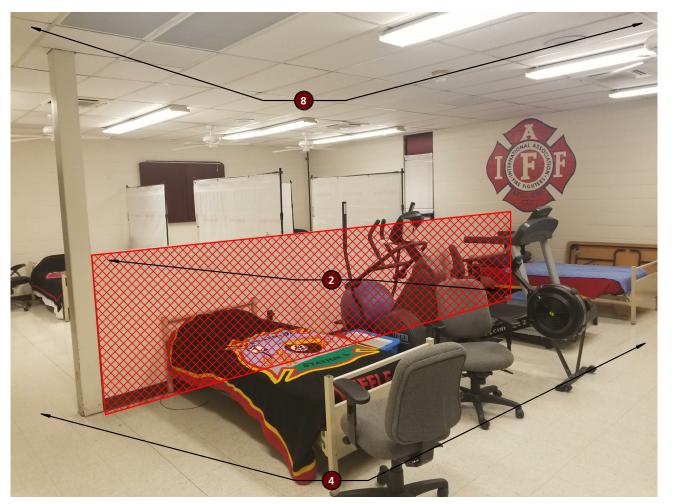
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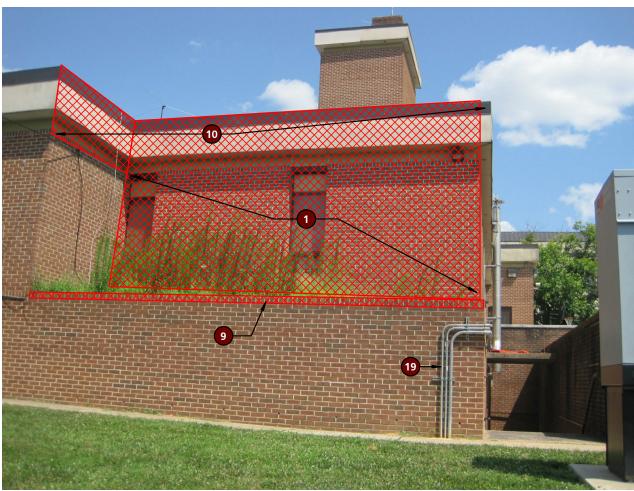
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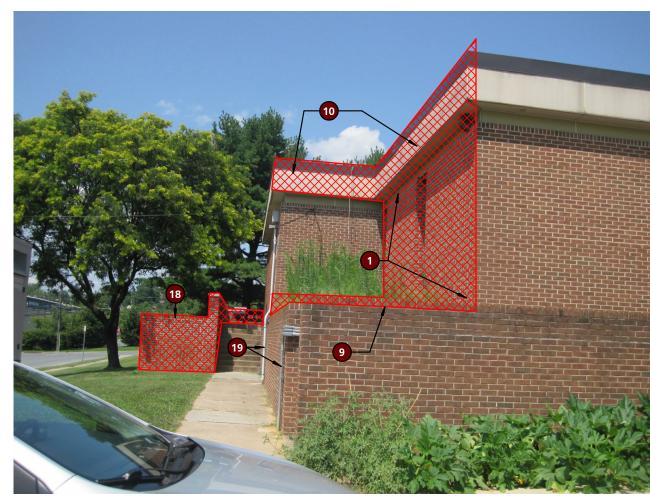
241-220-0054-0012 SHEET 13 of 58 DRAWING NUMBER 2022-2332 FILE NO.: 8


22221 PFO







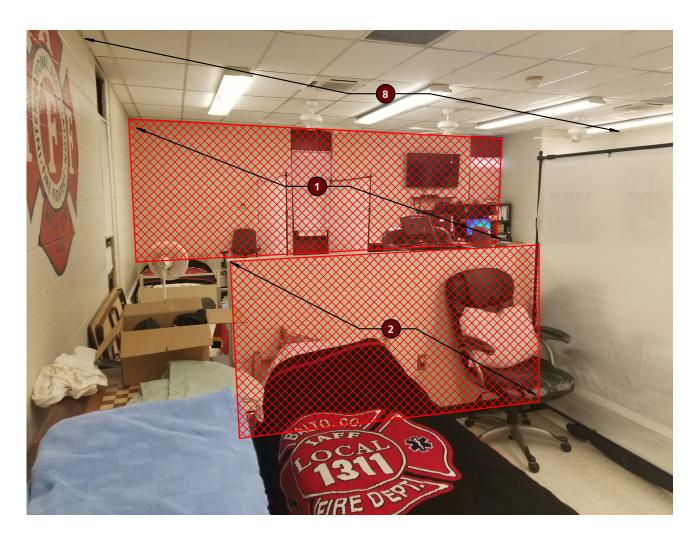

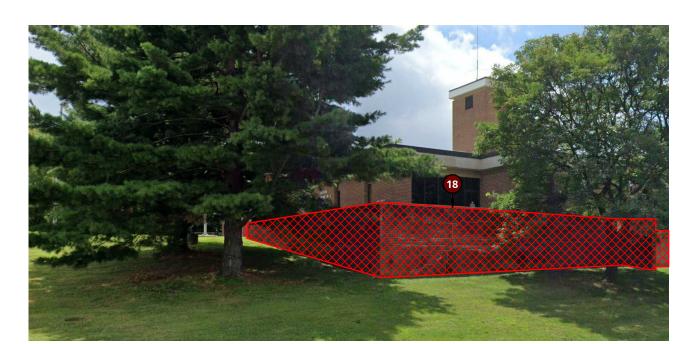

**AREA OF DEMO WORK** 

	PROFESSIONAL CERTIFIC	CATION	AS-BUILT / REV	/ISION	BY	DATE	P.W.A. NO.	KEY SHEET	POSITION SHT	DRAWIN	G SCALE		
10/0 = 304 - 30	I HEREBY CERTIFY THAT THESE DOCUMENTS APPROVED BY ME, AND THAT I AM A DULY LIC		BID/PERM	ИТ		09/20/24	-	MSW	27NE21	PLAN SCALE:	3/8" = 1'-0"	APPROVED BY: Mihai T. Petrisor	
	PROFESSIONAL ARCHITECT UNDER THE LAWS						R.O.W NO.	-	-			DIRECTOR	
TAR AND	MARYLAND. LICENSE NO. 15505 EXPIRATION DA	ATE: 08-18-2026					-	-	-	PROFILE SCALE:	-	DATE: 10/03/2024	
	ARCHITECT:	DGN BY:	BUREAU OF ENGINEERING AND CONSTRUCTION		HIGH	WAYS	STRUCTURES	STORM DRAINS	SEWER	WATER	FIELD ENGINEER	PROPERTY MANAGEMENT	
A.75503.63	PRINCIPAL ARCHITECT  MANNS WOODWARD STUDIOS 10839-D PHILADELPHIA ROAD	DWN BY:	REVIEWED BY:									APPROVED BY:CHIEF	
9/20/24	WHITE MARSH, MARYLAND 21162 (P) 410-344-1460	CHKD BY:	DATE REVIEWED:									DATE:	1

BALTIMORE COUNTY OFFICE OF BUDGET AND FINANCE, PROPERTY MANAGEMENT

FULLERTON FIRE STATION #8 - RENOVATION & ADDITION

SUBDIVISION: FULLERTON

DEMOLITION - AREA OF WORK

4401 FITCH AVENUE, NOTTINGHAM, MARYLAND, 21236

AD102

FILE NO.: 8

SHEET DESIGNATION | CONTRACT NUMBER

ELECTION DIST. NO.: 14C5

TO REMAIN OCCUPIED OR USEABLE BY THE OWNER OR TO AREAS THAT CONTAIN ITEMS TO REMAIN THAT WILL BE DAMAGED 10 ALL ITEMS INDICATED TO BE REMOVED AND/OR DEMOLISHED SHALL REMAIN THE PROPERTY OF THE OWNER. THE CONTRACTOR SHALL REVIEW WITH THE OWNER IF ANY ITEMS TO BE REMOVED AND/OR DEMOLISHED ARE TO BE RETAINED BY THE OWNER PRIOR TO ANY DEMOLITION WORK BEING PERFORMED. ALL ITEMS TO BE RETAINED BY THE OWNER SHALL BE REMOVED BY THE CONTRACTOR AND DELIVERED TO THE OWNER IN THE CONDITION FOUND PRIOR TO ANY WORK BEING PERFORMED. ALL OTHER ITEMS INDICATED TO BE REMOVED AND/OR DEMOLISHED SHALL BE DISPOSED OF OFF SITE BY THE CONTRACTOR IN A LAWFUL MANNER. 11 THE CONTRACTOR SHALL REPLACE OR REPAIR ANY ITEMS DAMAGED BY THE CONTRACTOR OR ANY OF ITS AGENTS TO A MINIMUM CONDITION MATCHING THE ITEMS' CONDITION AT THE START OF CONSTRUCTION AT NO ADDITIONAL COST TO THE 12 THE CONTRACTOR SHALL REPAIR ANY MATERIALS, SYSTEMS, OR FINISHES WITHIN OR OUTSIDE OF THE GENERAL WORK AREA THAT ARE REQUIRED TO BE DISTURBED TO COMPLETE THE ENTIRE SCOPE OF WORK ASSOCIATED WITH BUILDING SYSTEM CONNECTIVITY. 13 THE CONTRACTOR SHALL PREPARE ALL SURFACES AFFECTED BY DEMOLITION OPERATIONS TO RECEIVE NEW WORK AS BOTH INDICATED WITHIN THESE DRAWINGS AND SPECIFICATIONS/PROJECT MANUAL AND AS RECOMMENDED BY THE MANUFACTURERS' WRITTEN INSTRUCTIONS FOR THE INSTALLATION OF EACH RESPECTIVE PRODUCT. 14 THE CONTRACTOR SHALL REMOVE EXISTING FINISHES AS INDICATED THROUGHOUT THE CONTRACT DOCUMENTS AND ENSURE THAT SUBSTRATE CONDITIONS ARE SMOOTH AND IN SATISFACTORY CONDITION TO RECEIVE NEW WORK. 15 THE CONTRACTOR SHALL REMOVE ALL ANCHORS, FASTENERS, WALL HANGERS, AND MISCELLANEOUS EXTRUSIONS AND APPURTENANCES OF ITEMS BOTH NO LONGER INSTALLED AND ITEMS REMOVED THROUGH DEMOLITION PROCEDURES. PATCH AND PAINT ALL SURFACES TOUCHED, CORNER TO CORNER, TOP TO BOTTOM AND WITH SQUARE AND STRAIGHT LINES. 16 THE CONTRACTOR SHALL COORDINATE ANY SAW CUTS WITHIN THE EXISTING SLABS WITHIN THE NEW WORK AREA AS REQUIRED TO INSTALL NEW ELECTRICAL CONDUIT, PLUMBING, AND/OR STRUCTURAL ELEMENTS. CONTRACTOR SHALL COORDINATE SIZE, LOCATION, AND DEPTH WITH THE FULL SET OF DOCUMENTS. REPLACE AND REPAIR CONCRETE AND FLASH AS REQUIRED TO CREATE A FLUSH SUBSTRATE AFTER COMPLETION OF WORK TASKS. CONTRACTOR TO LOCATE ANY IN-SLAB SERVICES. IF DAMAGED DURING DEMOLITION, CONTRACTOR TO REPLACE AT THEIR EXPENSE **REFERENCED NOTES - DEMOLITION** 1 DEMOLISH EXTERIOR WALL AS REQUIRED TO MAKE WAY FOR NEW WORK. DEMOLITION INCLUDES BUT IS NOT LIMITED TO ALL. ASSOCIATED WINDOW OPENINGS. SEE OTHER NOTES AND DRAWINGS FOR ADDITIONAL INFORMATION. REMOVE EXISTING INTERIOR WALL AND ALL ASSOCIATED APPURTENANCES IN THEIR ENTIRETY. REMOVE EXISTING DOOR, FRAME AND HARDWARE. 4 REMOVE EXISTING FLOOR FINISHES, ASSOCIATED FASTENERS AND ADHESIVES. PATCH & GRIND SMOOTH EXISTING CONCRETE SLAB UNDERLAYMENT. 5 REMOVE EXISTING TOILET PARTITIONS. 6 LOCKERS, BENCHES AND OTHER ITEMS SHALL BE REMOVED WITH CARE AND STORED IN A LOCATION ON PROJECT SITE DESIGNATED BY THE OWNER. 7 REMOVE EXISTING SINKS, TOILETS, URINALS, SHOWER HEADS AND ALL ASSOCIATED APPURTENANCES. SEE MEP DRAWINGS FOR ADDITIONAL INFORMATION 8 REMOVE EXISTING FINISHED CEILING AND ALL ASSOCIATED APPURTENANCES. SEE MEP DEMO PLANS FOR ADDITIONAL INFORMATION REGARDING REMOVAL OF LIGHTS, HVAC REGISTERS, A/V AND ALERTING EQUIPMENT. 9 REMOVE EXISTING PLANTER BED SOLDIER COURSE

10 EXISTING SOFFIT, FASCIA & ASSOCIATED ROOF EDGE BLOCKING TO BE REMOVED AND PREPARED FOR NEW WORK. 11 REMOVE EXISTING CEILING FANS WITH CARE AND STORE IN A LOCATION ON PROJECT SITE DESIGNATED BY THE OWNER. 12 SAWCUT PORTIONS OF EXISTING WALL TO ACCOMMODATE NEW OPENINGS. COORDINATE ROUGH OPENING REQUIREMENTS WITH BOTH MANUFACTURERS OF PRODUCT TO BE USED AND NEW WORK INDICATED WITHIN CONTRACT DOCUMENTS. 13 SAW CUT PORTION OF CONCRETE SLAB TO ACCOMMODATE REMOVAL OF EXISTING FLOOR DRAINS AND REMEDIATE SLOPED

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14 DISCONNECT AND REMOVE BASEBOARD HEATER(S). SEE MEP DRAWINGS FOR ADDITIONAL INFORMATION.

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17 SAW CUT PORTIONS OF EXISTING SLAB AS REQUIRED TO ACCOMODATE NEW WORK. 18 EXISTING BRICK RETAINING WALL, CONCRETE PATIO AND STAIR TO BE DEMOLISHED. 19 PROTECT EXISTING CONDUITS AS REQUIRED DURING DURATION OF CONSTRUCTION.

CEILING TO BE REINSTALLED.

15 REMOVE LAYER OF ORGANIC SOIL AS REQUIRED TO BACKFILL STONE FILL BASE FOR NEW SLAB.

**GENERAL DEMOLITION NOTES** 

1 ALL BIDDERS SHALL MAKE THEMSELVES FAMILIAR WITH THE EXISTING PROJECT CONDITIONS PRIOR TO SUBMITTING A BID. THIS

THE CONTRACTOR SHALL BE RESPONSIBLE FOR VERIFYING ALL EXISTING CONDITIONS, DIMENSIONS, CONSTRUCTION ASSEMBLIES AND THE LIKE PRIOR TO FABRICATING, INSTALLING, OR PURCHASING ANY NEW WORK. DETAILS INDICATING EXISTING MATERIALS OF CONDITIONS MAY BE SHOWN WITHIN THE DOCUMENTS BUT ARE NOT INTENDED TO FULLY DEFINE

4 DEMOLITION WORK MAY BE INDICATED THROUGHOUT THE CONTRACT DOCUMENTS. IT IS THE RESPONSIBILITY OF THE

5 IT IS THE CONTRACTORS RESPONSIBILITY TO MAINTAIN SAFE WORKING CONDITIONS THROUGHOUT THE CONSTRUCTION SITE. THE CONTRACTOR SHALL PROVIDE TEMPORARY BARRIERS AS REQUIRED TO PROTECT PERSONS AND PROPERTY AND

6 THE CONTRACTOR SHALL MAINTAIN A CLEAR, CLEAN, USEABLE CONSTRUCTION SITE THROUGH DAILY CLEANUP OF WORK

CONTRACTOR SHALL COORDINATE WITH THE OWNER A MINIMUM OF 72 HOURS PRIOR TO ANY DISRUPTION OF

THE OWNER SHALL BE MAINTAINING OCCUPANCY OF THE SITE AND PORTIONS OF THE BUILDING DURING THE CONSTRUCTION PROCESS. THE CONTRACTOR SHALL COORDINATE WITH THE OWNER AND THE OWNER'S PERSONNEL THROUGHOUT THE CONSTRUCTION TO MINIMIZE, TO THE GREATEST EXTENT POSSIBLE, ANY DISRUPTIONS IN THE OWNER'S WORKING PROCEDURES. THE PHASING OF THE PROJECT SHALL BE DETERMINED BY MWS, BCPM AND AGENCY. ADDITIONALLY, THE

THE CONTRACTOR SHALL PROVIDE TEMPORARY DUST AND DEBRIS BARRIERS BETWEEN AREAS TO REMAIN IN OPERATION AND WORK AREAS. BARRIERS SHALL BE PROVIDED AT, BUT NOT LIMITED TO, HVAC SUPPLY AND RETURN OPENINGS, TRANSFER VENTS, EXHAUST VENTS, AND OTHER SUCH OPENINGS. BARRIERS SHALL BE A MINIMUM OF 10 MIL PLASTIC SHEETING SECURED AND SEALED TO EXISTING CONSTRUCTION AND/OR TEMPORARY FRAMING. PLASTIC SHEETING SHALL BE OVERLAPPED A

9 THE CONTRACTOR SHALL PROVIDE PROTECTION FROM THE WEATHER FOR PORTIONS OF EXISTING CONSTRUCTION THAT ARE

PRIOR TO THE PERFORMANCE OF ANY DEMOLITION WORK THE CONTRACTOR SHALL MAKE THEMSELVES FAMILIAR WITH THE EXISTING CONDITIONS OF THE PROJECT. THE CONTRACTOR SHALL BE RESPONSIBLE FOR DESIGNING, PROVIDING, INSTALLING,

IS INCLUSIVE OF CONDITIONS ABOVE ACCESSIBLE CEILINGS TO DETERMINE WORKING CONDITIONS.

AND MAINTAINING ALL TEMPORARY SUPPORT AND BRACING REQUIRED TO COMPLETE THE WORK.


CONTRACTOR TO REVIEW ALL DOCUMENTS FOR ADDITIONAL DEMOLITION WORK.

OTHERWISE MAINTAIN SAFE WORKING CONDITIONS.

SERVICES/UTILITIES REQUIRED TO COMPLETE THE WORK.


MINIMUM OF 12" AND TAPED BOTH SIDES.


EXISTING CONDITIONS.

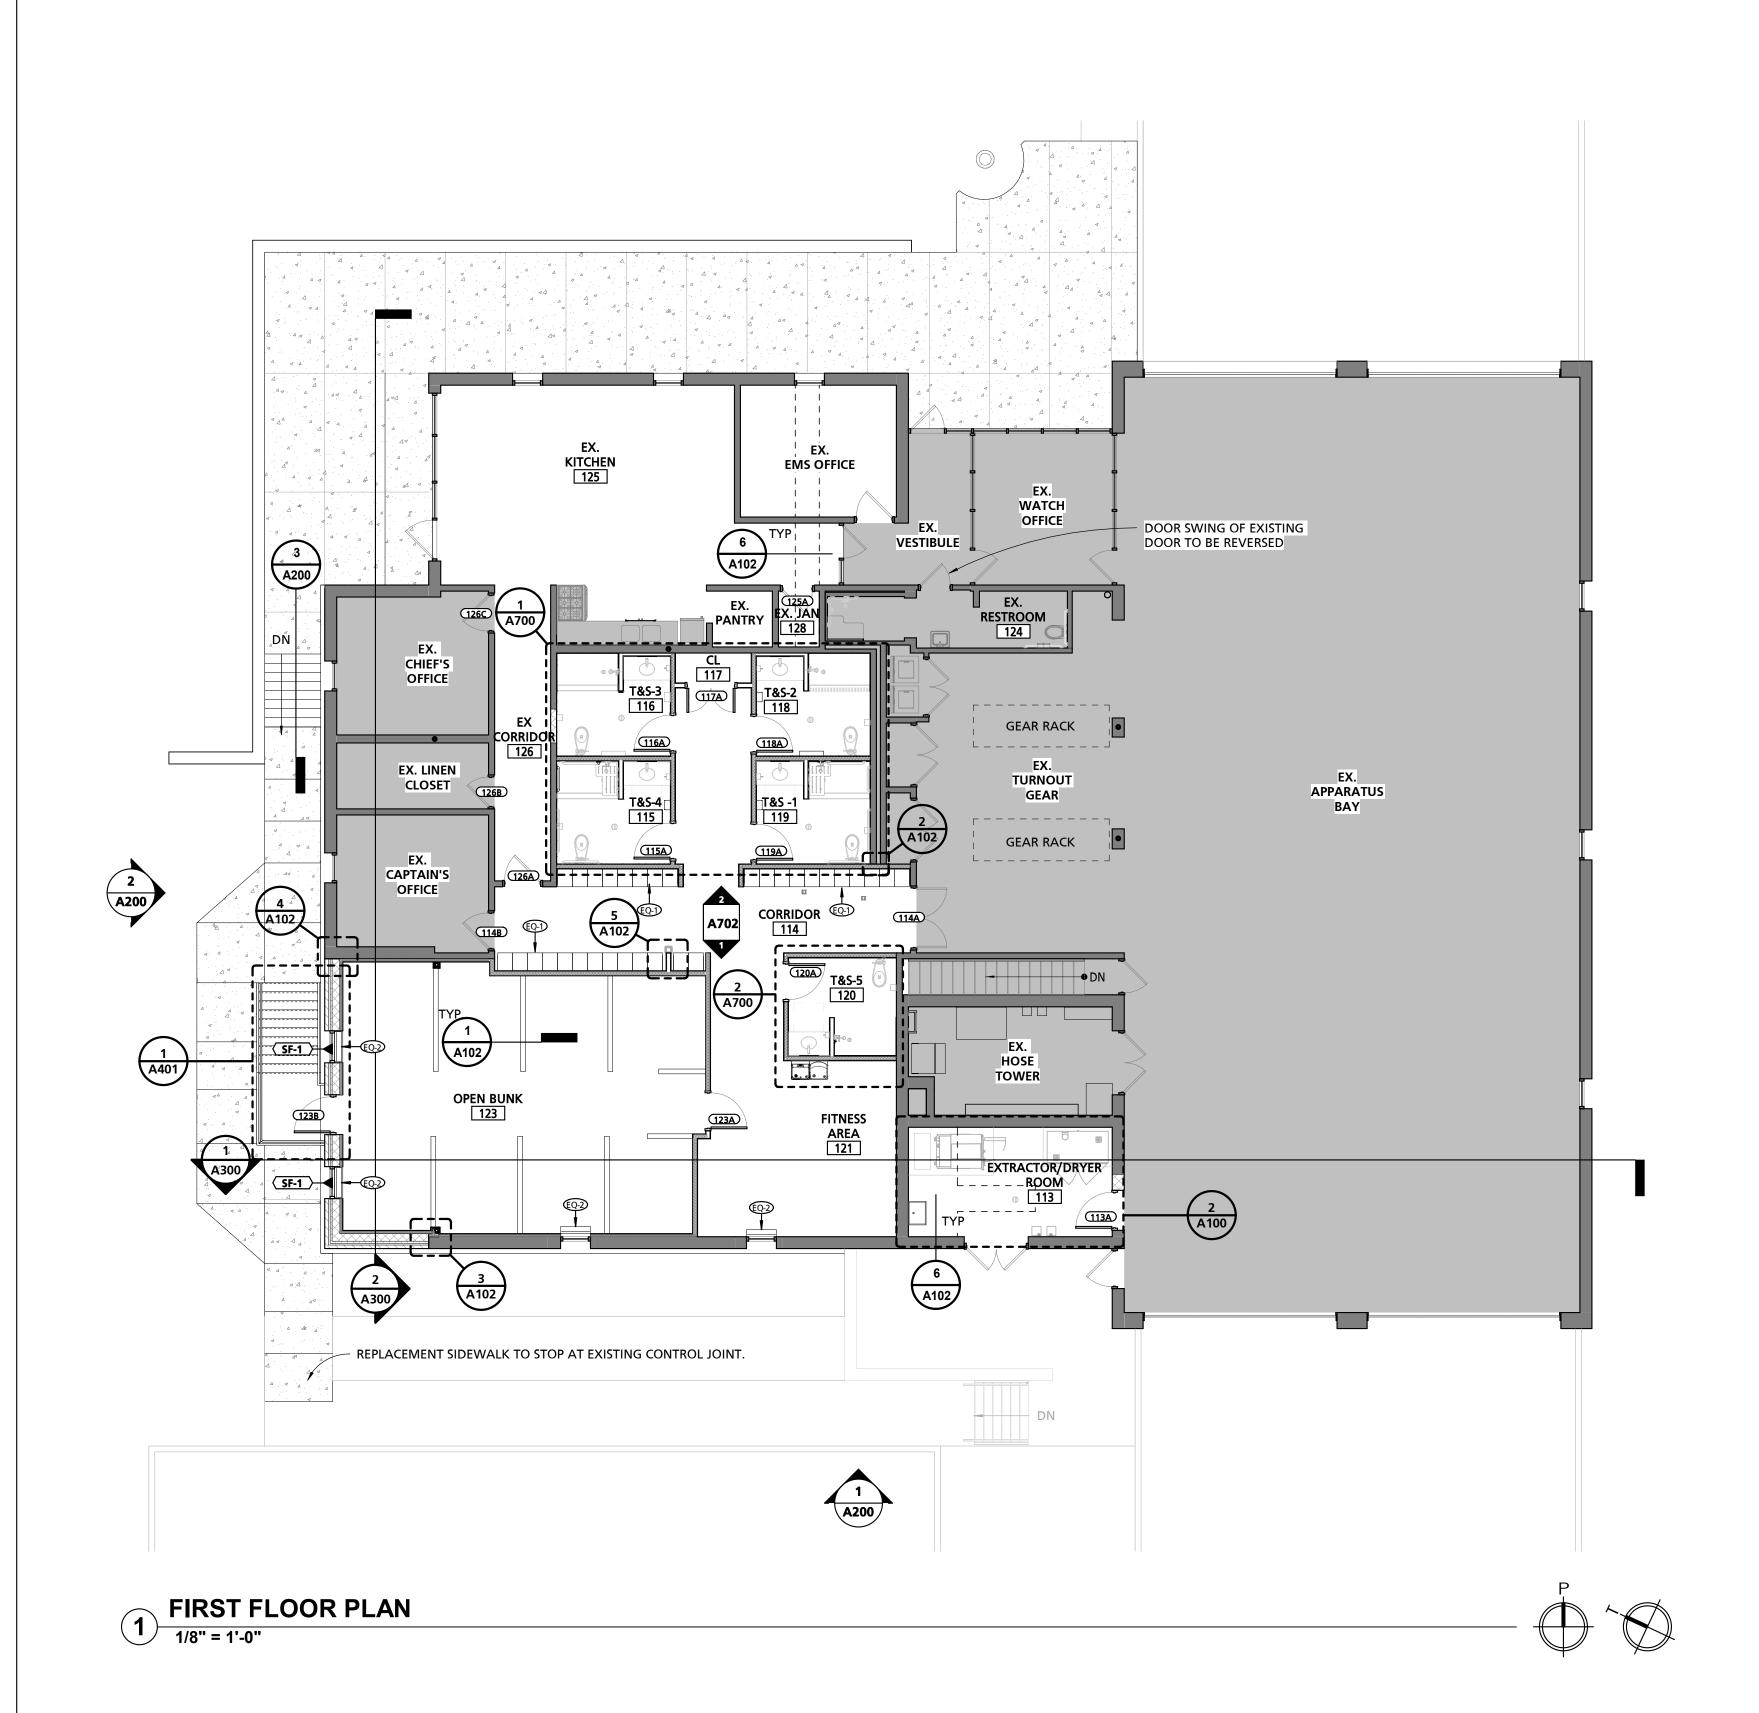

**SCHEDULE - EQUIPMENT BOD MANUFACTURER BOD MODEL** O.P.O.I. O.P.C.I. C.P.C.I. DESCRIPTION EQ-1 15"W x 18"D x 72"H TWO-TIER SOLID PLASTIC LOCKER BRADLEY CORPORATION LENOX "Z" LOCKER PROVIDED WITH SLOPED TOP EQ-2 MANUAL ROLLER SHADE HUNTER DOUGLAS RB-500 ROLLER SHADES PROVIDE BLACK-OUT BLINDS

> SCHEDULE ABBREVIATIONS:
> O.P.O.I. - OWNER PROVIDED; OWNER INSTALLED O.P.C.I. - OWNER PROVIDED; CONTRACTOR INSTALLED C.P.C.I. - CONTRACTOR PROVIDED; CONTRACTOR INSTALLED

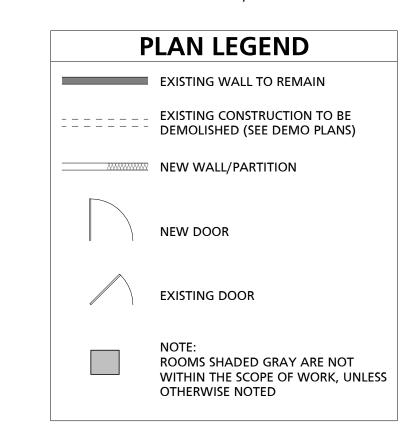

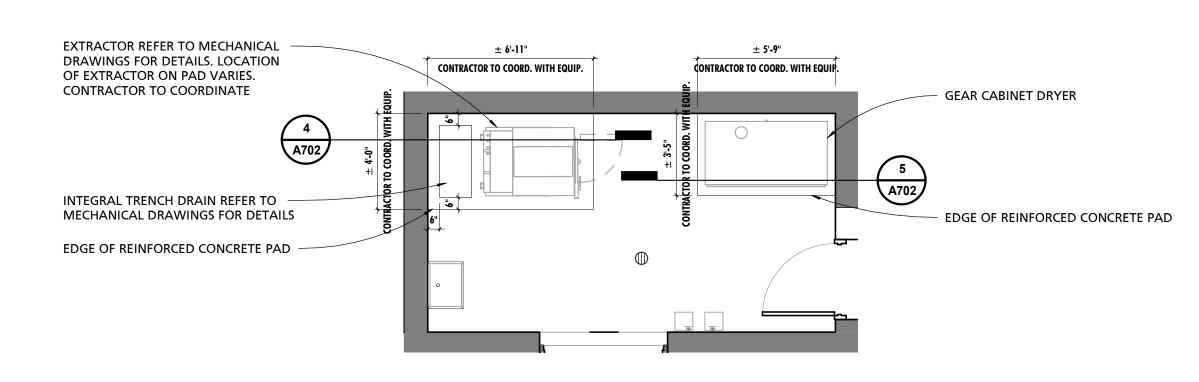

# 2 ENLARGED EXTRACTOR/DRYER ROOM PLAN 1/4" = 1'-0"

SEAL		PROFESSIONAL CERTIFI	AS-BUILT / REV	ISION	BY	DATE	P.W.A. NO.	KEY SHEET	POSITION SHT	DRAWIN	IG SCALE			
	A WOOD WAR	I HEREBY CERTIFY THAT THESE DOCUMENTS WERE PREPARED OR APPROVED BY ME, AND THAT I AM A DULY LICENSED		BID/PERM	IIT		09/20/24	-	MSW	27NE21	PLAN SCALE:	As indicated	APPROVED BY: Mihai T. Petrisor	
		PROFESSIONAL ARCHITECT UNDER THE LAWS						R.O.W NO.	-	-			DIREC	TOL
		MARYLAND. LICENSE NO. 15505 EXPIRATION D	ATE: 08-18-2026					-	:	-	PROFILE SCALE:	-	DATE: 10/03/2024	
		ARCHITECT:  DAVID WOODWARD, AIA PRINCIPAL ARCHITECT  MANNS WOODWARD STUDIOS 10839-D PHILADELPHIA ROAD	DGN BY:	BUREAU OF ENGINEERING AND CONSTRUCTION		HIGH	IWAYS	STRUCTURES	S STORM DRAINS	SEWER	WATER	FIELD ENGINEER	PROPERTY MANAGEMENT	
10	AR 15505 CALLED		DWN BY:	REVIEWED BY:									APPROVED BY:	HIE
DAT	E: 09/20/24	WHITE MARSH, MARYLAND 21162 (P) 410-344-1460	CHKD BY:	DATE REVIEWED:									DATE:	TILE

BALTIMORE COUNTY OFFICE OF BUDGET AND FINANCE, PROPERTY MANAGEMENT FULLERTON FIRE STATION #8 - RENOVATION & ADDITION

REFERENCE PLAN


SUBDIVISION: FULLERTON

4401 FITCH AVENUE, NOTTINGHAM, MARYLAND, 21236

0	22221 PFO
	JOB ORDER NUMBER
	241-220-0054-0012
* *	SHEET 15 of 58
	DRAWING NUMBER
	2022-2334

SHEET DESIGNATION | CONTRACT NUMBER

FILE NO.: 8

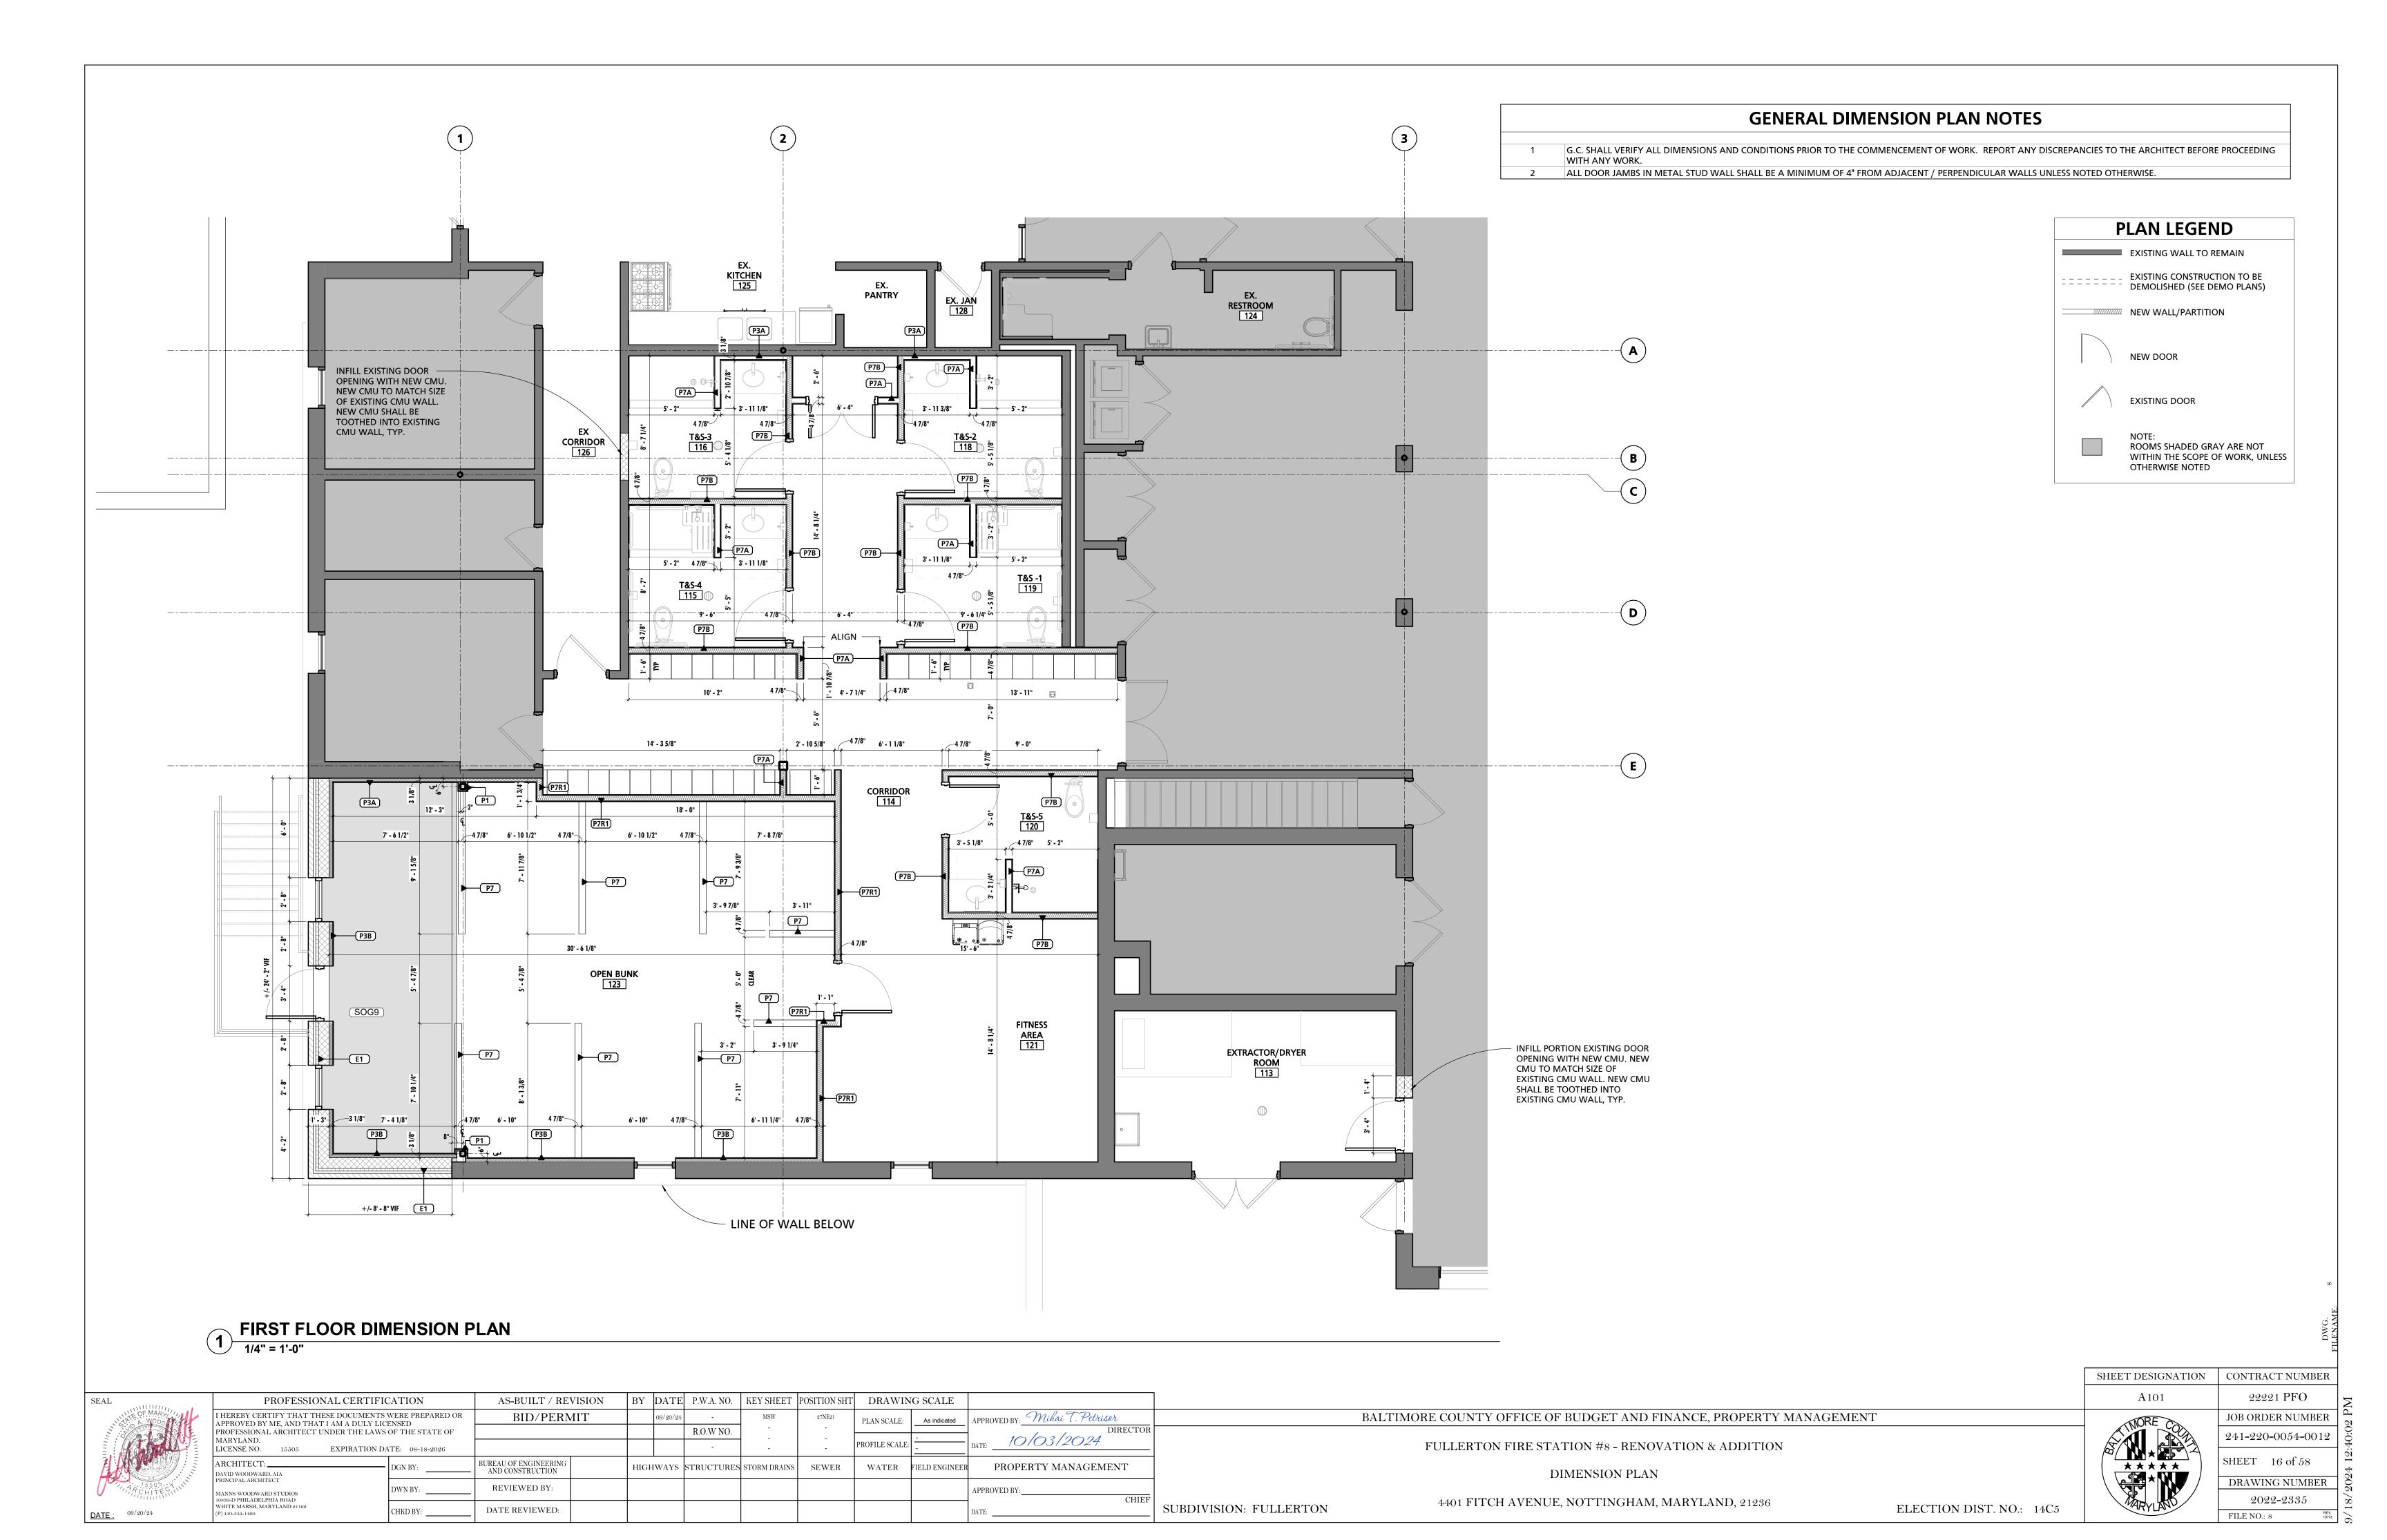

### **GENERAL PARTITION NOTES**

- OPEN BUNK 123, FITNESS AREA 121, AND CORRIDOR 114 TO RECEIVE IMPACT RESISTANT GYPSUM WALL BOARD, U.N.O
- PROVIDE FIBERGLASS REINFORCED MOISTURE RESISTANT GYPSUM WALL BOARD IN ALL EQUIPMENT ROOMS, JANITOR'S CLOSETS, RESTROOMS, KITCHENS AND OTHER WET AREAS. PROVIDE FIBERGLASS REINFORCED MOISTURE RESISTANT WALL BOARD IN ALL OTHER AREAS WITHIN 8'-0" OF WATER SOURCE.
- CONTRACTOR SHALL PROVIDE BLOCKING AND NAILERS AS REQUIRED TO SUPPORT ALL NEW WORK, INCLUDING ITEMS TO BE PROVIDED AND/OR INSTALLED BY OWNER. ALL CORRIDOR AND FIRE-RATED PARTITIONS SHALL BE EXTENDED TO THE UNDERSIDE OF THE DECK ABOVE, U.N.O. THE PERIMETER WALLS OF ANY SPACE NOT PROVIDED
- WITH A CEILING SHALL EXTEND TO THE UNDERSIDE OF DECK ABOVE. PROVIDE DEFLECTION TRACKS AT TOP OF ALL NON-LOAD BEARING STUD WALLS EXTENDING TO THE UNDERSIDE OF STRUCTURE ABOVE, U.N.O.
  - ALL FIRE WALLS SHALL BE PLACARDED OR STENCILED ON BOTH SIDES WITH THE PHRASE "FIRE WALL" PER IBC SECTION 703.7.1. THE LETTERS SHALL BE RED IN COLOR, 6"
- MOISTURE RESISTANT GYPSUM WALL BOARD SHALL BE UTILIZED IN ALL AREAS WHERE GYPSUM WALL BOARD IS TO BE DIRECTLY ADHERED TO CONCRETE OR MASONRY SURFACES IN INTERIOR APPLICATIONS. SUBSTRATE SHALL BE CLEANED AS REQUIRED AND FREE OF DUST, DEBRIS, AND MOISTURE PRIOR TO ADHESION AND FINISHING.
- CONSTRUCTION OF RATED WALL ASSEMBLIES SHALL BE STRICTLY ADHERED TO IN ACCORDANCE WITH UL AND/OR GYPSUM ASSEMBLY SPECIFICATIONS. REFER TO CODE PLANS FOR ADDITIONAL INFORMATION.
- 9 PROVIDE A BULLNOSE CMU AT ALL OUTSIDE CORNERS OF INTERIOR MASONRY WALLS & SILLS

### **SCHEDULE - INTERIOR PARTITION & WALL TYPE**


			FIRE R	ATING
MARK	WIDTH	DESCRIPTION	RATING	ASSEMBLY REF
P1	1 1/2"	7/8" METAL FURRING W/ 5/8" GWB		
P3A	3 1/8"	2 1/2" METAL STUD W/ 5/8" GWB ONE SIDE TO TO EXTEND 6" MIN ABOVE FINISH CEILING		
P3B	3 1/8"	2 1/2" METAL STUD W/ 5/8" GWB ONE SIDE TO EXTEND TO UNDERSIDE OF METAL DECK.		
P7	4 7/8"	3-5/8" METAL STUD W/ 5/8" GYPSUM WALL BOARD EACH SIDE TO EXTEND 48" ABOVE FINISH FLOOR		
P7A	4 7/8"	3-5/8" METAL STUD W/ 5/8" GYPSUM WALL BOARD EACH SIDE TO EXTEND 6" MIN ABOVE FINISH CEILING		
P7B	4 7/8"	3-5/8" METAL STUD W/ 5/8" GYPSUM WALL BOARD EACH SIDE TO EXTEND TO UNDERSIDE OF ROOF DECK		
P7R1	4 7/8"	3-5/8" METAL STUD W/ 5/8" TYPE X GWB EACH SIDE TO EXTEND TO UNDERSIDE OF ROOF DECK - 1 HR RATED	1	UL 419


### **SCHEDULE - EXTERIOR PARTITION & WALL TYPE**


			FIRE	RATING
MARK	WIDTH	DESCRIPTION	RATING	ASSEMBLY REF STC RATING
E1	15"	7 5/8" CMU WITH LIQUID APPLIED AIR BARRIER, 2" RIGID INSULATION, 1 3/4" AIR SPACE AND 3 5/8" BRICK VENEER		


	SCHEDULE - ROOFING TYPE	:S
MARK	DESCRIPTION	COMMENTS
RA1	(2) PLY SBS MODIFIED MEMBRANE OVER 1/2 COVER BOARD, MIN 5 1/2" SLOPED RIGID INSULATION AND 1 1/2" METAL DECK	
RA2	(2) PLY SBS MODIFIED MEMBRANE OVER 1/2 COVER BOARD, SLOPED RIGID INSULATION AND EXISTING ROOF TILE	MATCH EXISTING ROOF SLOPE AND THICKNESS

#### **SCHEDULE - FLOOR ASSEMBLY TYPES** COMMENTS 9" CONCRETE SLAB ON GRADE OVER VAPOR BARRIER, 2" RIGID INSULATION

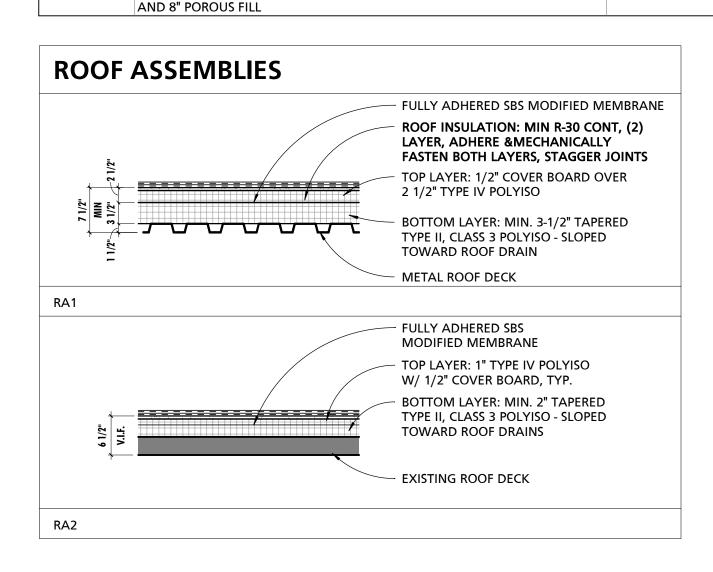


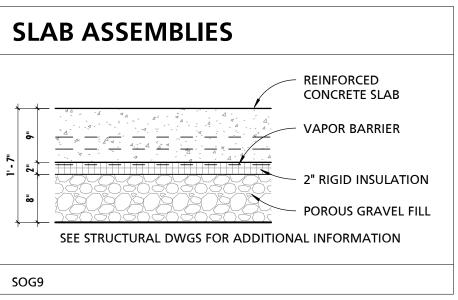


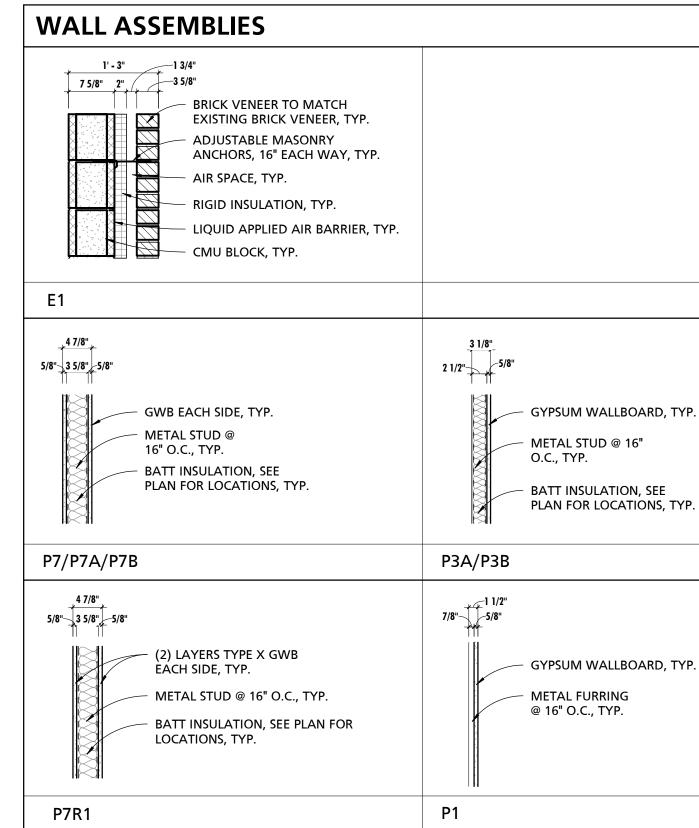


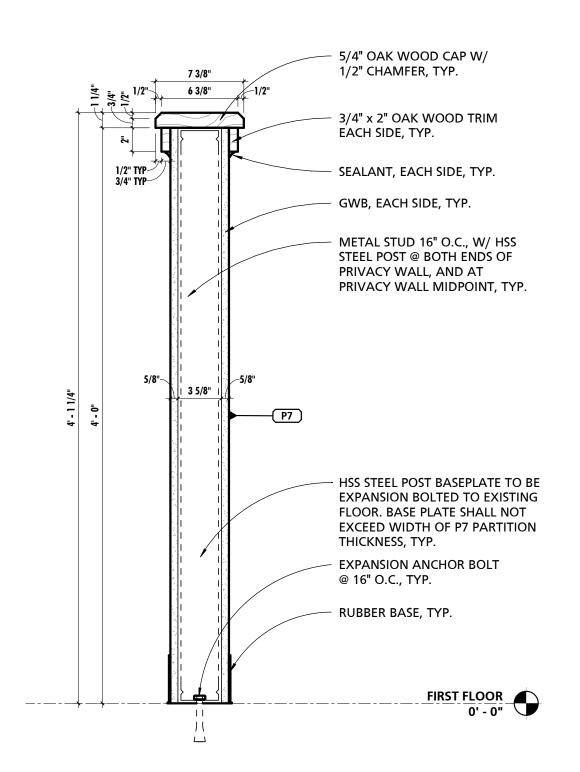


SUBDIVISION: FULLERTON

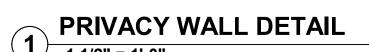

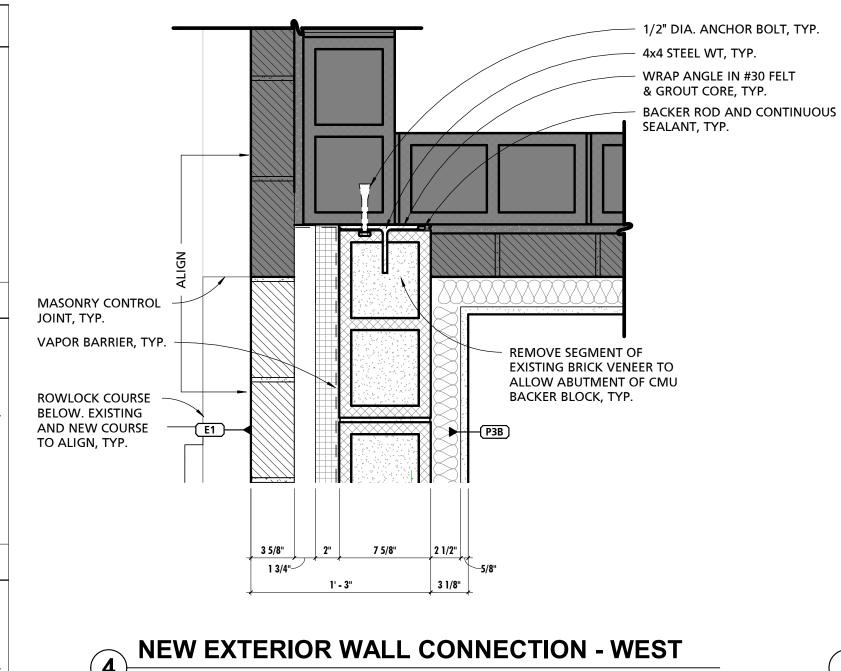


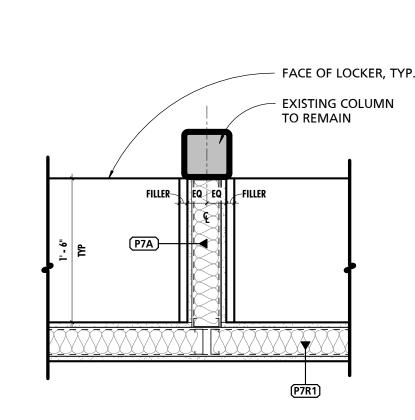




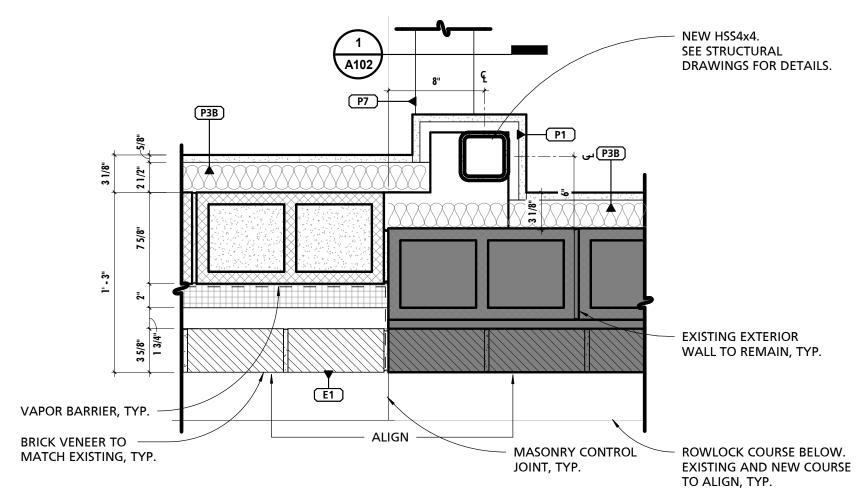



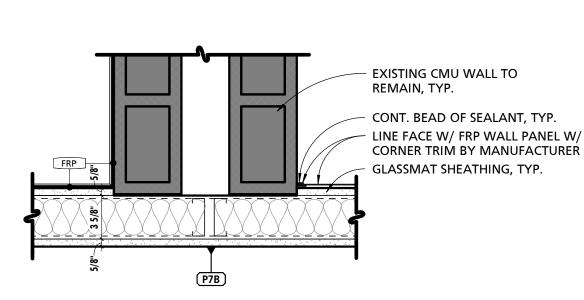



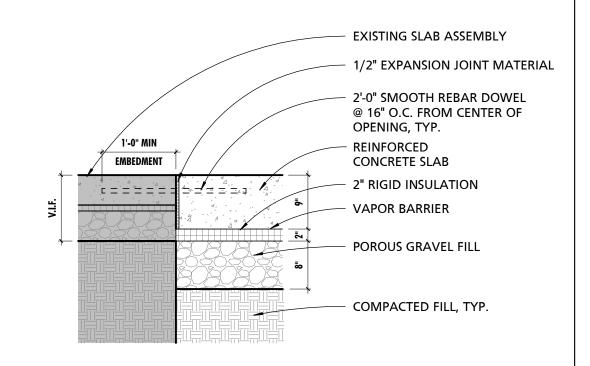

6 TYPICAL TIE-IN DETAIL @ SAW CUT

SEAL
OF MARY!
SE OF MARY
7.7.7.5.5.5. 7.7.7.5.5.5.5.5.5.5.5.5.5.5.5.5.5.5.5.5
ARCHITECHINE
. (1)

<u>DATE</u>: 09/20/24

PROFESSIONAL CERTIFICATION  I HEREBY CERTIFY THAT THESE DOCUMENTS WERE PREPARPROVED BY ME, AND THAT I AM A DULY LICENSED PROFESSIONAL ARCHITECT UNDER THE LAWS OF THE STA		CATION	AS-BUILT / REVISION	BY	DATE	P.W.A. NO.	KEY SHEET	POSITION SHT	DRAWIN	G SCALE	
			BID/PERMIT		09/20/24	-	MSW	27NE21	PLAN SCALE:	As indicated	APPROVED BY: Mihai T. Petrisor
						R.O.W NO.	-	-			DIRECTO
	MARYLAND. LICENSE NO. 15505 EXPIRATION DATE: 08-18-2026					-	-	-	PROFILE SCALE:	-	DATE: 10/03/2024
	ARCHITECT:	DGN BY:	BUREAU OF ENGINEERING AND CONSTRUCTION	HIGI	HWAYS	STRUCTURES	STORM DRAINS	SEWER	WATER	FIELD ENGINEER	PROPERTY MANAGEMENT
	PRINCIPAL ARCHITECT  MANNS WOODWARD STUDIOS	DWN BY:	REVIEWED BY:								APPROVED BY:
10839-D PHILADELPHIA ROAD WHITE MARSH, MARYLAND 21162		CHKD BY:	DATE REVIEWED:								CHIE DATE:

BALTIMORE COUNTY OFFICE OF BUDGET AND FINANCE, PROPERTY MANAGEMENT

FULLERTON FIRE STATION #8 - RENOVATION & ADDITION

BUILDING ASSEMBLY TYPES & DETAILS


4401 FITCH AVENUE, NOTTINGHAM, MARYLAND, 21236


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	22221 PFO
<u> </u>	JOB ORDER NUMBER
	241-220-0054-0012
*	SHEET 17 of 58
	DRAWING NUMBER
3/	2022-2336

FILE NO.: 8


SHEET DESIGNATION | CONTRACT NUMBER



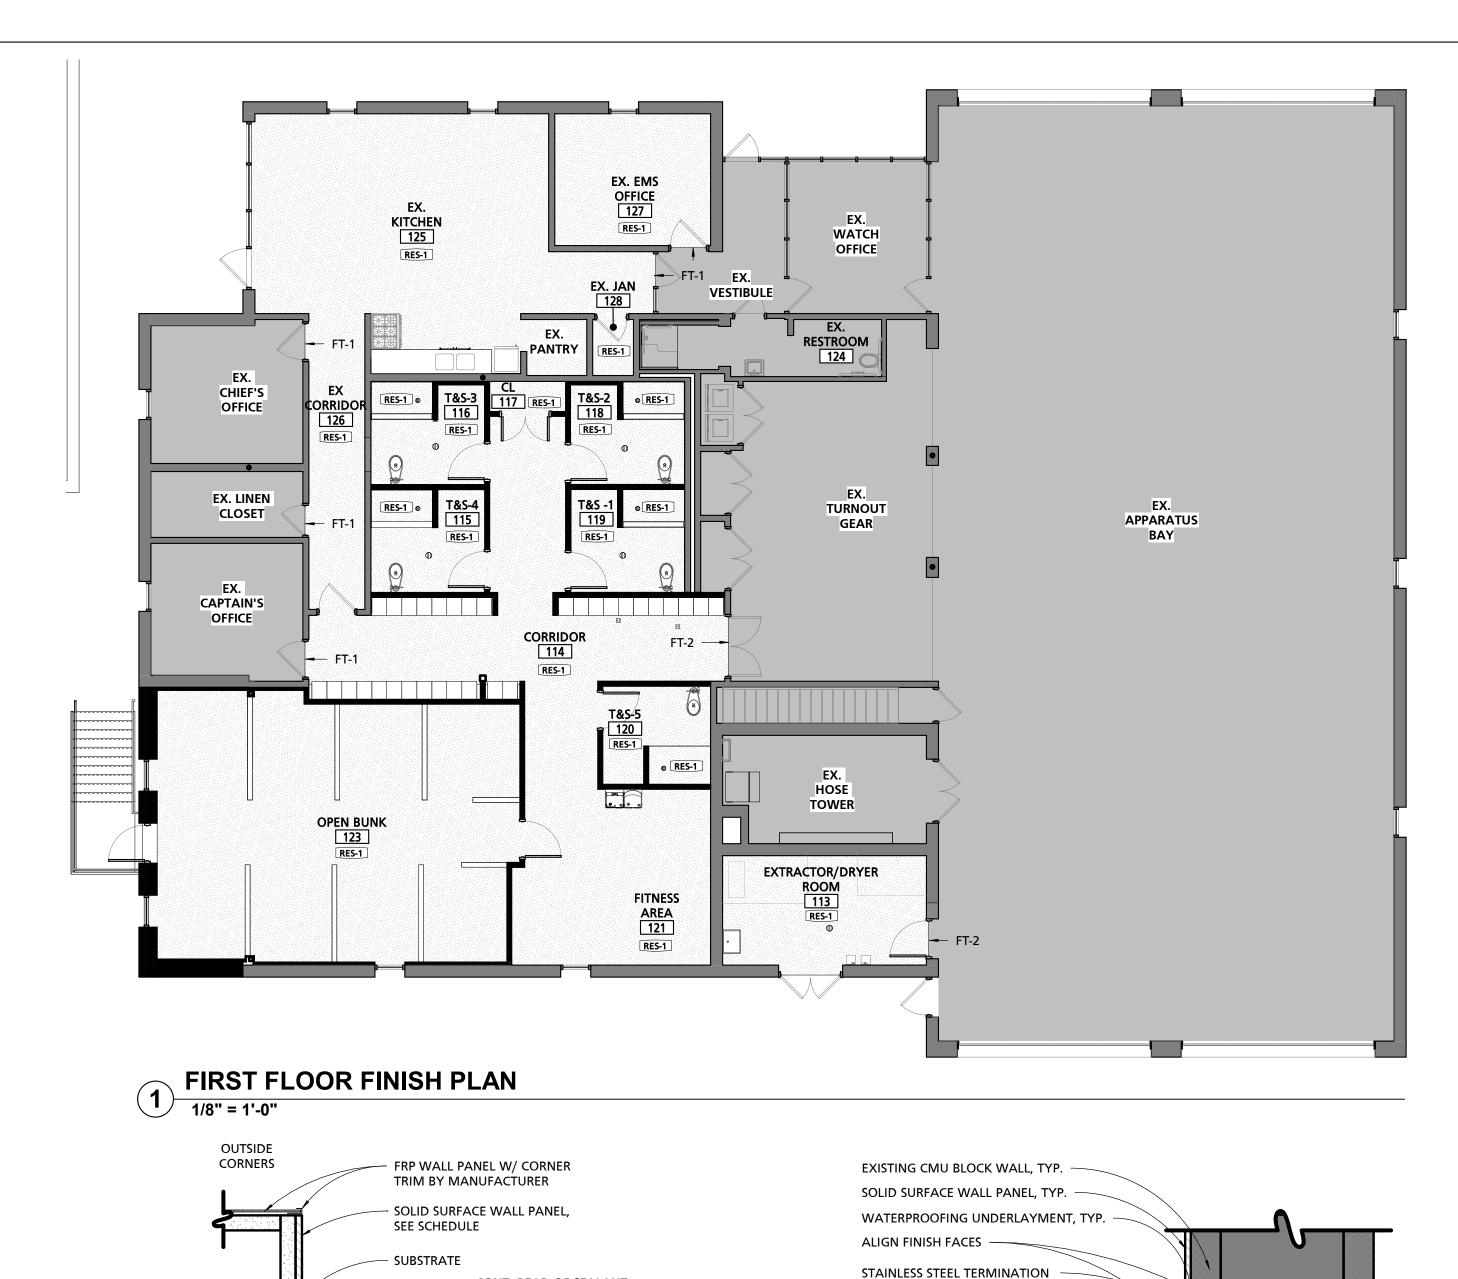

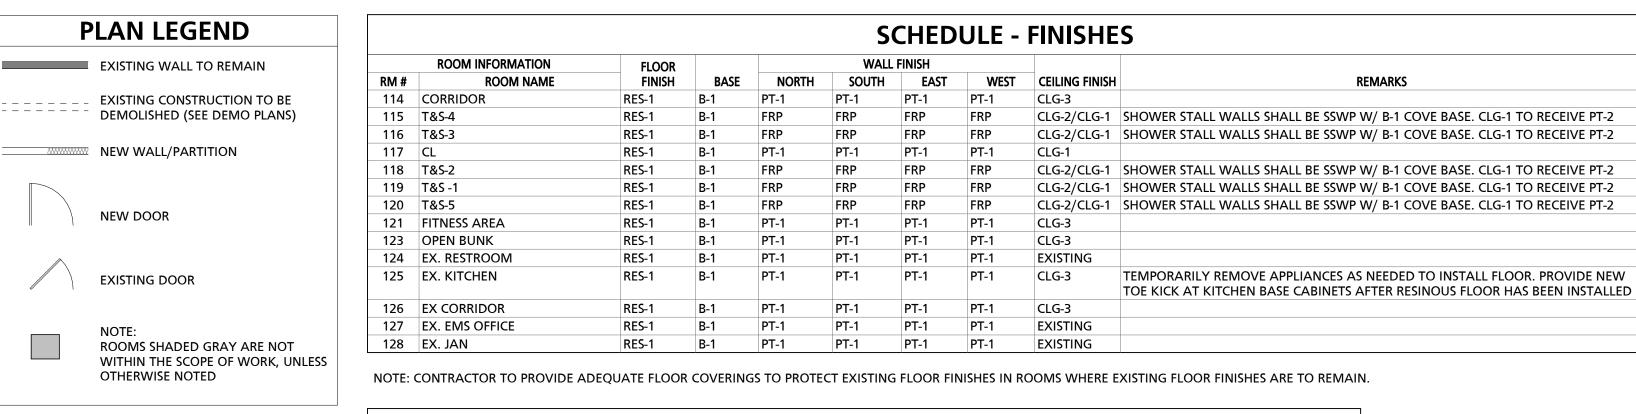
SCHEDULE - MATERIAL FINISH KEY							
FINISH MARK	DESCRIPTION	BOD MANUFACTURER	BOD PRODUCT LINE/COLOR	COMMENTS			
		KEY RESIN CO.	·				
B-1	4" RESINOUS COVE BASE		KEY MMA CHIP 900				
FRP	FIBERGLASS REINFORCED PLASTIC WALL PANELING	CRANE COMPOSITES					
PT-1		SHERWIN WILLIAMS					
PT-2	WALL PAINT	SHERWIN WILLIAMS	#6224 SEMI-GLOSS				
RES-1	RESINOUS COVERING	KEY RESIN CO.	KEY MMA CHIP 900				
SS-1	SOLID SURFACE COUNTERTOP	FORMICA	EVERFORM SOLID SURFACE: COLOR TBD				
SSWP	36X62X84 SOLID SURFACE WALL KIT	SWANSTONE	WALL KIT: MODERN SUBWAY TILE, COLOR TBD	BOTTOM OF KIT @ 4 A.F.F., PROVIDE WITH SOAP SHELVES			


	SCHEDULE - CEILING TYPES									
MARK	DESCRIPTION	BOD MANUFACTURER	BOD MODEL	COMMENTS						
CLG 1	5/8" GWB ON 1 1/2" DRYWALL GRID	ARMSTRONG	DRYWALL GRID SYSTEM							
CLG 2	2x2 WASHABLE CEILING TILE	ARMSTRONG	ULTIMA HEALTH ZONE							
CLG 3	2x4 ACOUSTICAL CEILING TILE	ARMSTRONG	FISSURED 895							

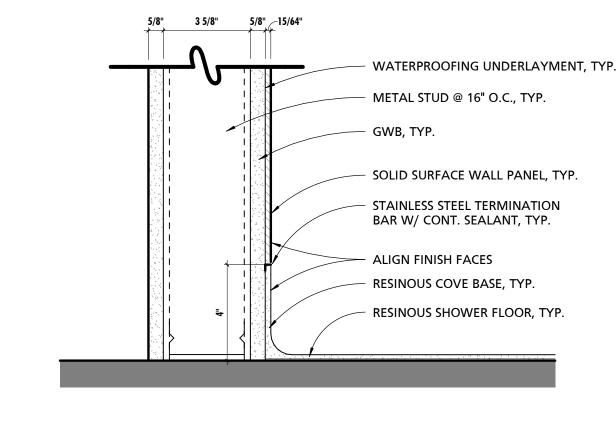

**EPOXY COVE BASE @ SHOWER** 

SUBDIVISION: FULLERTON

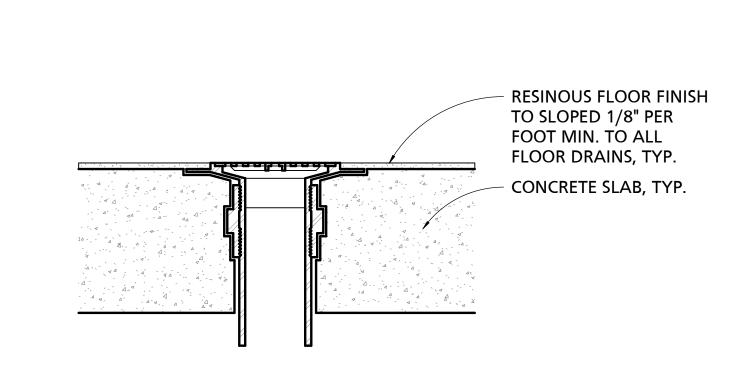

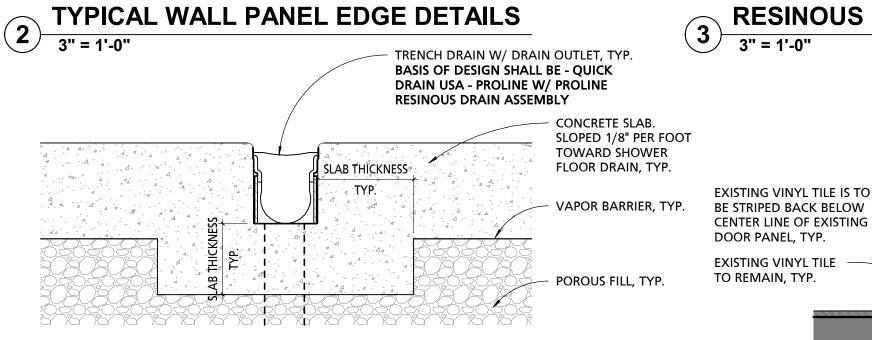

CONT. BEAD OF SEALANT

FRP WALL PANEL W/ CORNER

TRIM BY MANUFACTURER

RESINOUS COVE BASE @ MASONRY

LINE OF EXISTING WALL - EXISTING DOOR PANEL & FRAME, TYP. RESINOUS COVE EXISTING VINYL TILE IS TO BASE, TYP. ALUMINUM TRANSITION STRIP, TYP. BASIS OF DESIGN SHALL BE SCHULTER-SCHIENE RESINOUS FLOORING, TYP. - RESINOUS PRIMER, TYP. - EXISTING CONCRETE SLAB, TYP.

DOOR PANEL, TYP.  SAW CUT CONCRETE SLAB, TYP.  RESINOUS PRIMER, TYP.  EXISING CONCRETE SLAB, TYP.
FT-2 RESINOUS FLOORING (RES-1) TO EXISTING CONCRETE SLAB

TYPICAL SHOWER TRENCH DRAIN DETAIL 6 TYPICA 3" = 1'-0"

**WALL PANEL** 

TRANSITION

FLOOR COVE & INSIDE

WALL CORNER

FT-1
RESINOUS FLOORING (RES-1) TO EXISTING VINYL TILE **TRANSITION DETAIL** 7 3" = 1'-0"

BAR W/ CONT. SEALANT, TYP.

RESINOUS SHOWER FLOOR, TYP.

EXISTING CONCRETE SLAB, TYP.

RESINOUS COVE BASE, TYP. -

	APPROVED BY: Mihai T. Petrisor	
	DIRECTOR	
-	DATE: 10/03/2024	
_		

FULLERTON FIRE STATION #8 - RENOVATION & ADDITION

FINISH PLAN, SCHEDULE & DETAILS

BALTIMORE COUNTY OFFICE OF BUDGET AND FINANCE, PROPERTY MANAGEMENT


5 FLOOR DRAIN
3" = 1'-0"

4401 FITCH AVENUE, NOTTINGHAM, MARYLAND, 21236

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SHEET DESIGNATION	CONTRACT NUMBER	
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	DRAWING NUMBER	05


DRAWING NUMBER 2022-2337 FILE NO.: 8

SEAL OF MARY		PROFESSIONAL CERTIFICATION		AS-BUILT / REVISION	BY	DATE	P.W.A. NO.	KEY SHEET	POSITION SHT	DRAWIN	IG SCALE	
		I HEREBY CERTIFY THAT THESE DOCUMENTS WERE PREPARED OR APPROVED BY ME, AND THAT I AM A DULY LICENSED		BID/PERMIT		09/20/24	-	MSW	27NE21	PLAN SCALE:	As indicated	APPROVED BY: Mihai T. Petrisor
		PROFESSIONAL ARCHITECT UNDER THE LAWS OF THE STATE OF MARYLAND.  LICENSE NO. 15505 EXPIRATION DATE: 08-18-2026					R.O.W NO.	-	-			DIRECTOR
							-		-	PROFILE SCALE		DATE: 10/03/2024
	<b>到:</b> [()	ARCHITECT:	DOM DAY	BUREAU OF ENGINEERING	11101				anvinn.	****		
		DAVID WOODWARD, AIA	DGN BY:	AND CONSTRUCTION	HIGH	HWAYS	STRUCTURES	S STORM DRAINS	SEWER	WATER	FIELD ENGINEER	PROPERTY MANAGEMENT
	1,5505 1,5505	PRINCIPAL ARCHITECT	DWN BY:	REVIEWED BY:								APPROVED BY:
	O WALLIAM.	MANNS WOODWARD STUDIOS 10839-D PHILADELPHIA ROAD										CHIEI
	DATE: 09/20/24	WHITE MARSH, MARYLAND 21162 (P) 410-344-1460	CHKD BY:	DATE REVIEWED:								DATE:
Ŀ	DATE.											

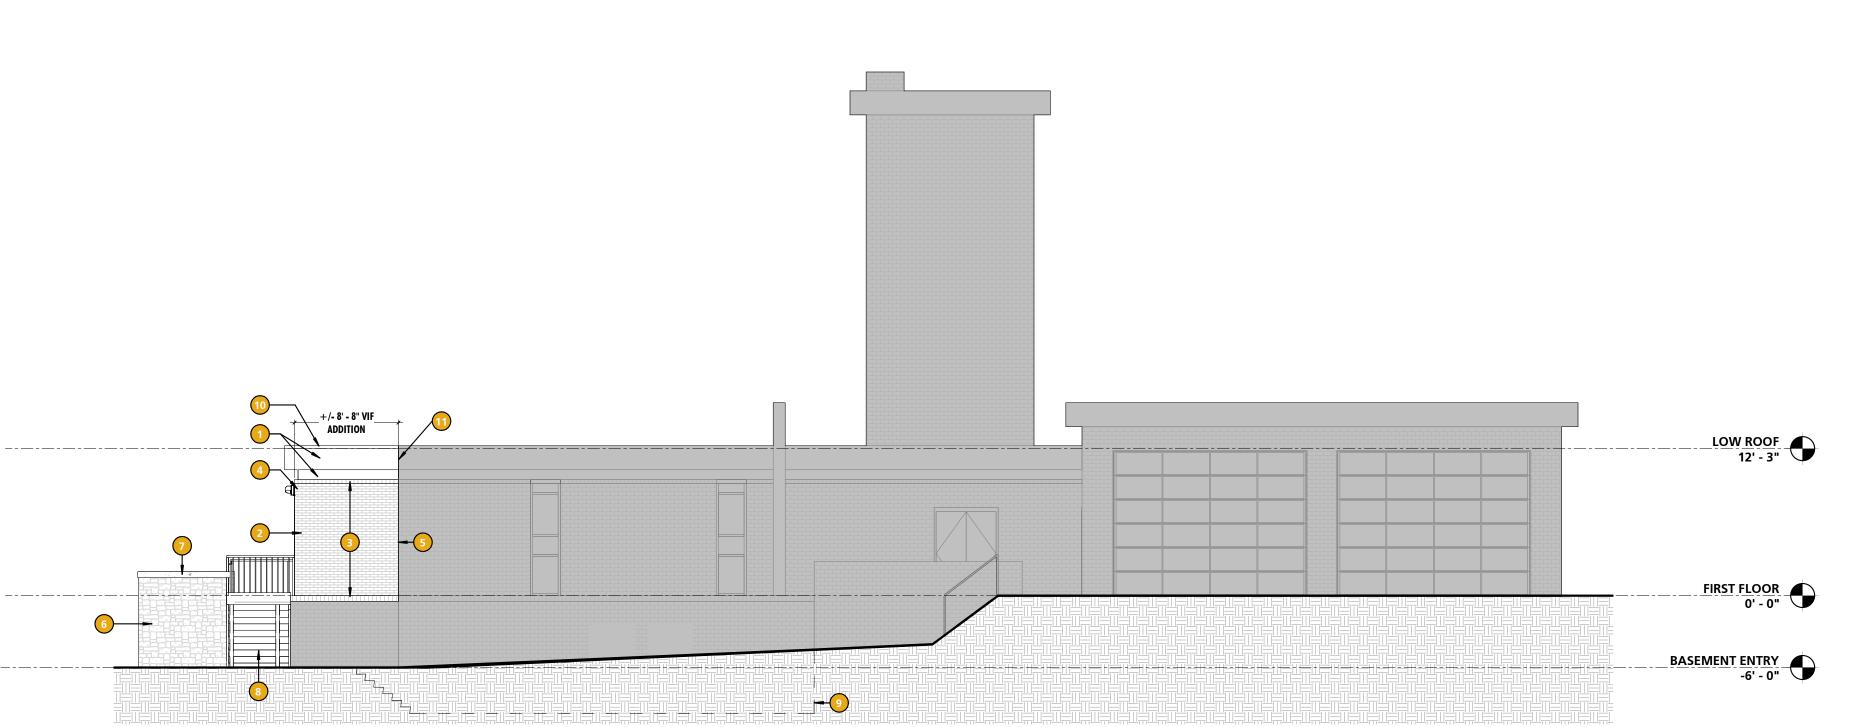

3 EXTERIOR HANDRAIL ELEVATION
1/2" = 1'-0"

SUBDIVISION: FULLERTON

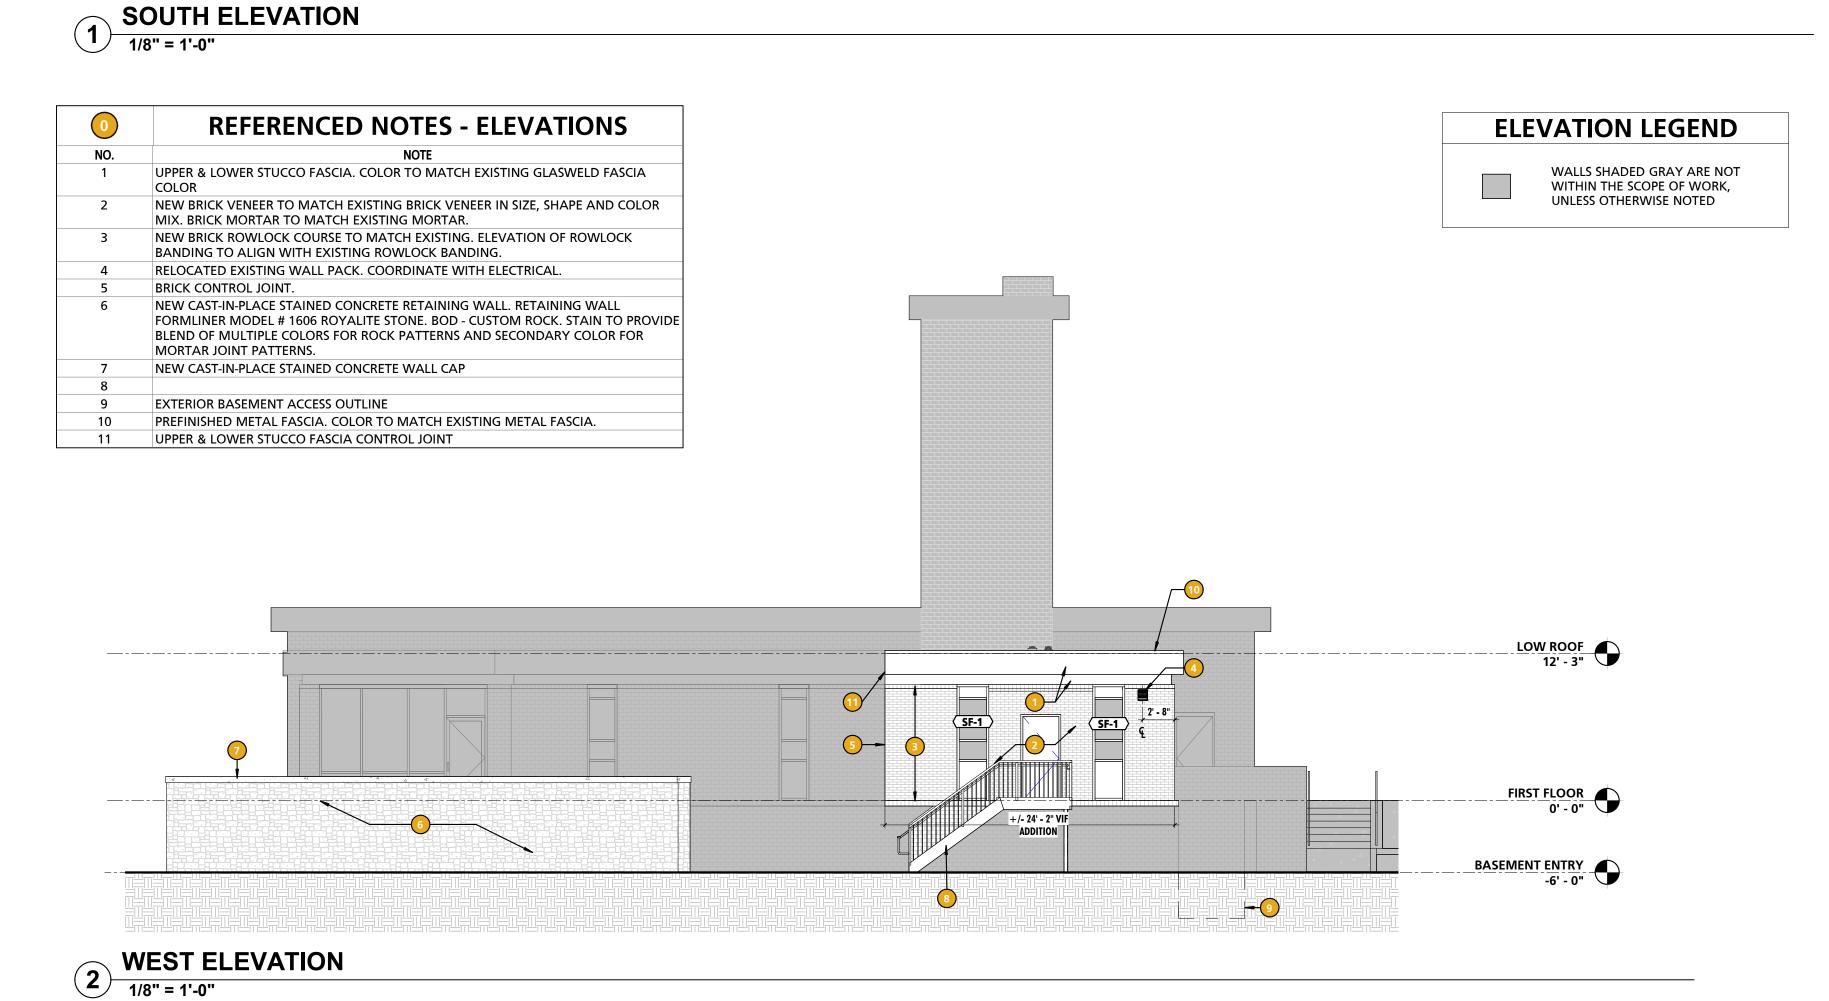

BY DATE P.W.A. NO. KEY SHEET POSITION SHT DRAWING SCALE AS-BUILT / REVISION PROFESSIONAL CERTIFICATION APPROVED BY: Mihai T. Petrisor I HEREBY CERTIFY THAT THESE DOCUMENTS WERE PREPARED OR APPROVED BY ME, AND THAT I AM A DULY LICENSED PROFESSIONAL ARCHITECT UNDER THE LAWS OF THE STATE OF BID/PERMIT PLAN SCALE: As indicated R.O.W NO. 10/03/2024 MARYLAND. LICENSE NO. 15505 EXPIRATION DATE: 08-18-2026 BUREAU OF ENGINEERING AND CONSTRUCTION HIGHWAYS STRUCTURES STORM DRAINS SEWER PROPERTY MANAGEMENT WATER FIELD ENGINEER REVIEWED BY: APPROVED BY: MANNS WOODWARD STUDIOS 10839-D PHILADELPHIA ROAD WHITE MARSH, MARYLAND 21162 DATE REVIEWED:

BALTIMORE COUNTY OFFICE OF BUDGET AND FINANCE, PROPERTY MANAGEMENT FULLERTON FIRE STATION #8 - RENOVATION & ADDITION BUILDING ELEVATIONS 4401 FITCH AVENUE, NOTTINGHAM, MARYLAND, 21236 ELECTION DIST. NO.: 14C5


SHEET DESIGNATION | CONTRACT NUMBER FILE NO.: 8

FIRST FLOOR
0' - 0"

\_\_1-1/2" O.D. CONTINUOUS GALVANIZED STEEL \_HANDRAIL @ 3'-0" ABOVE TREAD NOSING W/


BRACKETS @ 36" O.C. MAX, TYP.

22221 PFO JOB ORDER NUMBER 241-220-0054-0012 SHEET 19 of 58 DRAWING NUMBER 2022-2338

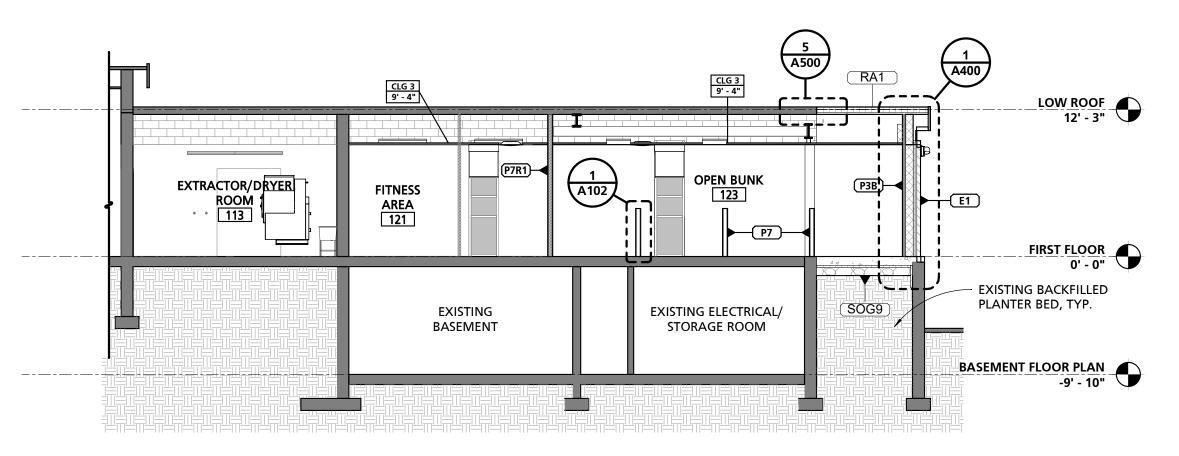

PARTIAL LONGITUDINAL BUILDING SECTION THROUGH OPEN BUNK

1/8" = 1'-0"

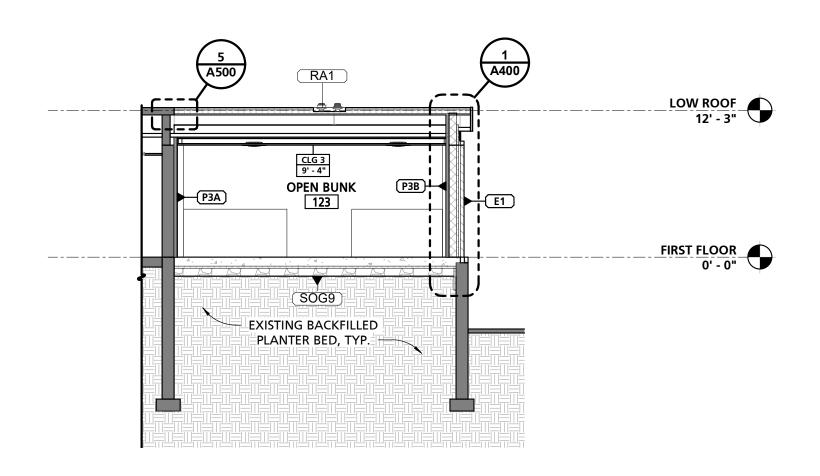

PARTIAL TRANSVERSE BUILDING SECTION THROUGH BUNK ROOM

1/8" = 1'-0"

-													1
SEAL WOOG WARN		PROFESSIONAL CERTIFICATION		AS-BUILT / REVISION		BY	DATE	P.W.A. NO.	KEY SHEET	POSITION SHT	DRAWIN	G SCALE	
		I HEREBY CERTIFY THAT THESE DOCUMENTS APPROVED BY ME, AND THAT I AM A DULY LIC	BID/PERMIT			09/20/24	-	MSW	27NE21	PLAN SCALE: 1/8" = 1'-0"		APPROVED BY: Mihai T. Petrisor	
	PROFESSIONAL ARCHITECT UNDER THE LAWS							R.O.W NO.	-	-			DIREC
		MARYLAND. LICENSE NO. 15505 EXPIRATION D	ATE: 08-18-2026					-	i :	-	PROFILE SCALE:	-	DATE: 10/03/2024
		ARCHITECT:	DGN BY:	BUREAU OF ENGINEERING AND CONSTRUCTION		HIGH	WAYS	STRUCTURES	STORM DRAINS	SEWER	WATER	FIELD ENGINEER	PROPERTY MANAGEMENT
	ARCHITECULA	PRINCIPAL ARCHITECT  MANNS WOODWARD STUDIOS	DWN BY:	REVIEWED BY:									APPROVED BY:
	"THE HALL	10839-D PHILADELPHIA ROAD											CH
	DATE: 09/20/24	WHITE MARSH, MARYLAND 21162 (P) 410-344-1460	CHKD BY:	DATE REVIEWED:									DATE:
L	BATE:												<u> </u>

4401 FITCH AVENUE, NOTTINGHAM, MARYLAND, 21236

ELECTION DIST. NO.: 14C5

SHEET DESIGNATION	CONTRACT NUMBER
A300	22221 PFO
NORE C	JOB ORDER NUMBER
	241-220-0054-0012
	SHEET 20 of 58

2022-2339

BALTIMORE COUNTY OFFICE OF BUDGET AND FINANCE, PROPERTY MANAGEMENT

**GENERAL BUILDING SECTION NOTES** 


BUILDING SECTIONS ARE INTENDED TO SHOW OVERALL RELATIONSHIPS OF SPACES, OVERALL ASSEMBLIES, AND THE GEOMETRY OF THE BUILDING. SEE REFERENCED WALL SECTIONS AND DETAILS FOR ADDITIONAL INFORMATION.

FULLERTON FIRE STATION #8 - RENOVATION & ADDITION


BUILDING SECTIONS

SUBDIVISION: FULLERTON

DRAWING NUMBER FILE NO.: 8

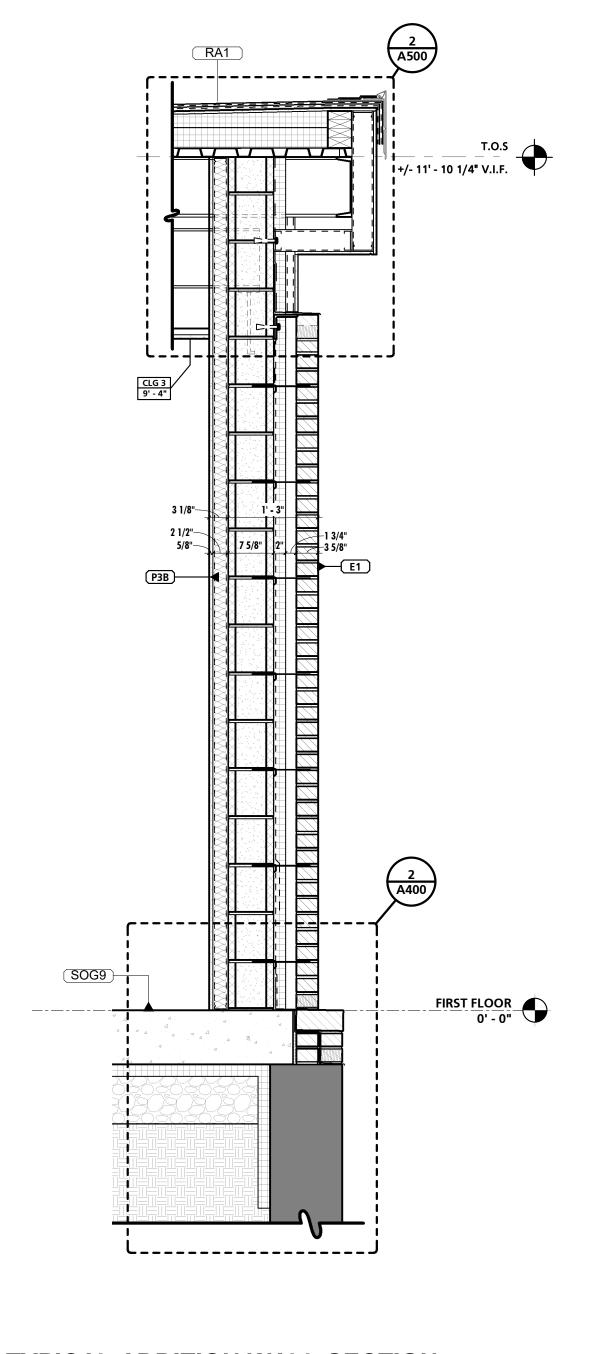

1 TYPICAL ADDITION WALL SECTION
3/4" = 1'-0"

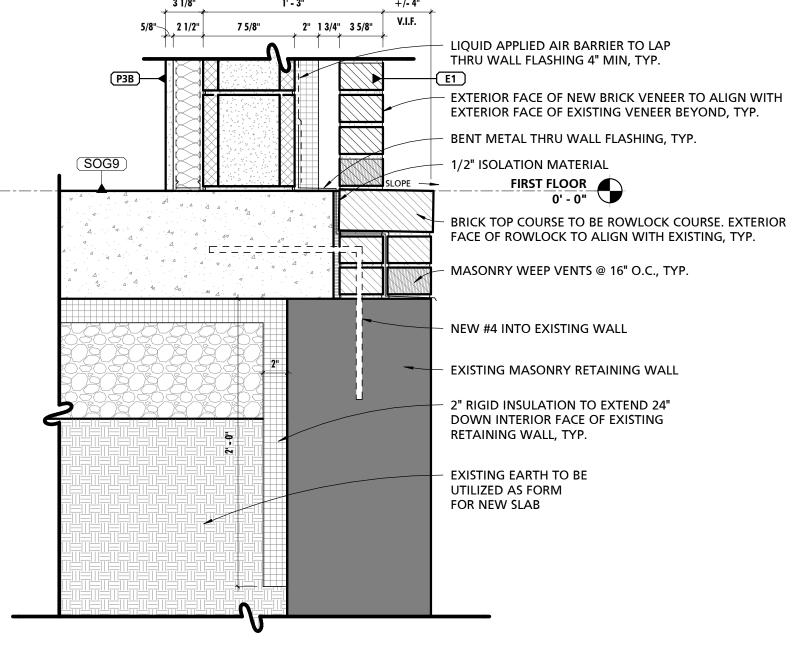

SUBDIVISION: FULLERTON

TYPICAL ADDITION FOUNDATION DETAIL

L															
SEAL PROFES		PROFESSIONAL CERTIFI	CATION	AS-BUILT / REV	ISION	BY	DATE	P.W.A. NO.	KEY SHEET	POSITION SHT	DRAWIN	G SCALE			
	A WOOD W	I HEREBY CERTIFY THAT THESE DOCUMENTS APPROVED BY ME, AND THAT I AM A DULY LIC	BID/PERM	ΙΤ		09/20/24	-	MSW	27NE21	PLAN SCALE:	As indicated	APPROVED	BY: Mihai T. Pet	usor	
	- * COV/SV @W *7@WV SCRLW XXXW * N	PROFESSIONAL ARCHITECT UNDER THE LAWS OF THE STATE OF MARYLAND.  LICENSE NO. 15505 EXPIRATION DATE: 08-18-2026						R.O.W NO.	-	-			15/50/0504		DIRECTO
								-			PROFILE SCALE:	-	DATE:	10/03/202	4
		ARCHITECT:	DGN BY:	BUREAU OF ENGINEERING AND CONSTRUCTION		HIGH	IWAYS	STRUCTURES	STORM DRAINS	SEWER	WATER	FIELD ENGINEER	PRO	PERTY MANAGEN	 ЛЕNТ
A. 15505.	PRINCIPAL ARCHITECT  MANNS WOODWARD STUDIOS	DWN BY:	REVIEWED BY:									APPROVED	BY:	CHIE	
	DATE: 09/20/24	10839-D PHILADELPHIA ROAD WHITE MARSH, MARYLAND 21162 (P) 410-344-1460	CHKD BY:	DATE REVIEWED:									DATE:		

BALTIMORE COUNTY OFFICE OF BUDGET AND FINANCE, PROPERTY MANAGEMENT

FULLERTON FIRE STATION #8 - RENOVATION & ADDITION

WALL SECTIONS

4401 FITCH AVENUE, NOTTINGHAM, MARYLAND, 21236

ELECTION DIST. NO.: 14C5

A400

22221 PFO

JOB ORDER NUMBER

241-220-0054-0012

SHEET 21 of 58


DRAWING NUMBER


2022-2340

FILE NO.: 8


REV. 10/13

SHEET DESIGNATION CONTRACT NUMBER

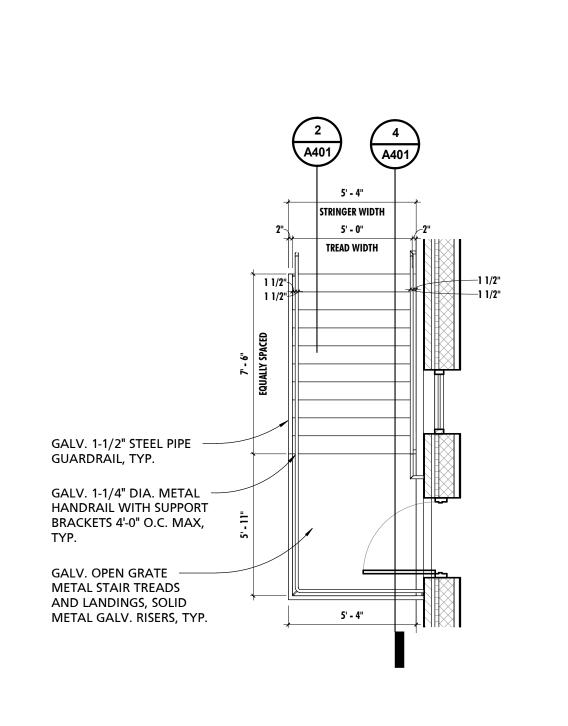

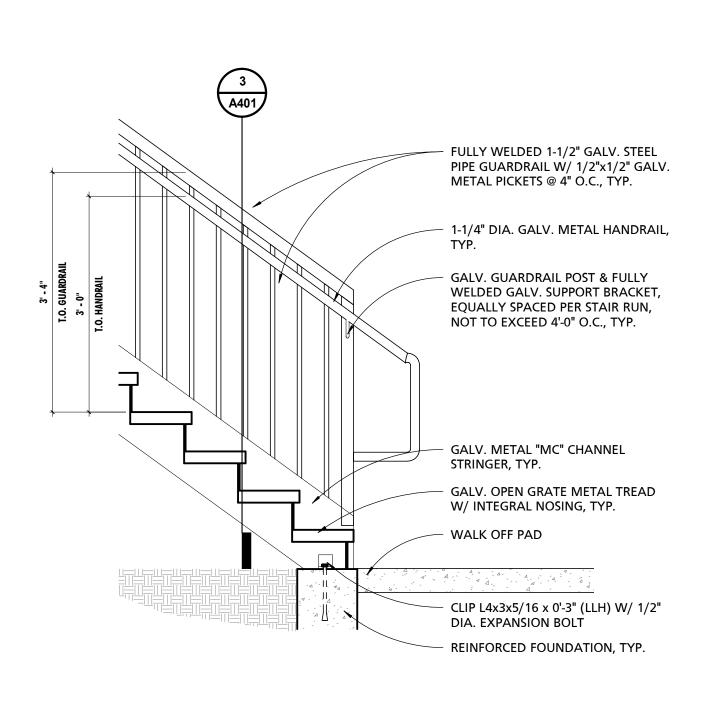

 1-1/4" DIA. GALV.
 METAL HANDRAIL, TYP. FULLY WELDED 1-1/2" — DIA. GALV. METAL PIPE - GALV. GUARDRAIL POST & FULLY WELDED GALV. GUARDRAIL W/ 1/2"x1/2" METAL SUPPORT BRACKET, EQUALLY SPACED PER PICKETS @ 4" O.C., TYP. STAIR RUN, NOT TO EXCEED 4'-0" O.C., TYP. - GALV. OPEN GRATE **METAL TREADS &** LANDINGS, TYP.

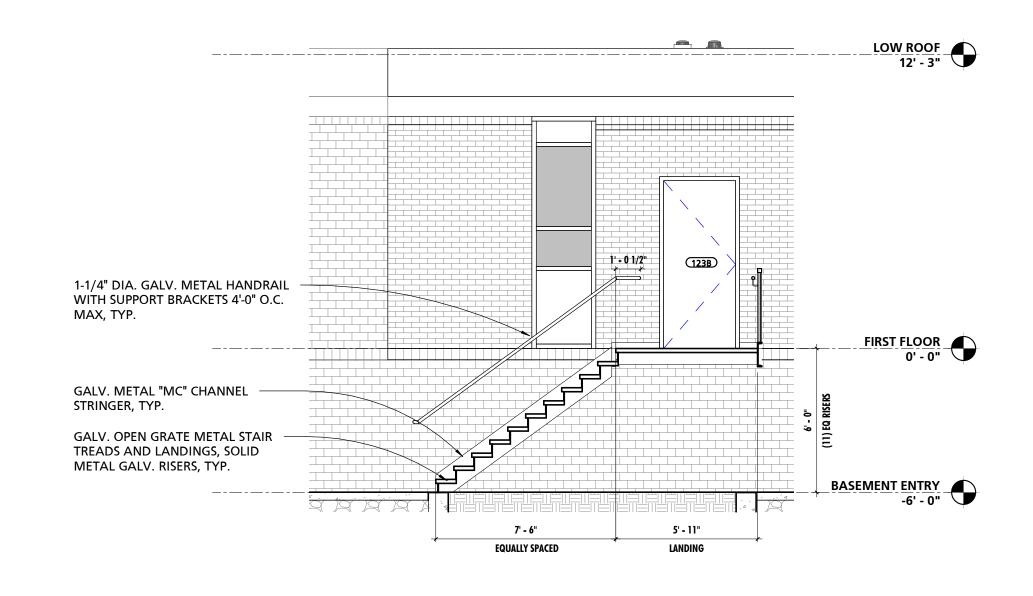

**EXTERIOR STAIR - FIRST FLOOR LANDING** 

**EXTERIOR STAIR DETAIL** 

TYPICAL EXTERIOR RAILING

SUBDIVISION: FULLERTON

**EXTERIOR STAIR SECTION** 

SEAL	PROFESSIONAL CERTIFICATION		AS-BUILT / REV	VISION	BY DATE	P.W.A. NO.	KEY SHEET	POSITION SHT	DRAWIN	G SCALE			
OF MARY	I HEREBY CERTIFY THAT THESE DOCUMENTS WERE PREPARED OR APPROVED BY ME, AND THAT I AM A DULY LICENSED PROFESSIONAL ARCHITECT UNDER THE LAWS OF THE STATE OF MARYLAND.  LICENSE NO. 15505 EXPIRATION DATE: 08-18-2026		BID/PERM	IIT	09/20/24	-	MSW	27NE21	PLAN SCALE:	As indicated	APPROVED BY:	Mihai T. Petris	or
					R.O.W NO.		-	-	-		10/	O3/2024	DIRECTO
						-	-	-	PROFILE SCALE:	-	DATE:	J312O24	
	ARCHITECT:	DGN BY:	BUREAU OF ENGINEERING AND CONSTRUCTION		HIGHWAYS	STRUCTURES	STORM DRAINS	SEWER	WATER	FIELD ENGINEER	PROPER	TY MANAGEME	ENT
ACHITECHINI	PRINCIPAL ARCHITECT  MANNS WOODWARD STUDIOS	DWN BY:	REVIEWED BY:								APPROVED BY:		
DATE: 09/20/24	10839-D PHILADELPHIA ROAD WHITE MARSH, MARYLAND 21162 (P) 410-344-1460	CHKD BY:	DATE REVIEWED:								DATE:		СНИ


BALTIMORE COUNTY OFFICE OF BUDGET AND FINANCE, PROPERTY MANAGEMENT FULLERTON FIRE STATION #8 - RENOVATION & ADDITION

4401 FITCH AVENUE, NOTTINGHAM, MARYLAND, 21236


STAIR DETAILS


ELECT	ION DIST. N	NO.: 14C5

SHEET DESIGNATION	CONTRACT NUMBER
A401	22221 PFO
MORE	JOB ORDER NUMBER
	241-220-0054-0012
* * * * *	SHEET 22 of 58
\ \ <u>\$</u> *\\\	DRAWING NUMBER
MARYLAND	
	FILE NO.: 8 REV. 10/13

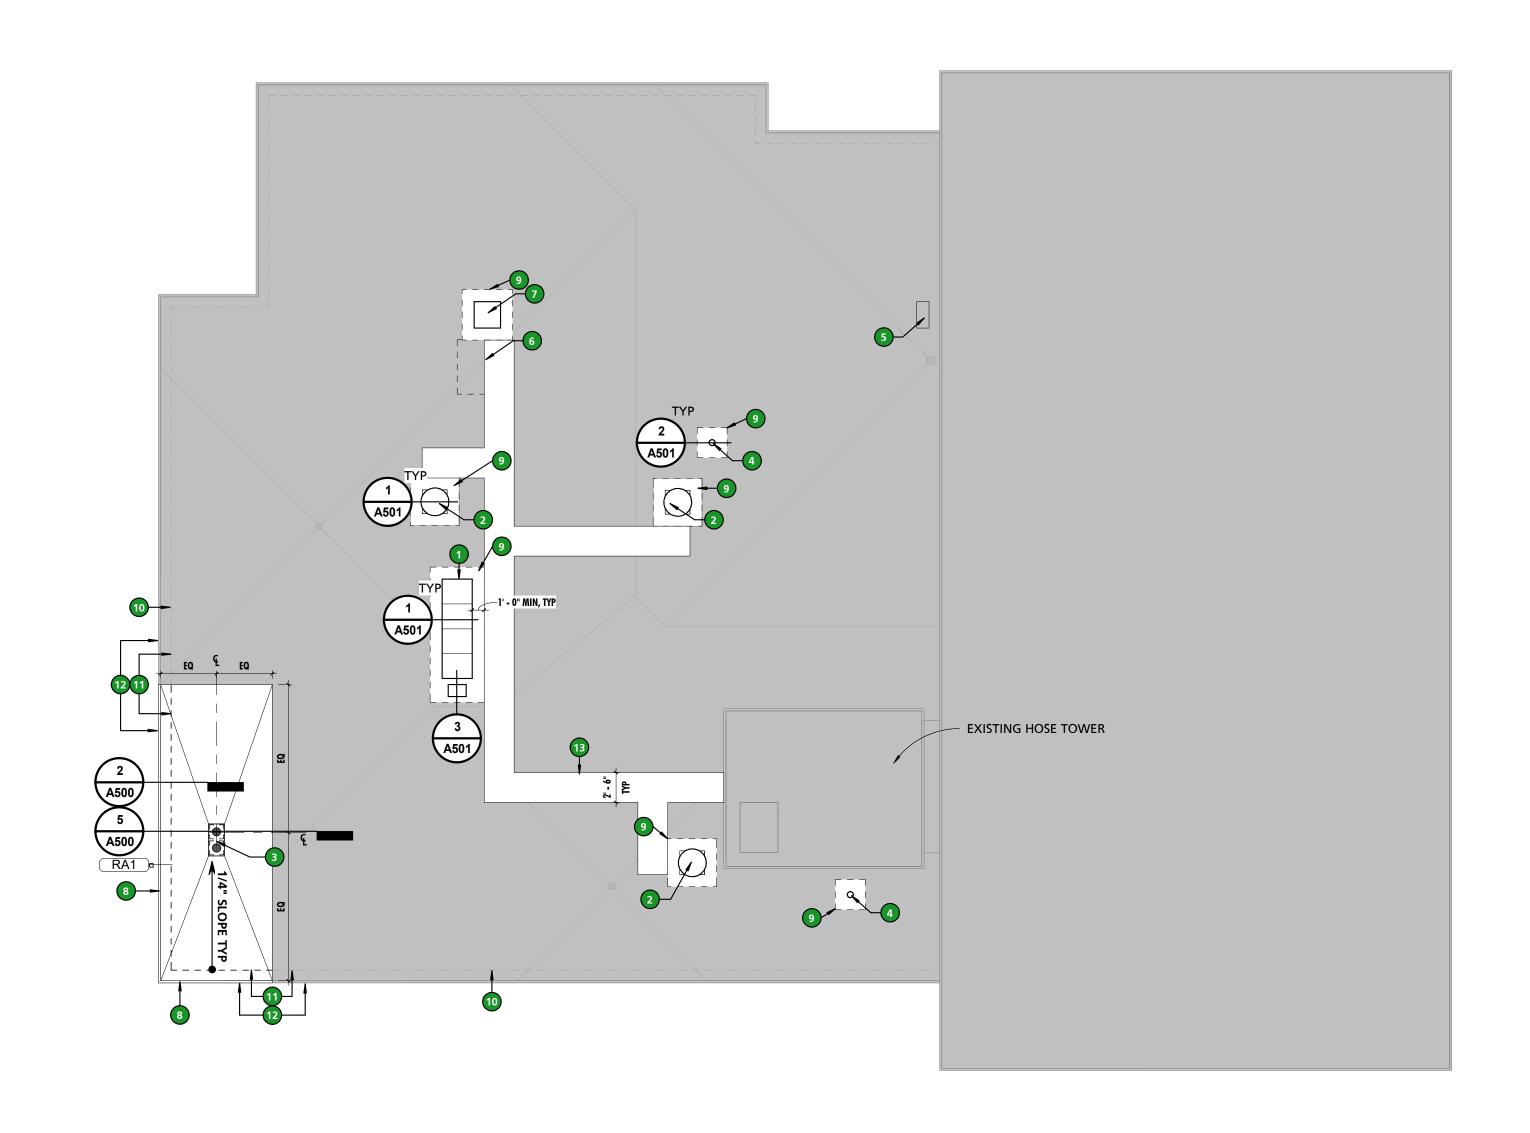

# **ROOF PLAN**

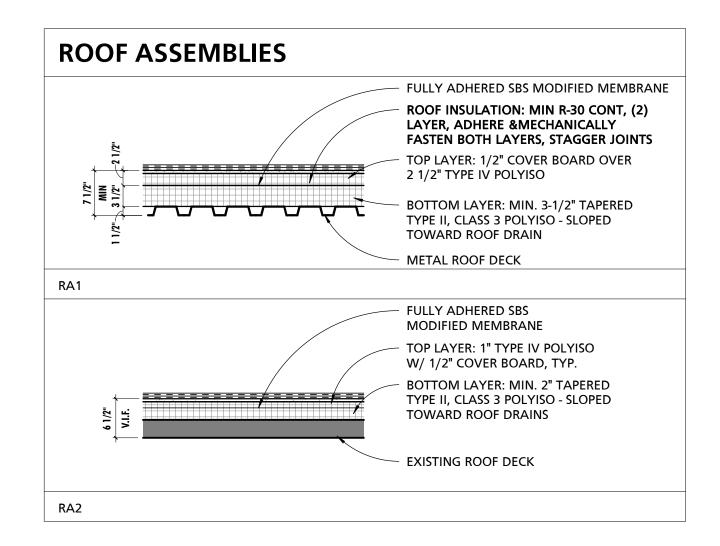

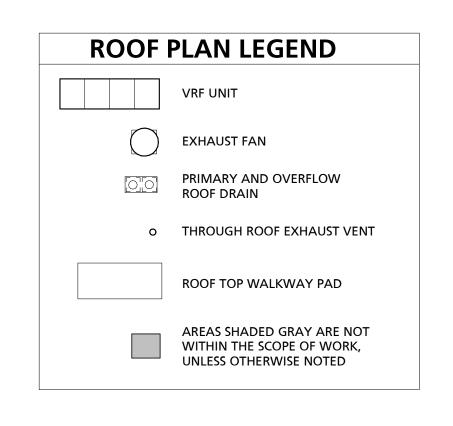

	GENERAL ROOFING NOTES
NOTE #	NOTE
1	BLOCKING/MISCELLANEOUS FRAMING INDICATED WITHIN THE DOCUMENTS IS SHOWN FOR THE PURPOSES OF DESIGN INTENT. IT SHALL BE THE CONTRACTORS RESPONSIBILITY, WHETHER SHOWN OR NOT SHOWN, TO PROVIDE BLOCKING/MISCELLANEOUS FRAMING AS REQUIRED TO PROPERLY SUPPORT ALL SUBSTRATES, FLASHINGS, COPINGS, BRAKE METAL, SOFFITS, INSULATIONS, CLIPS, STOPS, MISCELLANEOUS ITEMS, ROOFING MEMBRANES OR SYSTEMS AND SIMILAR ITEMS REQUIRED TO COMPLETE THE WORK. WHERE ADDITIONAL BLOCKING/MISCELLANEOUS FRAMING, INCLUDING BUT NOT LIMITED TO THE REPLACEMENT OF INDICATED SHEATHING/DECKING, IS RECOMMENDED BY ONE OF THE ASSEMBLY COMPONENTS MANUFACTURER, THE CONTRACTOR SHALL PROVIDE AND INSTALL SUCH BLOCKING/MISCELLANEOUS FRAMING TO COMPLY WITH THE MANUFACTURER'S RECOMMENDATIONS
2	CONTRACTOR SHALL BE RESPONSIBLE FOR COORDINATING FINAL ROOFING SUBSTRATE REQUIREMENTS TO ENSURE SUCCESSFUL INSTALLATION OF ROOFING MATERIALS IN A MANNER THAT MAINTAINS THE FULL PRODUCT WARRANTY AND COMPLIES WITH ALL APPLICABLE BUILDING CODES OF THE AHJ.
3	PENETRATION DETAILS ARE FOR REFERENCE ONLY. CONTRACTOR TO REVIEW FULL EXTENT OF PENETRATIONS AND ASSOCIATED LOCATIONS WITH ALL OTHER DRAWINGS WITHIN THE DOCUMENT SET.
4	AT ALL AREAS TO RECEIVE ROOF PATCHING, INFILLING AND NEW EQUIPMENT CURB WORK, CONTRACTOR TO ENSURE ADEQUATE SLOPE TO EXISTING ROOF DRAINAGE IS MAINTAINED.


### **SCHEDULE - ROOFING TYPES**

MARK	DESCRIPTION	COMMENTS
RA1	(2) PLY SBS MODIFIED MEMBRANE OVER 1/2 COVER BOARD, MIN 5 1/2"	
	SLOPED RIGID INSULATION AND 1 1/2" METAL DECK	
RA2	(2) PLY SBS MODIFIED MEMBRANE OVER 1/2 COVER BOARD, SLOPED RIGID	MATCH EXISTING ROOF SLOPE AND
	INSULATION AND EXISTING ROOF TILE	THICKNESS

0	REFERENCED NOTES - ROOF PLANS
NO.	NOTE
1	CURB MOUNTED VRF UNIT.
2	CURB MOUNTED EXHAUST FAN.
3	PRIMARY & OVERFLOW ROOF DRAIN W/ CAST IRON BODY & POLYETHLENE STRAINER.
4	THRU ROOF EXHAUST VENT.
5	EXISTING SPLIT SYSTEM UNIT TO REMAIN.
6	CONTRACTOR TO DISSCONNECT AND REMOVE ROOF TOP UNIT AND ALL ASSOCIATED APPURTENANCES IN THEIR ENTIRETY. PREPARE OPENING TO RECEIVE NEW DECKING, RIGID INSULATION, AND ROOF MEMBRANE TO MATCH EXISTING ROOF ASSEMBLY.
7	CURB MOUNTED INTAKE LOUVER.
8	PREFINISHED ALUMINUM FASCIA COPING TO MATCH EXISTING COPING IN PROFILE, THICKNESS, AND COLOR.
9	ROOF ASSEMBLY (RA2) TO MATCH EXISTING SLOPE AND THICKNESS.
10	DASHED LINE INDICATES EXTERIOR FACE OF LOWER STUCCO FASCIA.
11	EXTERIOR FACE OF LOWER STUCCO FASCIA TO ALIGN WITH EXTERIOR FACE OF EXISTING LOWER STUCCO FASCIA.
12	EXTERIOR FACE OF UPPER STUCCO FASCIA TO ALIGN WITH EXTERIOR FACE OF EXISTING UPPER STUCCO FASCIA.
13	ROOF TOP WALKWAY PAD.

					(2) PLY MODIFIED SBS MEMBRANE, TYP.
					MODIFIED SBS SURFACED CAP SHEET, TYP.
	1/4" / 12"	(RA1)			PRE-FINISHED METAL FASCIA COPING TO MATCH EXISTING FASCIA COPING IN PROFILE, THICKNESS, AND COLOR, TYP.
	# / / · · · · · · · · · · · · · · · · ·				ALIGN TOP OF ROOF EDGE W/ THAT
			1/4"	,	OF EXISTING ROOF EDGE, TYP.
					EXTERIOR FACE OF STUCCO FASCIA TO ALIGN W/ EXTERIOR FACE OF EXISTING UPPER STUCCO FASCIA, TYP.  T.O.S
				2' -	11' - 10 1/4" V.I.F.
			± 1' - 4 5/8"	-1/2" +1	METAL STUD FURRING FOR STUCCO FASCIA, TYP.
TOP OF STEEL TO ———————————————————————————————————			V.III.		EXTERIOR GLASSMAT SHEATHING, TYP.
TOP OF STEEL, TYP.					VAPOR BARRIER, TYP.
					GALVANIZED SELF-FURRING LATH, TYP.
_					STUCCO BASE, PRIMER AND FINISH COATS, TYP.
					B.O. SOFFIT B.O. SOFFIT TO ALIGN
			+/- 3 1/2" V.I.F.		10' - 6" V.I.F. WITH EXISTING SOFFIT
			1/2"	10.	UPPER FASCIA STUCCO DRIP EDGE W/ CASING BEAD AND WEEPS PER MNFR
			LOWER FACE OF STU		RECOMENDATIONS, TYP.
			FASCIA TO ALIGN WA	OWER	
			STUCCO FASCIA, TYP	·	T.O.M TO ALIGN WITH EXISTING T.O.M.
	ηΥΠ " = -		DD5 5111		9 - 0 V.I.F. T
			BED OF		HING SET IN FULL LASHING COLOR TO CIA, TYP.
			E1 ELEVAT BANDIN	ION OF ADJ IG. BANDING	IDING TO MATCH ACENT EXISTING SOLDIER G TO RECEIVE MASONRY
		V	WEEPS '	VENTS @ 16"	O.C., TYP.

# TYPICAL UPPER & LOWER ROOF EDGE FASCIA DETAIL

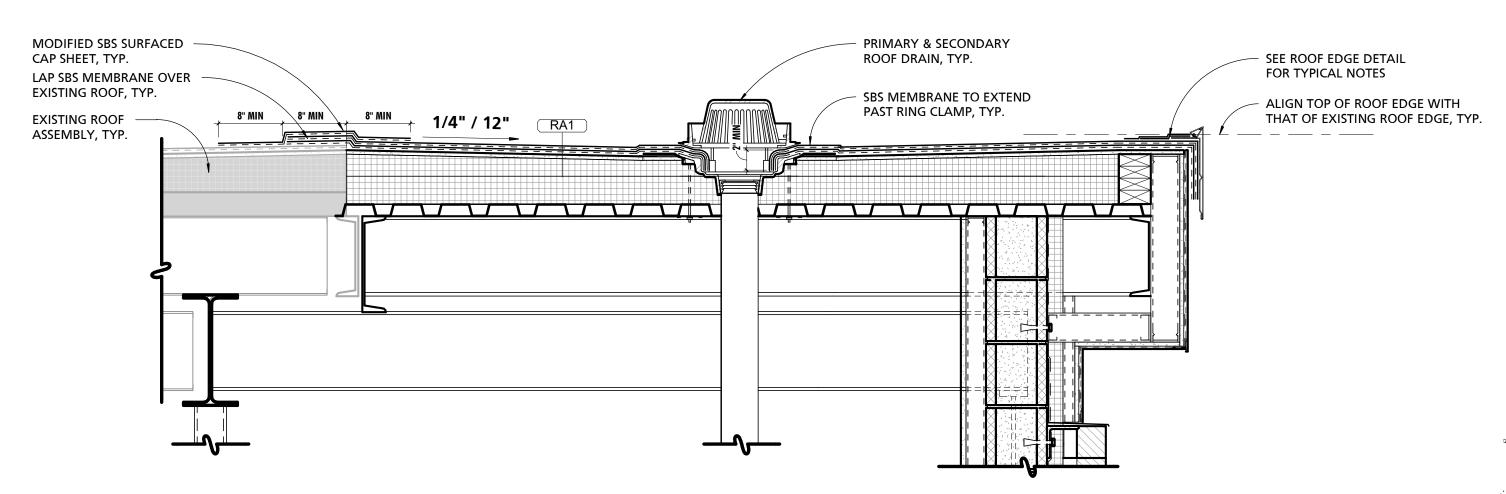

# **EXISTING TO NEW ROOF TRANSITION**

SUBDIVISION: FULLERTON

SEAL	PROFESSIONAL CERTIFICATION		AS-BUILT / RE	VISION	BY	DATE	P.W.A. NO.	KEY SHEET	POSITION SHT	DRAWIN	IG SCALE				
A WOOD W	311	I HEREBY CERTIFY THAT THESE DOCUME. APPROVED BY ME, AND THAT I AM A DULY		BID/PERN	ЛΙТ		09/20/24	-	MSW	27NE21	PLAN SCALE:	As indicated	APPROVED BY:	Mihai T. Petrisor	
		PROFESSIONAL ARCHITECT UNDER THE LA						R.O.W NO.	-	-				DIREC	CTOF
	MARYLAND. LICENSE NO. 15505 EXPIRATIO	N DATE: 08-18-2026	08-18-2026				-	] .	-	PROFILE SCALE:	-	DATE: 10/03/2024			
				<del>                               </del>								<del></del>			
		ARCHITECT:	DGN BY:	BUREAU OF ENGINEERING AND CONSTRUCTION		HIGH	HWAYS	STRUCTURES	STORM DRAINS	SEWER	WATER	FIELD ENGINEER	PROPE	ERTY MANAGEMENT	
A P. CHITECHIA	PRINCIPAL ARCHITECT  MANNS WOODWARD STUDIOS	DWN BY:	REVIEWED BY:									APPROVED BY:_			
10839-D PHILADELPHIA ROAD WHITE MARSH, MARYLAND 21162			CHKD BY:	DATE REVIEWED:									DATE:	C	CHIEF
DATE.		l`'			l	1			1				1 -	•	

BALTIMORE COUNTY OFFICE OF BUDGET AND FINANCE, PROPERTY MANAGEMENT

FULLERTON FIRE STATION #8 - RENOVATION & ADDITION

ROOF PLAN

4401 FITCH AVENUE, NOTTINGHAM, MARYLAND, 21236


A500

22221 PFO JOB ORDER NUMBER 241-220-0054-0012

SHEET DESIGNATION | CONTRACT NUMBER

ELECTION DIST. NO.: 14C5

SHEET 23 of 58 DRAWING NUMBER 2022-2341 FILE NO.: 8

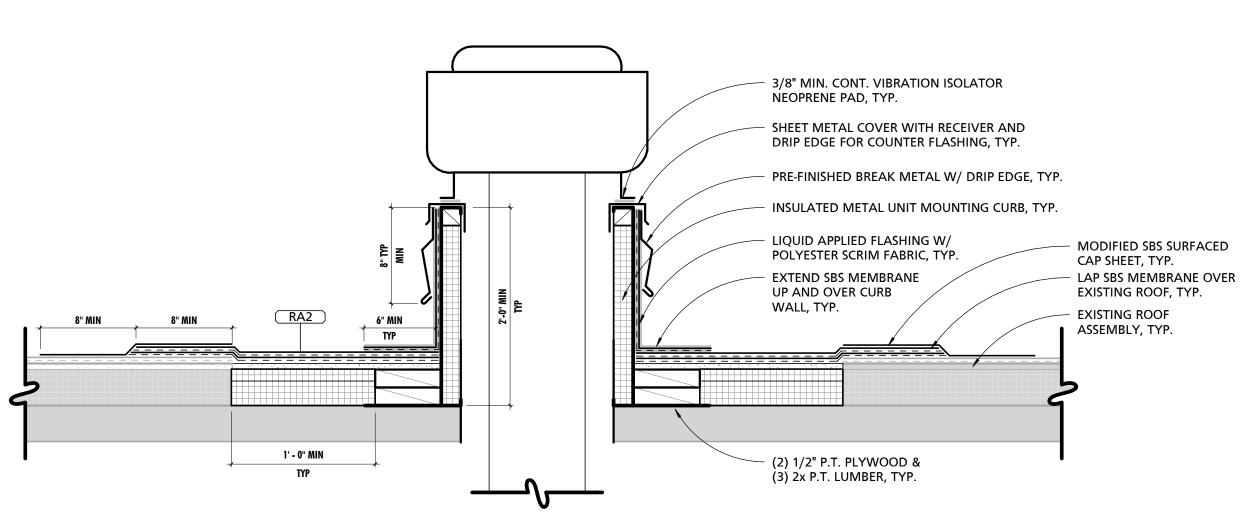

1 1/2" = 1'-0"

TYPICAL EXHAUST FAN PENETRATION DETAIL

SEALANT, TYP. -INSULATED 18 GA SHEET METAL ENCLOSURE-CROSSBREAK OR SLOPE —\_\_\_ SLOPE OF DRAINAGE, TYP. 18 GA PRE-FINISHED -SHEET METAL CHINK MINERAL WOOL COLLAR, TYP. AROUND PIPE WORK WITHIN ENCLOSURE, TYP. 18 GA SHEET METAL -FLASHING RECEIVER, TYP. 18 GA PRE-FINISHED METAL CAP W/ DRIP EDGE, TYP. PRE-FINISHED BREAK METAL **MECH EQUIPMENT** W/ DRIP EDGE, TYP. **18 GA INSULATED** METAL CURB, TYP. ASSEMBLY, TYP. 1' - 0" MIN

3 TYPICAL PIPE PORTAL & RAIL SUPPORT DETAIL
1 1/2" = 1'-0"

BY DATE P.W.A. NO. KEY SHEET POSITION SHT DRAWING SCALE AS-BUILT / REVISION PROFESSIONAL CERTIFICATION APPROVED BY: Mihai T. Petrisor
DIRECTOR I HEREBY CERTIFY THAT THESE DOCUMENTS WERE PREPARED OR APPROVED BY ME, AND THAT I AM A DULY LICENSED PROFESSIONAL ARCHITECT UNDER THE LAWS OF THE STATE OF BID/PERMIT PLAN SCALE: R.O.W NO. 10/03/2024 EXPIRATION DATE: 08-18-2026 BUREAU OF ENGINEERING AND CONSTRUCTION PROPERTY MANAGEMENT HIGHWAYS STRUCTURES STORM DRAINS SEWER WATER FIELD ENGINEER REVIEWED BY: MANNS WOODWARD STUDIOS 10839-D PHILADELPHIA ROAD WHITE MARSH, MARYLAND 21162 DATE REVIEWED:

BALTIMORE COUNTY OFFICE OF BUDGET AND FINANCE, PROPERTY MANAGEMENT

FULLERTON FIRE STATION #8 - RENOVATION & ADDITION

ROOF DETAILS

4401 FITCH AVENUE, NOTTINGHAM, MARYLAND, 21236

SHEET DESIGNATION	CONTRACT NUMBER
A501	22221 PFO
MORE C	JOB ORDER NUMBER
	241-220-0054-0012
\( \lambda \times \tim	SHEET 24 of 58
\ \ <b>~~~</b> *\\\ <b>\</b>	DRAWING NUMBER
MARY AND	2022-2342
	FILE NO · 8 REV.

ELECTION DIST. NO.: 14C5

054-0012 4 of 58 NUMBER

LIQUID APPLIED FLASHING W/ POLYESTER SCRIM FABRIC, TYP.

RA2

- LAP SBS MEMBRANE OVER EXISTING

ROOF, TYP.

SHEET, TYP.

MODIFIED SBS

SURFACED CAP

- EXISTING ROOF


ASSEMBLY, TYP.

2' - 0" MIN

(2) 1/2" P.T. PLYWOOD & (3) 2x P.T. LUMBER, TYP.

2 TYPICAL VENT PIPE PENETRATION DETAIL
1 1/2" = 1'-0"

SUBDIVISION: FULLERTON

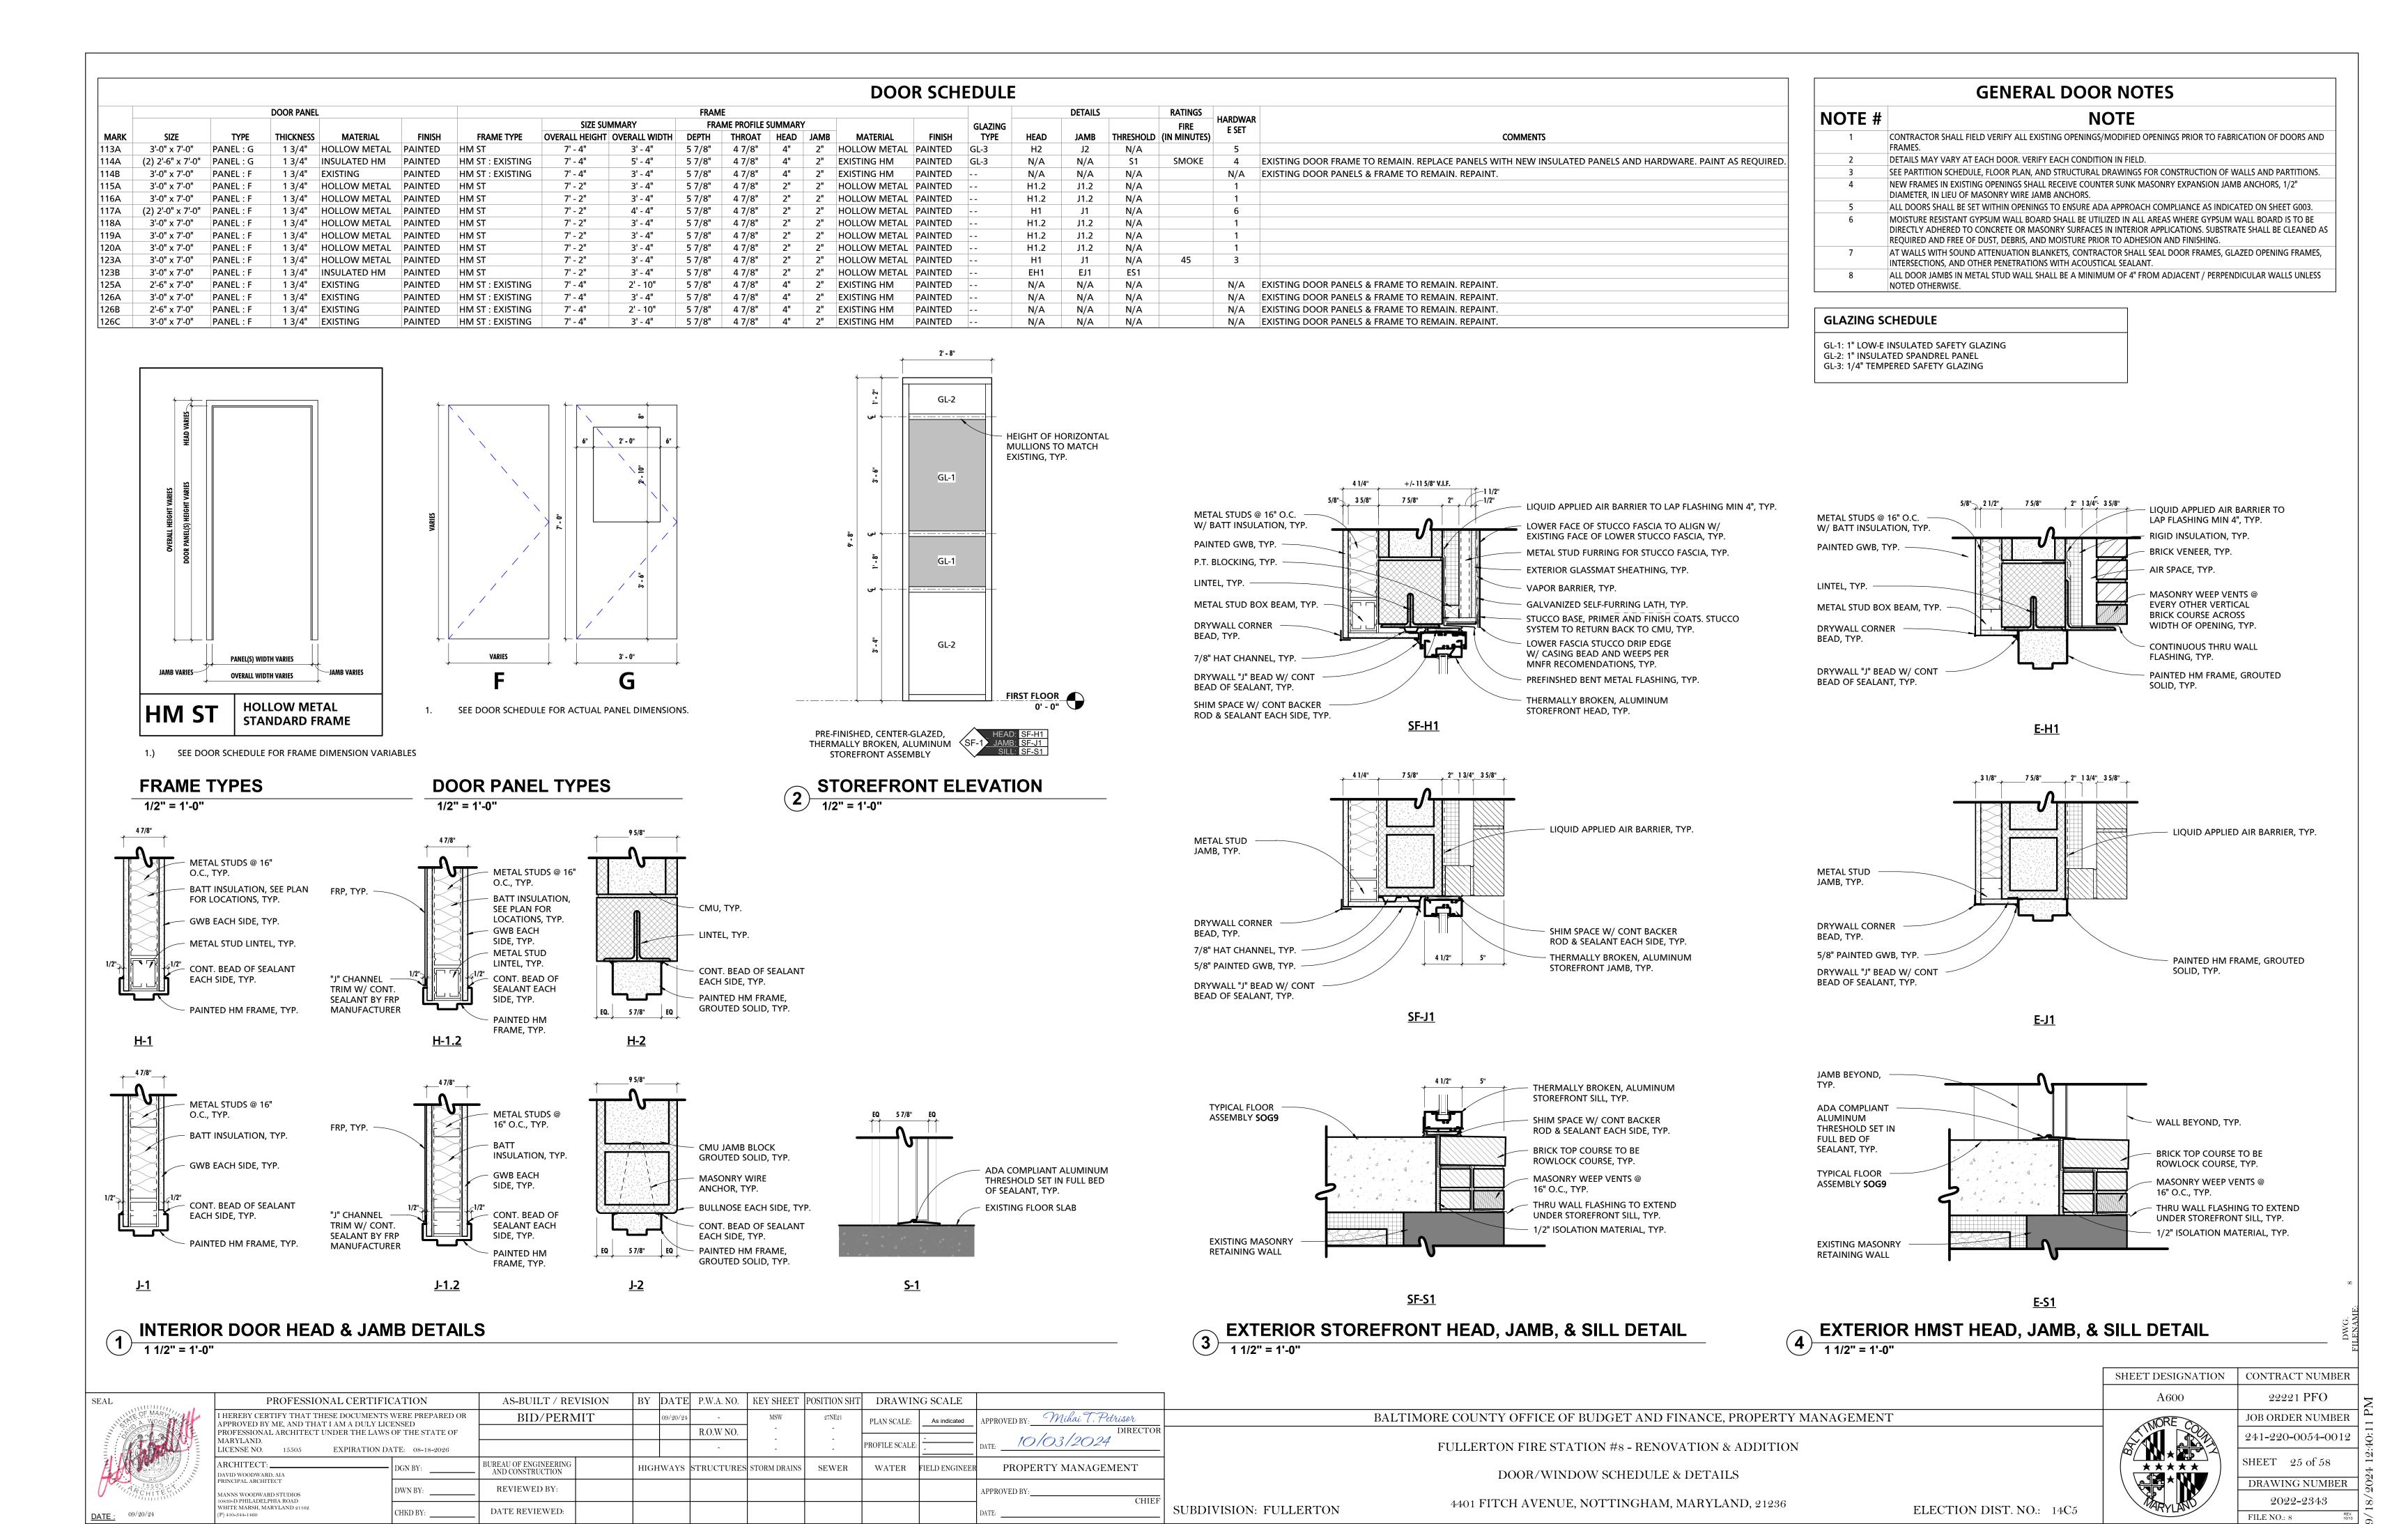

#### AS-BUILT / REVISION BY DATE P.W.A. NO. KEY SHEET POSITION SHT DRAWING SCALE PROFESSIONAL CERTIFICATION APPROVED BY: Mihai T. Petrisor I HEREBY CERTIFY THAT THESE DOCUMENTS WERE PREPARED OR BID/PERMIT PLAN SCALE: APPROVED BY ME, AND THAT I AM A DULY LICENSED PROFESSIONAL ARCHITECT UNDER THE LAWS OF THE STATE OF R.O.W NO. 10/03/2024 MARYLAND. PROFILE SCALE: LICENSE NO. 15505 EXPIRATION DATE: 08-18-2026 BUREAU OF ENGINEERING AND CONSTRUCTION PROPERTY MANAGEMENT HIGHWAYS STRUCTURES STORM DRAINS SEWER WATER FIELD ENGINEER DAVID WOODWARD, AIA PRINCIPAL ARCHITECT DWN BY: REVIEWED BY: APPROVED BY: MANNS WOODWARD STUDIOS 10839-D PHILADELPHIA ROAD WHITE MARSH, MARYLAND 21162 SUBDIVISION: FULLERTON

DATE REVIEWED:

BALTIMORE COUNTY OFFICE OF BUDGET AND FINANCE, PROPERTY MANAGEMENT

FULLERTON FIRE STATION #8 - RENOVATION & ADDITION

DOOR/WINDOW SCHEDULE & DETAILS

4401 FITCH AVENUE, NOTTINGHAM, MARYLAND, 21236

A601

SHEET DESIGNATION | CONTRACT NUMBER 22221 PFO JOB ORDER NUMBER 241-220-0054-0012 SHEET 26 of 58 DRAWING NUMBER

FILE NO.: 8

ELECTION DIST. NO.: 14C5

**DOOR HARDWARE SETS** 

Typical Single Occupant Toilet Room Door, (116A, 118A, 115A, 119A, 120A)

(1) Mortise Lockset, F02 Privacy function, with Occupancy Indicator

Bunk Single Door, W/ Panic Hardware & 45-Min. Fire Rated (123A)

Typical Interior Free Passage Single Door W/ Panic Hardware (113A)

Typical Interior Closet Double Door W/ Panic Hardware (117A)

(1) Mortise Exit Device, F01 Passage Function, exposed vertical rod less bottom rod, on

(1) Kick Plate, 1 1/2" LDW, on push side of door

(1) Mortise Lockset, F30 Storeroom Function

(1) Mortise Exit Device, F01 Passage Function

Interior Double Door, W/ Panic Hardware (114A)

(1) Mortise Exit Device, F01 Passage Function

(1) Automatic Flush Bolt, inactive leaf

HARDWARE SET 1

(3) Butt Hinges

(1) Surface Closer

(1) Door Sweep (1) Coat Hook

HARDWARE SET 2

(3) Butt Hinges

(1) Surface Closer (1) Wall-Mounted Stop (1) Perimeter Gasketing

HARDWARE SET 3

(3) Butt Hinges

(2) Kick Plate, 1 1/2" LDW (1) Wall-Mounted Stop (1) Perimeter Gasketing

(2) Surface Closer (4) Kick Plate, 1-1/2" LDW (2) Wall-Mounted Stop (1) Perimeter Gasketing (1) Meeting Stile Gasketing

HARDWARE SET 4

(6) Butt Hinges

HARDWARE SET 5

(3) Butt Hinges

(3) Silencers

HARDWARE SET 6

(1) Dust-Proof Strike

(1) Wall-Mounted Stop (1) Lever Door Holder (2) Kick Plate, 1 1/2" LDW

active leaf


(1) Closer


(1) Coat Hook

Office Single Door (122A)

(1) Wall-Mounted Stop (1) Perimeter Gasketing


(6) Butt Hinges (1) Manual Flush Bolts on inactive leaf (1) Mortise Lockset, F07 Passage Function, on active leaf (2) Lever Door Holder (2) Silencers

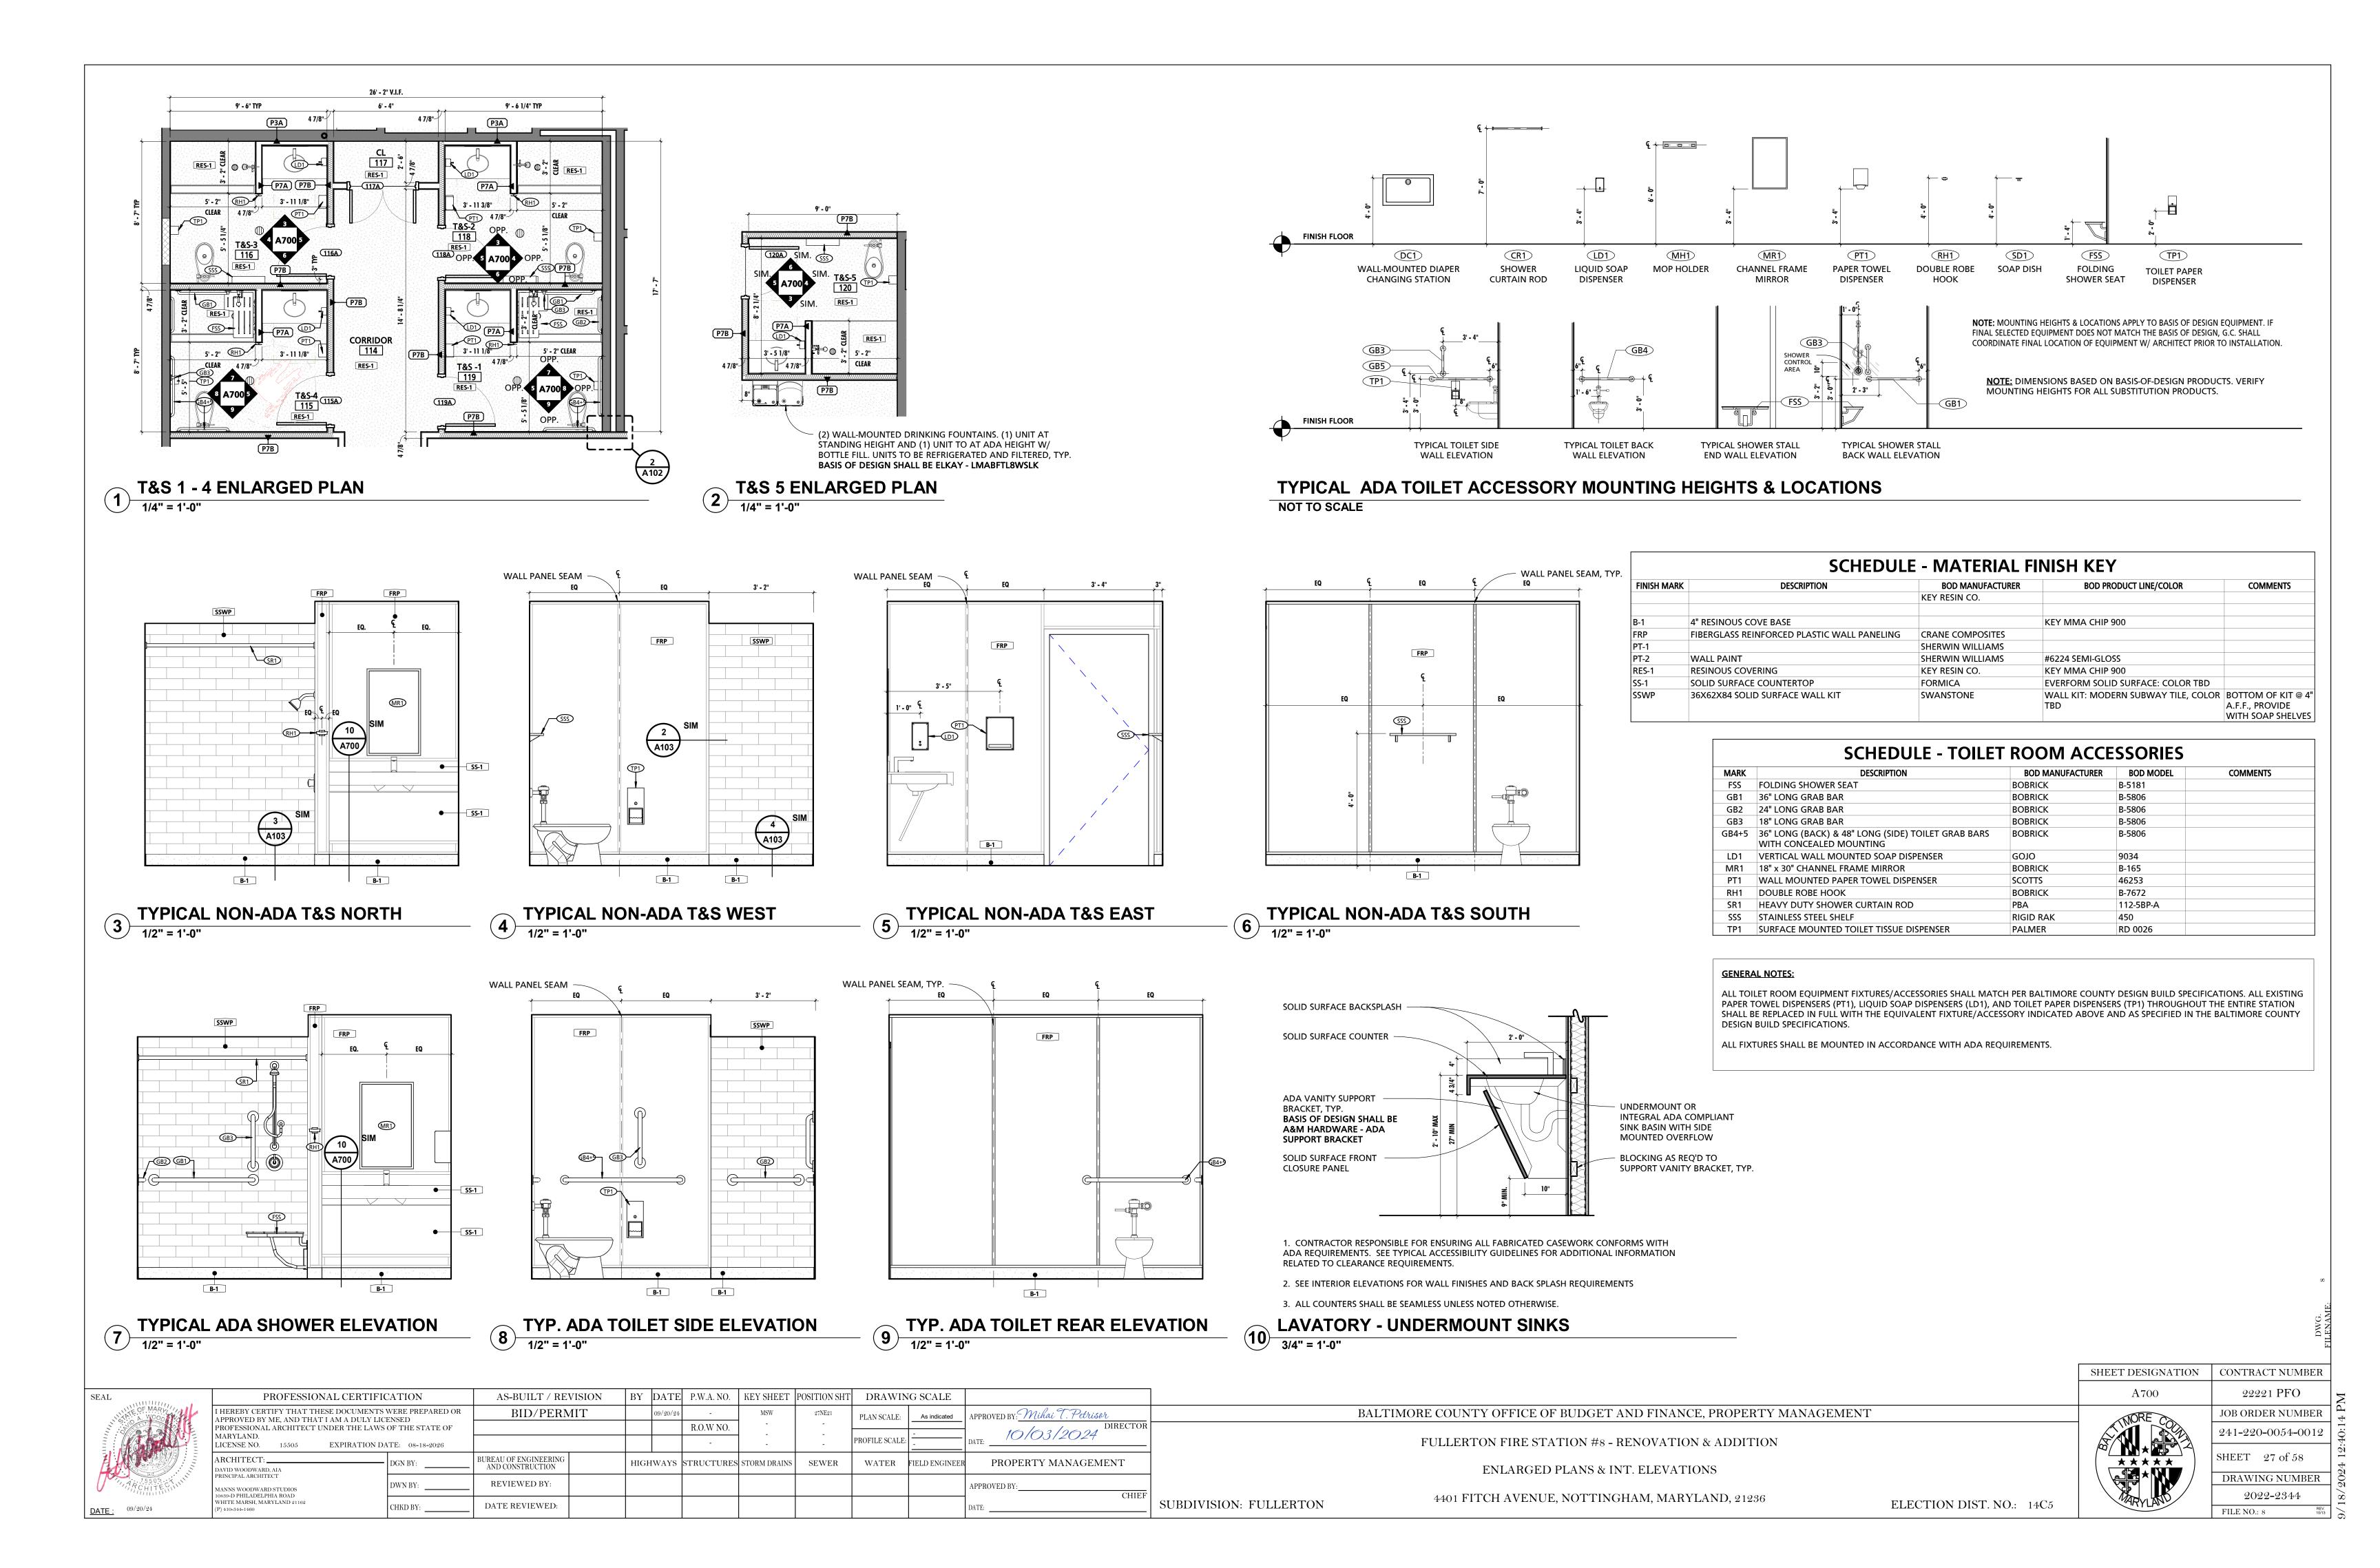

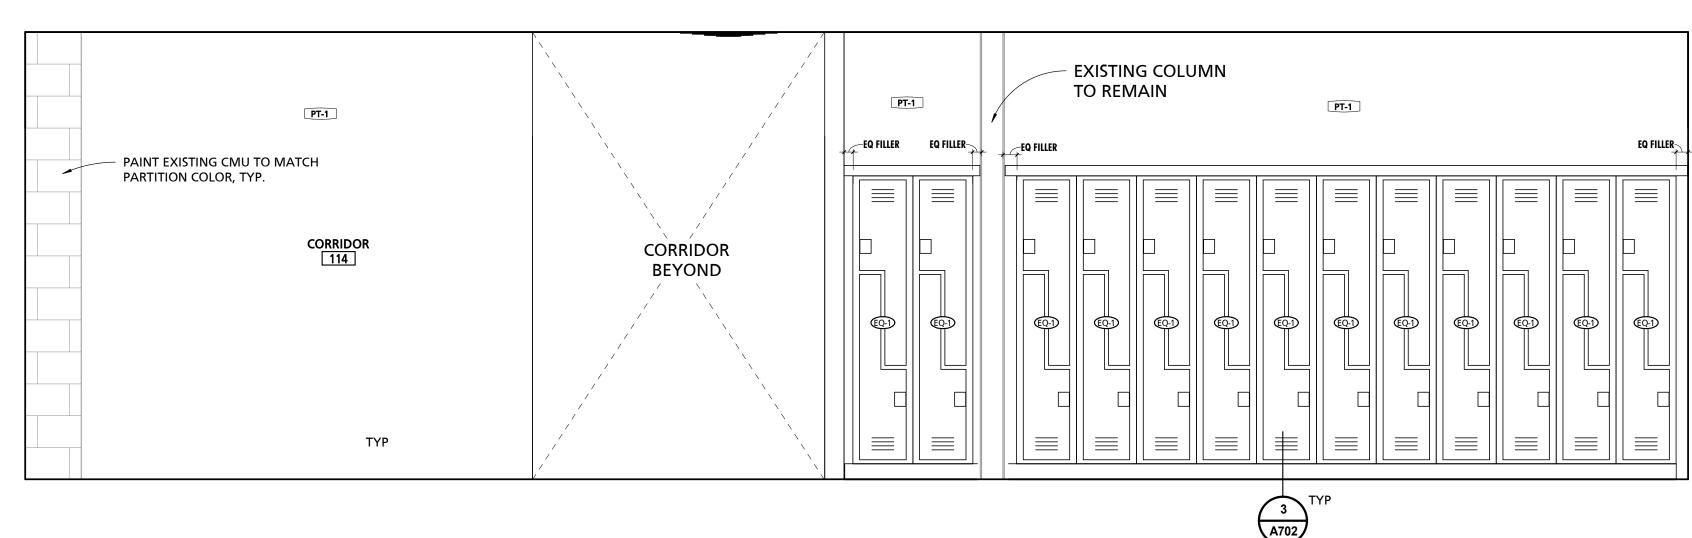

CORRIDOR SOUTH

1/2" = 1'-0"

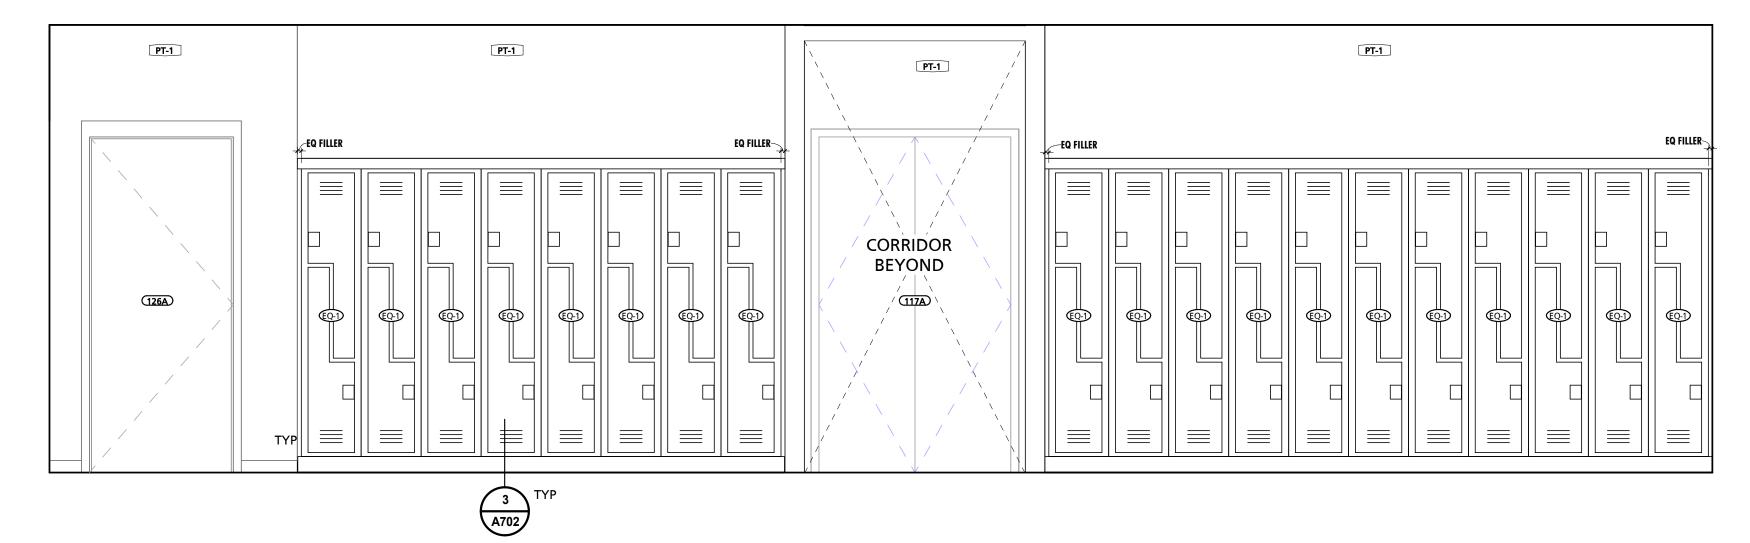

2 CORRIDOR NORTH

BY DATE P.W.A. NO. KEY SHEET POSITION SHT DRAWING SCALE AS-BUILT / REVISION PROFESSIONAL CERTIFICATION APPROVED BY: Mihai T. Petrisor I HEREBY CERTIFY THAT THESE DOCUMENTS WERE PREPARED OR BID/PERMIT PLAN SCALE: APPROVED BY ME, AND THAT I AM A DULY LICENSED
PROFESSIONAL ARCHITECT UNDER THE LAWS OF THE STATE OF R.O.W NO. 10/03/2024 MARYLAND. EXPIRATION DATE: 08-18-2026 LICENSE NO. 15505 BUREAU OF ENGINEERING AND CONSTRUCTION PROPERTY MANAGEMENT HIGHWAYS STRUCTURES STORM DRAINS SEWER WATER FIELD ENGINEER DWN BY: REVIEWED BY: APPROVED BY: 10839-D PHILADELPHIA ROAD WHITE MARSH, MARYLAND 21162 DATE REVIEWED: CHKD BY:

SUBDIVISION: FULLERTON


 SCHEDULE - EQUIPMENT

 MARK
 DESCRIPTION
 BOD MANUFACTURER
 BOD MODEL
 O.P.O.I.
 O.P.O.I.
 C.P.C.I.
 COMMENTS


 EQ-1
 15"W x 18"D x 72"H TWO-TIER SOLID PLASTIC LOCKER
 BRADLEY CORPORATION
 LENOX "Z" LOCKER
 ●
 PROVIDED WITH SLOPED TOP

 EQ-2
 MANUAL ROLLER SHADE
 HUNTER DOUGLAS
 RB-500 ROLLER SHADES
 ●
 PROVIDE BLACK-OUT BLINDS


FINISH MARK DESCRIPTION BOD MANUFACTURER BOD PRODUCT LINE/COLOR COMMENTS  B-1 4" RESINOUS COVE BASE KEY MMA CHIP 900  FRP FIBERGLASS REINFORCED PLASTIC WALL PANELING CRANE COMPOSITES SHERWIN WILLIAMS  PT-2 WALL PAINT SHERWIN WILLIAMS #6224 SEMI-GLOSS  RES-1 RESINOUS COVERING KEY RESIN CO. KEY MMA CHIP 900  SS-1 SOLID SURFACE COUNTERTOP FORMICA EVERFORM SOLID SURFACE: COLOR TBD							
FINISH MARK	DESCRIPTION	BOD MANUFACTURER	BOD PRODUCT LINE/COLOR	COMMENTS			
B-1	4" RESINOUS COVE BASE		KEY MMA CHIP 900				
FRP	FIBERGLASS REINFORCED PLASTIC WALL PANELING	CRANE COMPOSITES					
PT-1		SHERWIN WILLIAMS					
PT-2	WALL PAINT	SHERWIN WILLIAMS	#6224 SEMI-GLOSS				
RES-1	RESINOUS COVERING	KEY RESIN CO.	KEY MMA CHIP 900				
SS-1	SOLID SURFACE COUNTERTOP	FORMICA	EVERFORM SOLID SURFACE: COLOR TBD				
SSWP	36X62X84 SOLID SURFACE WALL KIT	SWANSTONE	WALL KIT: MODERN SUBWAY TILE, COLOR TBD	BOTTOM OF KIT @ A.F.F., PROVIDE WITH SOAP SHELVE			

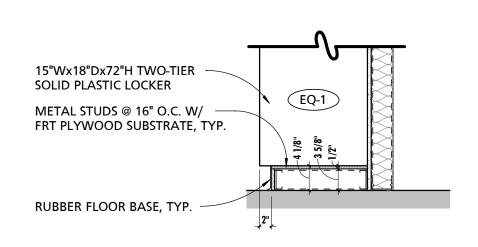

TYPICAL LOCKER BASE DETAIL

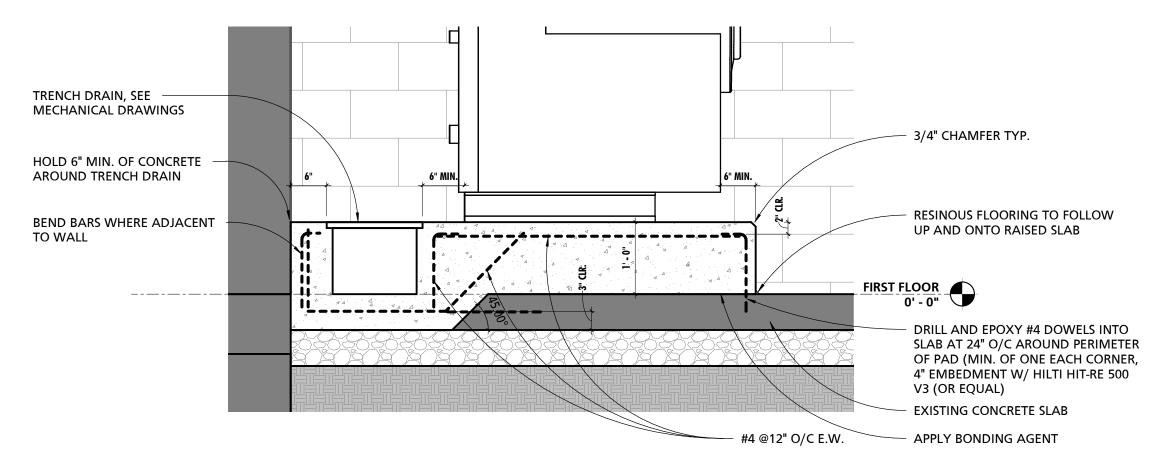

**EXTRACTOR CONCRETE PAD WITH TRENCH DRAIN**3/4" = 1'-0"

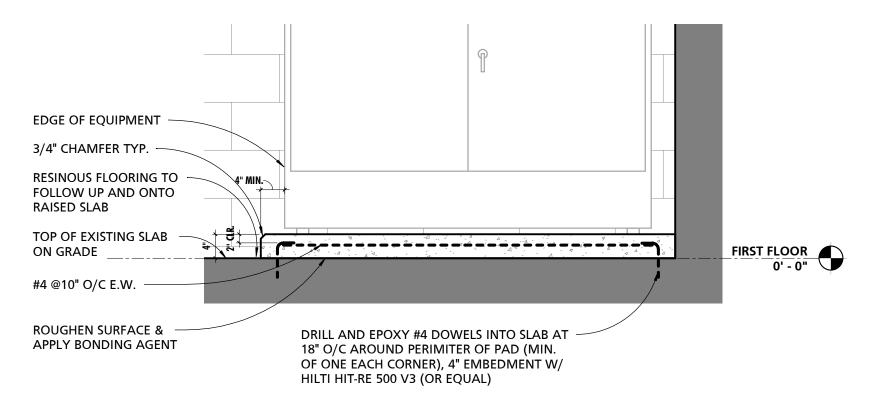


DRYING CABINET CONCRETE PAD

ALTIMORE COUNTY OFFICE OF BUDGET AND FINANCE, PROPERTY MANAGEMENT	
FULLERTON FIRE STATION #8 - RENOVATION & ADDITION	
INTERIOR ELEVATIONS	

4401 FITCH AVENUE, NOTTINGHAM, MARYLAND, 21236

ELECTION DIST. NO.: 14C5

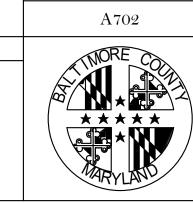

JOB ORDER NUMBER

241-220-0054-0012

SHEET 28 of 58


DRAWING NUMBER

2022-2345

FILE NO.: 8


22221 PFO

SHEET DESIGNATION | CONTRACT NUMBER

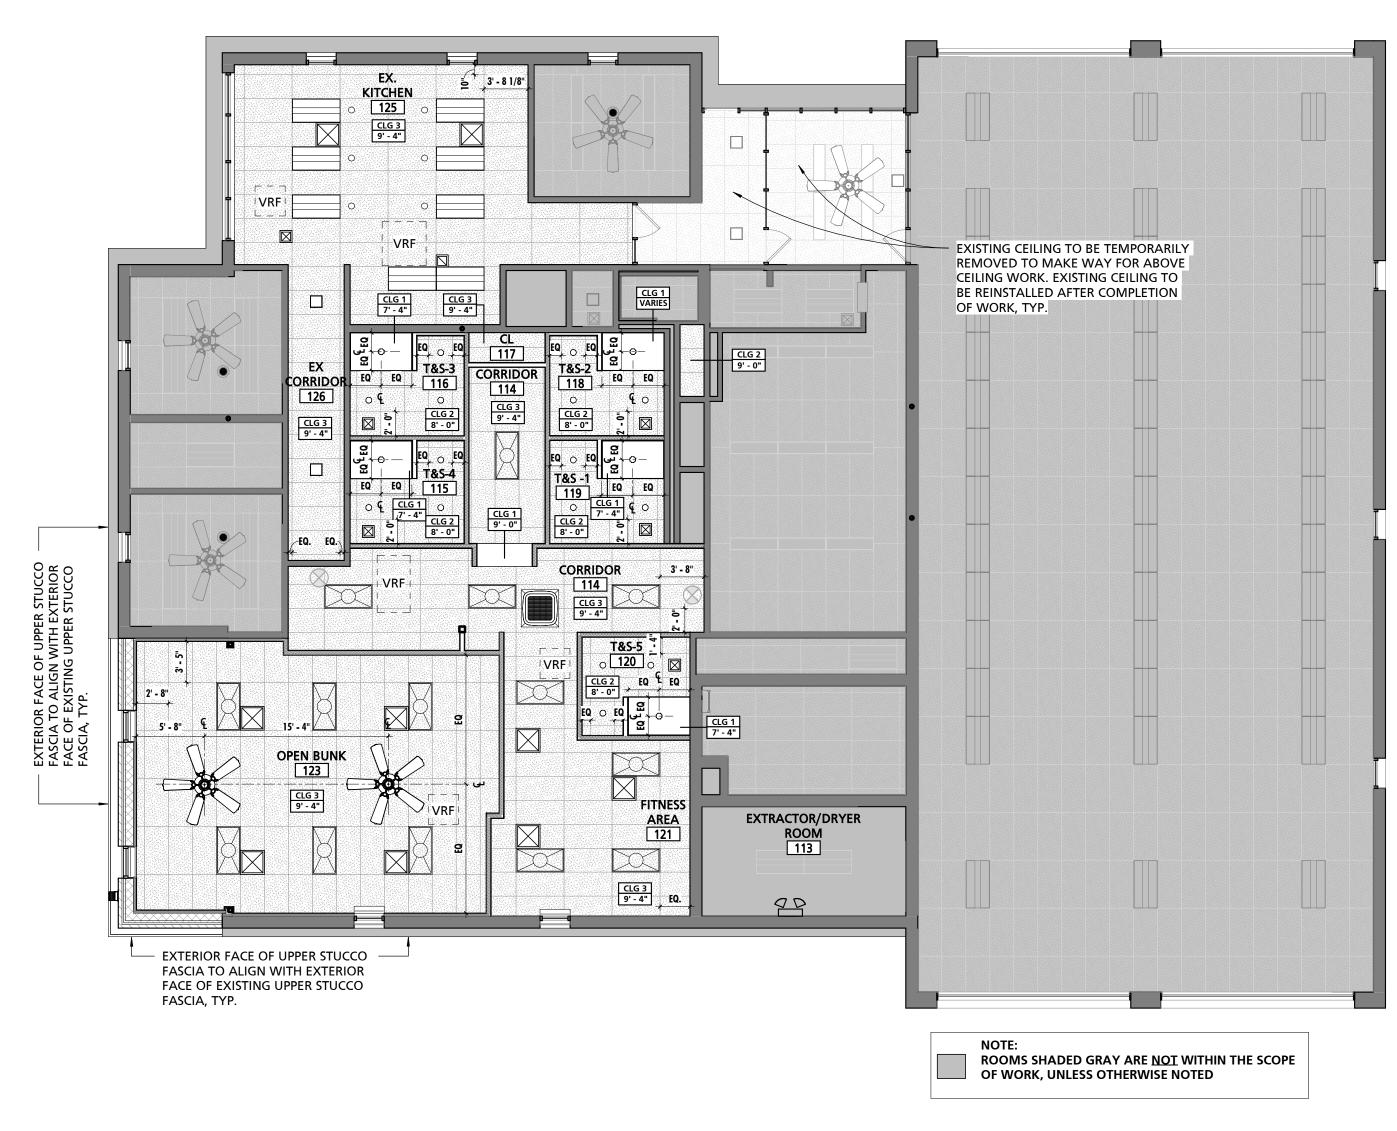

### REFLECTED CEILING PLAN

1/8" = 1'-0

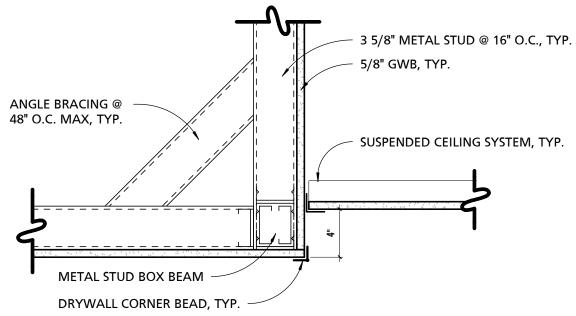

TYPICAL BULKHEAD DETAIL

1 1/2" = 1'-0"

SEAL	PROFESSIONAL CERTIFICATION		AS-BUILT / RE	VISION	BY	DATE	P.W.A. NO.	KEY SHEET	POSITION SHT	DRAWIN	NG SCALE	
OF MARY			BID/PERN	ЛІТ		09/20/24	-	MSW	27NE21	PLAN SCALE:	As indicated	APPROVED BY: Mihai T. Petrisor
	PROFESSIONAL ARCHITECT UNDER THE LAWS						R.O.W NO.	-				DIREC
		ATE: 08-18-2026					-	] .	-	PROFILE SCALE	-	DATE: 10/03/2024
	ARCHITECT:	DGN BY:	BUREAU OF ENGINEERING AND CONSTRUCTION		HIGH	IWAYS	STRUCTURES	STORM DRAINS	SEWER	WATER	FIELD ENGINEER	PROPERTY MANAGEMENT
ARCHITECHIN	MANNS WOODWARD STUDIOS	DWN BY:	REVIEWED BY:									APPROVED BY:
DATE: 09/20/24	10839-D PHILADELPHIA ROAD WHITE MARSH, MARYLAND 21162 (P) 410-344-1460		DATE REVIEWED:									DATE:
	OF MARY WOOD 15505 C	I HEREBY CERTIFY THAT THESE DOCUMENTS APPROVED BY ME, AND THAT I AM A DULY LIC PROFESSIONAL ARCHITECT UNDER THE LAWS MARYLAND. LICENSE NO. 15505 EXPIRATION D  ARCHITECT:  DAVID WOODWARD, AIA PRINCIPAL ARCHITECT  MANNS WOODWARD STUDIOS 10839-D PHILADELPHIA ROAD WHITE MARSH, MARYLAND 21162	I HEREBY CERTIFY THAT THESE DOCUMENTS WERE PREPARED OR APPROVED BY ME, AND THAT I AM A DULY LICENSED PROFESSIONAL ARCHITECT UNDER THE LAWS OF THE STATE OF MARYLAND.  LICENSE NO. 15505 EXPIRATION DATE: 08-18-2026  ARCHITECT:  DAVID WOODWARD, AIA PRINCIPAL ARCHITECT  MANNS WOODWARD STUDIOS 10839-D PHILADELPHIA ROAD WHITE MARSH, MARYLAND 21162  CHEED BY  CH	I HEREBY CERTIFY THAT THESE DOCUMENTS WERE PREPARED OR APPROVED BY ME, AND THAT I AM A DULY LICENSED PROFESSIONAL ARCHITECT UNDER THE LAWS OF THE STATE OF MARYLAND. LICENSE NO. 15505 EXPIRATION DATE: 08-18-2026  ARCHITECT:  DAVID WOODWARD, AIA PRINCIPAL ARCHITECT  MANNS WOODWARD STUDIOS 10839-D PHILADELPHIA ROAD WHITE MARSH, MARYLAND 21162  DELIVER DELIVER OR  BID/PERM BUREAU OF ENGINEERING AND CONSTRUCTION  DWN BY:  REVIEWED BY:  DATE REVIEWED:	I HEREBY CERTIFY THAT THESE DOCUMENTS WERE PREPARED OR APPROVED BY ME, AND THAT I AM A DULY LICENSED PROFESSIONAL ARCHITECT UNDER THE LAWS OF THE STATE OF MARYLAND. LICENSE NO. 15505 EXPIRATION DATE: 08-18-2026  ARCHITECT:  DAVID WOODWARD, AIA PRINCIPAL ARCHITECT  MANNS WOODWARD STUDIOS 10839-D PHILADELPHIA ROAD WHITE MARSH, MARYLAND 21162  DATE REVIEWED BY:  DATE REVIEWED:	I HEREBY CERTIFY THAT THESE DOCUMENTS WERE PREPARED OR APPROVED BY ME, AND THAT I AM A DULY LICENSED PROFESSIONAL ARCHITECT UNDER THE LAWS OF THE STATE OF MARYLAND. LICENSE NO. 15505 EXPIRATION DATE: 08-18-2026  ARCHITECT:  DAVID WOODWARD, AIA PRINCIPAL ARCHITECT  MANNS WOODWARD STUDIOS 10839-D PHILADELPHIA ROAD WHITE MARSH, MARYLAND 21162  DATE REVIEWED BY:  DATE REVIEWED:	I HEREBY CERTIFY THAT THESE DOCUMENTS WERE PREPARED OR APPROVED BY ME, AND THAT I AM A DULY LICENSED PROFESSIONAL ARCHITECT UNDER THE LAWS OF THE STATE OF MARYLAND. LICENSE NO. 15505 EXPIRATION DATE: 08-18-2026  ARCHITECT:  DAVID WOODWARD, AIA PRINCIPAL ARCHITECT  MANDS WOODWARD STUDIOS 10839-D PHILADELPHIA ROAD WHITE MARSH, MARYLAND 21162  DATE REVIEWED  DATE REVIEWED:	I HEREBY CERTIFY THAT THESE DOCUMENTS WERE PREPARED OR APPROVED BY ME, AND THAT I AM A DULY LICENSED PROFESSIONAL ARCHITECT UNDER THE LAWS OF THE STATE OF MARYLAND. LICENSE NO. 15505 EXPIRATION DATE: 08-18-2026  ARCHITECT: DAVID WOODWARD, AIA PRINCIPAL ARCHITECT  MANNS WOODWARD STUDIOS 10839-D PHILADELPHIA ROAD WHITE MARSH, MARYLAND 21162  DATE REVIEWED BY:  DATE REVIEWED:	I HEREBY CERTIFY THAT THESE DOCUMENTS WERE PREPARED OR APPROVED BY ME, AND THAT I AM A DULY LICENSED PROFESSIONAL ARCHITECT UNDER THE LAWS OF THE STATE OF MARYLAND. LICENSE NO. 15505 EXPIRATION DATE: 08-18-2026  ARCHITECT: DAVID WOODWARD, AIA PRINCIPAL ARCHITECT  MANNS WOODWARD STUDIOS 10839-D PHILADELPHIA ROAD WHITE MARSH, MARYLAND 21162  DWN BY: DATE REVIEWED BY: DATE REVIEWED: DATE REVIEWED:	I HEREBY CERTIFY THAT THESE DOCUMENTS WERE PREPARED OR APPROVED BY ME, AND THAT I AM A DULY LICENSED PROFESSIONAL ARCHITECT UNDER THE LAWS OF THE STATE OF MARYLAND.  LICENSE NO. 15505 EXPIRATION DATE: 08-18-2026  ARCHITECT:  DAVID WOODWARD, AIA PRINCIPAL ARCHITECT  MANNS WOODWARD, AIA PRINCIPAL ARCHITECT  MANNS WOODWARD STUDIOS 10839-D PHILADELPHIA ROAD WHITE MARSH, MARYLAND 21102  OF MARY MARYLAND 21102  BID/PERMIT  09/20/24  - MSW 27NE21  R.O.W NO.	I HEREBY CERTIFY THAT THESE DOCUMENTS WERE PREPARED OR APPROVED BY ME, AND THAT I AM A DULY LICENSED PROFESSIONAL ARCHITECT UNDER THE LAWS OF THE STATE OF MARYLAND.  LICENSE NO. 15505 EXPIRATION DATE: 08-18-2026  ARCHITECT:  DAVID WOODWARD, AIA PRINCIPAL ARCHITECT  MANNS WOODWARD, AIA PRINCIPAL ARCHITECT  MANNS WOODWARD, AIA PRINCIPAL ARCHITECT  DAVID WOODWARD, AIA PRINCIPAL ARCHITECT  MANNS WOODWARD, AIA PRINCIPAL ARCHITECT  DWN BY:  REVIEWED BY:  DATE REVIEWED BY:	I HEREBY CERTIFY THAT THESE DOCUMENTS WERE PREPARED OR APPROVED BY ME, AND THAT I AM A DULY LICENSED PROFESSIONAL ARCHITECT UNDER THE LAWS OF THE STATE OF MARYLAND. LICENSE NO. 15505 EXPIRATION DATE: 08-18-2026  ARCHITECT:  DAVID WOODWARD, AIA PRINCIPAL ARCHITECT  MANNS WOODWARD, AIA PRINCIPAL ARCHITECT  MANNS WOODWARD STUDIOS 10838-D PHILADELPHIA ROAD WHITE MARSH, MARYLAND 21162  DATE REVIEWED BY:  DATE REVIEWED BY:  DATE REVIEWED BY:  DATE REVIEWED BY:

**GENERAL CEILING NOTES** 

NOTE

CONTRACTOR SHALL COORDINATE FINAL FIELD LOCATION OF ALL EXIT SIGNS AND EMERGENCY LIGHTING WITH ARCHITECT PRIOR TO ROUGH-IN, TYP.

ON ACT CEILINGS IN FIRE-RATED AREAS INSTALL HOLD DOWN CLIPS ON ACOUSTIC PANELS WEIGHING LESS THAN 1 LB. PER SQ. FT. PER SPEC.

ALL MECHANICAL, ELECTRICAL AND PLUMBING WORK TO OCCUR IN AREAS WHERE THE STRUCTURE IS EXPOSED SHALL BE EXECUTED IN A COORDINATED, NEAT AND WORKMANLIKE MANNER. AT A MINIMUM ALL WIRING SHALL BE RUN THOUGH CONDUITS, PIPE AND DUCT INSULATION SHALL BE NEATLY INSTALLED AND PARALLEL TO WALL CONSTRUCTION AND SHALL BE INSTALLED AT THE SAME NOMINAL ELEVATION OR SLOPE. ALL MATERIALS AND INSTALLATION METHODS SHALL COMPLY WITH APPLICABLE

CODES AND STANDARDS. WHERE MECHANICAL, ELECTRICAL, AND PLUMBING DRAWINGS INDICATE OTHER REQUIREMENTS THE GREATER QUALITY SHALL PREVAIL.

4 CONTRACTOR SHALL COORDINATE THE COLOR AND FINISH OF ALL CEILING MOUNTED EQUIPMENT SUCH AS DIFFUSERS, RETURNS, SPEAKERS, ETC. WITH THE ARCHITECT TO ENSURE THERE ARE NO STARK CONTRASTING COLORS.

WHERE ACT GRID LAYOUT AT EDGE CONDITIONS FOR 2X2 TILES REQUIRE TILES TO BE CUT TO LESS THAN 3", UTILIZE A 2X4 TILE IN LIEU OF THE 2X2 TILE. OMIT CEILING GRID CROSS MEMBERS AS REQUIRED. NO TILE SHALL EXCEED 27" OR BE LESS THAN 3" AT PERIMETER CONDITIONS. IT IS THE CONTRACTORS RESPONSIBILITY TO COORDINATE GRID MAINS AS REQUIRED TO ACHIEVE THIS DESIGN INTENT.

	SCHEDULE - CEILING TYPES										
MARK	DESCRIPTION	BOD MANUFACTURER	BOD MODEL	COMMENTS							
CLG 1	5/8" GWB ON 1 1/2" DRYWALL GRID	ARMSTRONG DRYV	WALL GRID SYSTEM								
CLG 2	2x2 WASHABLE CEILING TILE	ARMSTRONG ULTI	MA HEALTH ZONE								
CLG 3	2x4 ACOUSTICAL CEILING TILE	ARMSTRONG FISSU	JRED 895								

SHEET DESIGNATION CONTRACT NUMBER

A800 22221 PFO

JOB ORDER NUMBER


FULLERTON FIRE STATION #8 - RENOVATION & ADDITION


BALTIMORE COUNTY OFFICE OF BUDGET AND FINANCE, PROPERTY MANAGEMENT

REFLECTED CEILING PLAN

4401 FITCH AVENUE, NOTTINGHAM, MARYLAND, 21236

SUBDIVISION: FULLERTON

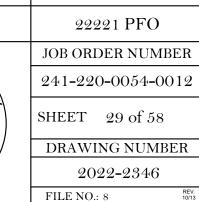

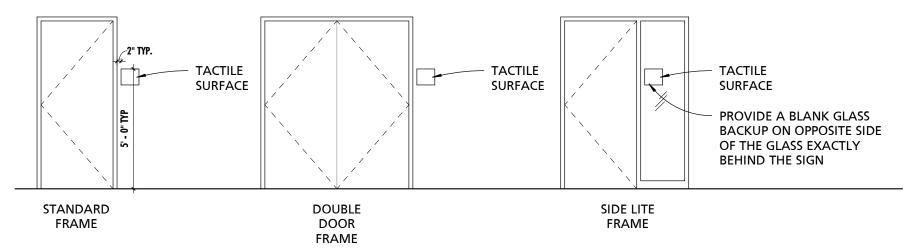


#### **PROVIDE SIGNAGE AT ALL OF THE FOLLOWING LOCATIONS:**

- 1. ADA COMPLIANT IDENTIFICATION ROOM SIGNAGE WITH REMOVABLE INSERT AT ALL ROOMS OTHER THAN MECHANICAL ROOMS AND TOILET ROOMS. SIGNS SHALL INDICATE ROOM NUMBER AND PROVIDE REMOVABLE INSERT FOR ROOM NAMES.
- ADA COMPLIANT IDENTIFICATION ROOM SIGNAGE AT MECHANICAL ROOMS AND TOILET ROOMS. SINGLE OCCUPANT TOILET ROOMS SHALL BE IDENTIFIED AS UNI-SEX.
- ADA COMPLIANT IDENTIFICATION EXIT SIGNAGE AT ALL DOORS LEADING TO RATED EXITS.
- 4. ADA COMPLIANT IDENTIFICATION FLOOR LEVEL SIGNAGE AT ALL FLOOR LANDINGS OF STAIRS AND RAMPS.

### **ADA SIGNAGE MOUNTING LOCATIONS**

(1) 1/4" = 1'-0"

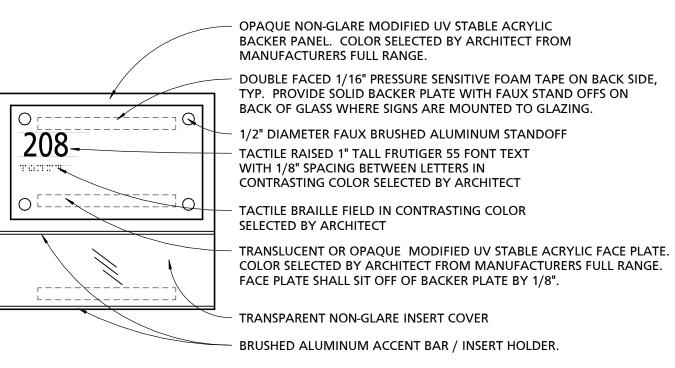

#### TYPICAL ROOM IDENTIFICATION SIGNAGE



1/2" DIAMETER FAUX BRUSHED ALUMINUM STANDOFF DOUBLE FACED 1/16" PRESSURE SENSITIVE FOAM TAPE ON BACK SIDE, TYP. PROVIDE SOLID BACKER PLATE WITH FAUX STAND OFFS ON BACK OF GLASS WHERE SIGNS ARE MOUNTED TO GLAZING.

OPAQUE NON-GLARE MODIFIED UV STABLE ACRYLIC BACKER PANEL. COLOR SELECTED BY ARCHITECT FROM MANUFACTURERS FULL RANGE.


TACTILE RAISED PICTOGRAM AS APPROPRIATE FOR

SIGNAGE LOCATION. TRANSLUCENT OR OPAQUE MODIFIED UV STABLE ACRYLIC FACE PLATE.

COLOR SELECTED BY ARCHITECT FROM MANUFACTURERS FULL RANGE. FACE PLATE SHALL SIT OFF OF BACKER PLATE BY 1/8". TACTILE RAISED 1" TALL FRUTIGER 55 FONT TEXT WITH 1/8" SPACING BETWEEN LETTERS IN CONTRASTING COLOR SELECTED BY ARCHITECT

TACTILE BRAILLE FIELD IN CONTRASTING COLOR SELECTED BY ARCHITECT

TYPICAL RESTROOM SIGN 2 TYPICAL SIGNAGE DETAILS
3" = 1'-0"

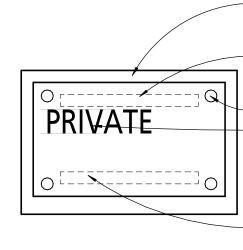


OPAQUE NON-GLARE MODIFIED UV STABLE ACRYLIC BACKER PANEL. COLOR SELECTED BY ARCHITECT FROM MANUFACTURERS FULL RANGE.

DOUBLE FACED 1/16" PRESSURE SENSITIVE FOAM TAPE ON BACK SIDE, TYP. PROVIDE SOLID BACKER PLATE WITH FAUX STAND OFFS ON BACK OF GLASS WHERE SIGNS ARE MOUNTED TO GLAZING.

1/2" DIAMETER FAUX BRUSHED ALUMINUM STANDOFF TACTILE RAISED 1" TALL FRUTIGER 55 FONT TEXT WITH 1/8" SPACING BETWEEN LETTERS IN CONTRASTING COLOR SELECTED BY ARCHITECT

TRANSLUCENT OR OPAQUE MODIFIED UV STABLE ACRYLIC FACE PLATE. COLOR SELECTED BY ARCHITECT FROM MANUFACTURERS FULL RANGE. FACE PLATE SHALL SIT OFF OF BACKER PLATE BY 1/8".

#### TYPICAL INFORMATIONAL SIGNAGE

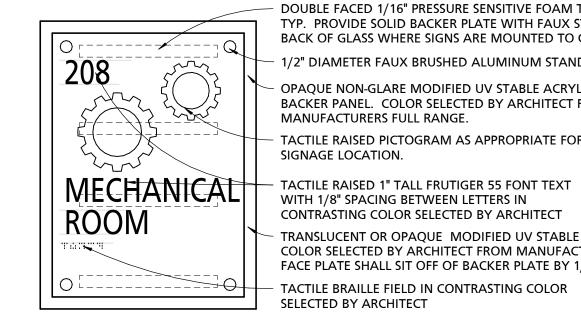

DOUBLE FACED 1/16" PRESSURE SENSITIVE FOAM TAPE ON BACK SIDE, TYP. PROVIDE SOLID BACKER PLATE WITH FAUX STAND OFFS ON BACK OF GLASS WHERE SIGNS ARE MOUNTED TO GLAZING. 1/2" DIAMETER FAUX BRUSHED ALUMINUM STANDOFF

OPAQUE NON-GLARE MODIFIED UV STABLE ACRYLIC BACKER PANEL. COLOR SELECTED BY ARCHITECT FROM MANUFACTURERS FULL RANGE.

TACTILE RAISED PICTOGRAM AS APPROPRIATE FOR

SIGNAGE LOCATION.

CONTRASTING COLOR SELECTED BY ARCHITECT TRANSLUCENT OR OPAQUE MODIFIED UV STABLE ACRYLIC FACE PLATE. COLOR SELECTED BY ARCHITECT FROM MANUFACTURERS FULL RANGE. FACE PLATE SHALL SIT OFF OF BACKER PLATE BY 1/8".

SUBDIVISION: FULLERTON

TACTILE BRAILLE FIELD IN CONTRASTING COLOR SELECTED BY ARCHITECT

### TYPICAL UTILITY ROOM / STAIRWAY SIGN

MIIIII.	PROFESSIONAL CERTIFIC	CATION	AS-BUILT / REV	AS-BUILT / REVISION		DATE	P.W.A. NO.	KEY SHEET	POSITION SHT	DRAWIN	G SCALE			
NO COM TO STANK	I HEREBY CERTIFY THAT THESE DOCUMENTS APPROVED BY ME, AND THAT I AM A DULY LIC		BID/PERM	ſΙΤ		09/20/24	-	MSW	27NE21	PLAN SCALE:	As indicated	APPROVED BY:	Mihai T. Petrisi	or
PR MALIC AR DAY PRI MA:	PROFESSIONAL ARCHITECT UNDER THE LAWS						R.O.W NO.	-	-			16	100/0001	DIRECTO
	MARYLAND. LICENSE NO. 15505 EXPIRATION D.	ATE: 08-18-2026					-	] [	-	PROFILE SCALE:	-	DATE: 10/03/2024		
	ARCHITECT:	DGN BY:	BUREAU OF ENGINEERING AND CONSTRUCTION		HIGH	IWAYS	STRUCTURES	STORM DRAINS	SEWER	WATER	FIELD ENGINEER	PROPER	TY MANAGEMI	ENT
	PRINCIPAL ARCHITECT  MANNS WOODWARD STUDIOS 10839-D PHILADELPHIA ROAD	DWN BY:	REVIEWED BY:									APPROVED BY:		CHIE
20/20/21	10839-D PHILADELPHIA ROAD WHITE MARSH, MARYLAND 21162 (P) 410-344-1460	CHKD BY:	DATE REVIEWED:									DATE:		CHIE

BALTIMORE COUNTY OFFICE OF BUDGET AND FINANCE, PROPERTY MANAGEMENT

FULLERTON FIRE STATION #8 - RENOVATION & ADDITION


TYPICAL ADA SIGNAGE DETAILS


4401 FITCH AVENUE, NOTTINGHAM, MARYLAND, 21236


A900

ELECTION DIST. NO.: 14C5

SHEET DESIGNATION | CONTRACT NUMBER 22221 PFO JOB ORDER NUMBER 241-220-0054-0012 SHEET 30 of 58 DRAWING NUMBER 2022-2347 FILE NO.: 8

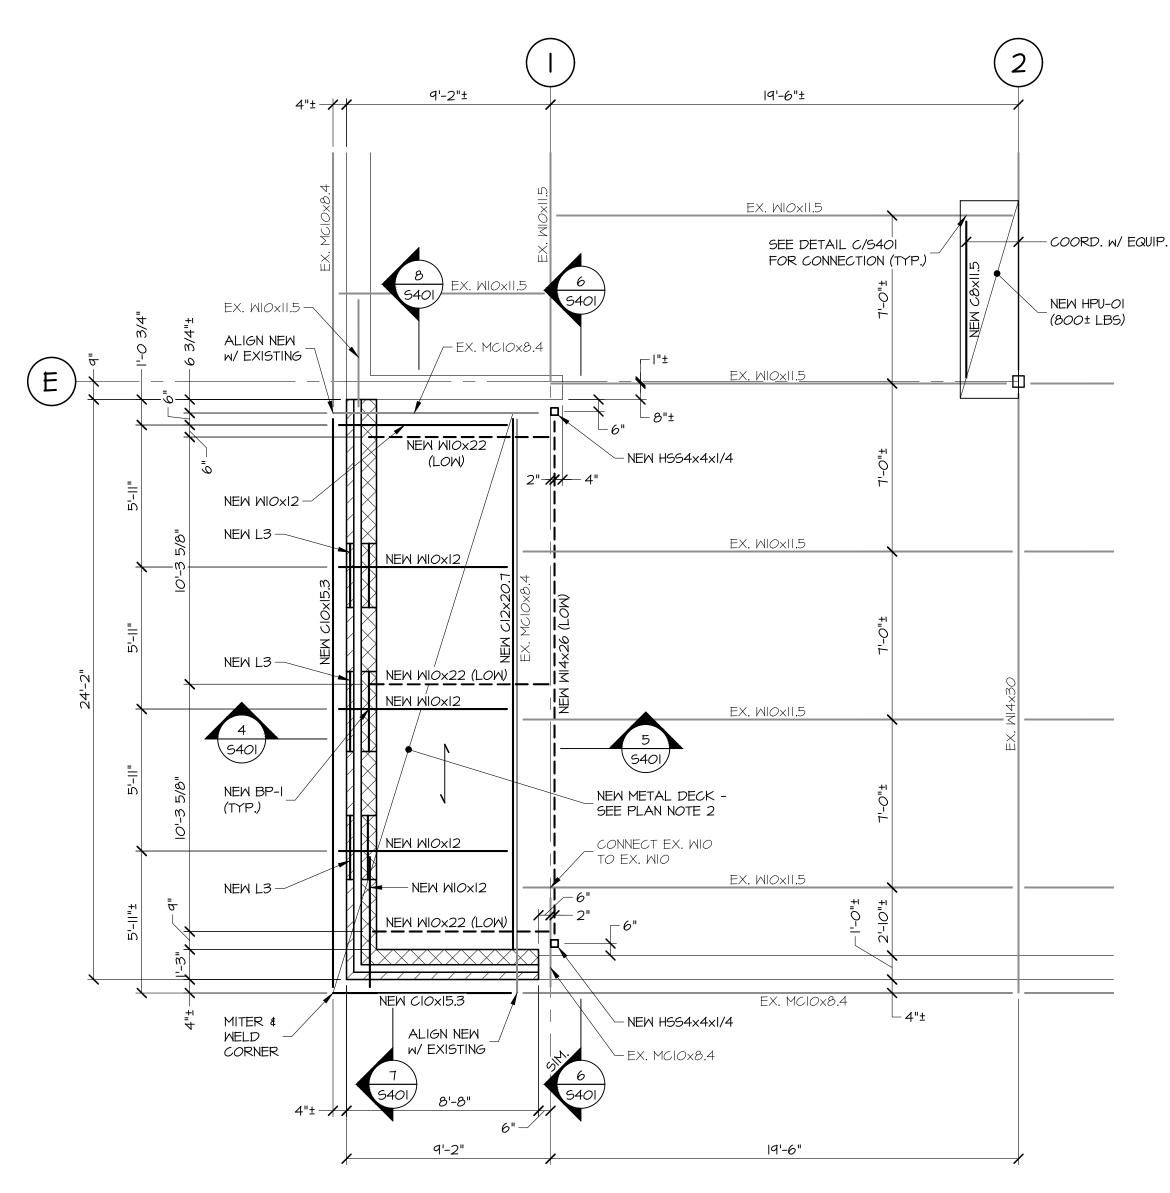

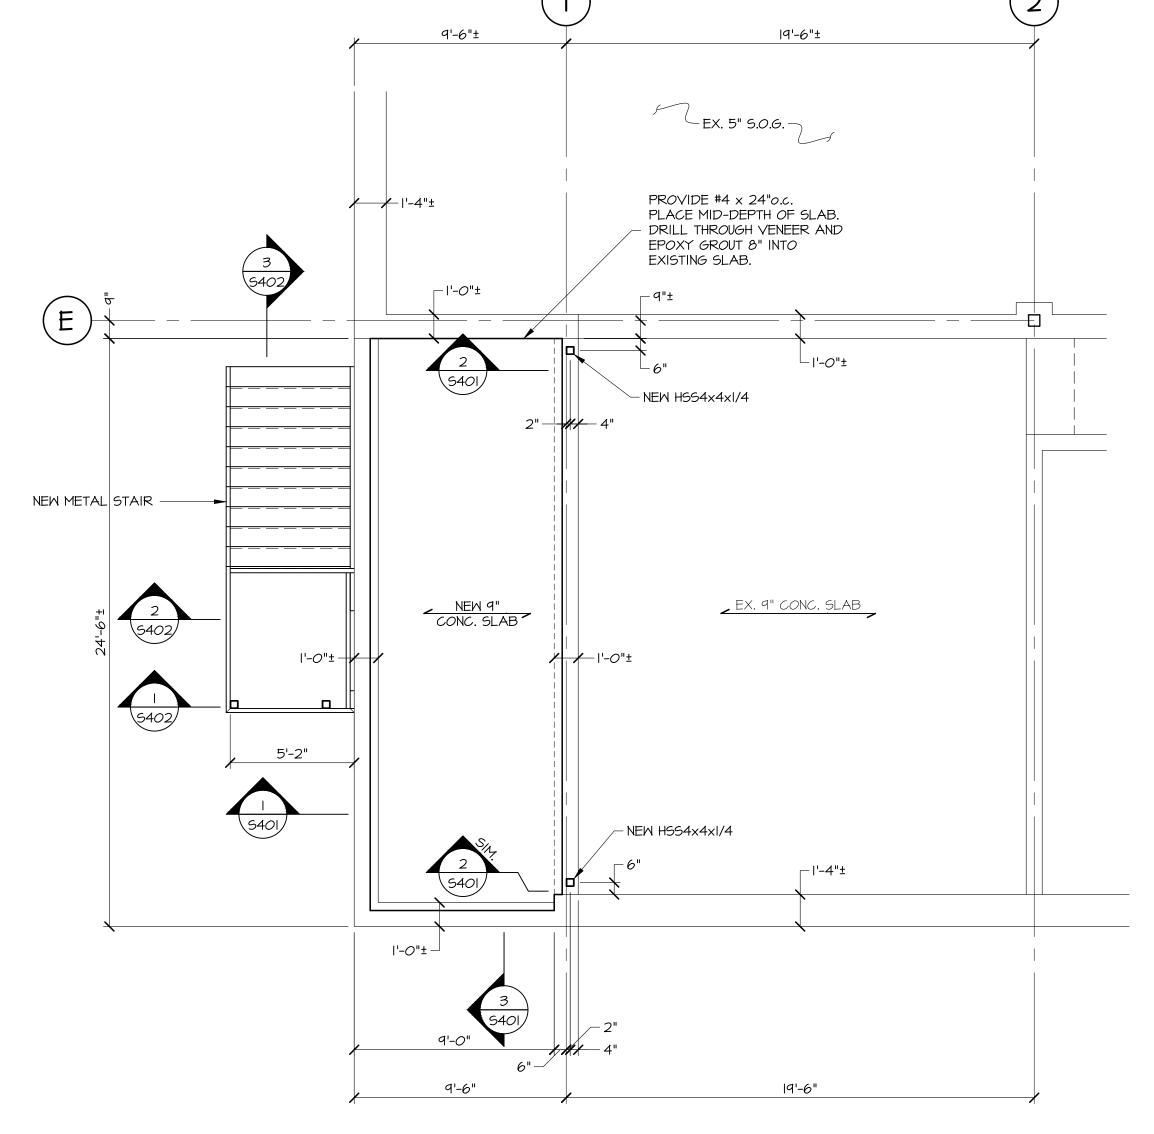

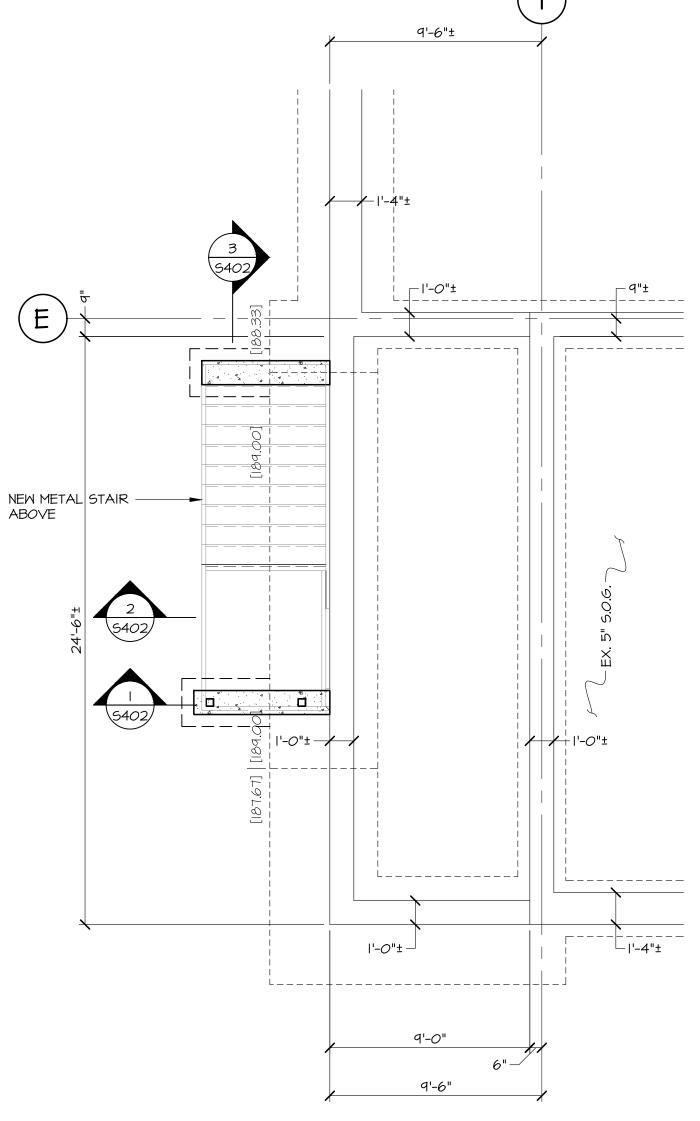





### PARTIAL ROOF FRAMING PLAN

1/4"=1'-0"

- ALL CONSTRUCTION IS EXISTING UNLESS OTHERWISE NOTED.
   NEW ROOF DECK TO BE I I/2", 20ga. GALVANIZED TYPE B METAL DECK AS MANUFACTURED BY VULCRAFT OR APPROVED EQUIVALENT.
   TOP OF NEW STEEL TO MATCH TOP OF EXISTING STEEL AT +12'-0"±.





SUBDIVISION: FULLERTON

## PARTIAL FIRST FLOOR FRAMING PLAN 1/4"=1"-0"

ALL CONSTRUCTION IS EXISTING UNLESS OTHERWISE NOTED.

NEW SLAB TO BE 9" MINIMUM THICK. SEE SECTIONS 1 \$2/5401 FOR SLAB REINFORCEMENT.

TOP OF NEW SLAB ELEVATION TO MATCH TOP OF EXISTING FLOOR SLAB ELEVATION AT REFERENCE ELEVATION O'-O".





ELECTION DIST. NO.: 8C5

# PARTIAL FOUNDATION PLAN 1/4"=1'-0"

I. ALL CONSTRUCTION IS EXISTING UNLESS OTHERWISE NOTED.

SEAL	PROFESSIONAL CERTIFICATION		AS-BUILT / REV	VISION	BY	DATE	P.W.A. NO.	KEY SHEET	POSITION SHT	DRAWIN	G SCALE		
OF MAN	I HEREBY CERTIFY THAT THESE DOCUMENTS WERE PREPARED OR APPROVED BY ME, AND THAT I AM A DULY LICENSED PROFESSIONAL		BID/PERM	ΠΤ		09/20/24	-	-	-	PLAN SCALE:	AS INDICATED	APPROVED BY: Mihai T. Petris	or
PRIL C.	ENGINEER UNDER THE LAWS OF THE STATE OF	MARYLAND.					R.O.W NO.	-	-	PROFILE SCALE:	-	DIRECT 10/03/2024	
	LICENSE NO. 17403 EXPIRATION DA	TE: 06-28-2025			<u> </u>		-	-	-		-	DATE	
	ENGINEER PAUL MILANO, P.E.	DGN BY:	BUREAU OF ENGINEERING AND CONSTRUCTION		HIGH	WAYS	STRUCTURES	STORM DRAINS	SEWER	WATER	FIELD ENGINEER	PROPERTY MANAGEME	ENT
STERED LE LAND	PRINCIPAL ENGINEER MINCIN PATEL MILANO, INC.	DWN BY:	REVIEWED BY:									APPROVED BY:	CI
B	6511 HARFORD ROAD BALTIMORE, MARYLAND 21214 	СНКО ВУ:	DATE REVIEWED:									DATE:	CF

BALTIMORE COUNTY OFFICE OF BUDGET AND FINANCE, PROPERTY MANAGEMENT

FULLERTON FIRE STATION #8 - RENOVATION & ADDITION

STRUCTURAL PLANS

4401 FITCH AVENUE, NOTTINGHAM, MARYLAND 21236

STRUCTURAL

22167 PO0
JOB ORDER NUMBE
241-220-0054-001
SHEET 31 of 58
DRAWING NUMBE
S101

SHEET DESIGNATION CONTRACT NUMBER

### STRUCTURAL GENERAL NOTES

#### **EXISTING CONDITIONS**

INFORMATION INDICATED ON THESE DRAWINGS PERTAINING TO EXISTING CONDITIONS HAS BEEN OBTAINED FROM EXISTING BUILDING DRAWINGS AND IS BELIEVED TO BE REASONABLY ACCURATE. HOWEVER, PRIOR TO PERFORMING ANY WORK OR FABRICATION, BASED UPON THIS INFORMATION, THE CONTRACTOR SHALL FIELD VERIFY THE ACTUAL EXISTING DIMENSIONS/CONDITIONS. SHOULD CONDITIONS BE DISCOVERED THAT PREVENT EXECUTION OF THE WORK AS INDICATED, THE CONTRACTOR SHALL NOTIFY THE ENGINEER PRIOR TO PROCEEDING WITH CONSTRUCTION. THE CONTRACTOR SHALL REMOVE ALL EXISTING CONSTRUCTION AS REQUIRED TO INSTALL NEW CONSTRUCTION. THE CONTRACTOR SHALL BE RESPONSIBLE FOR PROTECTING ALL EXISTING WORK AND SHALL REPAIR AND/OR REPLACE TO IT'S PRESENT CONDITION ANY DAMAGE OR INJURY CAUSED DURING DEMOLITION OR NEW CONSTRUCTION. ALL TEMPORARY SHORING, NEEDLING, ETC. SHALL BE AS REQUIRED TO SUPPORT THE EXISTING STRUCTURE DURING DEMOLITION AND NEW WORK. THE CONTRACTOR SHALL EXAMINE THE EXISTING STRUCTURE TO DETERMINE THE EXTENT OF NECESSARY SHORING AND NEEDLING. THE CAPACITY AND METHOD USED FOR SHORING AND NEEDLING SHALL BE THE RESPONSIBILITY OF THE CONTRACTOR. INSTALLATION OF TEMPORARY SHORING, NEEDLING, ETC. SHALL BE COORDINATED WITH THE CONTRACTOR'S SEQUENCE FOR THE INSTALLATION OF THE NEW WORK AND THE DEMOLITION OF EXISTING CONSTRUCTION.

#### <u>DIMENSIONS</u>

THE CONTRACTOR SHALL FIELD CHECK AND VERIFY ALL PERTINENT DIMENSIONS AND CONDITIONS INDICATED ON THESE DRAWINGS AND SHALL NOTIFY THE ENGINEER OF ANY DISCREPANCIES OR POTENTIAL CONFLICTS PRIOR TO PROCEEDING WITH CONSTRUCTION. DIMENSIONS IDENTIFIED WITH A ± REPRESENT DIMENSIONS, EITHER EXISTING OR NEW, THAT REQUIRE VERIFICATION IN THE FIELD BY THE CONTRACTOR PRIOR TO FABRICATION OR INSTALLATION OF ANY COMPONENTS.

THE NEW ADDITION HAS BEEN DESIGNED TO BE SELF-SUPPORTING AND STABLE AFTER FULLY COMPLETED. CONSTRUCTION MEANS AND METHODS ARE SOLELY THE CONTRACTOR'S RESPONSIBILITY. THE CONTRACTOR MUST DETERMINE ERECTION PROCEDURE AND SEQUENCE, WHICH WILL ENSURE THE STABILITY OF ALL COMPONENTS DURING ERECTION, INCLUDING THE ADDITION OF ANY GUYS, BRACING, ETC. THAT MAY BE NECESSARY. SUCH MATERIAL AND METHODS ARE NOT SHOWN IN THE CONTRACT DRAWINGS OR SPECIFICATIONS AND IS SOLELY THE RESPONSIBILITY OF THE CONTRACTOR. THE ENGINEER HAS NO EXPERTISE IN, AND TAKES NO RESPONSIBILITY FOR, THE CONSTRUCTION MEANS AND METHODS OR JOB SITE SAFETY DURING CONSTRUCTION. PROCESSING OR APPROVING SUBMITTALS MADE BY THE CONTRACTOR WHICH MAY CONTAIN INFORMATION RELATED TO CONSTRUCTION METHODS OR SAFETY ISSUES, OR PARTICIPATION IN MEETINGS WHERE SUCH ISSUES MIGHT BE DISCUSSED, SHALL NOT BE CONSTRUED AS VOLUNTARY ASSUMPTION BY THE ENGINEER OF ANY RESPONSIBILITY FOR CONSTRUCTION METHODS AND/OR SAFETY PROCEDURES, IT IS SOLELY THE RESPONSIBILITY OF EACH CONTRACTOR TO FOLLOW ALL APPLICABLE SAFETY PROCEDURES AND APPLICABLE SAFETY CODES AND REGULATIONS DURING ALL PHASES OF CONSTRUCTION. THE STRUCTURAL ENGINEER DOES NOT ENGAGE IN, AND DOES NOT SUPERVISE CONSTRUCTION.

#### SPECIAL CONDITIONS

THE CONTRACTOR SHALL BE RESPONSIBLE TO INSURE THAT PROPER STORAGE OF MATERIAL IS MAINTAINED SO AS NOT TO CAUSE OVERLOADING OF THE EXISTING STRUCTURE DURING PERFORMANCE OF THIS WORK. ALL WORK IS TO BE COORDINATED WITH THE OWNER'S REPRESENTATIVE TO MINIMIZE ANY DISTURBANCES TO THE USE OF THE BUILDING. CONTRACTOR SHOULD TAKE ALL NECESSARY PRECAUTION TO AVOID FIRE DAMAGE TO ANY MEMBER OR OBJECT. CONTRACTOR SHALL SEPARATE THE WORK AREA FROM SURROUNDING AREA BY ERECTING FIRE SEPARATION BARRIERS AS NECESSARY.

#### CAST IN PLACE CONCRETE AND REINFORCING

ALL CONCRETE SHALL CONFORM TO ACI 301, ACI 318, ACI 315. ALL CONCRETE SHALL BE NORMAL WEIGHT CONCRETE WITH THE FOLLOWING 28 DAY COMPRESSIVE STRENGTH (f'c): 4,000psi

CEMENTITIOUS MATERIAL SHALL BE A MINIMUM OF 75% PORTLÀND CEMENT TYPE I

REINFORCING - ASTM A 615, GRADE 60.

WELDED WIRE FABRIC - ASTM A 185, LAP ENDS 6" MINIMUM.

SPLICE LAPS FOR ALL REINFORCING SHALL BE CLASS "B" SPLICE, UNLESS OTHERWISE NOTED. ALL CONCRETE SHALL CONTAIN A WATER-REDUCING ADMIXTURE PER MANUFACTURER'S RECOMMENDATIONS.

PROVIDE ACCESSORIES AND BAR SUPPORTS FOR ALL REINFORCING IN ACCORDANCE WITH ACI 315 (LATEST EDITION).

MAXIMUM SLUMP TO BE 4". SUBMIT CONCRETE MIX DESIGN FOR EACH TYPE OF CONCRETE TO BE USED AT LEAST 15 DAYS PRIOR TO INTENDED USE.

MASONRY WORK SHALL COMPLY WITH ACI530.I/ASCE 6 "SPECIFICATIONS FOR MASONRY STRUCTURES." CONCRETE MASONRY UNITS SHALL CONFORM TO ASTM C 90. CONCRETE MASONRY UNITS SHALL HAVE A MINIMUM COMPRESSIVE STRENGTH OF 1,900psi AND A MINIMUM PRISM STRENGTH

MORTAR SHALL CONFORM TO ASTM C 270, TYPE S FOR ALL CMU WALLS AND TYPE N FOR ALL VENEERS.

GROUT FOR ALL MASONRY WALLS TO EITHER BE 3,000psi PEA GRAVEL CONCRETE OR COMPLY WITH ASTM C476 - GROUT.

ALL OPENINGS IN MASONRY WALLS AND PARTITIONS ARE TO BE PROVIDED WITH LINTELS. LINTELS SHALL BE STRUCTURAL STEEL OR PRECAST CONCRETE AS INDICATED IN THE LINTEL SCHEDULE. ALL LINTELS SHALL HAVE 8" MINIMUM BEARING AND SHALL BE SET IN A FULL BED OF MORTAR, SHORE LINTELS AS REQUIRED TO PREVENT ROTATION DURING CONSTRUCTION. NOTE THAT ALL WALL OPENINGS ARE NOT SHOWN ON THE STRUCTURAL DRAWINGS. CONTRACTOR SHALL COORDINATE SIZE, TYPE AND LOCATION OF ALL LINTELS REQUIRED WITH ARCHITECTURAL AND MECHANICAL DRAWINGS.

M,	MASONRY WALL LINTEL SCHEDULE										
MARK	TYPE	CONFIGURATION	REMARKS								
P	4" WIDE x 8" HIGH PRECAST MASONRY LINTEL w/ (I)-#5 TOP & BOTTOM FOR EACH 4" OF WALL THICKNESS.		WHERE INDICATED AND/ OR FOR OPENINGS IN NON-BEARING INTERIOR PARTITIONS UP TO 5'-O" WIDE. UNLESS OTHERWISE NOTED, PROVIDE 8" MIN. BEARING EACH END.								
P6	6" WIDE x 8" HIGH PRECAST MASONRY LINTEL w/ (I)-#5 TOP & BOTTOM FOR EACH 6" OF WALL THICKNESS.		WHERE INDICATED AND/ OR FOR OPENINGS IN NON-BEARING 6" CMU INTERIOR PARTITIONS UP TO 5'-O" WIDE. PROVIDE 8" MIN. BEARING EA. END.								
LI	L4x3 1/2x5/16 LLV FOR EACH 4" OF WALL THICKNESS.		WHERE INDICATED AND/ OR FOR OPENINGS IN WALLS UP TO 6'-O" WIDE. PROVIDE 8" MIN. BEARING EACH END, UNLESS OTHERWISE NOTED.								
L2	L6x3 1/2x5/16 LLV FOR EACH 4" OF WALL THICKNESS.		WHERE INDICATED AND/ OR FOR OPENINGS IN WALLS BETWEEN 6'-O" TO IO'-O" WIDE. PROVIDE 8" MIN. BEARING EACH END.								
L3	(2)-L4x3 1/2x5/16 LLV w/ L4x3 1/2x5/16 + L3x3x1/4 AT VENEER	-3"	WHERE INDICATED. PROVIDE 8" MIN. SOLID BEARING EACH END.								

#### STRUCTURAL STEEL

FABRICATION & ERECTION OF STRUCTURAL STEEL SHALL CONFORM TO AISC SPECIFICATIONS \$ AWS DI.I.

NEW STRUCTURAL STEEL: WIDE FLANGE SHAPES: ASTM A992 GRADE 50

MISC. CHANNELS, ANGLES, PLATES: ASTM A36, UNLESS OTHERWISE NOTED

WELDING ELECTRODES: ETOXX HIGH STRENGTH BOLTS: ASTM A 325-N.

SHOP PREP OTHER STEEL PER SSPC SP3. PROVIDE TWO COATS OF FABRICATOR'S STANDARD RUST INHIBITING PRIMER.

ALL WELDING SHALL CONFORM TO AWS STANDARDS AND SHALL BE PERFORMED BY CERTIFIED WELDERS. ALL WELDING TO ANY EXISTING MEMBERS SHALL BE PREFORMED WITH EXTREME CARE TO AVOID EXCESSIVE DAMAGE TO

#### THE BASE METAL. METAL DECK

FABRICATION AND ERECTION OF STEEL DECK SHALL CONFORM TO STEEL DECK INSTITUTE SPECIFICATIONS.

STEEL DECK - ASTM A 653 (SQ), GRADE 33 GALVANIZING - ASTM A 924, G90 GALVANIZED COATING.

FASTEN DECK WITH 5/8" PUDDLE WELD AT 12"o.c. MAX NO LOADS SHALL BE SUSPENDED FROM METAL DECK WHETHER DECK IS NEW OR EXISTING

ALL ANCHORS INDICATED TO BE MANUFACTURED BY HILTI OR APPROVED EQUIVALENT. INSTALLATION OF ALL ANCHORS SHALL ADHERE TO HILTI SPECIFICATIONS.

INSTALLERS OF ANCHORS SHALL BE TRAINED BY HILTI IN THE PROPER INSTALLATION METHODS PRIOR TO INSTALLATION OF ANCHORS IN THE FIELD.

#### **SUBMITTALS** ORIGINAL SUBMITTALS SHALL BE SUBMITTED FOR ARCHITECT/ENGINEER'S REVIEW FOR THE FOLLOWING ITEMS:

CONCRETE MIX DESIGNS

CONCRETE AND MASONRY REINFORCING STEEL SHOP DRAWINGS

SHOP DRAWINGS FOR STRUCTURAL AND METAL DECK IF A CONTRACTOR FAILS TO SUBMIT THE SHOP DRAWINGS, THE FIRM, MINCIN PATEL MILANO, INC. WILL NOT BE RESPONSIBLE FOR THE CONTRACTORS INTERPRETATION OF THE INTENT OF THE STRUCTURAL DRAWINGS. THE GENERAL CONTRACTOR SHALL REVIEW ALL SHOP DRAWINGS PRIOR TO SUBMISSION TO THE A/E AND SHALL MAKE ALL CORRECTIONS AS HE DEEMS NECESSARY. THE GENERAL CONTRACTOR SHALL STATE IN WRITING ANY DEVIATION OR OMISSIONS FROM THE CONTRACT DOCUMENTS.

### AN INDEPENDENT INSPECTION AGENCY, PAID FOR BY THE CONTRACTOR AND APPROVED BY THE ARCHITECT/ENGINEER.

SHALL INSPECT/MONITOR/TEST THE FOLLOWING ITEMS:

NEW CAST IN PLACE CONCRETE AND REINFORCING STEEL NEW STRUCTURAL STEEL AND METAL DECK

COPIES OF THE INSPECTORS FINAL REPORTS CERTIFYING THAT THE ITEMS INSPECTED HAVE BEEN INSTALLED IN ACCORDANCE WITH THE REQUIREMENTS OF THE CONTRACT DOCUMENTS SHALL BE SUBMITTED TO THE ARCHITECT/ENGINEER.

THESE BUILDING MODIFICATIONS HAVE BEEN DESIGNED FOR THE FOLLOWING LIVE LOAD CRITERIA FROM THE APPLICABLE CODES LISTED BELOW:

1.2

1.0

IBC 2015 IEBC 2015 ASCE 7-10

BUILDING RISK CATEGORY:

NEW ROOF LIVE LOAD: 30psf NEW FLOOR LIVE LOAD: 100psf SNOW LOADS: GROUND SNOW (Pa) 30psf FLAT ROOF SNOW 28psf

SNOW IMPORTANCE FACTOR (Is) SNOW THERMAL FACTOR (Ct) SNOW EXPOSURE FACTOR (Ce) WIND LOADS:

BASIC WIND SPEED: V = 130mph WIND EXPOSURE: SEISMIC:

SEISMIC FORCES RESULTING FROM NEW ADDITION DOES NOT

SIGNIFICANTLY IMPACT THE SEISMIC FORCES ON THE EXISTING STRUCTURE.

ALL OPENINGS IN MASONRY WALLS AND IN PARTITIONS ARE TO BE PROVIDED WITH LINTELS, LINTELS SHALL BE STRUCTURAL STEEL OR PRECAST CONCRETE AS INDICTED, UNLESS OTHERWISE NOTED. ALL LINTELS SHALL HAVE 8" MINIMUM BEARING AND SHALL BE SET IN A FULL BED OF MORTAR. SHORE LINTELS AS REQUIRED TO PREVENT ROTATION DURING CONSTRUCTION. NOTE THAT ALL WALL OPENINGS ARE NOT SHOWN ON THE STRUCTURAL DRAWINGS. CONTRACTOR SHALL COORDINATE SIZE TYPE, AND LOCATION OF ALL LINTELS REQUIRED WITH ARCHITECTURAL AND MECHANICAL DRAWINGS.

SUBDIVISION: FULLERTON


SHEET DESIGNATION CONTRACT NUMBER 22167 PO0 STRUCTURAL JOB ORDER NUMBER


241-220-0054-0012 SHEET 32 of 58 DRAWING NUMBER

FILE NO.: 20-120 MPM #21137


PROFESSIONAL CERTIFICATION		AS-BUILT / REVISION		DATE	P.W.A. NO.	KEY SHEET	POSITION SHT	DRAWIN	IG SCALE		
I HEREBY CERTIFY THAT THESE DOCUMEN	BID/PERMIT		09/20/24	-	-		PLAN SCALE: PROFILE SCALE:	AS INDICATED	APPROVED BY: Mihai T. Petrisor		
APPROVED BY ME, AND THAT I AM A DULY LICENSED PROFESSIONAL ENGINEER UNDER THE LAWS OF THE STATE OF MARYLAND.  LICENSE NO. 17403 EXPIRATION DATE: 06-28-2025					R.O.W NO.			-		DIRECTO	
					-			1 :	-	DATE: 10/03/2024	
ENGINEER PAUL MILANO, P.E.	DGN BY:	BUREAU OF ENGINEERING AND CONSTRUCTION	HIG	HWAYS	STRUCTURES	STORM DRAINS	SEWER	WATER	FIELD ENGINEER	PROPERTY MANAGEMENT	
PRINCIPAL ENGINEER  MINCIN PATEL MILANO, INC. 65   1 HARFORD ROAD BALTIMORE, MARYLAND 21214	DWN BY:	REVIEWED BY:								APPROVED BY:CHIE	
	CHIND DV	DATE REVIEWED.								DITTE	

BALTIMORE COUNTY OFFICE OF BUDGET AND FINANCE, PROPERTY MANAGEMENT

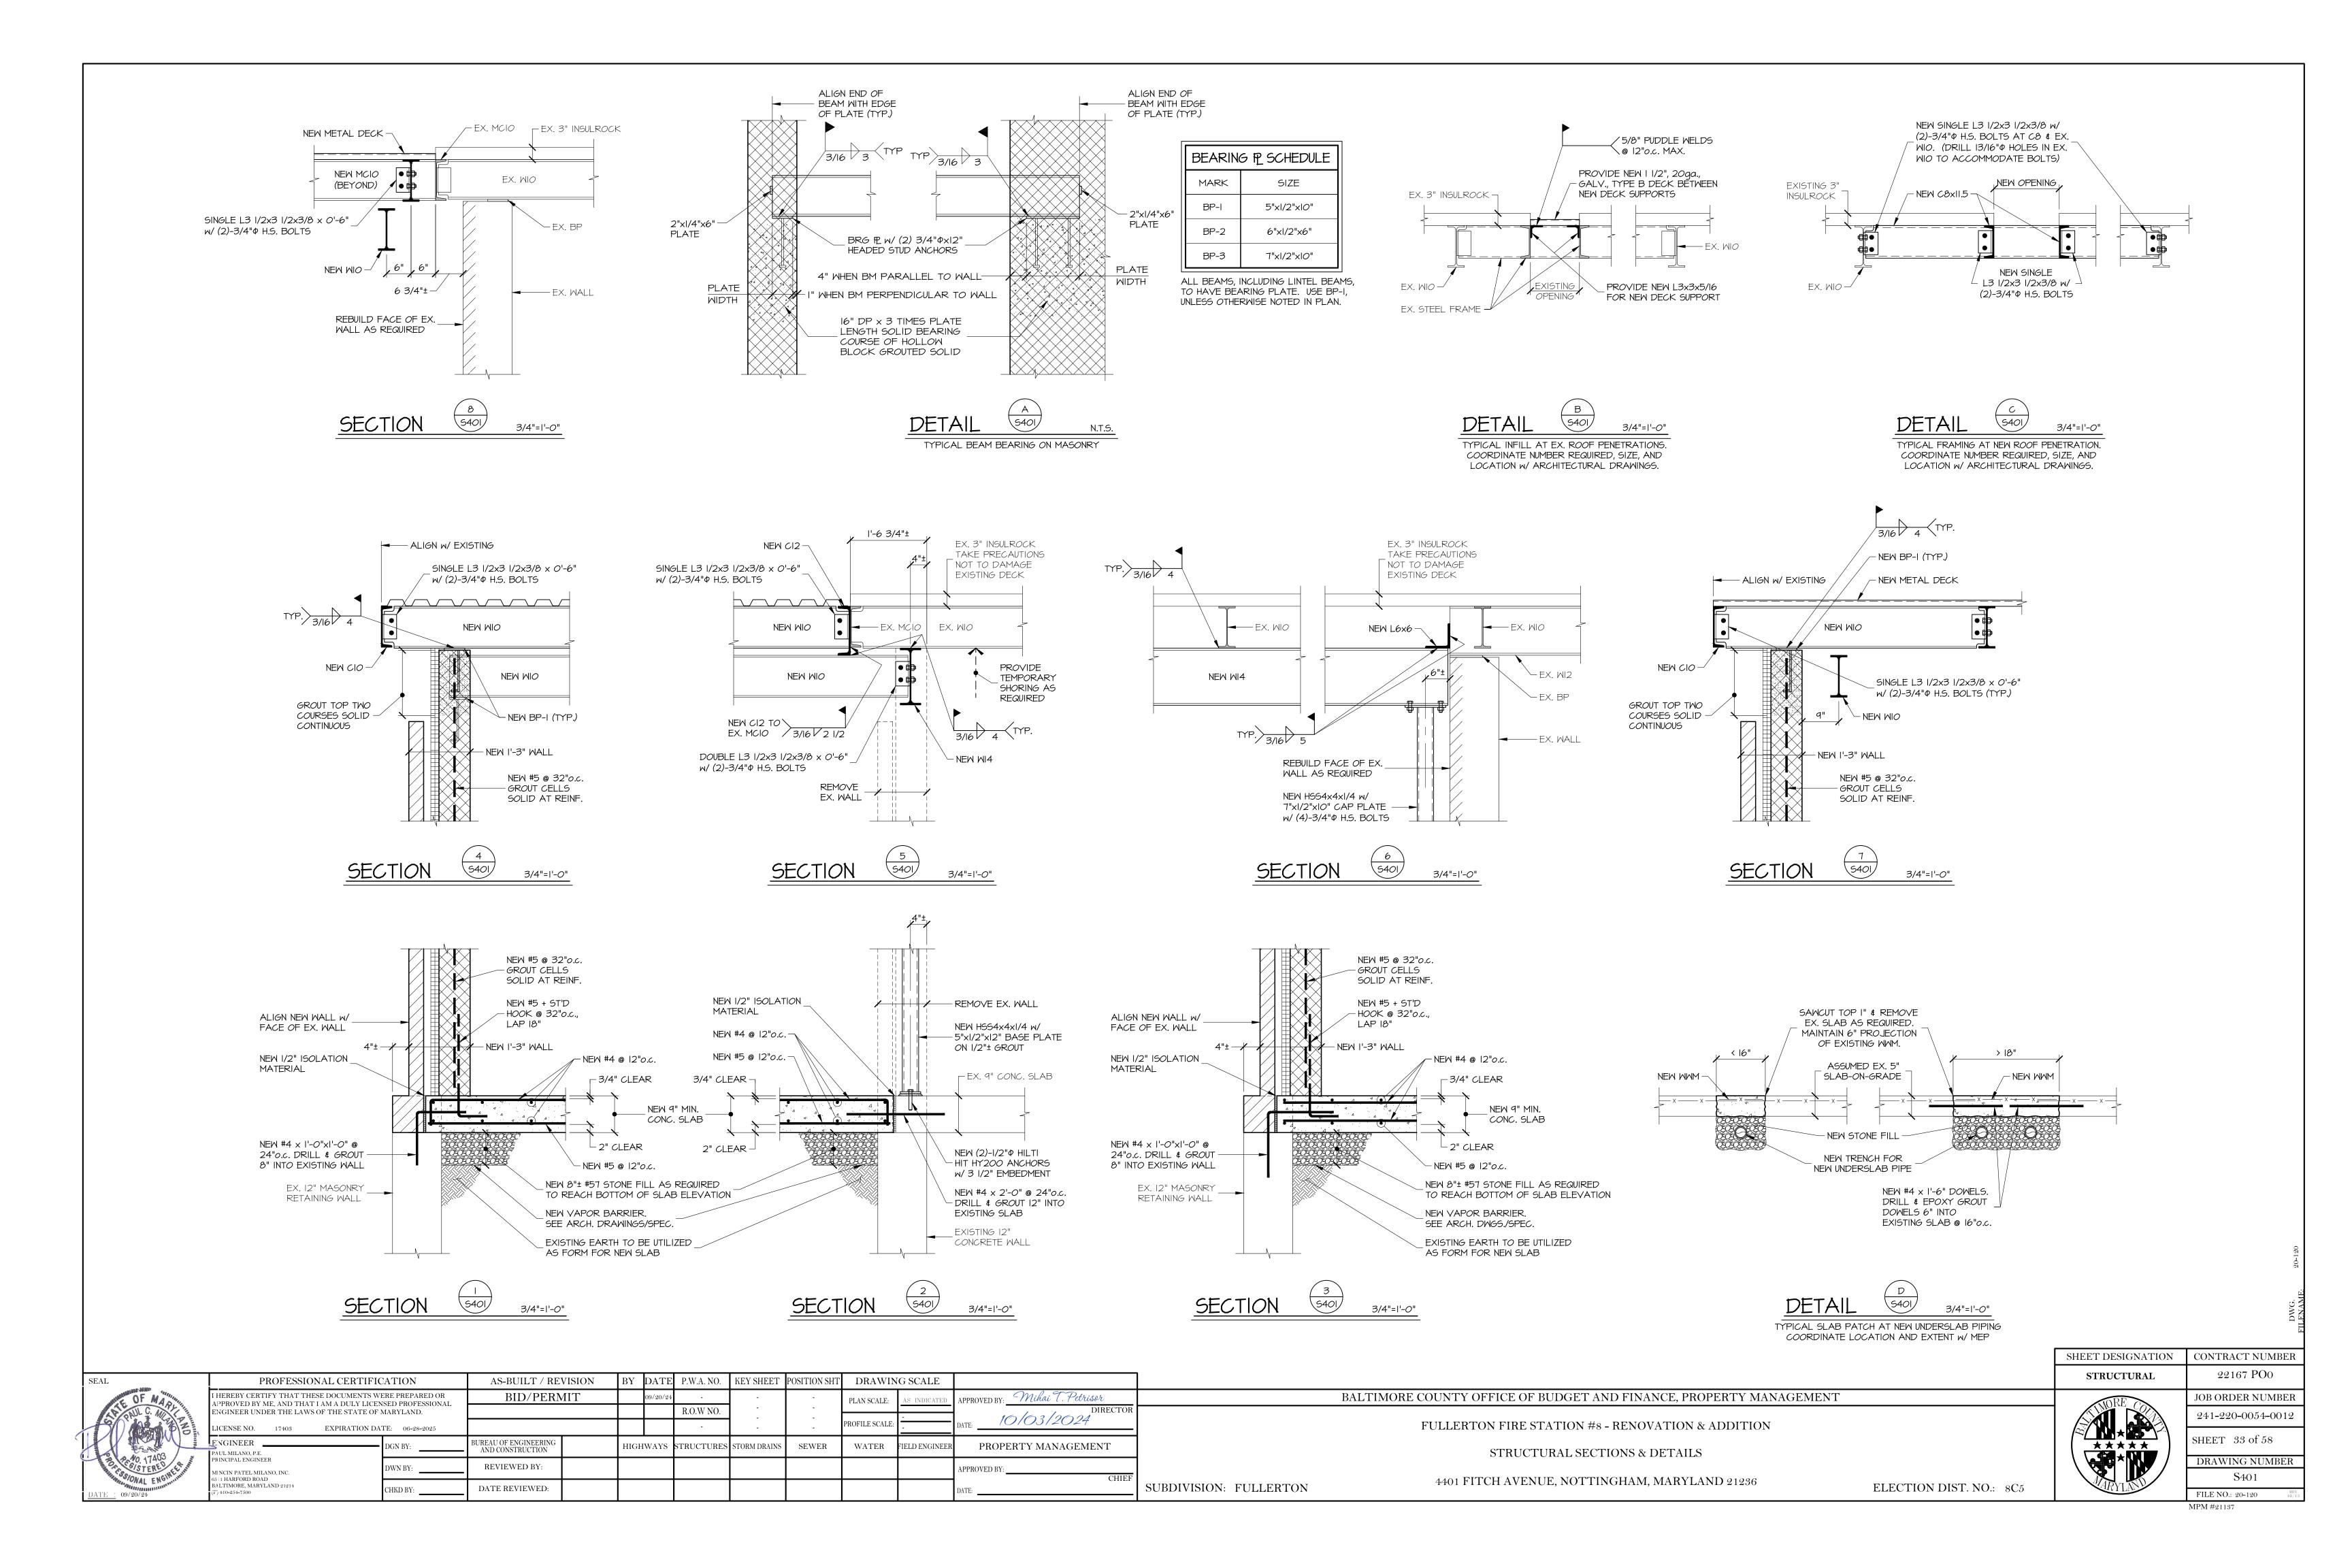

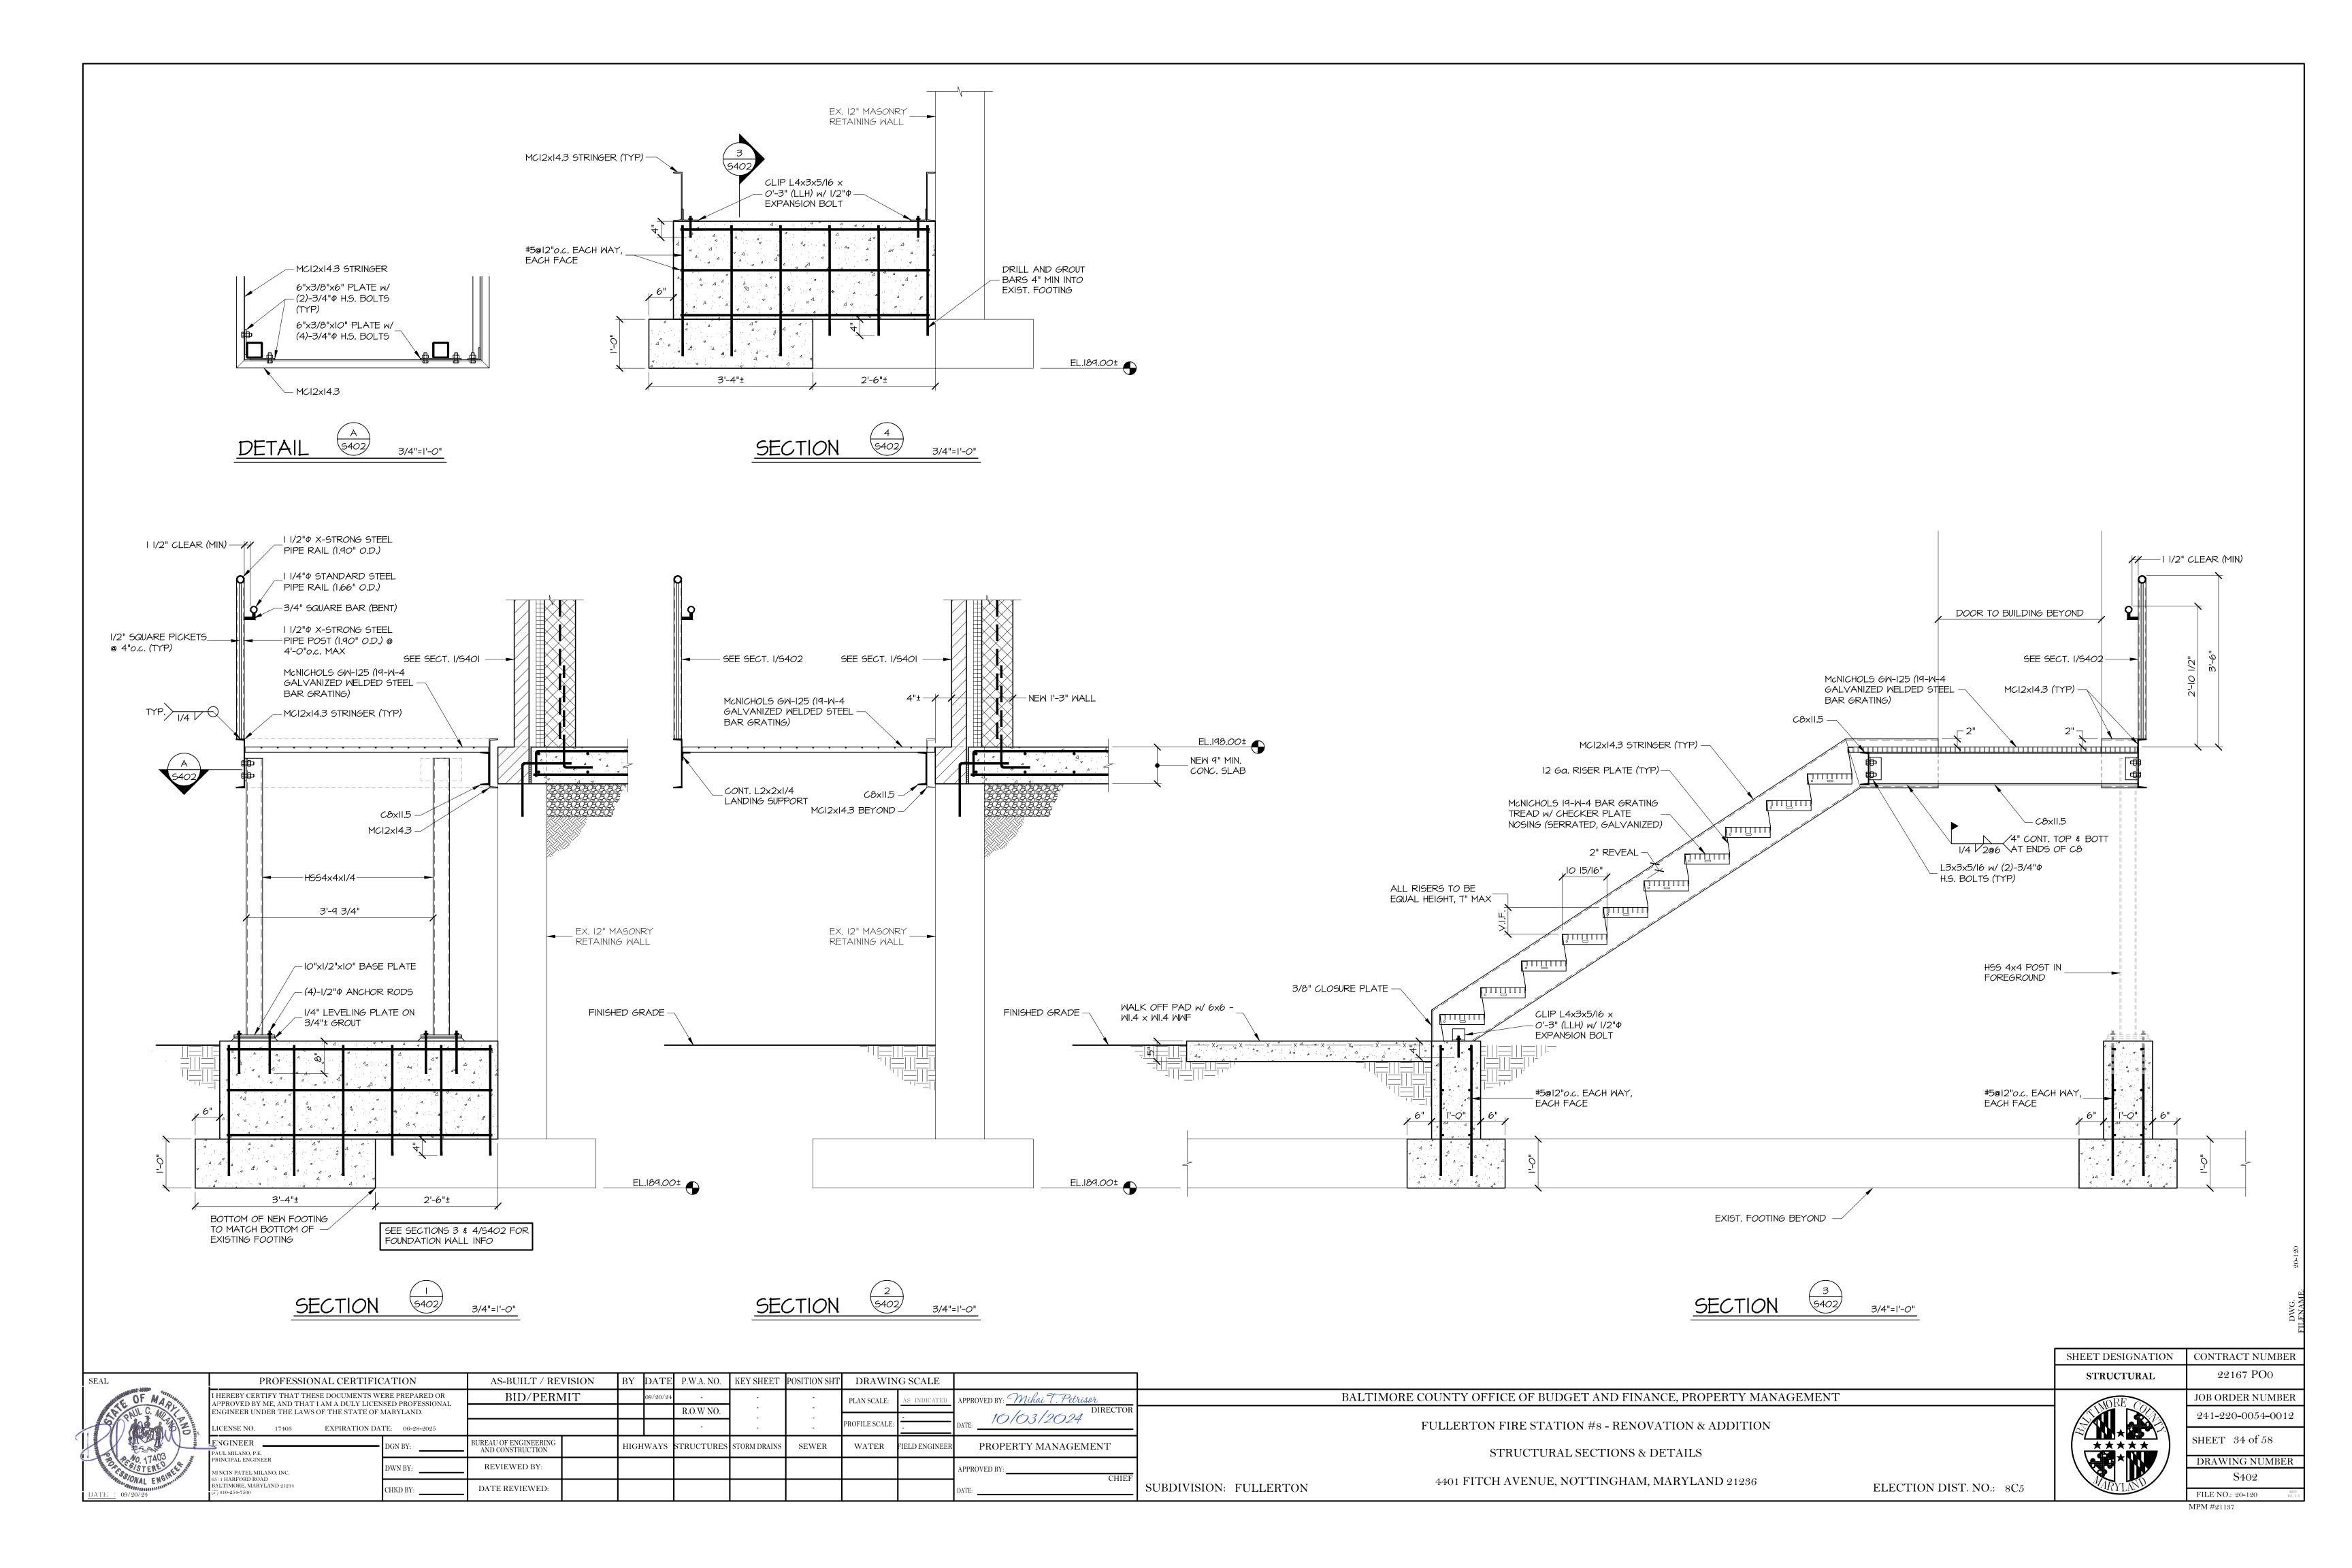

# HEATING, VENTILATION AND AIR CONDITIONING

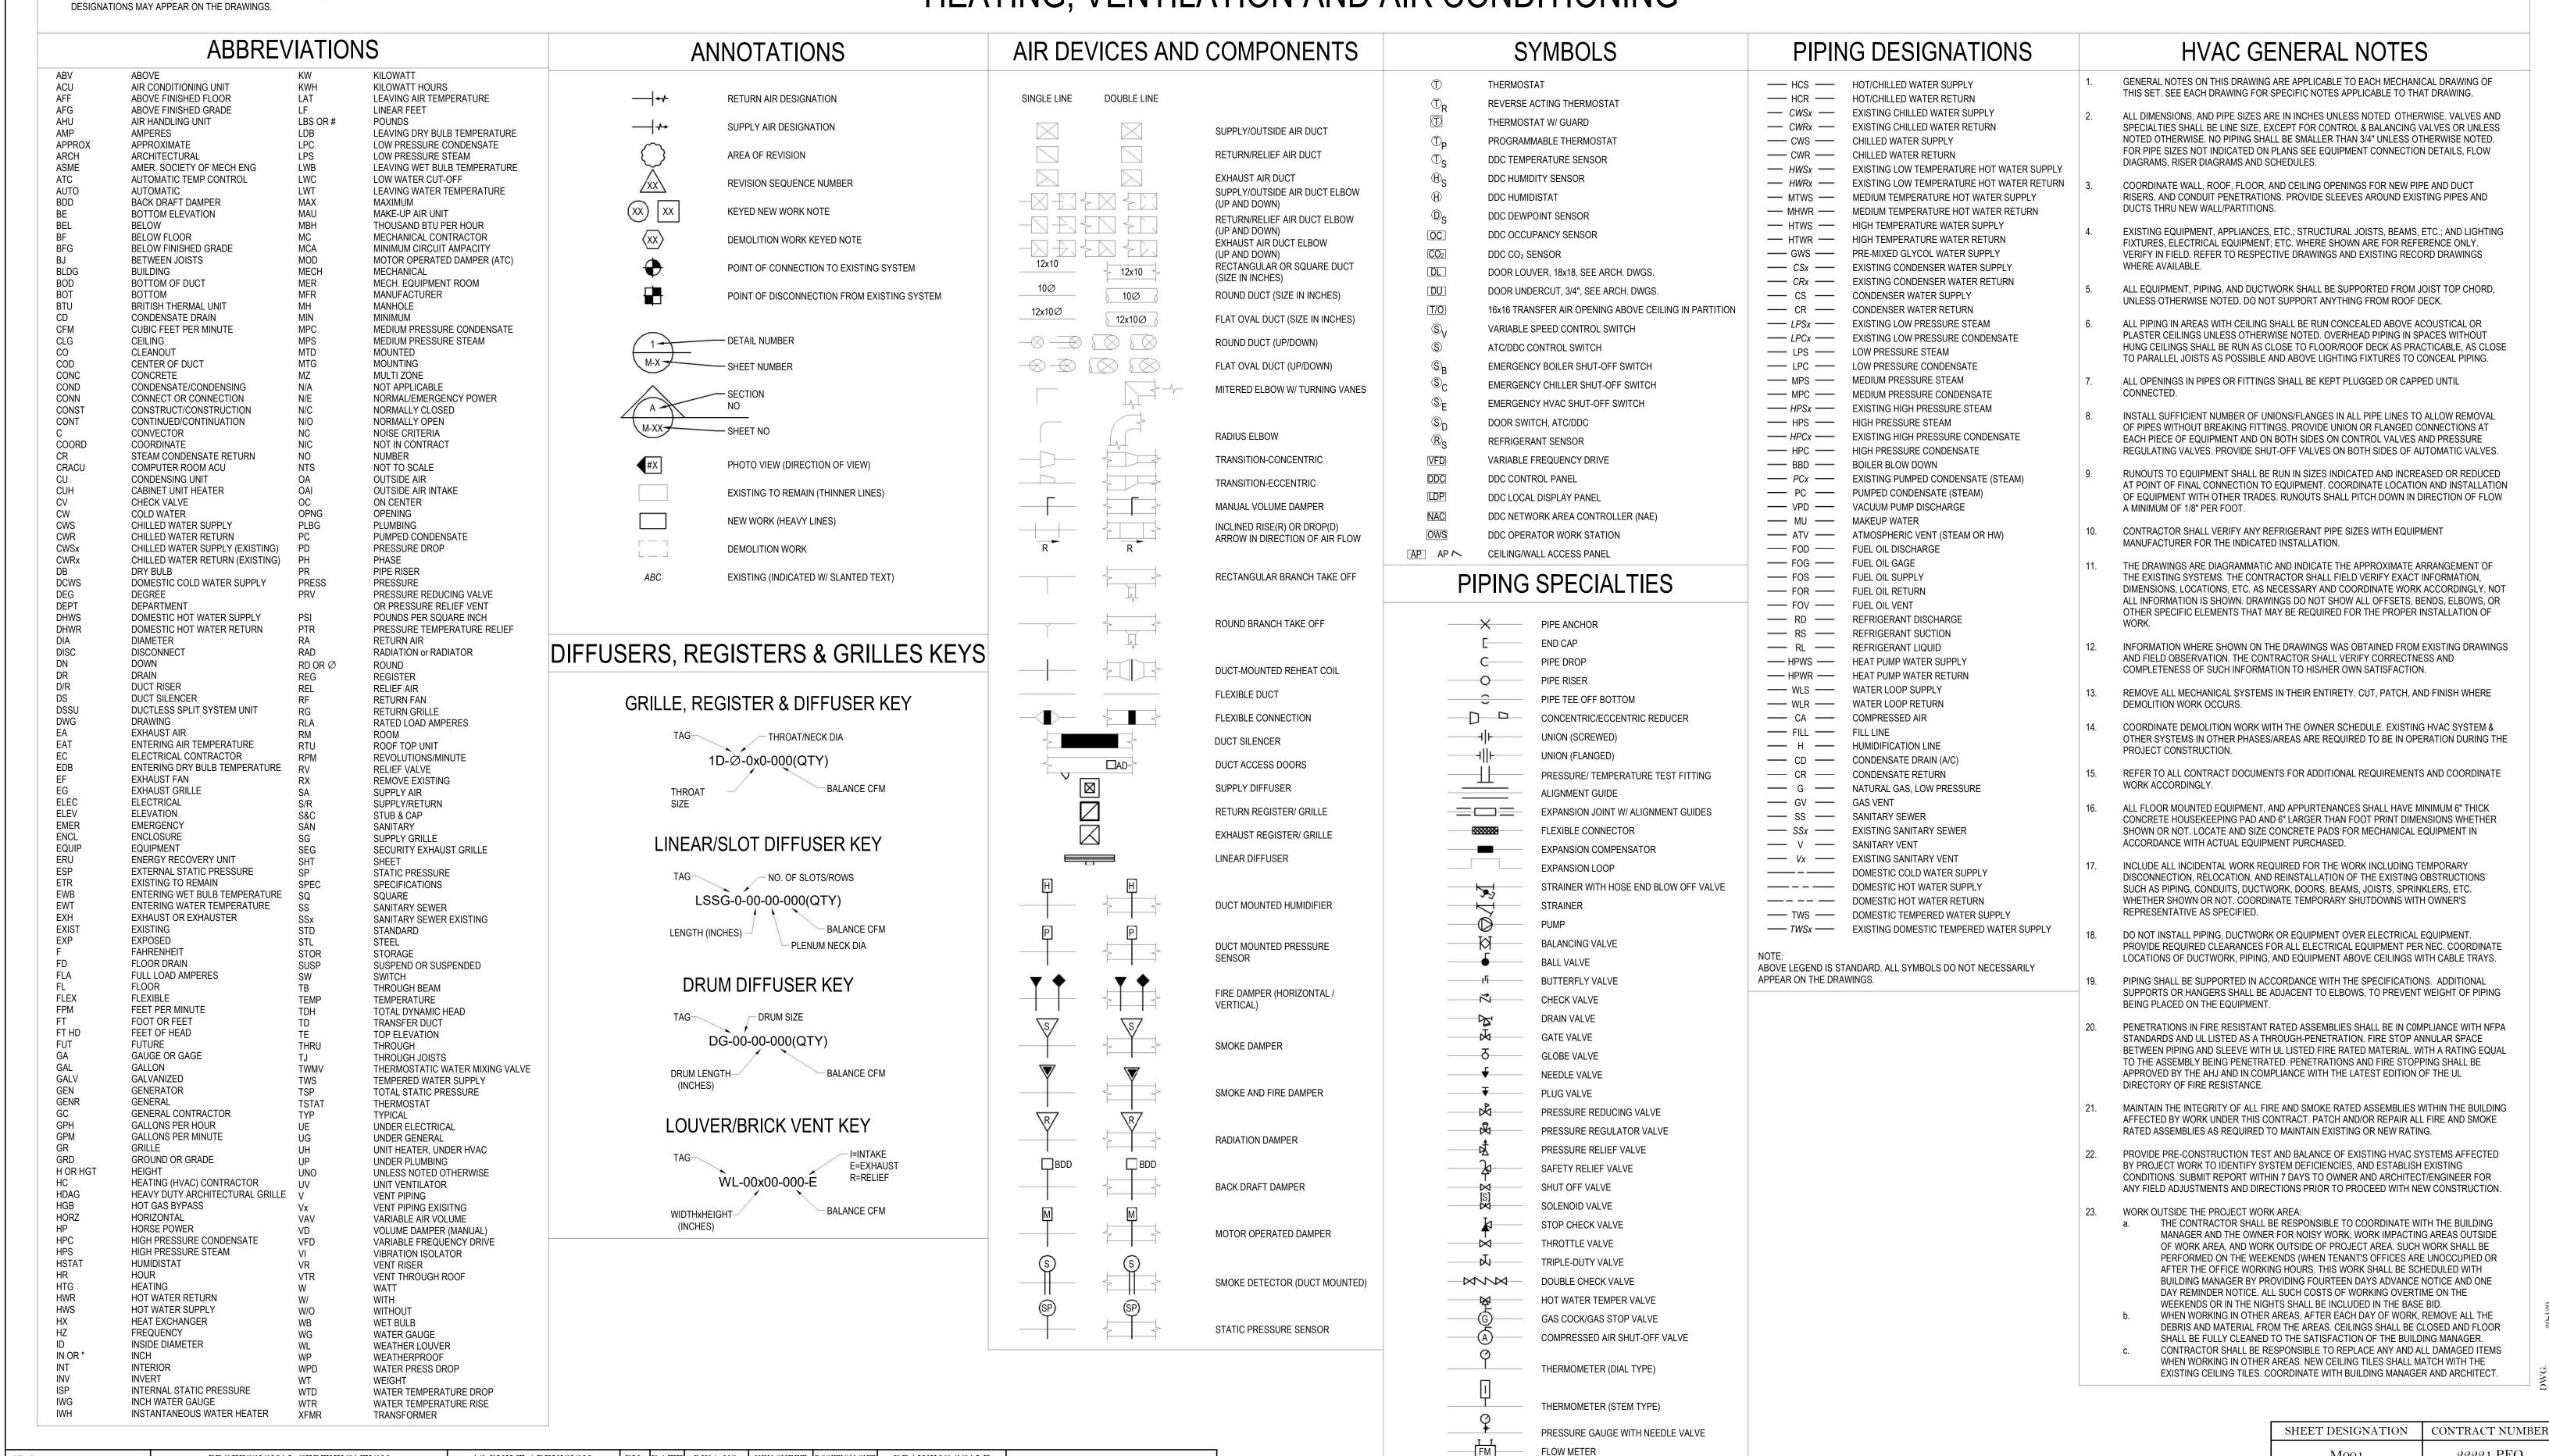

SUBDIVISION: FULLERTON

PROFESSIONAL CERTIFICATION		AS-BUILT / REVISION	BY	DATE	P.W.A. NO.	KEY SHEET	POSITION SHT	DRAWIN	G SCALE		
I HEREBY CERTIFY THAT THESE DOCUMENTS WERE F APPROVED BY ME, AND THAT I AM A DULY LICENSED			BID/PERMIT		9/20/24	-	MSW	27NE21	PLAN SCALE:	NONE	APPROVED BY: Mihai T. Petrisor
	PROFESSIONAL ENGINEER UNDER THE LAWS OF THE STATE OF					R.O.W NO.	-	-			10/03/2024 DIRECT
MARYLAND. LICENSE NO. 22942 EXPIRATION DATE: 12-24		ATE: 12-24-2024				-	-	-	PROFILE SCALE:	-	DATE: /0/03/2024
ENGINEER:  UDAY PATEL, PE, LEED BD+C PRINCIPAL MECHANICAL ENGINEER  C.C. JOHNSON & MALHOTRA, P.C. 400 EAST PRATT STREET, SUITE 604 BALTIMORE, MARYLAND 21202 (P) 410-461-9920	UDAY PATEL, PE, LEED BD+C	DGN BY: CCJM	BUREAU OF ENGINEERING AND CONSTRUCTION	HIGH	HWAYS	STRUCTURES	STORM DRAINS	SEWER	WATER	FIELD ENGINEER	PROPERTY MANAGEMENT
	C.C. JOHNSON & MALHOTRA, P.C.	DWN BY: CCJM	REVIEWED BY:								APPROVED BY:
	CHKD BY: CCJM	DATE REVIEWED:								DATE:	

BALTIMORE COUNTY OFFICE OF BUDGET AND FINANCE, PROPERTY MANAGEMENT

LEGEND, ABBREVIATIONS AND NOTES

FULLERTON FIRE STATION #8 - RENOVATION & ADDITION


4401 FITCH AVENUE, NOTTINGHAM, MARYLAND, 21236


M001

JOB ORDER NUMBER 241-220-0054-0012 SHEET 35 of 58

DRAWING NUMBER 2022-2351 FILE NO.: 20-120

22221 PFO

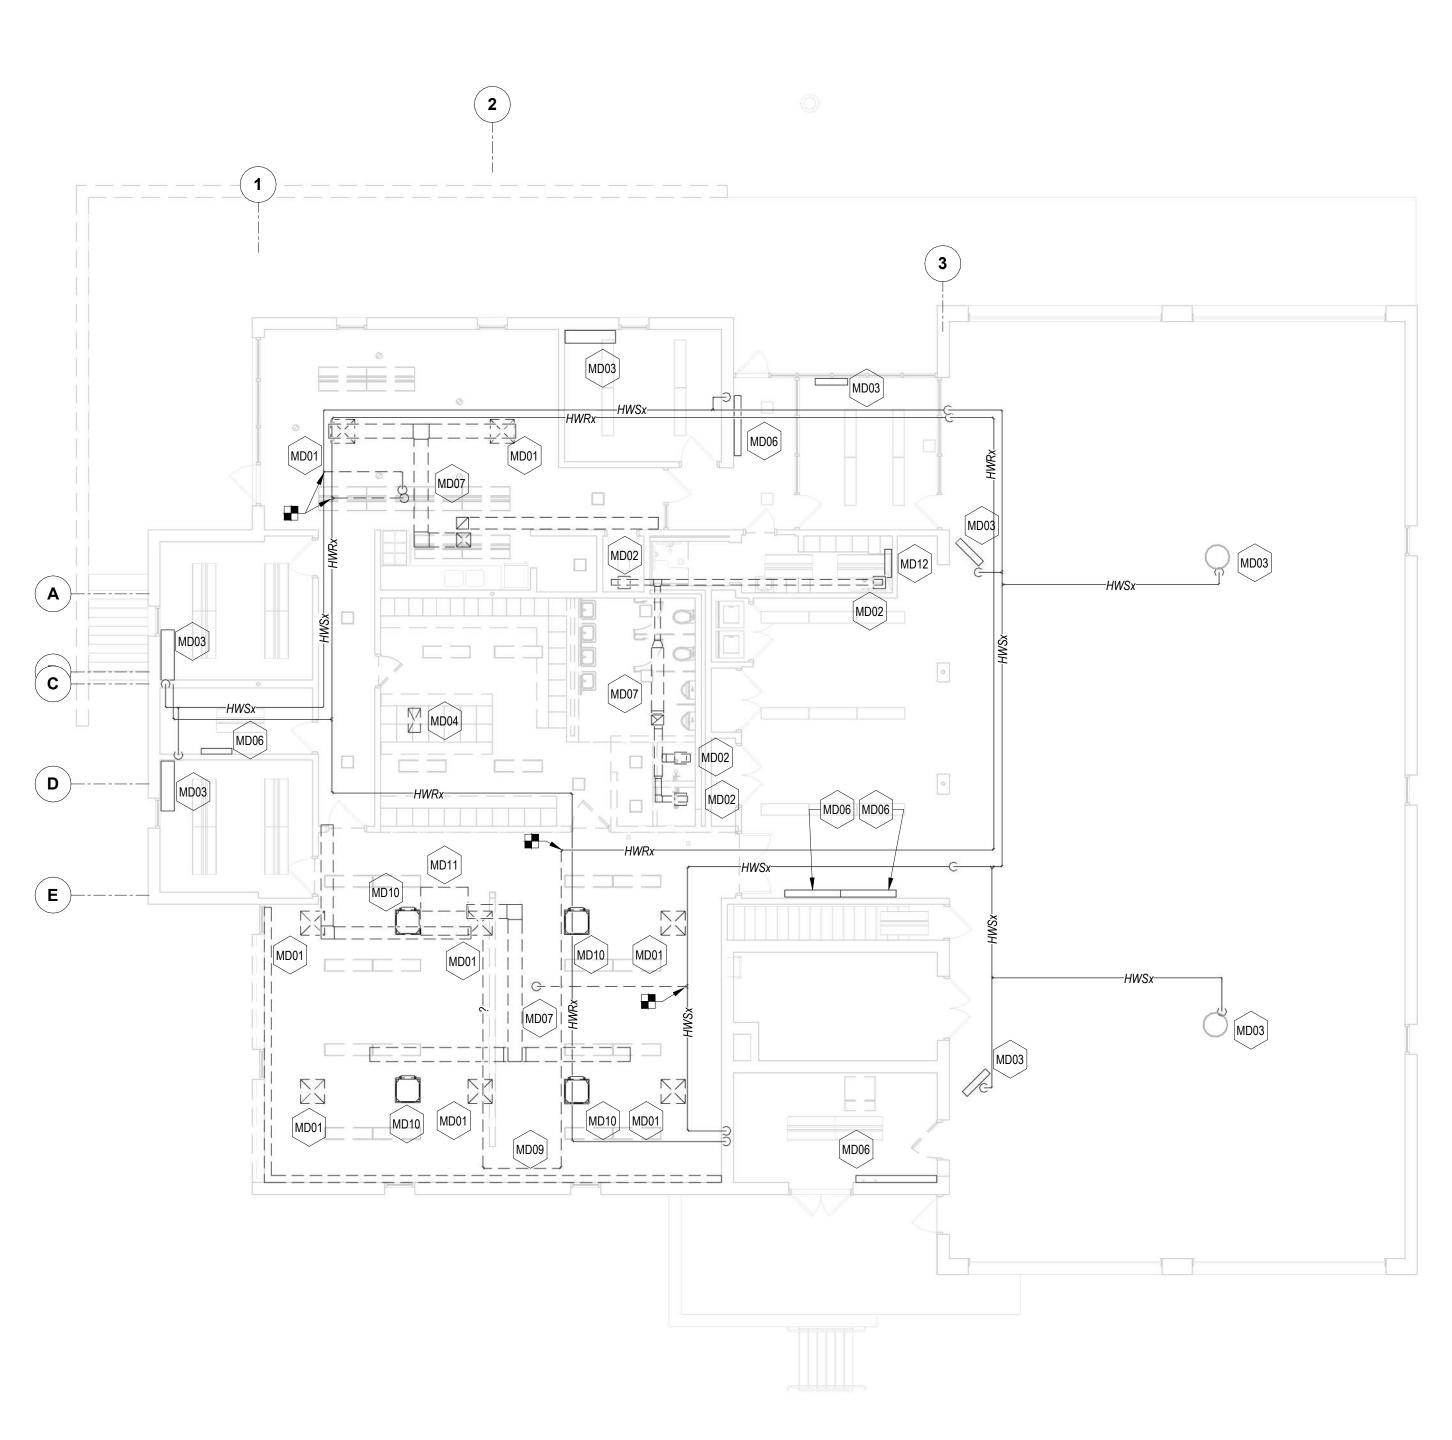

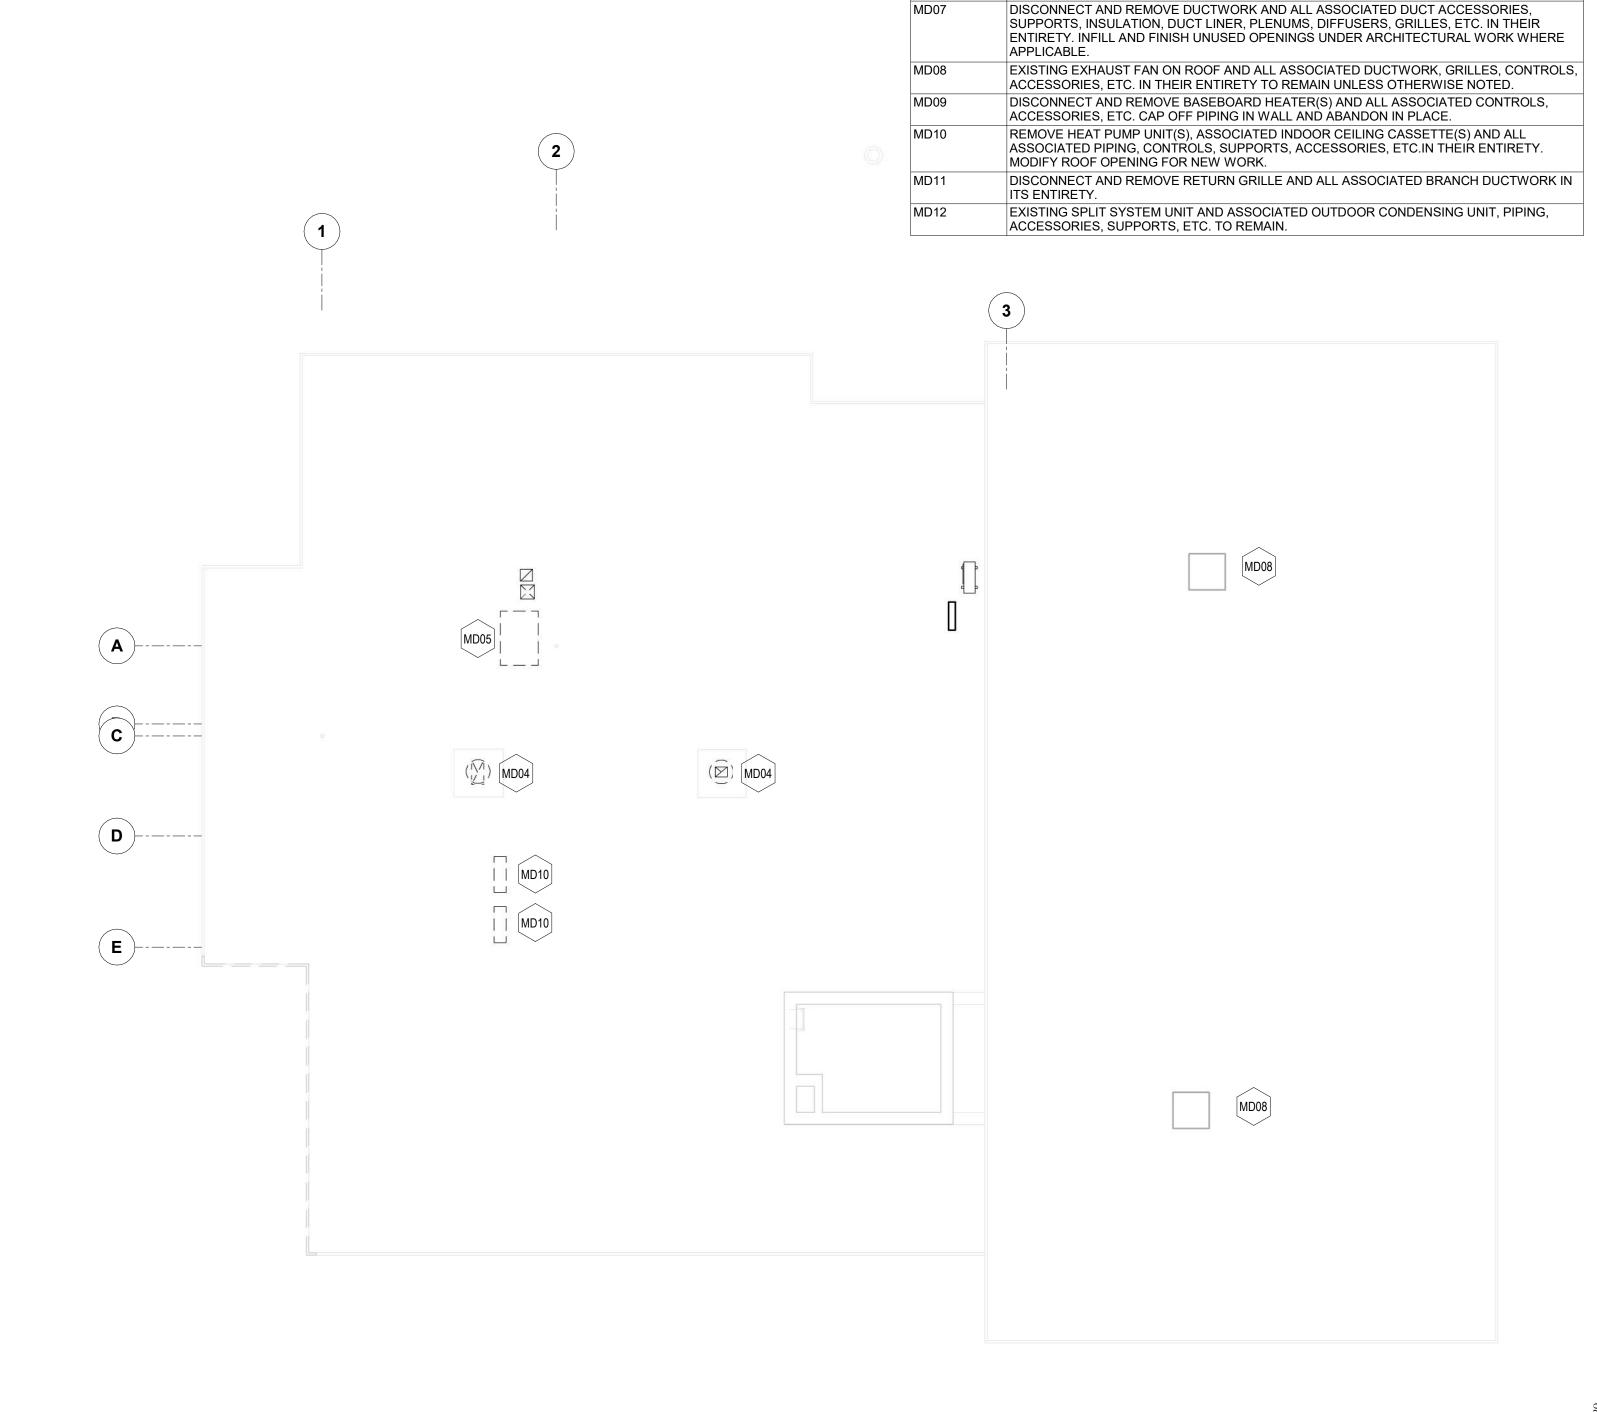

MECHANICAL - FIRST FLOOR PLAN - DEMOLITION

1/8" = 1'-0"

MECHANICAL - ROOF PLAN - DEMOLITION

SUBDIVISION: FULLERTON

SEAL	PROFESSIONAL CERTIFICATION		AS-BUILT / REV	ISION	BY I	DATE	P.W.A. NO.	KEY SHEET	POSITION SHT	DRAWIN	G SCALE		
WILLIAM OF MADIN	I HEREBY CERTIFY THAT THESE DOCUMENTS APPROVED BY ME, AND THAT I AM A DULY LIC		BID/PERMIT			9/20/24	-	MSW	27NE21	PLAN SCALE:	AS INDICATED	APPROVED BY: Mihai T. Petrisor	
MARS	PROFESSIONAL ENGINEER UNDER THE LAWS O						R.O.W NO.	-	-		-	DIRECTION 10/03/2024	CTOR
	MARYLAND. LICENSE NO. 22942 EXPIRATION D.	ATE: 12-24-2024					-	-	-	PROFILE SCALE:	-	DATE: /0/03/2024	
HILLING OF THE PAIN OF THE PAI	ENGINEER: UDAY PATEL, PE, LEED BD+C	DGN BY: CCJM	BUREAU OF ENGINEERING AND CONSTRUCTION		HIGHV	WAYS	STRUCTURES	STORM DRAINS	SEWER	WATER	FIELD ENGINEER	PROPERTY MANAGEMENT	
22942 (A)	PRINCIPAL MECHANICAL ENGINEER  C.C. JOHNSON & MALHOTRA, P.C.	DWN BY: CCJM	REVIEWED BY:									APPROVED BY:	<u> </u>
JAMAAIIIIIII	400 EAST PRATT STREET, SUITE 604 BALTIMORE, MARYLAND 21202 (P) 410 461 9090	CHKD BY: CCJM	DATE REVIEWED:									DATE:	CHIEF

BALTIMORE COUNTY OFFICE OF BUDGET AND FINANCE, PROPERTY MANAGEMENT

FULLERTON FIRE STATION #8 - RENOVATION & ADDITION

FIRST FLOOR AND ROOF PLAN - DEMOLITION

4401 FITCH AVENUE, NOTTINGHAM, MARYLAND, 21236

SHEET DESIGNATION

MD100

MECHANICAL DEMOLITION KEYNOTES

DUCTWORK IN ITS ENTIRETY.

AND ROOF CURB FOR NEW WORK.

AND ROOF CURB FOR NEW WORK.

DISTRIBUTION SYSTEM.

DISTRIBUTION SYSTEM.

ITS ENTIRETY.

DISCONNECT AND REMOVE CEILING SUPPLY DIFFUSER AND ALL ASSOCIATED BRANCH

EXISTING UNIT HEATER(S) AND ASSOCIATED PIPING AND CONTROLS SHALL REMAIN UNLESS OTHERWISE INDICATED. EXTEND AND RECONNECT PIPING TO MAINTAIN THE CIRCULATION LOOP WHERE REQUIRED. REBALANCE AFFECTED HVAC WATER

DISCONNECT AND REMOVE EXHAUST FAN ON ROOF AND ALL ASSOCIATED DUCTWORK, GRILLES, CONTROLS, ACCESSORIES, ETC. IN THEIR ENTIRETY. PREPARE ROOF OPENING

DISCONNECT AND REMOVE ROOF TOP UNIT AND ALL ASSOCIATED DUCTWORK, PIPING, GRILLES, CONTROLS, ACCESSORIES, ETC. IN THEIR ENTIRETY. PREPARE ROOF OPENING

EXISTING CONVECTOR UNIT(S) AND ASSOCIATED PIPING AND CONTROLS SHALL REMAIN UNLESS OTHERWISE INDICATED. EXTEND AND RECONNECT PIPING TO MAINTAIN THE

CIRCULATION LOOP WHERE REQUIRED. REBALANCE AFFECTED HVAC WATER

DISCONNECT AND REMOVE EXHAUST GRILLE AND ALL ASSOCIATED BRANCH DUCTWORK IN

JOB ORDER NUMBER
241-220-0054-0012
SHEET 36 of 58
DRAWING NUMBER

CONTRACT NUMBER


22221 PFO

DRAWING NUMBER

2022-2352

FILE NO.: 20-120

REV. 10/13

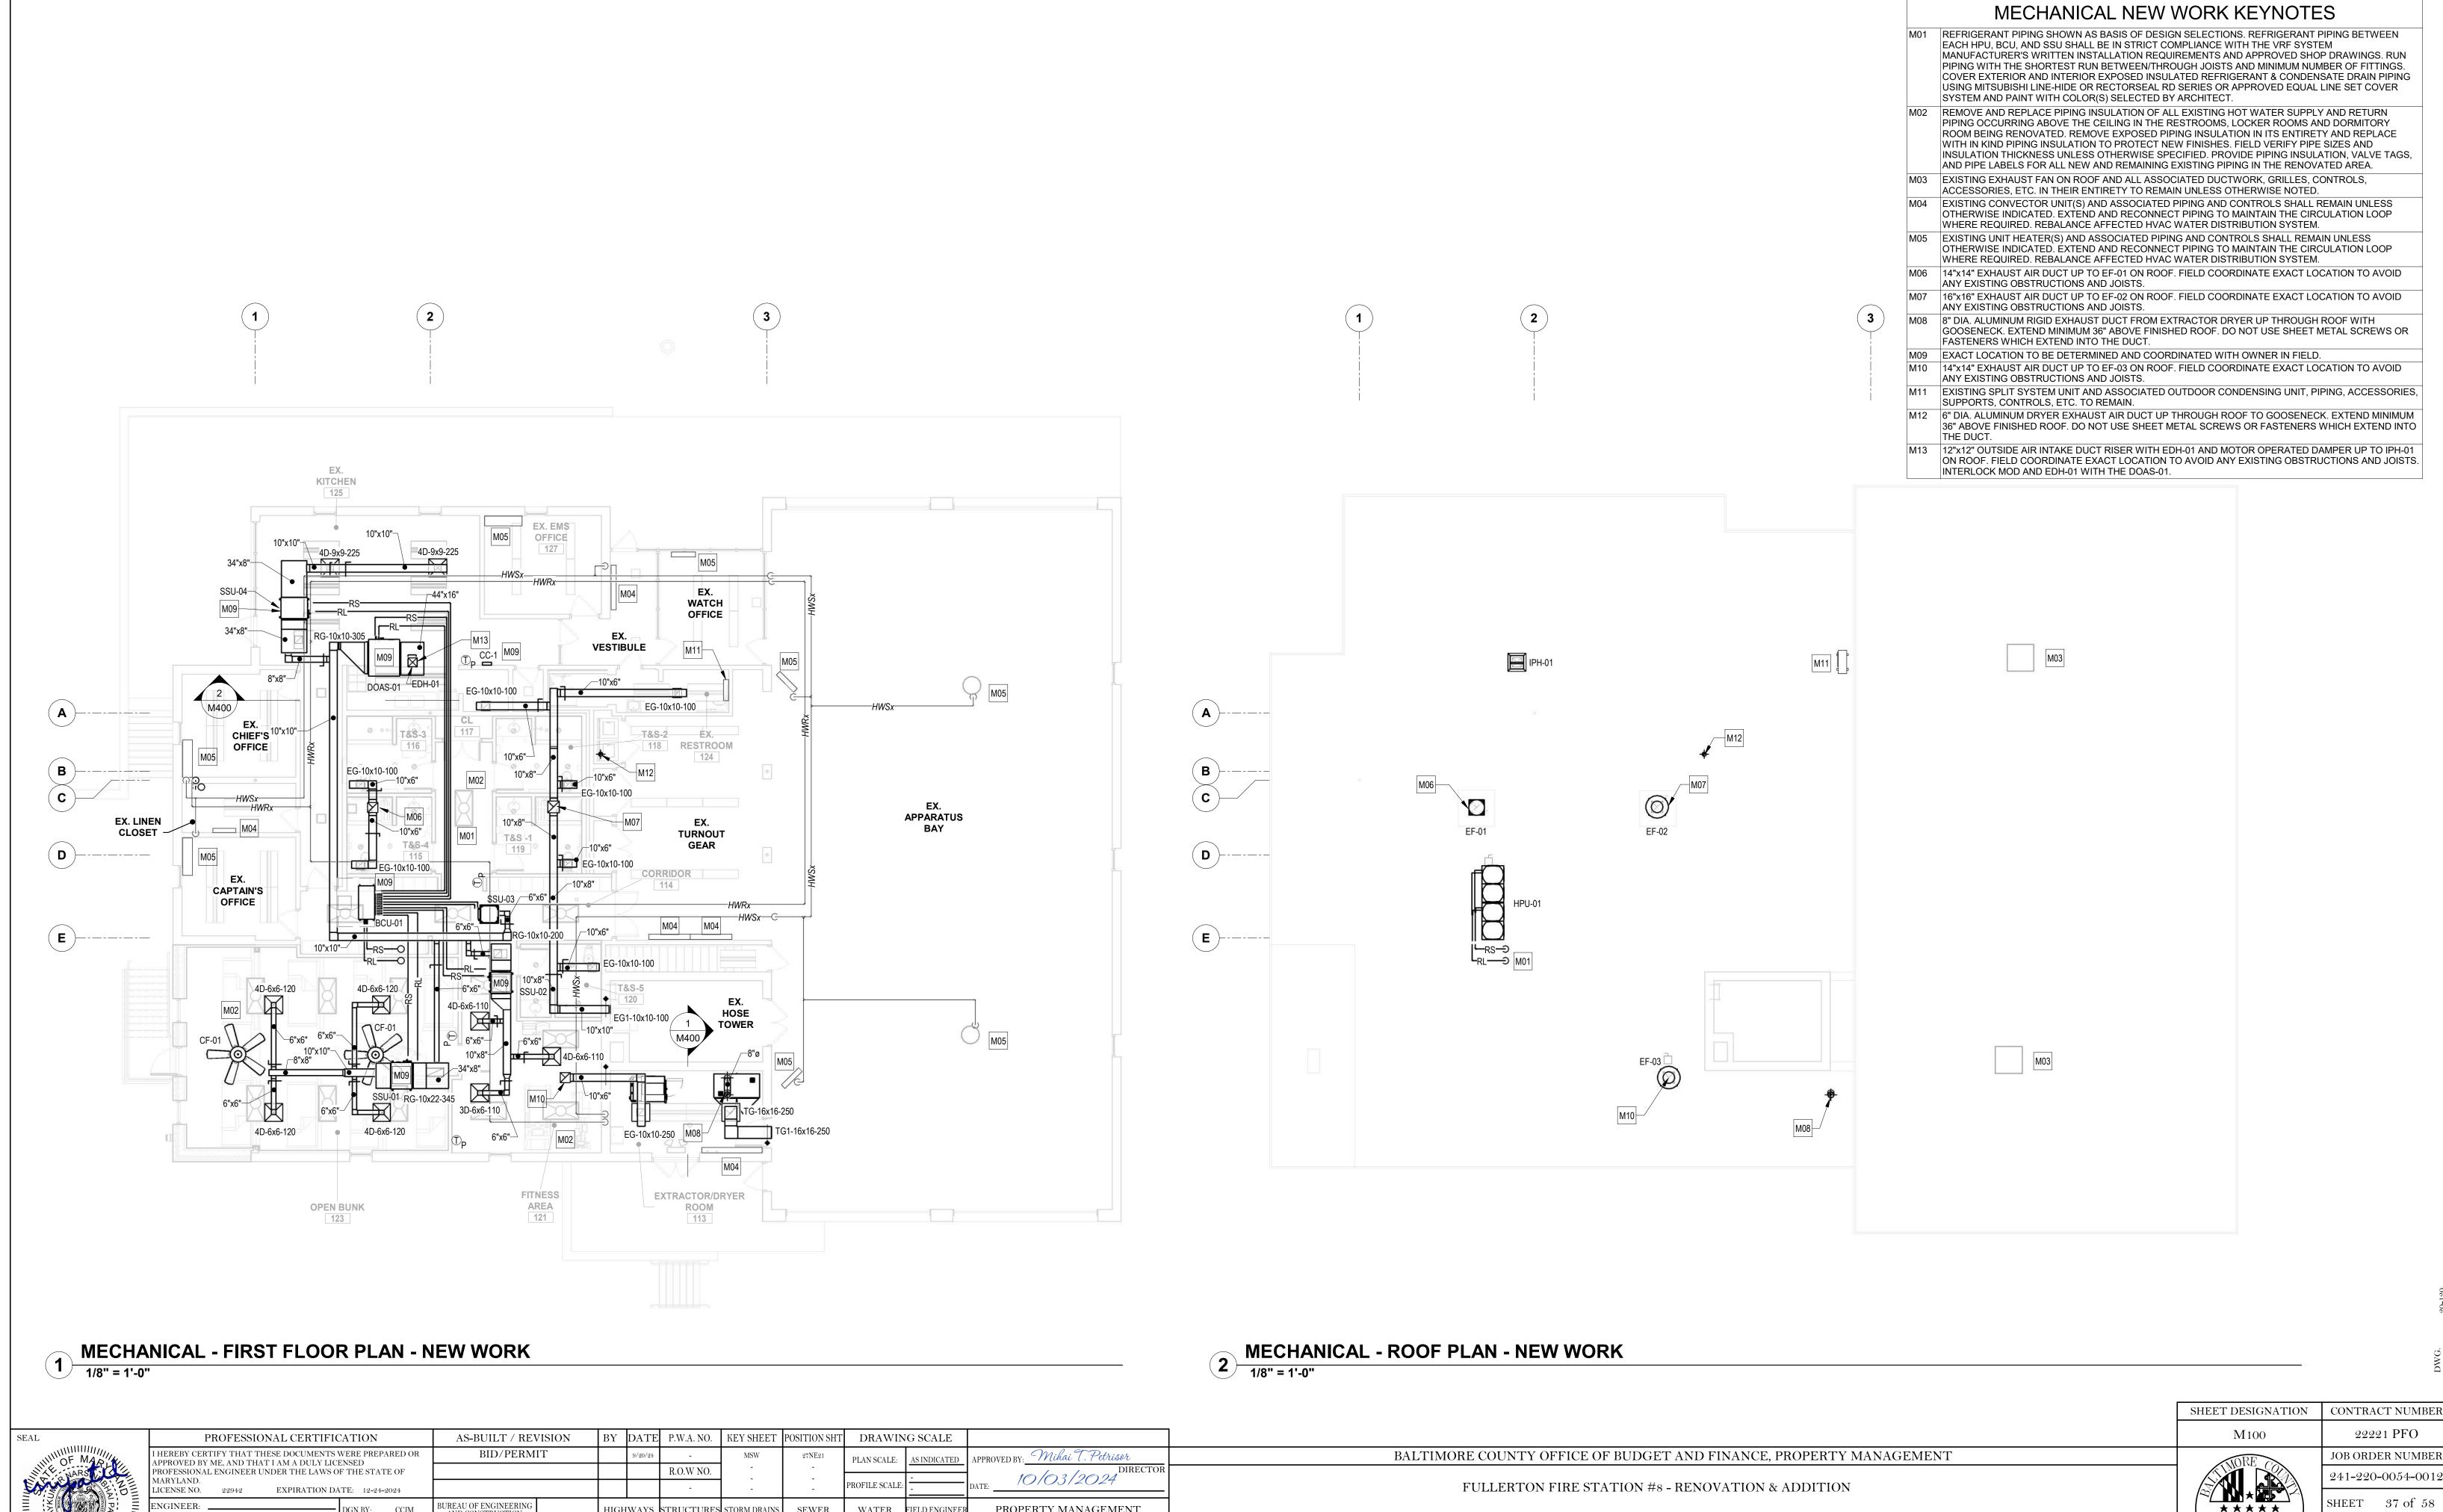

BUREAU OF ENGINEERING AND CONSTRUCTION HIGHWAYS STRUCTURES STORM DRAINS SEWER WATER PROPERTY MANAGEMENT DAY PATEL, PE, LEED BD+C RINCIPAL MECHANICAL ENGINEER REVIEWED BY: EAST PRATT STREET, SUITE 604 TIMORE, MARYLAND 21202 DATE REVIEWED:


FIRST FLOOR AND ROOF PLAN - NEW WORK


4401 FITCH AVENUE, NOTTINGHAM, MARYLAND, 21236

ELECTION DIST. NO.: 14C5

JOB ORDER NUMBER DRAWING NUMBER

2022-2353 FILE NO.: 20-120

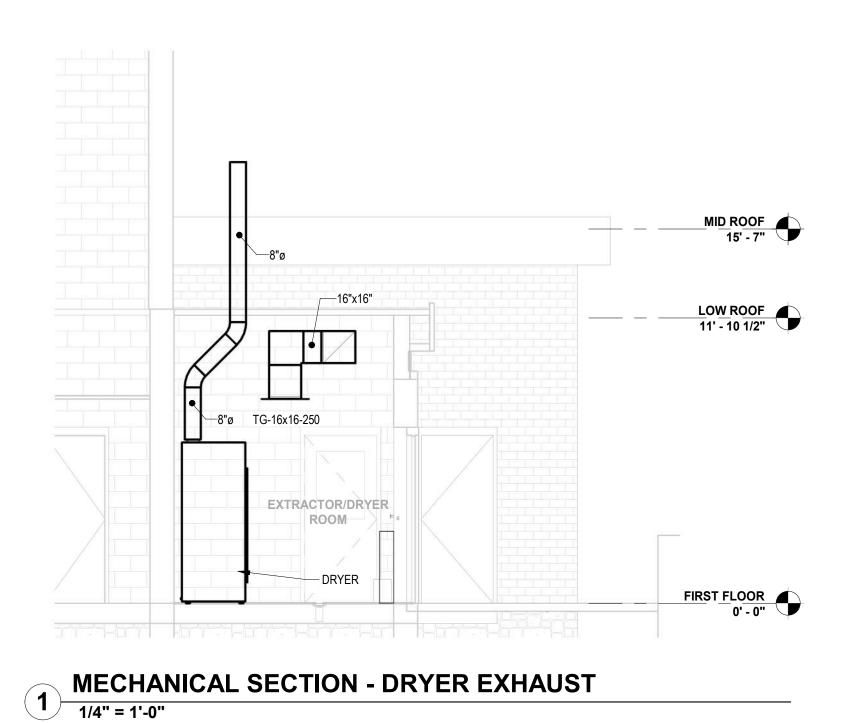

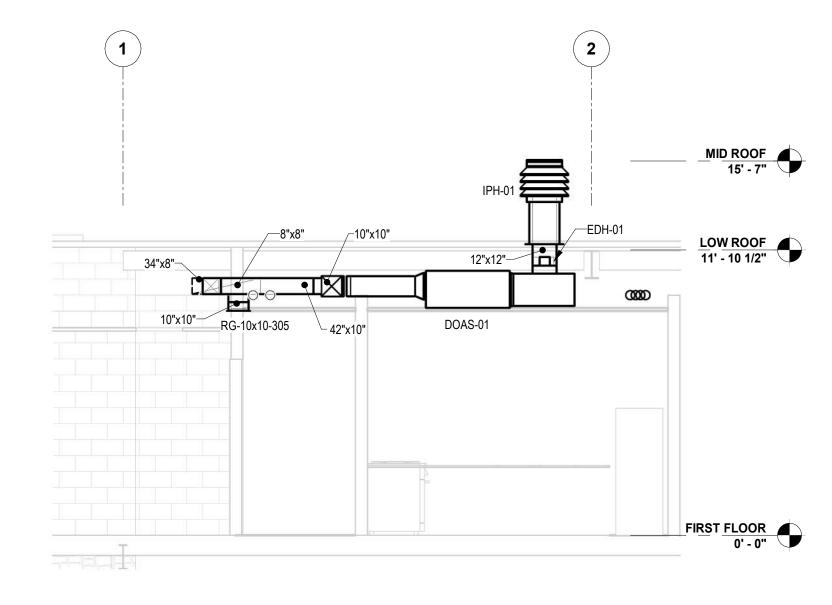

MECHANICAL SECTION - DOAS UNIT

1/4" = 1'-0"

BY DATE P.W.A. NO. KEY SHEET POSITION SHT DRAWING SCALE AS-BUILT / REVISION PROFESSIONAL CERTIFICATION I HEREBY CERTIFY THAT THESE DOCUMENTS WERE PREPARED OR APPROVED BY ME, AND THAT I AM A DULY LICENSED PROFESSIONAL ENGINEER UNDER THE LAWS OF THE STATE OF MARYLAND. BID/PERMIT APPROVED BY: Mihai T. Petrisor PLAN SCALE: 10/03/2024 DIRECTOR R.O.W NO. LICENSE NO. 22942 EXPIRATION DATE: 12-24-2024 ENGINEER: BUREAU OF ENGINEERING AND CONSTRUCTION PROPERTY MANAGEMENT HIGHWAYS STRUCTURES STORM DRAINS SEWER WATER UDAY PATEL, PE, LEED BD+C PRINCIPAL MECHANICAL ENGINEER REVIEWED BY: APPROVED BY: C.C. JOHNSON & MALHOTRA, P.C. 400 EAST PRATT STREET, SUITE 604 BALTIMORE, MARYLAND 21202 (P) 410-461-9920 DATE REVIEWED:

FULLERTON FIRE STATION #8 - RENOVATION & ADDITION

SECTIONS

BALTIMORE COUNTY OFFICE OF BUDGET AND FINANCE, PROPERTY MANAGEMENT

4401 FITCH AVENUE, NOTTINGHAM, MARYLAND, 21236


ELECTION DIST. NO.: 14C5

22221 PFO JOB ORDER NUMBER 241-220-0054-0012 SHEET 38 of 58


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SHEET DESIGNATION | CONTRACT NUMBER


DRAWING NUMBER 2022-2354

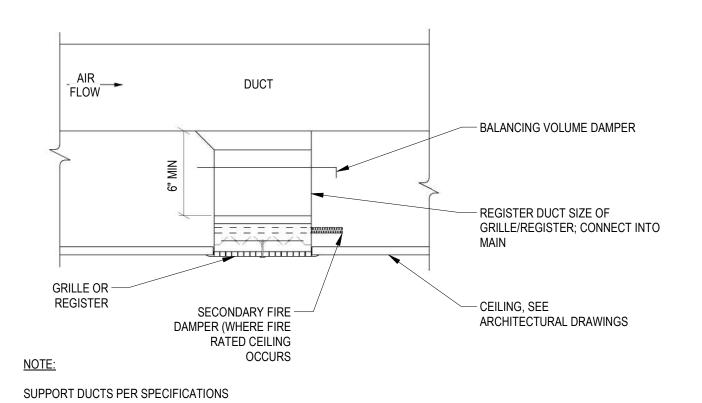


### HVAC DETAIL - GRILLE/REGISTER CONNECTION - TYPICAL 1) NOT TO SCALE

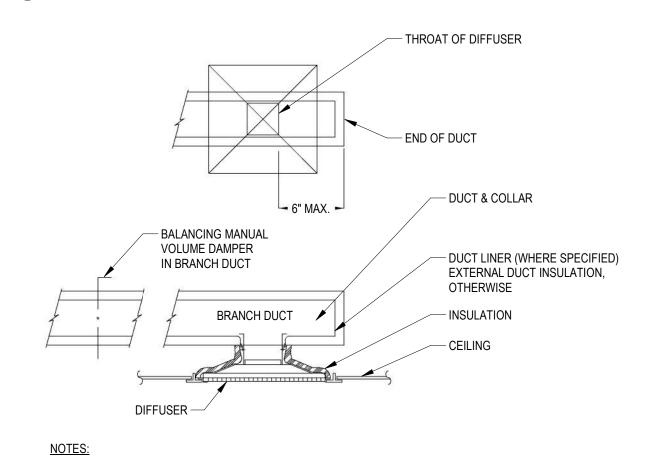


FLEXIBLE DUCT IS NOT ACCEPTABLE. MANUAL VOLUME DAMPER IN DIFFUSER NECK IS NOT ACCEPTABLE.

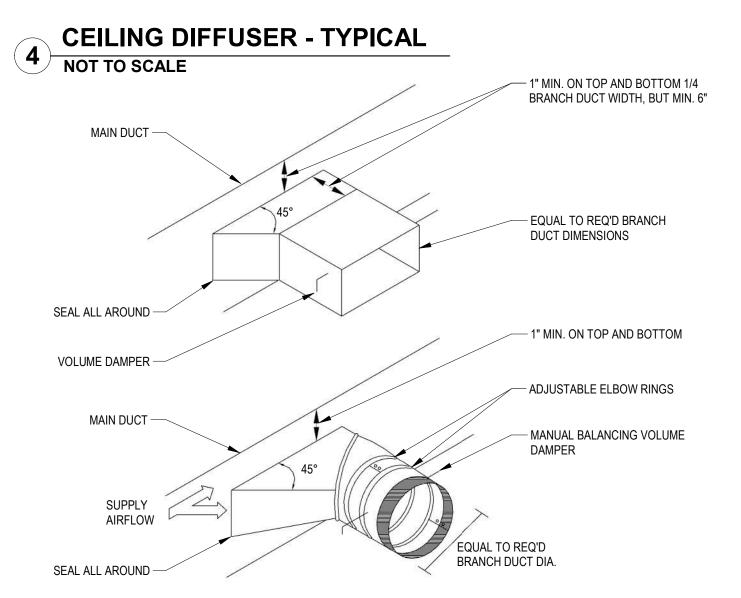

**BRANCH DUCT TAKE-OFF FITTING - TYPICAL** 

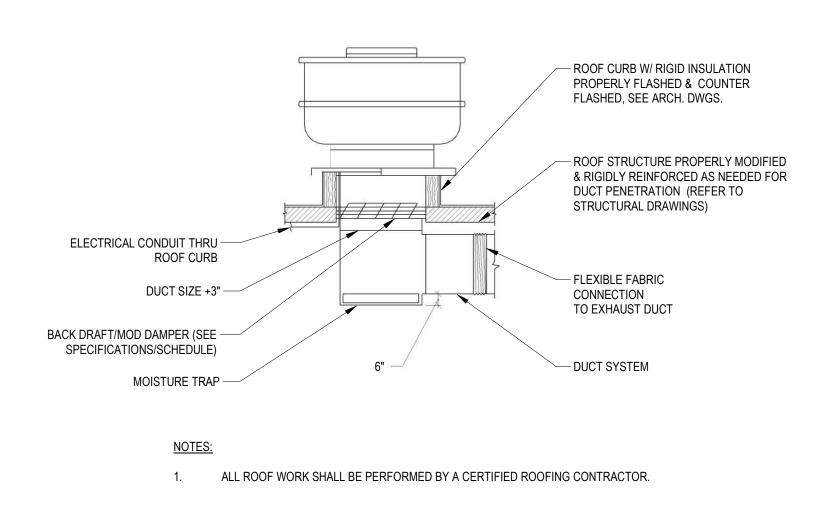


# 2 HVAC DETAIL - ROOF TOP EXHAUST FAN - TYPICAL NOT TO SCALE

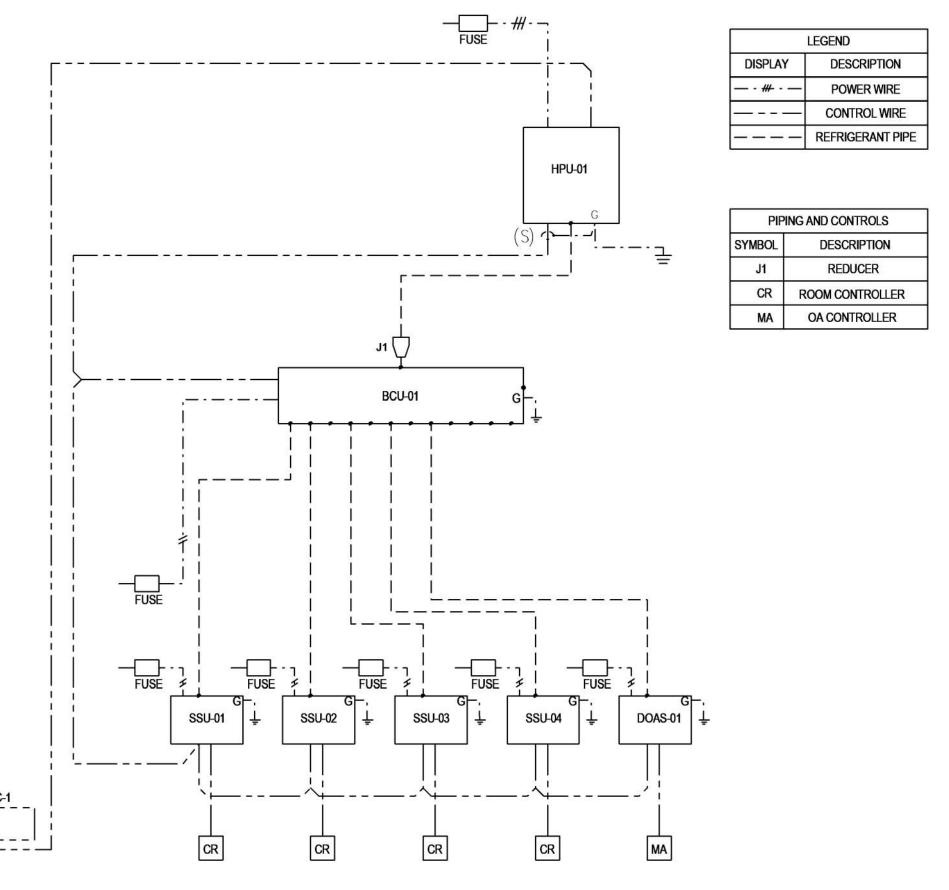


SUBDIVISION: FULLERTON

6 VARIABLE REFRIGERANT FLOW (VRF) - SYSTEM SCHEMATIC NOT TO SCALE

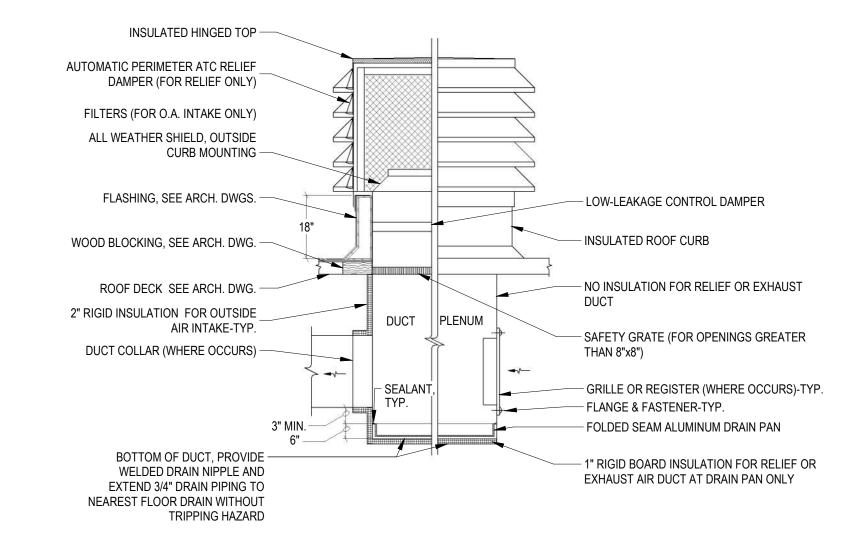

### **RELIEF/OAI PENTHOUSE - TYPICAL**

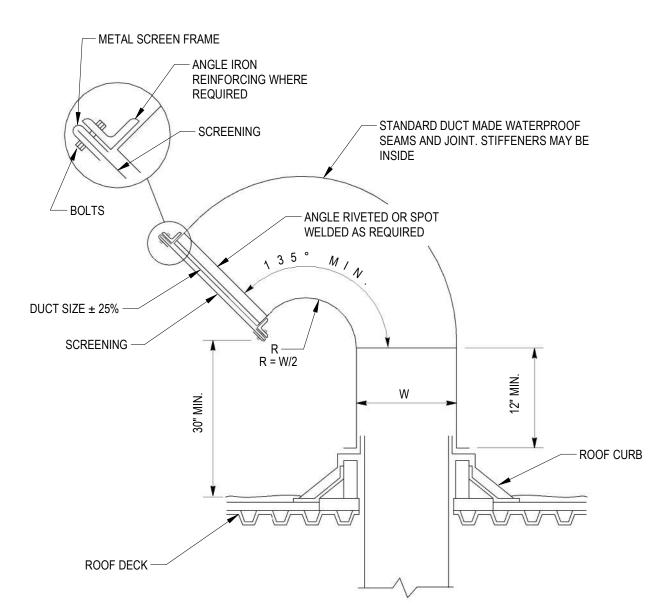

NOTES:

- SEE ARCHITECTURAL DRAWINGS FOR ROOF PENETRATION DETAILS, WHERE OCCURS. GOOSENECK SHALL BE MIN. 0.034 INCH THK. ASTM A653, G90 GALVANIZED STEEL OR 0.032 INCH THK, ASTM B209 ALLOY 3003,
- H14 TEMPER ALUMINUM. FINISH AND COLOR AS SELECTED BY ARCHITECT.
- INSECT SCREENING, INTAKE AIR: ALUMINUM, 18-BY-16 MESH, 0.012-INCH WIRE OR STAINLESS STEEL, 18-BY-18 MESH, 0.009
- BIRD SCREENING, EXHAUST AIR: ALUMINUM, 1/2-INCH SQUARE MESH, 0.063-INCH WIRE OR STAINLESS-STEEL, 1/2-INCH SQUARE MESH, 0.047-INCH WIRE.


# HVAC DETAIL - RECTANGULAR GOOSENECK - TYPICAL


M500 BALTIMORE COUNTY OFFICE OF BUDGET AND FINANCE, PROPERTY MANAGEMENT FULLERTON FIRE STATION #8 - RENOVATION & ADDITION

SEAL	PROFESSIONAL CERTIFIC	CATION	AS-BUILT / REV	ISION	BY	DATE	P.W.A. NO.	KEY SHEET	POSITION SHT	DRAWIN	G SCALE	
WILLIAM OF MARIA	I HEREBY CERTIFY THAT THESE DOCUMENTS APPROVED BY ME, AND THAT I AM A DULY LIC		BID/PERM	ΙΤ		9/20/24	-	MSW	27NE21	PLAN SCALE:	NONE	APPROVED BY: Mihai T. Petrisor
	PROFESSIONAL ENGINEER UNDER THE LAWS O MARYLAND.						R.O.W NO.	-	-		-	DIRECT 10/03/2024
		ATE: 12-24-2024					-	-	-	PROFILE SCALE:	-	DATE:
PAZZ PAZZ PAZZ PAZZ PAZZ PAZZ PAZZ PAZZ	ENGINEER:	DGN BY: CCJM	BUREAU OF ENGINEERING AND CONSTRUCTION		HIGH	WAYS	STRUCTURES	STORM DRAINS	SEWER	WATER	FIELD ENGINEEF	PROPERTY MANAGEMENT
	PRINCIPAL MECHANICAL ENGINEER  C.C. JOHNSON & MALHOTRA, P.C.	DWN BY: CCJM	REVIEWED BY:									APPROVED BY:
	400 EAST PRATT STREET, SUITE 604 BALTIMORE, MARYLAND 21202 (P) 410-461-9920	CHKD BY: CCJM	DATE REVIEWED:									DATE:


DETAILS I

4401 FITCH AVENUE, NOTTINGHAM, MARYLAND, 21236

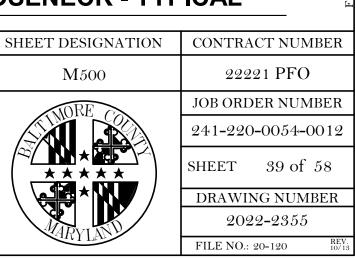

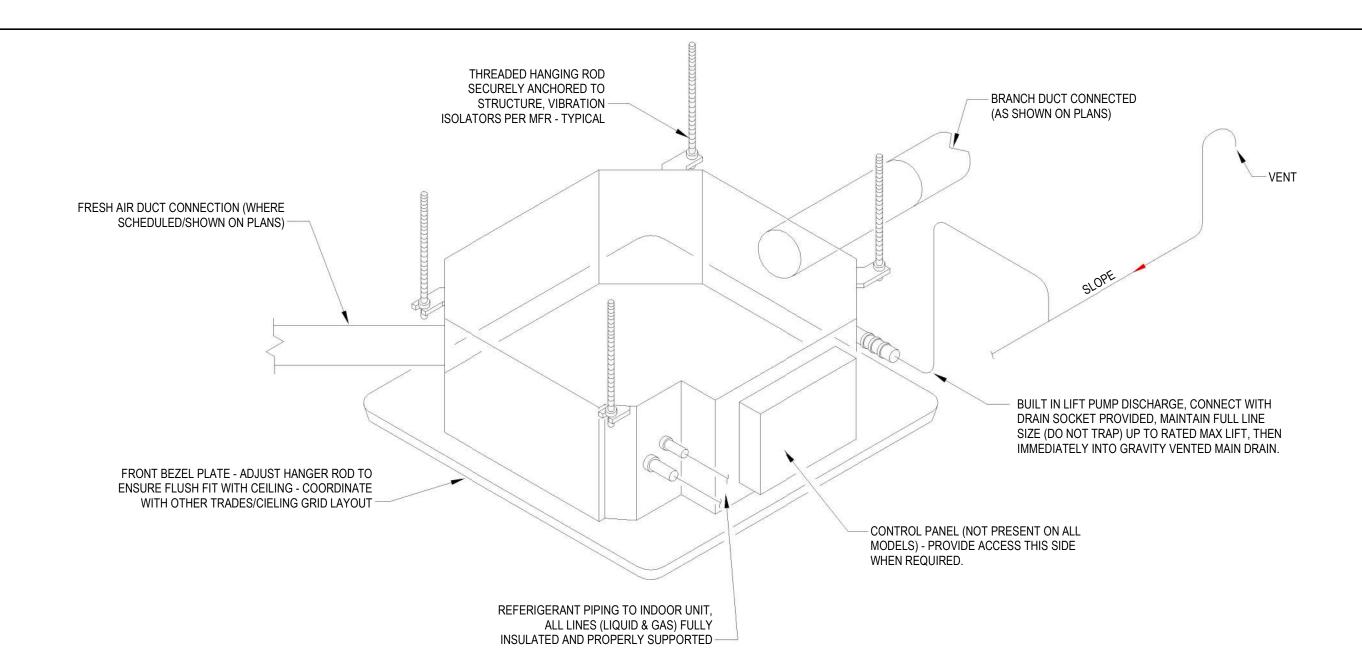

### VRF CASSETTE INDOOR UNIT DETAIL - TYPICAL

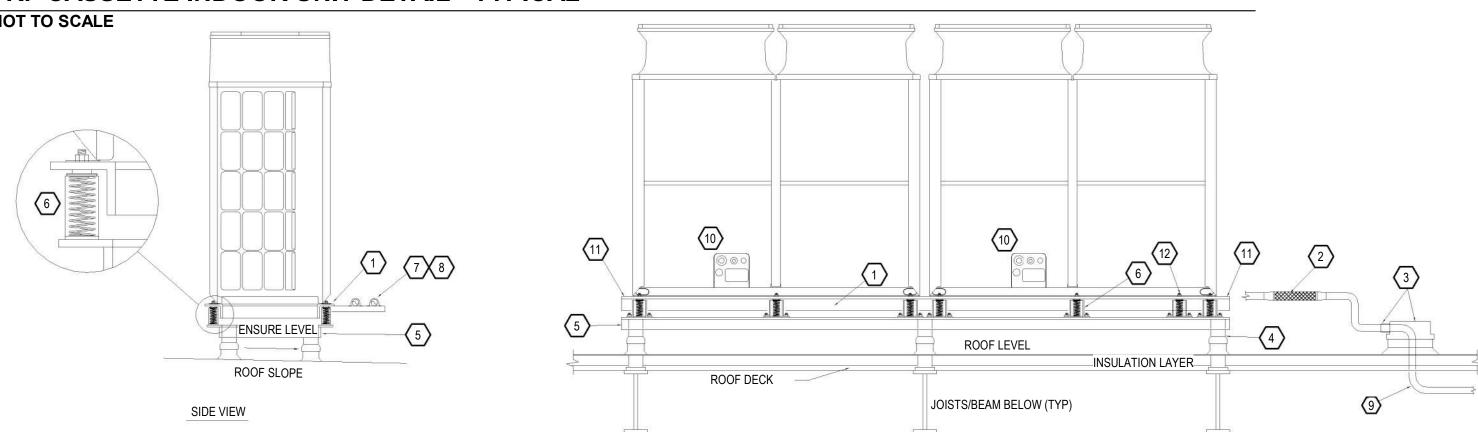


# CODED NOTES:

- PROVIDE STRUCTURAL INTERSTITIAL ANGLE IRON MOUNTING MEMBER OR SIMILAR ATTACHED DIRECTLY TO BOTTOM OF UNIT MOUNTING FLANGE AND PROVIDE CROSS BRACING FOR RIGIDITY. ENSURE IT CARRIES FULL MOUNTING FOOT WIDTH ON UNIT. FINAL SPECIFICATION OF MEMBER BY DELEGATED DESIGN STRUCTURAL ENGINEER.
- PROVIDE BRAIDED COPPER FLEXIBLE CONNECTOR, R410A RATED, 650PSI MAX WORKING PRESSURE, PACKLESS INDUSTRIES OR EQUAL ON ALL MAIN PIPING DOWNSTREAM OF TWINNING KITS/CONVERGING FITTINGS PRIOR TO PENETRATION THROUGH ROOF.
- PIPE PORTAL SYSTEM WITH ROOF CURB. FLASHED AND SEALED WATER TIGHT, PROVIDE FLEXIBLE WATER TIGHT COLLAR TO ALLOW FOR MOVEMENT WHERE PIPE ENTERS CURB. DO NOT ENTER PIPE CURB FROM VERTICAL DIRECTION. SEE DETAIL 2/M501.
- TYPICAL BASE SUPPORT POSTS, SECURELY ANCHORED TO BUILDING STRUCTURE BELOW, QUANTITY, SIZE, AND CARRYING CAPACITY DETERMINED BY DELEGATED DESIGN STRUCTURAL ENGINEER.
- STRUCTURAL ANGLE IRON BASE MOUNTING FRAME WITH CROSS MEMBERS FOR RIGIDITY FINAL SIZING BY DELEGATED DESIGN STRUCTURAL ENGINEER.
- VIBRATION SPRING SLR TYPE ISOLATORS (MASON INDUSTRIES OR EQUIV.) WITH RUBBER BASE PADS, SECURELY FASTENED TO STRUCTURAL BASE AND TO VRF UNIT INTERSTITIAL SUPPORT STEEL. SPRING ISOLATOR TO PROVIDE MINIMUM 1" DEFLECTION OR 10 TIMES THE STATIC DEFLECTION OF THE ROOF DECK FROM EQUIPMENT WEIGHT - DETERMINED BY STRUCTURAL ENGINEER OF RECORD. AT A MINIMUM, PROVIDE SPRING ISOLATORS AT EACH EQUIPMENT BASE MOUNTING HOLE LOCATION.
- 7. IF REQUIRED, ONLY SUPPORT LATERAL PIPE EMANATING FROM VRF UNIT CONNECTIONS BY CROSS MEMBER SUPPORT THAT IS ATTACHED DIRECTLY TO VRF UNIT MOUNTING ANGLE IRON FRAME ABOVE SPRING ISOLATORS. DO NOT ATTACH ANY PIPING TO LOWER FIXED SUPPORT BASE.
- 8. USE NEOPRENE ISOLATION COLLARS ON PIPE CLAMS WHEN FASTENING PIPING TO SUPPORTS.
- USE LONG RADIUS SWEEPING COPPER ACR TUBE PIPE BENDS WHERE PIPE ENTERS BUILDING AT FIRST ELBOW INTO CEILING SPACE TO MINIMIZE REFRIGERANT FLOW NOISE AND VIBRATION.
- 10. ALL ELECTRICAL CONNECTIONS TO UNITS TO BE VIA FLEXIBLE CONDUIT, PROVIDE SUFFICIENT SLACK TO ALLOW FOR UNIT MOVEMENT ON SPRING ISOLATORS.
- 11. ENSURE CROSS MEMBERS OF INTERSTITIAL FRAME AND BOTTOM SUPPORT FRAME ARE NOT DIRECTLY BELOW ENDS OF MODULES IN ALL LOCATIONS AND DO NOT BLOCK DRAINAGE WEEP HOLES IN BOTTOM OF UNIT CASING, FAILURE TO DO THIS MAY RESULT IN ICE DAMMING/BUILDUP BENEATH UNIT AND SUBSEQUENT BUILDUP OF ICE IN BOTTOM OF UNIT CASING BELOW COIL AND POTENTIAL DAMAGE TO BOTTOM OF COIL.
- 12. WHEN SELECTING SPRING ISOLATORS ALWAYS CONSIDER WEIGHT DISTRIBUTION BY REFERENCING EQUIPMENT WEIGHT AND CENTER OF GRAVITY. NEAR RIGHT ENDS OF UNITS (VIEWED FROM FRONT PANEL) SPRING WEIGHT CAPACITY MAY BE LARGER. IF HIGHER SPRING WEIGHT CAPACITY IS REQUIRED VS OTHER SPRING LOCATIONS, CONSIDER AN ADDITIONAL SPRING OF EQUAL "K" VALUE (LBS/IN) NEAR RIGHT END OF LAST MODULE. IN GENERAL, SELECT ALL MOUNTING SPRINGS OF EQUIVALENT "K" VALUE (LBS/IN).


FRONT VIEW

### VRF OUTDOOR EQUIPMENT SUPPORT DETAIL


SEAL	PROFESSIONAL CERTIF	ICATION	AS-BUILT / REVISION	BY	DATE	P.W.A. NO.	KEY SHEET	POSITION SHT	DRAWIN	G SCALE	
WILLIAM OF MADIN	I HEREBY CERTIFY THAT THESE DOCUMENT APPROVED BY ME, AND THAT I AM A DULY LI		BID/PERMIT		9/20/24	-	MSW	27NE21	PLAN SCALE:	NONE	APPROVED BY: Mihai T. Petrisor
MARS	PROFESSIONAL ENGINEER UNDER THE LAWS MARYLAND.					R.O.W NO.		-		-	DIRECT 10/03/2024
\$ \$ \$ \$ \$ \$ \$ \$ \$ \$ \$ \$ \$ \$ \$ \$ \$ \$ \$		DATE: 12-24-2024				-	-	-	PROFILE SCALE:	-	DATE: /0/03/2024
A NAMA CALLARY	ENGINEER:UDAY PATEL, PE, LEED BD+C	DGN BY: CCJM	BUREAU OF ENGINEERING AND CONSTRUCTION	HIG	HWAYS	STRUCTURES	STORM DRAINS	SEWER	WATER	FIELD ENGINEEF	PROPERTY MANAGEMENT
22942 NG	PRINCIPAL MECHANICAL ENGINEER  C.C. JOHNSON & MALHOTRA, P.C.	DWN BY: CCJM	REVIEWED BY:								APPROVED BY:CHI
DATE:	400 EAST PRATT STREET, SUITE 604 BALTIMORE, MARYLAND 21202 (P) 410-461-9920	CHKD BY: CCJM	DATE REVIEWED:								DATE:

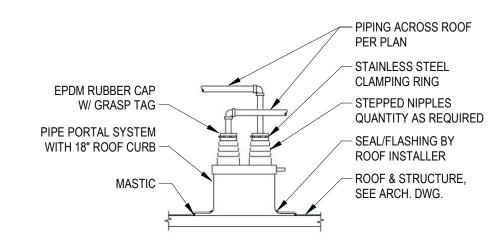

PIPE PORTAL - TYPICAL

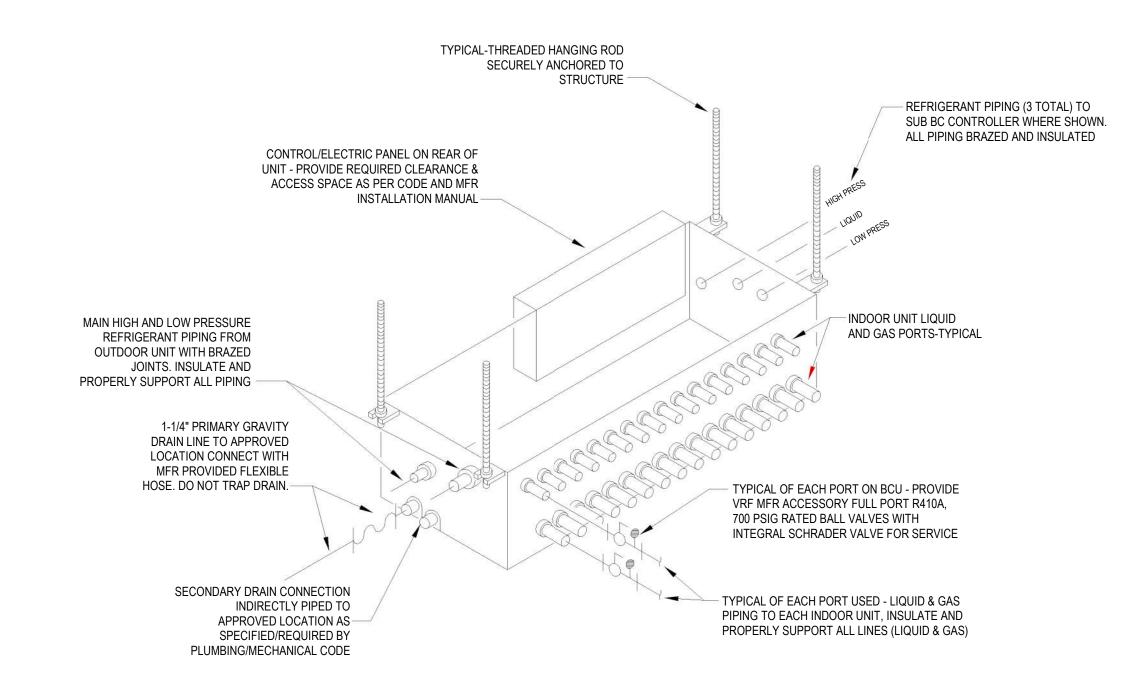

### VRF HEAT RECOVERY BRANCH CIRCUIT CONTROLLER UNIT (BCU) DETAIL - TYPICAL NOT TO SCALE

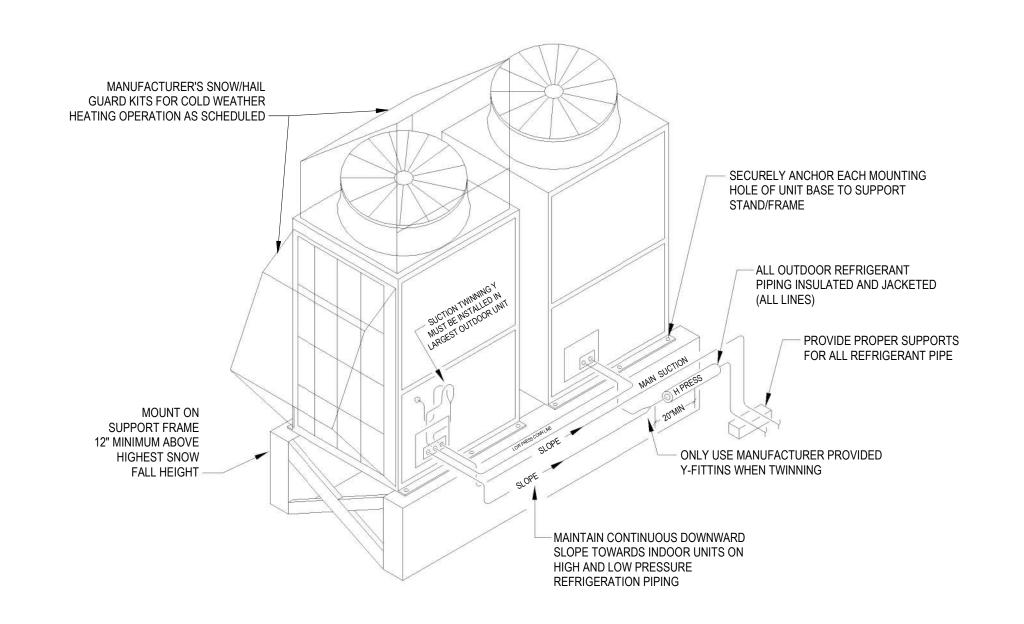

### VRF OUTDOOR HEAT RECOVERY HEAT PUMP UNIT (HPU) DETAIL - TYPICAL

BALTIMORE COUNTY OFFICE OF BUDGET AND FINANCE, PROPERTY MANAGEMENT

FULLERTON FIRE STATION #8 - RENOVATION & ADDITION

DETAILS II

SUBDIVISION: FULLERTON

4401 FITCH AVENUE, NOTTINGHAM, MARYLAND, 21236

ELECTION DIST. NO.: 14C5

SHEET DESIGNATION CONTRACT NUMBER M501 22221 PFO JOB ORDER NUMBER 241-220-0054-0012 SHEET 40 of 58 DRAWING NUMBER

2022-2356

						VARIA	BLE	REFRIC	GERANT FLO	OW (VRF	) SPLIT	SYSTEM	INDOC	OR UNIT S	SCHEDU	JLE								
			DATED COOLING	RATED	CLIDDLY	MIN.			CAPACITIES AT DESIG	N CONDITIONS					ADDDOV						ELECTR	RICAL (60 H	Z)	
TAG	DESCRIPTION	MANUFACTURER (MITSUBISHI) MODEL	RATED COOLING TOTAL CAPACITY	HEATING CAPACITY	SUPPLY AIRFLOW	OUTDOOR AIR	ESP	COOLING EDB / EWB	COOLING TOTAL / SENSIBLE	HEATING EAT	HEATING	CONDENSING / HEAT PUMP OUTDOOR UNIT	SOUND	SIZE LxWxH	APPROX. WEIGHT	DETAIL	ACCESSORIES	REMARKS	HP	MCA	МОСР	VOLTS/ PHASE	EMER.	DISC.
			МВН	МВН	CFM	CFM	IWG	°F	мвн	°F	MBH		dBA	INCHES	LBS	#/DWG#						PHASE	POWER	SWITCH
SSU-01	CEILING CONCEALED SPLIT SYSTEM UNIT (DUCTED)	PEFY-P15NMHU-E2	15.0	17.0	480	140	0.6	74 / 65	15.0 / 9.5	70	16.8	HPU-01	40	36 x 30 x 10	75	6/M500, 1/M601	2, 3, 8, 11	-	-	1.63	15	208 / 1	NO	MFR
SSU-02	CEILING CONCEALED SPLIT SYSTEM UNIT (DUCTED)	PEFY-P15NMHU-E2	15.0	17.0	330	130	0.6	75 / 65	14.5 / 9.5	70	16.8	HPU-01	40	36 x 30 x 10	60	6/M500, 1/M601	2, 3, 8, 11	<u>~</u>	-	1.63	15	208 / 1	NO	MFR
SSU-03	CEILING CASSETTE (4-WAY) DUCTLESS SPLIT SYSTEM UNIT	PLFY-P18NFMU-E	18.0	20.0	400	30	3	79 / 66	17.8 / 11.6	70	19.9	HPU-01	40	24 x 24 x 12	50	6/M500, 1/M501	2, 3, 4, 5, 10	*	-	0.50	15	208 / 1	NO	MFR
SSU-04	CEILING CONCEALED SPLIT SYSTEM UNIT (DUCTED)	PEFY-P15NMHU-E2	15.0	17.0	450	150	0.6	74 / 65	14.5 / 9.2	70	16.7	HPU-01	40	36 x 30 x 10	75	6/M500, 1/M601	2, 3, 8, 11	AS	-	1.63	15	208 / 1	NO	MFR
DOAS-01	CEILING-CONCEALED DEDICATED OUTSIDE AIR SPLIT SYSTEM UNIT	PEFY-P48NMHU-E-OA	48.0	28.0	450	450	0.8	94 / 82	43.5 / 20.3	10	34.8	HPU-01	40	48 x 36 x 15	125	6/M500, 1/M601	7, 8, 12	20	-	3.30	15	208 / 1	NO	MFR/EC
CC-1	CENTRALIZED CONTROLLER	AE-200A	-	-	-	=		:=:	-	8.5	₹:	<b>-</b> /		8x2x5		6/M500	9	PAC-YG84UTB-J ELECTRICAL BOX	55.8	-	15	120/1	NO	MFR
VRF SPLIT SYSTE	M INDOOR UNIT ACCESSORIES:								REFER TO SPECIFICAT	TIONS FOR ADD	ITIONAL VRF S	SPLIT SYSTEM INDO	OR UNIT AC	CESSORIES REQU	JIRED. DESIGN	CAPACITIES B	ASED ON FULL DEM	MAND COOLING AND HEATING DIVERSITIES.						
1.	. 1"-MERV 8 PLEATED FILTER KIT (PAC-SH89KF-E)							5.	1"-MERV 8 PLEATED FILTER KI	IT (PAC-SH90KF-E)							9.	PROVIDE AC-SC51KUA POWER SUPPLY UNIT, MINIMUM OF TWO PAC NEMA 1 ENCLOSED CONTROL PANEL ABOVE CEILING; PAC-YG10HA-I BRACKET & PAC-YG86TK-J KIT FOR BUILDING CONTROLS. PROVIDE I COORDINATE CONTROLS INTERFACE WORK WITH OWNER. PROVIDE CONNECT TO LAN PORT. PROVIDE SW-BACNET AND SW-PWEB SOFT OWNER TO INTEGRATE THESE SOFTWARE ON OWNER'S CENTRAL B	ER EXTERNA DDC CONTRO E A POWER O WARE AND A	L INPUT/OU OLLERS AN OUTLET AND ASSOCIATE	JTPUT ADAP D BMS EQUIF D A DATA OU D LICENSE A	TER AND PAC- PMENT IN MEC ITLET NEAR EA	YG84UTB MO HANICAL ROO CH CONTROI	OUNTING OM (008). LLER AND
2.	DELUXE WIRED MA REMOTE CONTROLLER (PAR-40MAAU). TI	HREE POLE DISCONNECT SWITC	:H (TAZ-MS303).					6.	1"-MERV 10 PLEATED FILTER N	KIT (PAC-SH59KF-E)							10.	48X48 CEILING INSTALLATION/TRIM PANELS (PMFY-ITP1 / PLFY-ITP1 /	PLFY-ITP2).	3				
3.	INTEGRAL CONDENSATE PUMP KIT (PAC-SH84DM-E) OR DRA	NIN WATER LIFT-UP KIT (X87-721).	DRAIN PAN LEVEL SENSOR.				1	7.	BUILT-IN CONDENSATE LIFT M	MECHANISM. DRAIN F	AN LEVEL SENSOR						11.	FILTER BOX WITH REAR OR BOTTOM RETURN AIR INLETS AS REQUIR ANGLED CONFIGURATION (FBM OR FBH SERIES)	RED TO SUIT	INSTALLAT	TION AND WIT	H 2" MERV-13	PLEATED FIL	TERS IN
4.	. 3D I-SEE SENSOR WITH MOUNT/PANEL (PAC-SH91MK-E OR P.	AC-SA1ME OR PAC-SF1ME-E AS A	APPLICABLE).					8.	M-NET ADAPTER (PAC-SF81MA	A)							12.	FILTER BOX INSULATED PLENUM WITH 2" MERV-13 PLEATED FILTERS (PAR-30MAOA), CN24 RELAY KIT( CN24RELAY-KIT-CM3), THREE POLE	S IN VERTICA DISCONNEC	L CONFIGU T SWITCH	JRATION (FBI (TAZ-MS303).	102-3), MA REI	MOTE CONTR	OLLER

						VARIAE	BLE REFR	RIGERA	NT FI	LOW (\	VRF) S	SPLIT	SYST	EM O	JTDOOR	UNIT SC	HEDU	LE							
		MANUFACTURER	RATED COOLING	RATED HEATING	DESIGN COOLING	DESIGN HEATING		AHRI		COOLING DB/WB	HEATING DB/WB	G NO. OF	F	ANS	SOUND dBA	SIZE LxWxH	APPROX. WEIGHT	DETAIL					CTRICAL (6	0 HZ)	T
TAG	DESCRIPTION	(MITSUBISHI) MODEL	CAPACITY	CAPACITY	CAPACITY	CAPACITY	REFRIGERANT	IEER/COP	SCHE	55/445	DB/WB	CKTS.					WEIGHT		ACCESSORIES	REMARKS	MCA	MOCP (M1/M2)	VOLTS/	EMER.	DISC.
			MBH	МВН	MBH	МВН				°F	°F		NO.	HP (EA)	@ 5 FEET	INCHES	LBS	#/DWG#			(M1/M2)	(141171412)	PHASE	POWER	SWITCH
HPU-01	AIR COOLED OUTDOOR VRF HEAT PUMP WITH HEAT RECOVERY SYSTEM	PURY-EP168TNU-A	168	188	168.6	127.2	R-410A	25.7 / 3.55	24.7	95 / 75	10/8	1	2	. <del></del> 2	65	70X30X72	800	6/M500, 3/M501, 5/M501	1, 5	FOR SSU-01 TO SSU-04 AND DOAS-01	57 / 53	90 / 80	208/3	NO	EC
BCU-01	HEAT RECOVERY CONTROL UNITS - MAIN BRANCH CONTROLLER	CMB-P1012NU-JA1	N/A	N/A	N/A	N/A	R-410A	N/A	N/A	N/A	N/A	N/A	N/A	N/A	N/A	44x21x10	200	6/M500, 4/M501	4	CONNECT TO HPU-01, MAX. 16 BRANCHES	1.57	15	208 / 1	NO	EC
VRF SPLIT SY	YSTEM OUTDOOR UNIT ACCESSORIE	ES:			RATED HEATING	CAPACITIES ARI	E BASED ON INDO	OR COIL EAT	OF 70/60 °	F (DB/WB), C	OUTDOOR (	OF 43 °F (W	В)			RATED COOL	ING CAPACIT	ES ARE BASED (	ON INDOOR COIL	EAT OF 80/67 °F (DB/WB), OUTDOOR OF 95	5/75 °F (DB/WB)	).			
1.	PORT ADAPTORS, DRAIN SOCKET, AIRFLOW G GUARDS AND SHK SNOW HOOD FOR SNOW/H	GUIDE. CMY-R100XLCBK TWINNIN AIL PROTECTION. PAC-PH03EHY	IG KIT FOR MULTIPLE N U-E1 20W, 208 V / 1 PH	MODULES. PAC-SPRFCS PANEL HEATERS.	S-118/138/158RCW REFRI	GERANT FILTER / CLE	EANING SYSTEM. SGN SI	ERIES SIDE, FROM	NT AND REAR	SNOW/HAIL		4 INCLUDE S PRESSUR	OINT ADAPTO E, FULL PORT,	RS; BRANCH JO 110A RATED BA	DINT; X87-721 [MBC] / SI3 ALL VALVES.	0-230 [SBC] CONDEN	SATE PUMP; DIAM	ONDBACK BV-SERIES,	700 PSIG WORKING						
2.	CMY-Y102LS-G2 T-BRANCH JOINT (73-144 MBH	), CMY-Y108C-G HEADER FOR 8 E	BRANCHES, LOW AMBI	ENT KIT.								5 MINIMUM 2 APPROVE	24" HIGH EQUIF D EQUAL BY IN	MENT SUPPOR STALLER.	RT RAILS OR BIG FOOT F	ROOF MOUNTED SUP	PORT SYSTEM BY	THE RECTORSEAL CO	DRPORATION OR						
3.	LOW AMBIENT HOOD KIT WITH ASSOCIATED W	VIND BAFFLES (WB-PA2) FOR 100	% LOW AMBIENT COOL	LING DOWN TO MINUS	10 °F, AIR OUTLET GUIDE	(PAC-SG59SG).						6 FRONT AN	D SIDE ADVAN	CED WIND BAF	FLES (WB-PA4 & WB-SD	04) FOR 100% LOW AN	BIENT COOLING	DOWN TO MINUS 20 °F	TO 115 °F.						

TAG									I IVILINI	POWER	K AFIALI	LATOR	<b>15 SCI</b>	HEDULE									
TAG					CAPACI	TY		ROOF/WALL	MECHANICAL	FAN	SIZE	APPROX.	DETAIL					FAN DATA		E	ELECTRICA	L (60 HZ)	
	AREA SERVED	DESCRIPTION	MANUFACTURER - MODEL	DRIVE	AIRFLOW	ESP	SOUND NC	OPENING	EFFICIENCY	EFFICIENCY GRADE	LxWxH OR DIA. x H	WEIGHT	DETAIL	ACCESSORIES	CONTROLS	REMARKS	FAN SPEED	MOTOR SPEED	FAN MOTOR	FAN MOTOR	VOLTS/	EMER.	DISC.
					CFM	IWG	dBA	INCHES	%		INCHES	LBS	#/SHT#	7			RPM	RPM	BHP	HP/WATTS	PHASE	POWER	SWITCH
EF-01	T&S-3, T&S-4	ROOF MOUNTED UPBLAST CENTRIFUGAL FAN	LOREN COOK - ACRUD - VF - 100R17DL (VF)	DIRECT	200	0.50	55	14 x 14	32	in the second se	22 x 17	90	2/M500	1,3,4,5	DDC TIME SCHEDULE W/ AUTO-ON-OFF SWITCH	£	1360	1725	0.05	0.25/-	208 / 1	NO	MFR
EF-02 T8	T&S-1, T&S-2, T&S-5, EX. WOMEN'S LOCKER ROOM,	ROOF MOUNTED UPBLAST CENTRIFUGAL FAN	LOREN COOK - ACRUD - VF - 120R28D OR91VF	DIRECT	600	0.75	63	16 x 16	39		31 x 29	125	2/M500	1,3,4,5	DDC TIME SCHEDULE W/ AUTO-ON-OFF SWITCH	-	1395	2800	0.18	0.75/-	208 / 1	NO	MFR
EF-03	EXTRACTOR/DRYER ROOM	ROOF MOUNTED UPBLAST CENTRIFUGAL FAN	LOREN COOK - ACRUD - VF - 120R17D OR81VF	DIRECT	250	0.5	57	16 x 16	28	-	31 x 29	120	2/M500	1,3,4,5	DDC TIME SCHEDULE W/ AUTO-ON-OFF SWITCH	LT.	1125	1725	0.07	0.33/-	120 / 1	NO	MFR
CF	DORMITORY	CEILING FAN	HUNTER - DEMPSEY 59247	DIRECT	22	4	•		200 200	ğ	52	3	-	10	ON/OFF WALL SWITCH WITH SPEED CONTROL	LOW PROFILE, BLACK OAK BLADES AND BRUSHED NICKEL FINISH	E	E	-	12 27	120 / 1	NO	EC
HE SCHEDULE NOTE	TES: [APPLY TO ALL NEW FANS]				10			AHE SCHEDULE	E OPTIONS/ACCE	SSORIES: (AS SCH	HEDULED)											,	
INSTALL FIXED SHEAVES A	S AFTER FINAL BALANCING FOR EACH B	BELT DRIVEN FAN.							ND WIRED FAN SPEED RI-FLOW ELECTRONIC				/ITH VFRSC REM	MOTE SPEED CONTROLLI	ER AND UL VFABK AIR BALANCE	8. INTEGRAL ALUMINUM GRAVITY BACKDRAFT ISOLATORS SET, MODEL RC-75 (4), CEILING MC FILTER.	DAMPER, AND DUNTED PASS	ODIZED ALUMIN SIVE INFRARED	NUM CEILING G MOTION SENS	GRILLE, MINIMUM 1 SOR, GRILLE MOUN	I" DEFLECTION NTED WASHABI	RUBBER-IN-SI LE ALUMINUM	HEAR MESH UNIT
SOUND PERFORMANCE DO	DOES NOT INCLUDE ADJUSTMENTS FOR	R SOUND CURB.						2. WALL MOUNTED A	AND WIRED SOLID STAT	E FAN SPEED CONTR	OLLER FURNISHED	BY FAN MFR AN	D INSTALLED BY	Y HVAC CONTRACTOR.		9. LIFE SAFETY BELTS, UL APPROVED & LISTE	D FOR SMOKE	E CONTROL APP	PLICATION.				
BELT DRIVE FAN INCLUDE: ELT-TENSIONR-ROTARY™ /		VIDE REINFORCED WHEEL, STAINLESS S	TEEL HARDWARE & SHAFT, EXTENDED LUBE LINES, \$	SPARE BELT SE	ET AND LOREN CO	OK'S		3. 24" HIGH ALUMINU LOCKING HASP-TOP		LUMINUM ROOF CAP,	STAINLESS STEEL	HARDWARE, HIN	GED SUB-BASE,	, ALUMINUM BIRD SCREE	N, TIE-DOWN EYELETS,	10. PROVIDE (4) SPEED, WITH ON/OFF, CONTR	OL WALL SWI	TCH. COORDIN	ATE MOUNTING	G LOCATIONS WIT	TH ELECTRICAL	DRAWINGS.	
1725-1750 RPM, TEFC MOT	OTORS WITH THERMAL OVERLOAD PRO	TECTION UNLESS OTHERWISE NOTED.						4. CLASS 1A LOW LE	EAKAGE, DDC, ALUMINU	M MOTOR OPERATE	DAMPER IN ROOF	CURB WITH DAM	MPER TRAY.										
USE ADDITIONAL SET OF C	F CONTACTS IN OCCUPANCY SENSOR P	PROVIDED UNDER DIVISION 26.						5. NEMA 1 (INDOOR	FAN) / NEMA 3R (OUTD	OOR FAN) DISCONNEC	CT SWITCH PRE-WI	RED WITH FLEXIB	LE CONDUIT BY	FAN MFR.									
LOOSE ACCESSORIES SHA	SHALL BE FIELD INSTALLED BY INSTALLE	ER.							IECT PRE-WIRED WITH ER-IN-SHEAR ISOLATOR						KDRAFT DAMPER, MINIMUM 1"								
								7. INTEGRAL ALUMIN (4).	NUM GRAVITY BACKDR	AFT DAMPER, MINIMU	M 1" DEFLECTION F	UBBER-IN-SHEAI	R ISOLATORS SE	ET, FILTER BOX WITH CA	RBON FILTERS, MODEL RC-75								

	PROFESSIONAL CERTIFIC	CATION	AS-BUILT / REV	VISION	BY	DATE	P.W.A. NO.	KEY SHEET	POSITION SHT	DRAWIN	G SCALE		
WIND TO THE PARTY OF THE PARTY	I HEREBY CERTIFY THAT THESE DOCUMENTS V APPROVED BY ME, AND THAT I AM A DULY LICI		BID/PERM	IT		9/20/24	-	MSW	27NE21	PLAN SCALE:	NONE	APPROVED BY: Mihai 7	Petrisor
	PROFESSIONAL ENGINEER UNDER THE LAWS O						R.O.W NO.	-	-		-	10/02/0	DIRECTOR
18:35 E	MARYLAND. LICENSE NO. 22942 EXPIRATION DA	TE: 12-24-2024					-	-	-	PROFILE SCALE:	-	DATE: 10/03/2	<u>'024</u>
PATE OF THE PATE O	ENGINEER: UDAY PATEL, PE, LEED BD+C	DGN BY: CCJM	BUREAU OF ENGINEERING AND CONSTRUCTION		HIGH	WAYS	STRUCTURES	STORM DRAINS	SEWER	WATER	FIELD ENGINEER	PROPERTY MAN	NAGEMENT
CHILL	C.C. JOHNSON & MALHOTRA, P.C.	DWN BY: CCJM	REVIEWED BY:									APPROVED BY:	CHIEF
illini.	400 EAST PRATT STREET, SUITE 604 BALTIMORE, MARYLAND 21202 (P) 410-461-9920	CHKD BY: CCJM	DATE REVIEWED:									DATE:	СНІЕГ

BALTIMORE COUNTY OFFICE OF BUDGET AND FINANCE, PROPERTY MANAGEMENT

FULLERTON FIRE STATION #8 - RENOVATION & ADDITION


SCHEDULES II

4401 FITCH AVENUE, NOTTINGHAM, MARYLAND, 21236

ELECTION DIST. NO.: 14C5

M600

SHEET DESIGNATION CONTRACT NUMBER 22221 PFO JOB ORDER NUMBER 241-220-0054-0012 SHEET 41 of 58 DRAWING NUMBER 2022 - 2357FILE NO.: 20-120

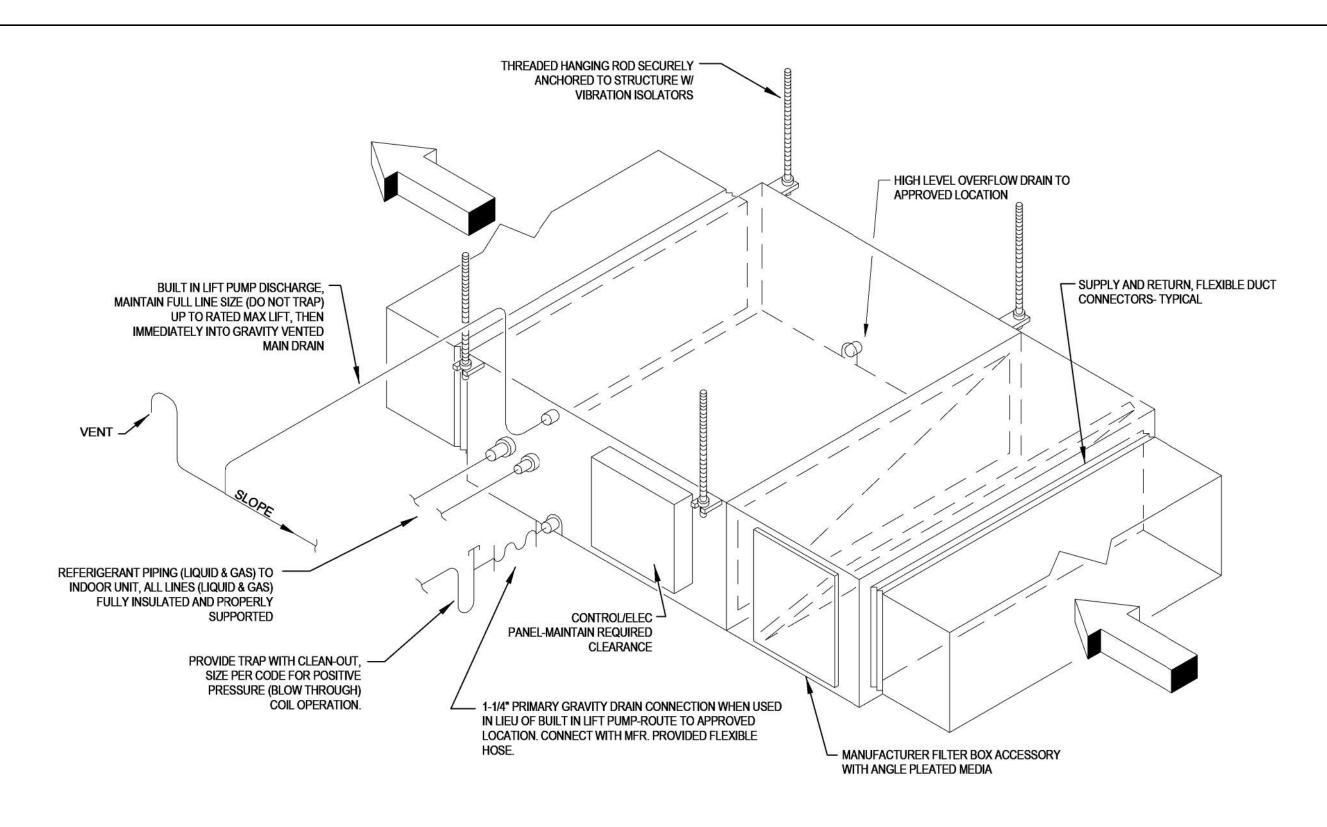

VRF DUCTED SSU/DOAS - TYPICAL
SCALE: NONE

		GRILLE,	REGISTER AND	DIFFUSER SC	CHEDULE								
TAG	DESCRIPTION	MANUFACTURER	MODEL	MATERIAL / FINISH (NOTE 2)	REMARKS								
1D, 2D, 3D, 4D	LAY-IN CEILING DIFFUSER	TUTTLE & BAILEY	ARCL	ALUMINUM / WHITE	24X24 / 24X12 / 24X48 LAY-IN T-BAR PANEL MODULE, SRR ADAPTER WHERE ROUND NECK OCCURS, NOTE 1								
EG/RG	EXHAUST GRILLE / RETURN GRILLE	TUTTLE & BAILEY	VPER	ALUMINUM / WHITE	VISUAL PRIVACY EGGCRATE TYPE, HEAVY GAUGE EXTRUDED ALUMINUM, 0.015-INCH THICK, 45 DEGREE DEFLECTION & 1/2 BY 1/2 INCH GRID CORE WITH SQUARE OR RECTANGULAR HOUSING EXTENDED TO FORM PANEL TO FIT IN CEILING SYSTEM MODULE, REMOVABLE OR HINGED FACE PANEL, LAY-IN T-BAR OR SURFACE MOUNT FRAME TO SUIT CEILING TYPES								
EG1 EXHAUST GRILLE TUTTLE & BAILEY A70D ALUMINUM / WHITE HORIZONTAL DEFLECTED BARS AT 3/4" SPACING													
EG1 EXHAUST GRILLE TUTTLE & BAILEY A70D ALUMINUM / WHITE HORIZONTAL DEFLECTED BARS AT 3/4" SPACING  TG TRANSFER GRILLE TUTTLE & BAILEY CRE510 ALUMINUM / WHITE 24x24 MODULE (UNO) W/ LT FRAME FOR LAY-IN & SF FRAME FOR SURFACE MOUNT, 24x12 OR 48x24 MODULE WHERE SHOWN													
TG1	TRANSFER GRILLE	TUTTLE & BAILEY	GAV	STEEL/MATCH PAINT	V-CORE WITH U-FRAME								
GRD SCHEDULE	E NOTES:			•	THE GRD SCHEDULE IS A STANDARD SCHEDULE. ALL GRILLE, REGISTER, AND DIFFUSER DO NOT NECESSARILY APPEAR ON DRAWINGS FOR THIS PROJECT.								
1. FOR DIRECTION O	F AIRFLOW, SEE DIFFUSER ON ASSOCIATED FLOOR	PLAN. 1D= 1-WAY, 2D=2-WAY, 3D	=3-WAY, 4D=4-WAY.										
2. BAKED ENAMEL W	HITE AT CEILING; CLEAR SATIN ANODIZED AT WINDO	W SILL OR ON FLOOR OR DUCT.	OR WALL MATCH PAINT TO ADJACENT SU	RFACES WHERE INDICATED OR SPE	CIFIED. FINAL FINISH AND COLOR SHALL BE AS SELECTED BY OWNER/ARCHITECT.								
3. SEE DETAILS 1 / M	500 AND 4 / M500.												

		GRA	/ITY VI	ENTILA	TOR / F	PENTH	OUSE	SCHE	DULE			
				CAPACITY		THROAT/	SIZE	ADDDOV				
TAG	DESCRIPTION	MANUFACTURER MODEL	AIRFLOW	PRESSURE DROP	FACE VELOCITY	ROOF OPENING L x W	LxWxH OR □x H	APPROX. WEIGHT	DETAIL	ACCESSORIES	REMARKS	
CFM IWG FPM INCHES INCHES LBS #/DWG#												
IPH-01         FRESH AIR INTAKE LOUVERED PENTHOUSE         LOREN COOK 12x12x4 TRE         420         0.03         100         12x12         24x24x16         150         3 / M500         1,2,3         DUCTED, 4.5 SQ. FT FREE AREA												
GV/PH SCHE	DULE NOTES:					GV/PH SCH	EDULE OPTION	ONS/ACCES	SORIES:			
1. LOOSE ACCES	SORIES SHALL BE FIELD INSTALLED B	Y INSTALLER.					MINUM ROOF CU OOF, WHERE OC		ER TRAY, HINGI	ED SUBBASE, TIE-DOWN	EYELETS, STAINLESS STEEL HARDWARE. SUITABLE	
						2. LOW LEAKAG	SE DDC CLASS 1A	ALUMINUM MC	TOR OPERATED	DAMPER IN PLENUM/DI	UCT.	
8						3. 1" WASHABLE	FILTERS, ALUMI	NUM INSECT S	CREEN, TOPCAF	INSULATION.		

								TER	RMIN	IAL U	JNITS	(HE	EATII	NG OI	NLY) S	SCHE	DULE						
			AIRFLO	W (CFM)	5550745555010054					HEATING	3									ELEC	CTRICAL (6	0 HZ)	
TAG	DESCRIPTION	MANUFACTURER MODEL	OA MIN	SA	FAN ESP/TSP	FAN SPEED	TYPE	EDB	UNIT LDB	TOTAL	WATER FLOW	LWT	WPD	SIZE LxWxH	APPROX. WEIGHT	DETAIL	ACCESSORIES / OPTIONS	REMARKS	ELEC. HEAT	MOTOR	VOLTS/		DISC. SWITCH
			Willy		IWG			°F	۰F	МВН	GPM	°F	FT. WG	INCHES	LBS	#/SHT#			KW	HP	TIAGE	FOWER	SWITCH
EDH-01	ELECTRIC DUCT HEATER	INDEECO QUA	ı	450	¥ï	-	ELECTRIC	10	52	20.5		~	<b>=</b> :	12 X 12	75	ų.	A	PREHEAT USE ONLY, INTERLOCK WITH DOAS-01, REMOTE CONTROL PANEL.	6.0	-	208 / 3	NO	MFR
TERMINAL U	NIT SCHEDULE NOTES:				TERMINA	L UNIT SC	HEDULE A	CCESS	ORIES:					Å.	As .				- A				
1	AMBIENT 95 °F DB/75 °F WB SUMMER, 10 °F DB WINTER				A	REFER TO ACCESSIB	THE SPECIFIC ILITY.	CATIONS.	PROVIDE I	REMOTE CO	ONTROL PANE	EL AT SUIT	TABLE LOCA	ATION ABOVE (	CEILING TO PRO	VIDE ADEQUA	TE CLEARANCES AND						
2	DISCONNECT SWITCH ON UNIT OR WALL MOUNTED AS	INDICATED.																					

DES	SIGN	I CONI	OITIC	SNC		
	HE	ATING	CC	OOLING		
AREA/SPACE	DB	WB / RH	DB	WB / DP*	MAXIMUM NC	REMARKS
	°F	°F/%	°F	°F/°F		
BALTIMORE, MD - AMBIENT [ASHRAE 90.1-2016, CLIMATE ZONE 4A]	11	(=)	91	74	-	-
OFFICES, CONFERENCE, DORMITORY, LOCKER ROOMS, FITNESS - OCCUPIED	68	-	78	67	35	-
STORAGE, TOILETS -OCCUPIED/UNOCCUPIED	60	7±1	(2)	-	-	-
OFFICES, CONFERENCE, DORMITORY, LOCKER ROOMS, FITNESS - UNOCCUPIED	55	=	85	61	-	3

	SCHEDULE GENERAL NOTES
1	MANUFACTURERS AND MODEL NUMBERS ARE NOTED TO ESTABLISH DESIGN QUALITY AND PERFORMANCE CRITERIA ONLY, OTHER MANUFACTURERS MAY BE ACCEPTABLE.
2	EQUIPMENT / FIXTURES / SPECIALTIES MANUFACTURER AVAILABLE FOR CONSTRUCTION OF THIS PROJECT MAY DIFFER WITH RESPECT TO PHYSICAL SIZE, CONNECTION LOCATIONS AND SIZES. THE CONTRACTOR SHALL BE RESPONSIBLE TO COORDINATE THE PURCHASED EQUIPMENT/FIXTURES/SPECIALTIES WITH THE CONDITIONS DEPICTED HEREIN AND MAKE ALL NECESSARY ADJUSTMENTS WITHOUT ANY ADDITIONAL COSTS.
3	ALL FIXTURES/EQUIPMENT/SPECIALTIES INDICATED HERE MAY NOT APPEAR ON THE CONTRACT DRAWINGS.

SHEET DESIGNATION	CONTRACT NUMBE
M601	22221 PFO

FULLERTON FIRE STATION #8 - RENOVATION & ADDITION

BALTIMORE COUNTY OFFICE OF BUDGET AND FINANCE, PROPERTY MANAGEMENT

SCHEDULES II

JOB ORDER NUMBER 241-220-0054-0012 SHEET 42 of 58 DRAWING NUMBER

FILE NO.: 20-120

2022-2358


ELECTION DIST. NO.: 14C5

PROFESSIONAL CERTIFIC	AS-BUILT / REVISION	BY	DATE	P.W.A. NO.	KEY SHEET	POSITION SHT	DRAWIN	IG SCALE			
I HEREBY CERTIFY THAT THESE DOCUMENTS WERE PREPARED OR APPROVED BY ME, AND THAT I AM A DULY LICENSED PROFESSIONAL ENGINEER UNDER THE LAWS OF THE STATE OF MARYLAND.  LICENSE NO. 22942 EXPIRATION DATE: 12-24-2024		BID/PERMIT		9/20/24	-	MSW	27NE21	PLAN SCALE:	NONE	APPROVED BY: Mihai T. Petrisor	
					R.O.W NO.	-	-		-	DIRECTOR 10/03/2024	
					-	-	-	PROFILE SCALE:	-	DATE: /0/03/2024	
ENGINEER:  UDAY PATEL, PE, LEED BD+C	DGN BY: CCJM	BUREAU OF ENGINEERING AND CONSTRUCTION	HIGH	HWAYS	STRUCTURES	STORM DRAINS	SEWER	WATER	FIELD ENGINEER	PROPERTY MANAGEMENT	
PRINCIPAL MECHANICAL ENGINEER  C.C. JOHNSON & MALHOTRA, P.C.	DWN BY: CCJM	REVIEWED BY:								APPROVED BY: CHIEF	
400 EAST PRATT STREET, SUITE 604 BALTIMORE, MARYLAND 21202 (P) 410-461-9920	СНКО ВҮ: ССЈМ	DATE REVIEWED:								DATE:	SUBDIVISION: FULLERTO

4401 FITCH AVENUE, NOTTINGHAM, MARYLAND, 21236

LEGENDS ARE GENERAL, NOT ALL SYMBOLS, ABBREVIATIONS, AND/OR DESIGNATIONS MAY APPEAR ON THE DRAWINGS.

# PLUMBING

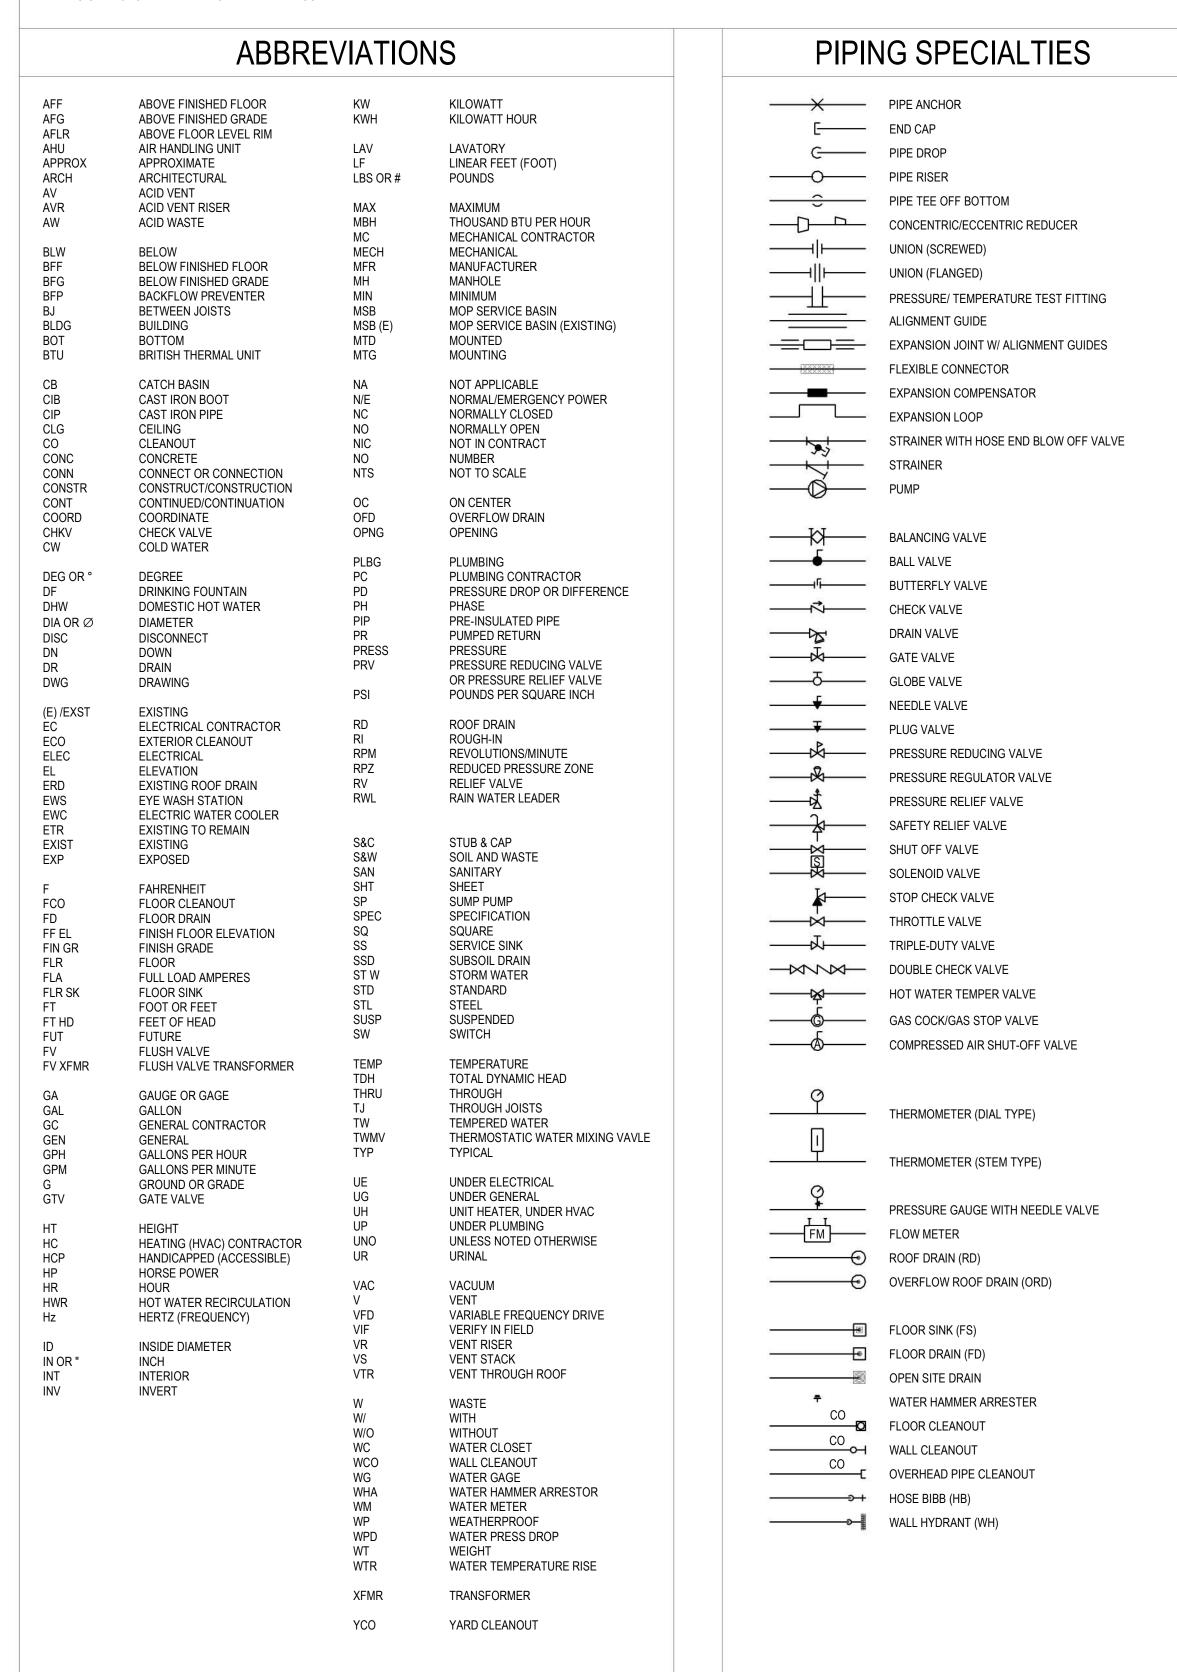

PIPING DESIGNATIONS	ANNOTATIONS
	AREA OF REVISION  REVISION SEQUENCE NUMBER  KEYED NOTE  DEMOLITION KEYED NOTE  POINT OF CONNECTION TO EXISTING SYSTEM  POINT OF DISCONNECTION FROM EXISTING SYSTEM  DETAIL NUMBER SHEET NUMBER  SECTION NO SHEET NO  EXISTING TO REMAIN NEW WORK DEMOLITION WORK  ABC  EXISTING (INDICATED W/ SLANTED TEXT)

SUBDIVISION: FULLERTON

### **GENERAL NOTES**

- THE DRAWINGS ARE DIAGRAMMATIC AND INDICATE THE APPROXIMATE ARRANGEMENT OF THE EXISTING SYSTEMS, THE CONTRACTOR SHALL FIELD VERIFY EXACT INFORMATION, DIMENSIONS, LOCATIONS, ETC. AS NECESSARY AND PERFORM WORK ACCORDINGLY. NOT ALL INFORMATION IS SHOWN.
- INFORMATION WHERE SHOWN ON THE DRAWINGS WAS OBTAINED FROM EXISTING DRAWINGS AND FIELD OBSERVATION. THE CONTRACTOR SHALL VERIFY CORRECTNESS AND COMPLETENESS OF SUCH INFORMATION TO HIS/HER OWN SATISFACTION.
- REMOVE SELECTED PLUMBING SYSTEMS IN THEIR ENTIRETY. CUT, PATCH, AND FINISH WHERE DEMOLITION WORK OCCURS. REMOVE ALL ABANDONED PIPING, EQUIPMENT, FIXTURES, AND APPURTENANCES IN THEIR ENTIRETY.
- COORDINATE DEMOLITION WORK WITH THE OWNER SCHEDULE. EXISTING PLUMBING SYSTEM & OTHER SYSTEMS IN OTHER PHASES/AREAS ARE REQUIRED TO BE IN OPERATION DURING THE PROJECT
- REFER TO ALL CONTRACT DOCUMENTS FOR ADDITIONAL REQUIREMENTS AND COORDINATE WORK
- REFER TO STRUCTURAL DRAWINGS FOR REQUIREMENTS FOR OPENING REINFORCEMENT, EQUIPMENT SUPPORTS, LINTELS, AND CONCRETE PADS UNLESS OTHERWISE INDICATED.
- ALL FLOOR MOUNTED EQUIPMENT, AND APPURTENANCES SHALL HAVE MINIMUM 6" THICK CONCRETE PAD WITH CHAMFERED EDGES, WHETHER SHOWN OR NOT.
- INCLUDE ALL INCIDENTAL WORK REQUIRED FOR THE WORK INCLUDING TEMPORARY DISCONNECTION, RELOCATION, AND REINSTALLATION OF THE EXISTING OBSTRUCTIONS SUCH AS PIPING, CONDUITS. DUCTWORK, DOORS, BEAMS, JOISTS, SPRINKLERS, ETC. WHETHER SHOWN OR NOT. COORDINATE

TEMPORARY SHUTDOWNS WITH OWNER'S REPRESENTATIVE AS SPECIFIED.

- ROUGH-IN AND CONNECT STORM WATER. HW. CW. VENT. SANITARY. AND WASTE LINES TO FIXTURES AND EQUIPMENT IN ACCORDANCE WITH SIZES INDICATED ON FIXTURE & EQUIPMENT SCHEDULES, DETAILS, RISER DIAGRAMS, FLOW DIAGRAMS, AND IN ACCORDANCE WITH THE PLUMBING CODE WHICH EVER IS THE MOST STRINGENT. NO PIPING SHALL BE SMALLER THAN 3/4" UNLESS OTHERWISE NOTED.
- ALL DIMENSIONS, AND PIPE SIZES ARE IN INCHES UNLESS NOTED OTHERWISE
- PROVIDE 2" MINIMUM SIZE SANITARY, WASTE, AND VENT PIPING BELOW GROUND/FLOOR INSIDE BUILDING REGARDLESS OF SIZE INDICATED ON PLUMBING FIXTURE SCHEDULE. PROVIDE MINIMUM 1/4" PER FEET SLOPE FOR ALL DWV AND SANITARY PIPING UNLESS OTHERWISE DIRECTED BY ENGINEER.
- PROVIDE ALL PIPING WITHIN BUILDING THERMAL ENVELOPE, ABOVE FINISHED CEILINGS UNDER BUILDING ROOF INSULATION AND ON THE CONDITIONED SPACE SIDE OF THE BUILDING INSULATION, UNLESS NOTED OTHERWISE. UNLESS OTHERWISE NOTED, PIPING SHALL BE RUN AS HIGH AS POSSIBLE, CONCEALED ABOVE CEILINGS, IN WALLS AND PARTITIONS, AND IN PIPE CHASES.
- PROVIDE ACCESS PANELS, FIRE-RATED WHERE REQUIRED FOR ACCESS TO ALL CONCEALED VALVES. TRAPS, COMPONENTS OR OTHER EQUIPMENT FURNISHED UNDER THIS CONTRACT WHERE NO OTHER MEANS IS PROVIDED. PROVIDE BEADED EDGE IN GYPSUM BOARD WALLS AND CEILING.
- COORDINATE WALL, ROOF, FLOOR, AND CEILING OPENINGS FOR NEW PIPE RISERS, AND CONDUIT PENETRATIONS. PROVIDE SLEEVES AROUND EXISTING PIPES THROUGH NEW WALLS/PARTITIONS.
- FIELD VERIFY AND COORDINATE PIPING AND PROVIDE OFFSETS TO ACCOMMODATE PIPING THROUGH/BETWEEN JOISTS, BETWEEN BEAMS AND EXISTING BUILDING STRUCTURE, WALL STUDS, ETC. AT NO ADDITIONAL COST.
- EXISTING EQUIPMENT, APPLIANCES, ETC.; STRUCTURAL JOISTS, BEAMS, ETC.; AND LIGHTING FIXTURES, ELECTRICAL EQUIPMENT; ETC. WHERE SHOWN ARE FOR REFERENCE ONLY. VERIFY IN FIELD. REFER TO RESPECTIVE DRAWINGS AND EXISTING RECORD DRAWINGS WHERE AVAILABLE.
- 17. ALL EQUIPMENT, AND PIPING SHALL BE SUPPORTED FROM JOIST TOP CHORD, UNLESS OTHERWISE NOTED. DO NOT SUPPORT ANYTHING FROM ROOF DECK.
- 18. ALL OPENINGS IN PIPES OR FITTINGS SHALL BE KEPT PLUGGED OR CAPPED UNTIL CONNECTED.
- PROVIDE SUFFICIENT NUMBER OF UNIONS/FLANGES IN ALL PIPE LINES TO ALLOW REMOVAL OF PIPES WITHOUT BREAKING FITTINGS AND AT ALL EQUIPMENT CONNECTIONS.
- RUNOUTS TO EQUIPMENT AND FIXTURES SHALL BE RUN IN SIZES INDICATED AND INCREASED OR REDUCED AT POINT OF FINAL CONNECTION TO EQUIPMENT AND FIXTURES.
- CONNECT AND EXTEND CONDENSATE DRAIN PIPING FROM EACH AHU, RTU, AC UNITS, CRACU, DSSU, SSU. BCU. ETC. TO NEAREST ROOF DRAIN OR FLOOR DRAIN OR EXTEND AT LEAST 25 FEET IN THE DIRECTION OF ROOF SLOPE WHERE ROOF DRAIN DOES NOT EXIST UNLESS OTHERWISE INDICATED. ROUTING SHALL NOT INTERFERE WITH PASSAGEWAYS AND MAINTENANCE, PROVIDE CONDENSATE TRAPS FOR ALL CONDENSATE DRAIN CONNECTS, SEE TYPICAL DETAIL FOR INSTALLATION. SLOPE SUSPENDED DRAIN PIPING.
- DO NOT INSTALL PIPING, EQUIPMENT, AND APPURTENANCES OVER ELECTRICAL EQUIPMENT. PROVIDE REQUIRED CLEARANCES FOR ALL ELECTRICAL EQUIPMENT PER ELECTRICAL CODE (NEC). COORDINATE LOCATIONS OF PIPING, AND EQUIPMENT ABOVE CEILINGS WITH CABLE TRAYS.
- COORDINATE MOUNTING HEIGHTS OF ALL EQUIPMENT, FIXTURES AND CONSTRUCTION BEFORE ROUGH-IN. FOR HANDICAPPED/ACCESSIBLE PLUMBING FIXTURES, CONFIRM EXACT MOUNTING HEIGHT WITH AUTHORITY HAVING JURISDICTION AND ADJUST WORK AS REQUIRED BEFORE INSTALLATION.
- PROVIDE WATER HAMMER ARRESTORS ON DOMESTIC HW AND CW PIPING AT EVERY FIXTURE GROUP WHETHER SHOWN OR NOT, LOCATE IN ACCESSIBLE POSITION FOR SERVICING.
- LOCATE ALL VENTS A MINIMUM OF 10 FEET AWAY FROM HVAC OUTSIDE AIR INTAKES AND BUILDING OPENINGS. ALL VENTS THRU ROOF SHALL TERMINATE A MINIMUM OF 24" ABOVE ROOF, ALL PLUMBING VENT RISERS IN EXTERIOR WALLS SHALL BE OFF-SET A MINIMUM OF 4'-0" AT ROOF BEFORE ROOF
- FURNISH OPERATIONAL, MAINTENANCE AND EMERGENCY INSTRUCTIONS TO THE OWNER'S REPRESENTATIVES BEFORE ANY PART OF THE SYSTEM IS TURNED OVER TO THE OWNER, AND SUBMIT WRITTEN CONFIRMATION TO THE ARCHITECT/ENGINEER AND GOVERNMENT.
- TEST INSTALLATION IN ACCORDANCE WITH THE APPROPRIATE CODE REQUIREMENTS AND SPECIFICATIONS IN PRESENCE OF OWNER'S REPRESENTATIVES. NOTIFY THE OWNER AND ENGINEER PRIOR TO TESTING SYSTEM. SUBMIT TESTING REPORTS IN OPERATION AND MAINTENANCE MANUALS.
- SHOULD ANY CHANGES OCCUR DUE TO COORDINATION WITH OTHER BUILDING TRADES AND CONFLICT WITH THE CONTRACT DOCUMENTS, THE CONTRACTOR SHALL SUBMIT FOR THE ARCHITECT/ENGINEER'S APPROVAL AN ALTERNATIVE METHOD OF COMPLETING THE WORK ACCORDING TO THE INTENT OF THE CONTRACT DOCUMENTS.
- REFER TO ARCHITECTURAL DRAWINGS FOR TEMPORARY LIVING FACILITY TRAILERS. PROVIDE TRAILERS WITH TEMPORARY WATER, SANITARY, ELECTRIC, AND OTHER UTILITIES THROUGHOUT THE DURATION OF

P001

SHEET DESIGNATION

JOB ORDER NUMBER 241-220-0054-0012  $\star\star\star\star\star$ 

SHEET 43 of 58 DRAWING NUMBER 2022**-**2359 FILE NO.: 20-120


CONTRACT NUMBER


22221 PFO

AS-BUILT / REVISION BY DATE P.W.A. NO. KEY SHEET POSITION SHT DRAWING SCALE PROFESSIONAL CERTIFICATION HEREBY CERTIFY THAT THESE DOCUMENTS WERE PREPARED OR BID/PERMIT .PPROVED BY: Mihai T. Petrisor PLAN SCALE: APPROVED BY ME, AND THAT I AM A DULY LICENSED PROFESSIONAL ENGINEER UNDER THE LAWS OF THE STATE OF R.O.W NO. 10/03/2024 AARYLAND. PROFILE SCALE LICENSE NO. 22942 EXPIRATION DATE: 12-24-2024 BUREAU OF ENGINEERING AND CONSTRUCTION ENGINEER: \_\_\_\_\_ HIGHWAYS STRUCTURES STORM DRAINS SEWER WATER ELD ENGINEE PROPERTY MANAGEMENT DAY PATEL, PE, LEED BD+C RINCIPAL MECHANICAL ENGINEER REVIEWED BY: DWN BY: CCJM APPROVED BY: 0 EAST PRATT STREET, SUITE 604 LTIMORE, MARYLAND 21202 DATE REVIEWED: CHKD BY: CCJM

BALTIMORE COUNTY OFFICE OF BUDGET AND FINANCE, PROPERTY MANAGEMENT

FULLERTON FIRE STATION #8 - RENOVATION & ADDITION

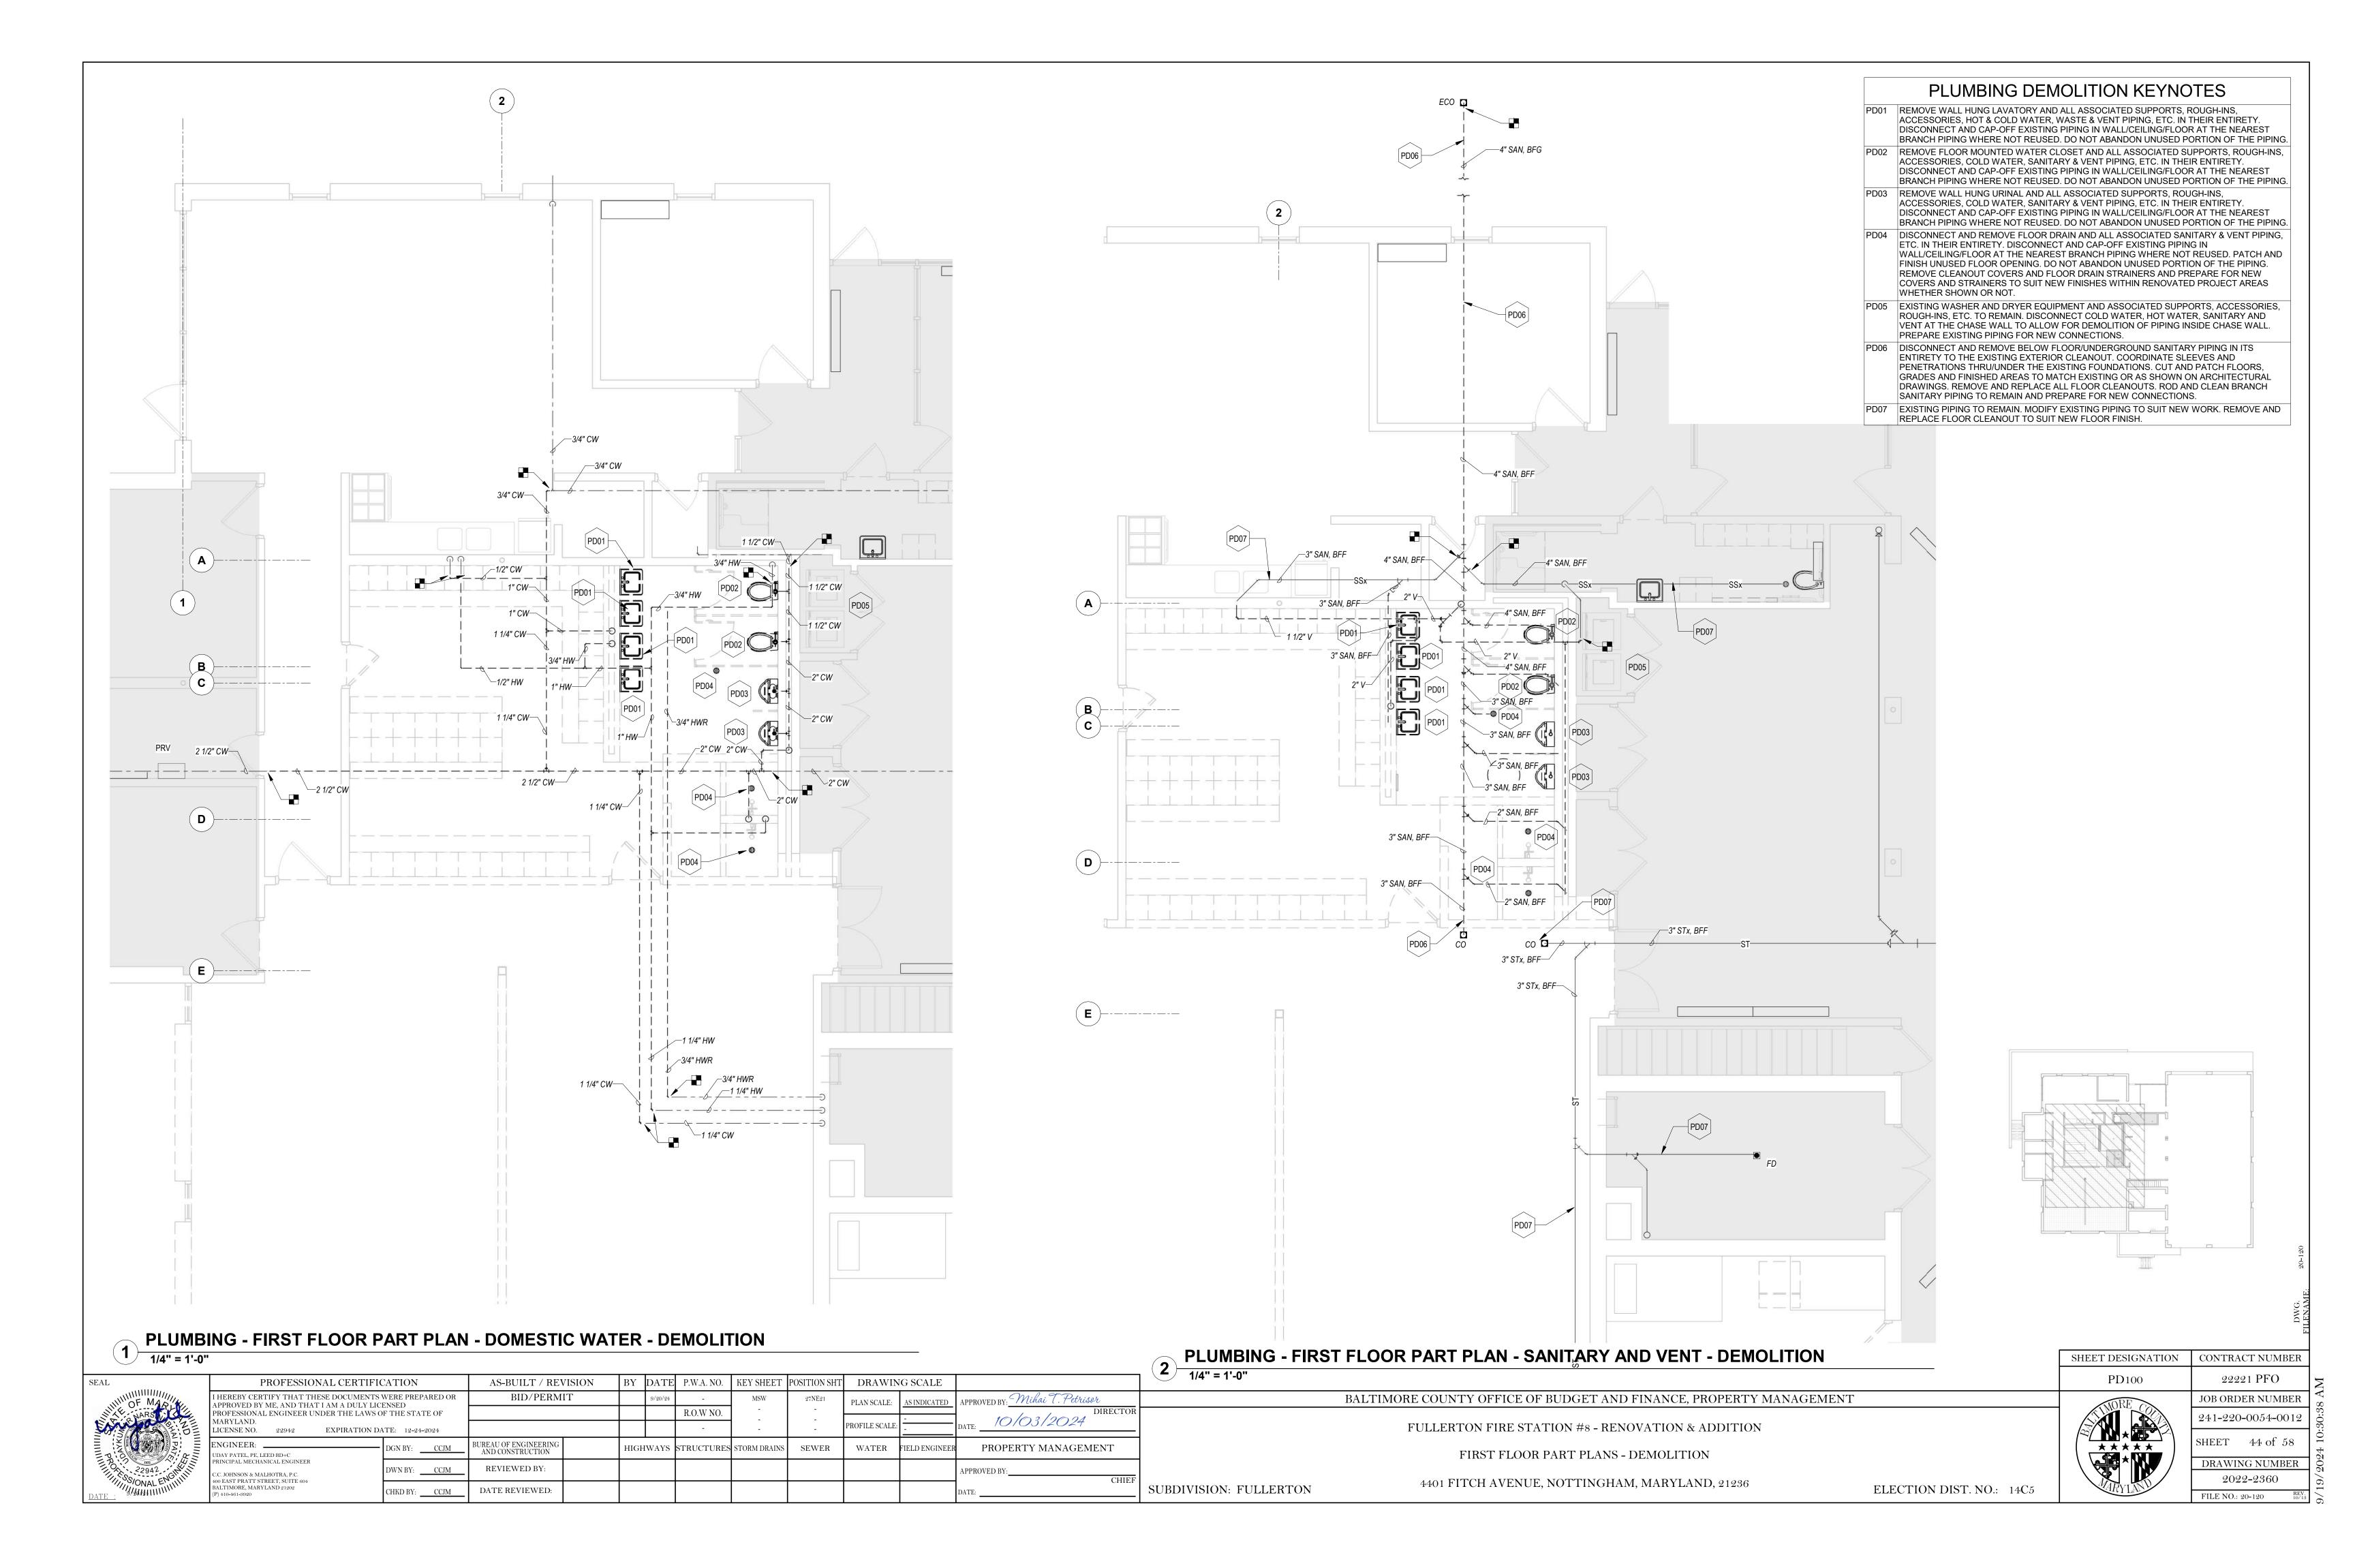

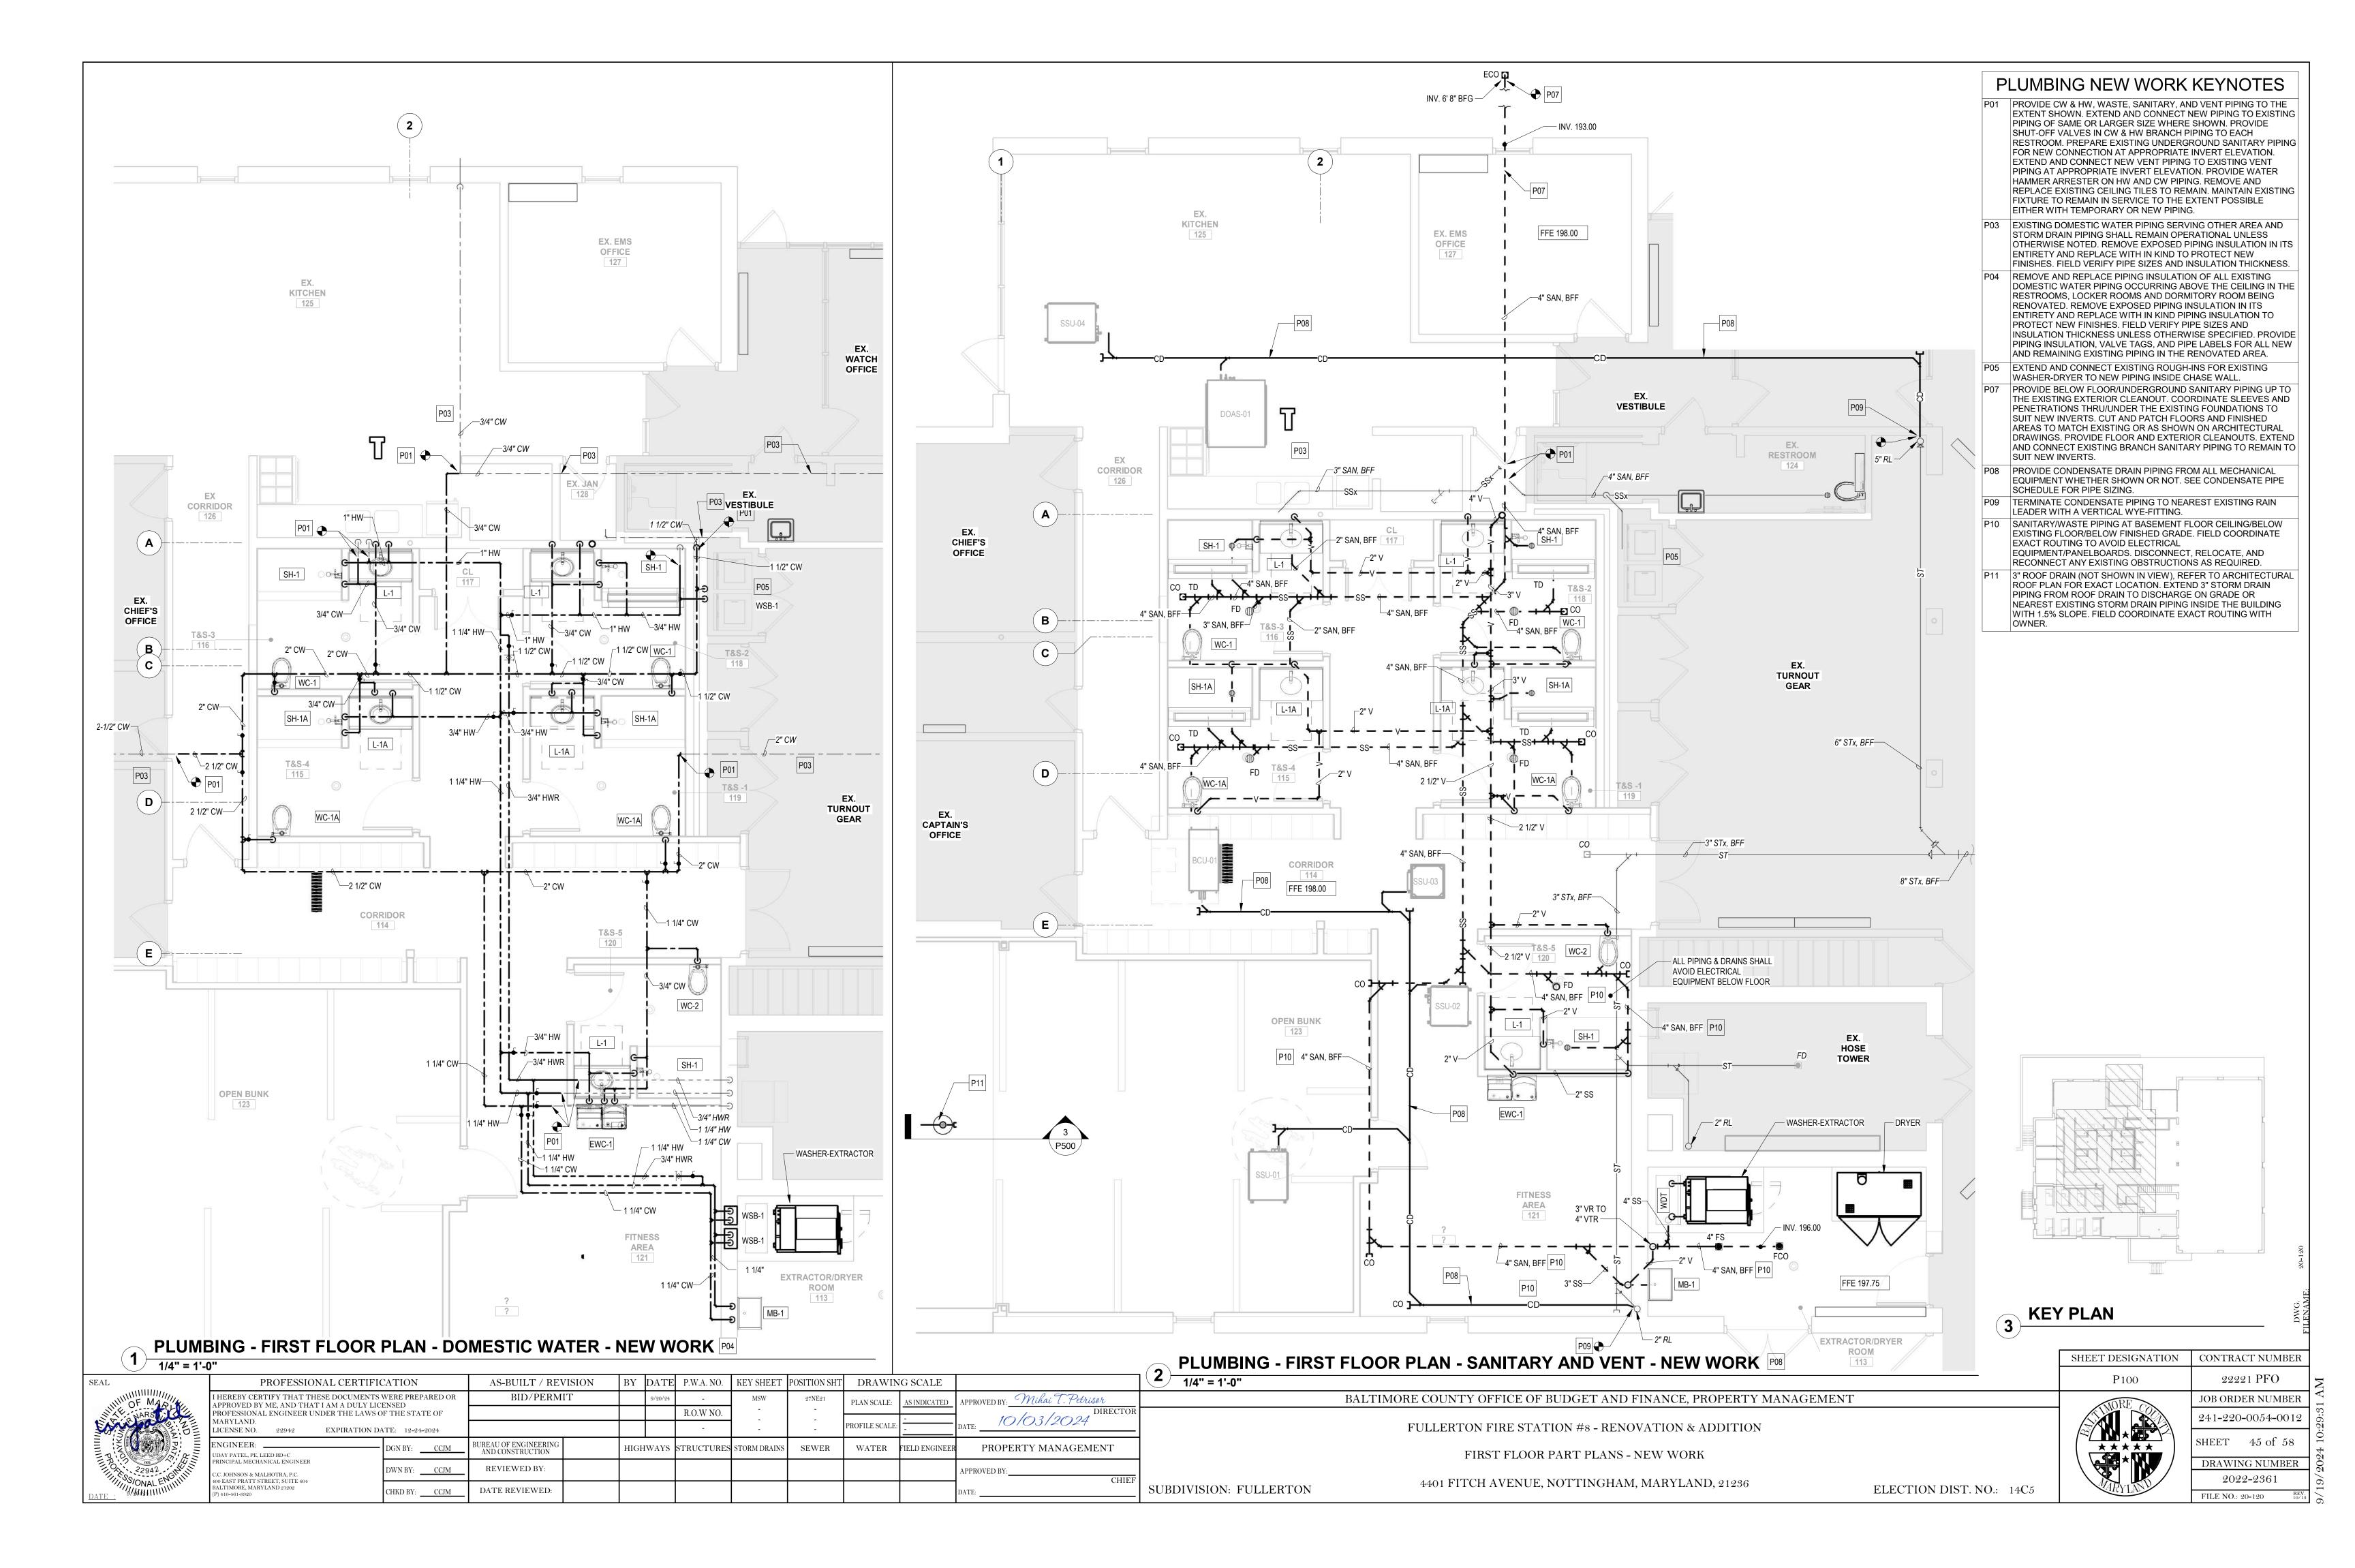


### PLUMBING NEW WORK KEYNOTES

PROVIDE BELOW FLOOR/UNDERGROUND SANITARY PIPING UP TO THE EXISTING EXTERIOR CLEANOUT. COORDINATE SLEEVES AND PENETRATIONS THRU/UNDER THE EXISTING FOUNDATIONS TO SUIT NEW INVERTS. CUT AND PATCH FLOORS AND FINISHED AREAS TO MATCH EXISTING OR AS SHOWN ON ARCHITECTURAL DRAWINGS. PROVIDE FLOOR AND EXTERIOR CLEANOUTS. EXTEND AND CONNECT EXISTING BRANCH SANITARY PIPING TO REMAIN TO SUIT NEW INVERTS.

P10 SANITARY/WASTE PIPING AT BASEMENT FLOOR CEILING/BELOW EXISTING FLOOR/BELOW FINISHED GRADE. FIELD COORDINATE EXACT ROUTING TO AVOID ELECTRICAL EQUIPMENT/PANELBOARDS. DISCONNECT, RELOCATE, AND RECONNECT ANY EXISTING OBSTRUCTIONS AS REQUIRED.

3" ROOF DRAIN (NOT SHOWN IN VIEW), REFER TO ARCHITECTURAL ROOF PLAN FOR EXACT LOCATION. EXTEND 3" STORM DRAIN PIPING FROM ROOF DRAIN TO DISCHARGE ON GRADE OR NEAREST EXISTING STORM DRAIN PIPING INSIDE THE BUILDING WITH 1.5% SLOPE. FIELD COORDINATE EXACT ROUTING WITH OWNER.

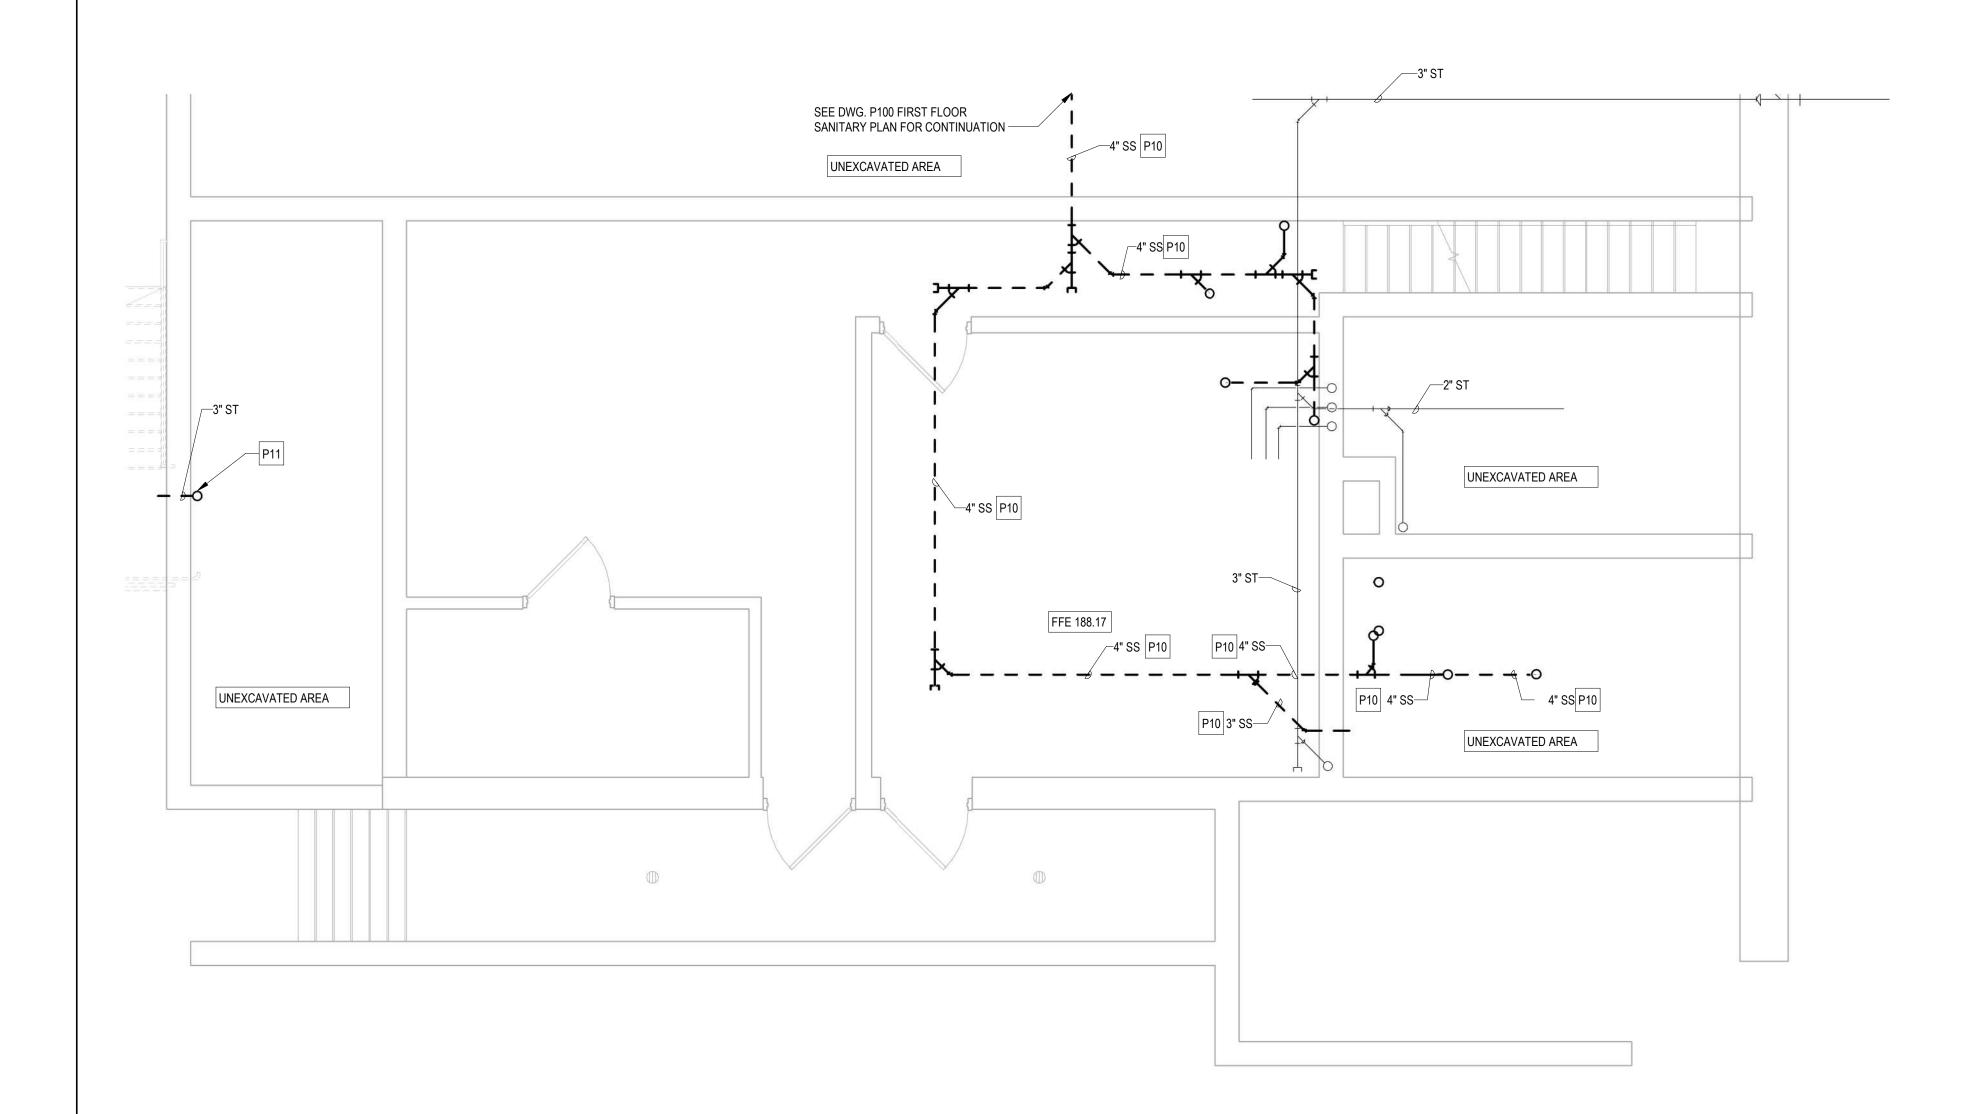

ECO (VIF) EX. 24" CCP EX. 24" CCP STATION 24" TREE LIGHT TRENCH DRAIN CONCRETE PAD EX. WALL FOUNDATION BRICK WALL 4" SAN, BFG CONCRETE WALK EX. 4"D SEE DWG. P100 FOR CONTINUATION

PLUMBING - BASEMENT FLOOR PLAN - NEW WORK

1/4" = 1'-0"

PLUMBING - PARTIAL SITE PLAN - SANITARY

1" = 10'-0"

SUBDIVISION: FULLERTON

				-									
	SEAL	PROFESSIONAL CERTIFIC	CATION	AS-BUILT / REV	AS-BUILT / REVISION		DATE	P.W.A. NO.	KEY SHEET	POSITION SHT	T DRAWING SCALE		
	OF MARIA	I HEREBY CERTIFY THAT THESE DOCUMENTS APPROVED BY ME, AND THAT I AM A DULY LIC	BID/PERMIT			9/20/24	-	MSW	27NE21	PLAN SCALE:	NONE	APPROVED BY: Mihai T. Petrisor	
		PROFESSIONAL ENGINEER UNDER THE LAWS O						R.O.W NO.	-	-			DIRECTOR
		MARYLAND. LICENSE NO. 22942 EXPIRATION DA						-	-	-	PROFILE SCALE:	-	DATE: 10/03/2024
	NIIIIIIIIIIIIIIIIIIIIIIIIIIIIIIIIIIIII	ENGINEER:  UDAY PATEL, PE, LEED BD+C	DGN BY: CCJM	BUREAU OF ENGINEERING AND CONSTRUCTION		HIGH	WAYS	STRUCTURES	STORM DRAINS	SEWER	WATER	FIELD ENGINEER	PROPERTY MANAGEMENT
	22942 CANALENGIANIAN DATE	PRINCIPAL MECHANICAL ENGINEER  C.C. JOHNSON & MALHOTRA, P.C.	DWN BY: CCJM	REVIEWED BY:									APPROVED BY: CHIEF
	DATE:	400 EAST PRATT STREET, SUITE 604 BALTIMORE, MARYLAND 21202 (P) 410-461-9920	CHKD BY: CCJM	DATE REVIEWED:									DATE:

BALTIMORE COUNTY OFFICE OF BUDGET AND FINANCE, PROPERTY MANAGEMENT

FULLERTON FIRE STATION #8 - RENOVATION & ADDITION


BASEMENT FLOOR PLAN AND SITE PLAN

4401 FITCH AVENUE, NOTTINGHAM, MARYLAND, 21236

ELECTION DIST. NO.: 14C5

	2221110
	JOB ORDER NUM
	241-220-0054-0
	SHEET 46 of
/	DRAWING NUM
	2022 222


SHEET DESIGNATION | CONTRACT NUMBER

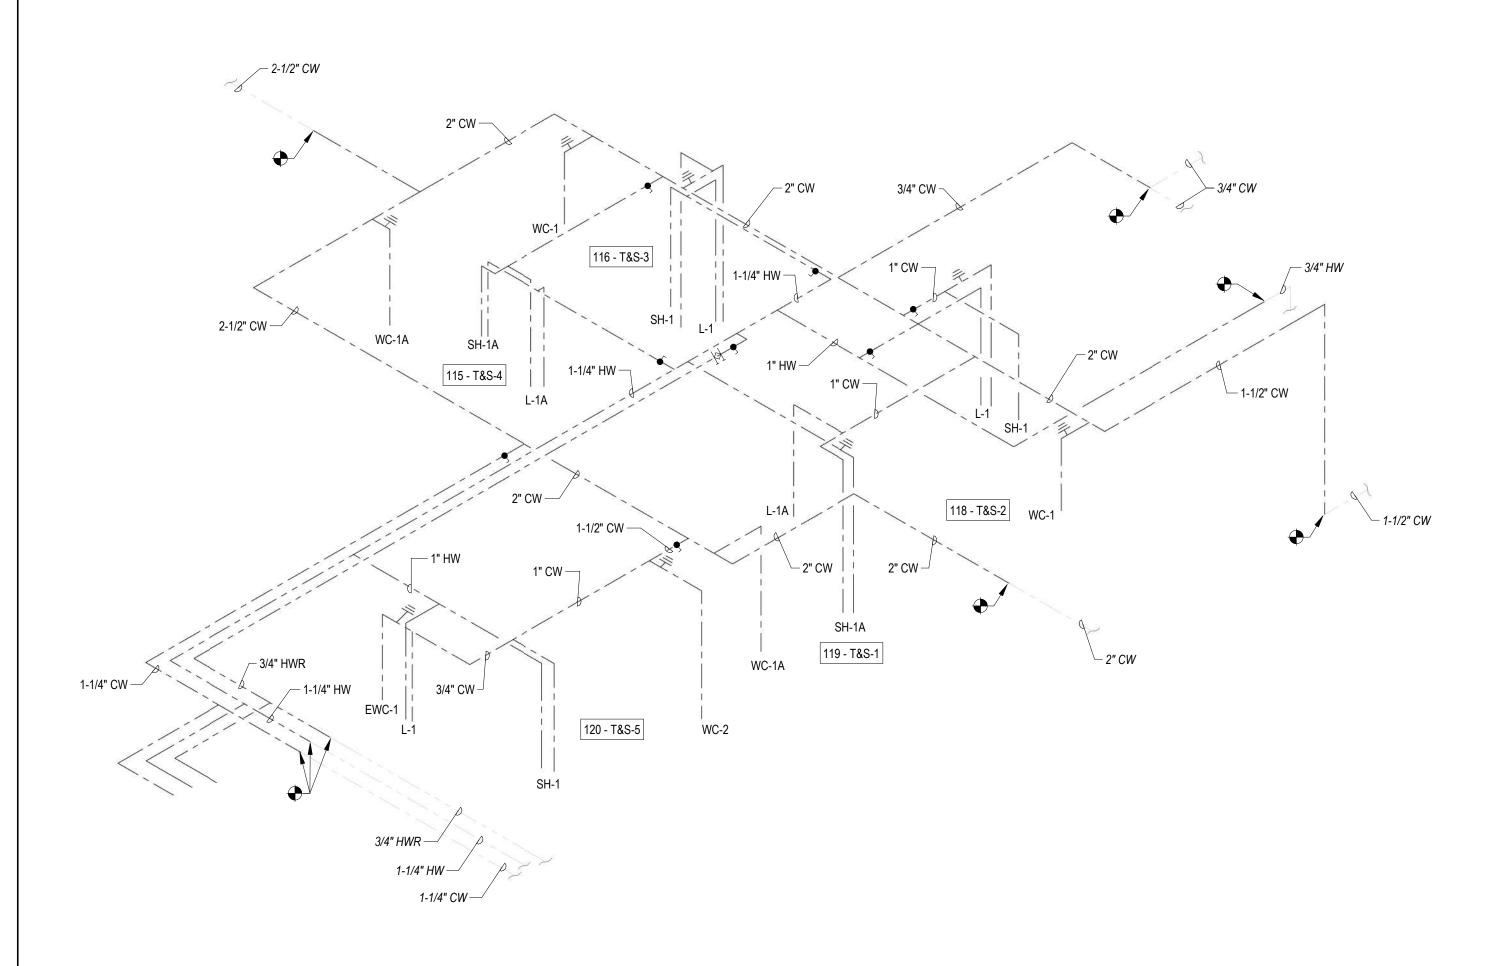

# PLUMBING - PARTIAL DOMESTIC WATER RISER DIAGRAM NOT TO SCALE


### PLUMBING NEW WORK KEYNOTES

3" ROOF DRAIN (NOT SHOWN IN VIEW), REFER TO ARCHITECTURAL ROOF PLAN FOR EXACT LOCATION. EXTEND 3" STORM DRAIN PIPING FROM ROOF DRAIN TO DISCHARGE ON GRADE OR NEAREST EXISTING STORM DRAIN PIPING INSIDE THE BUILDING WITH 1.5% SLOPE. FIELD COORDINATE EXACT ROUTING WITH OWNER.

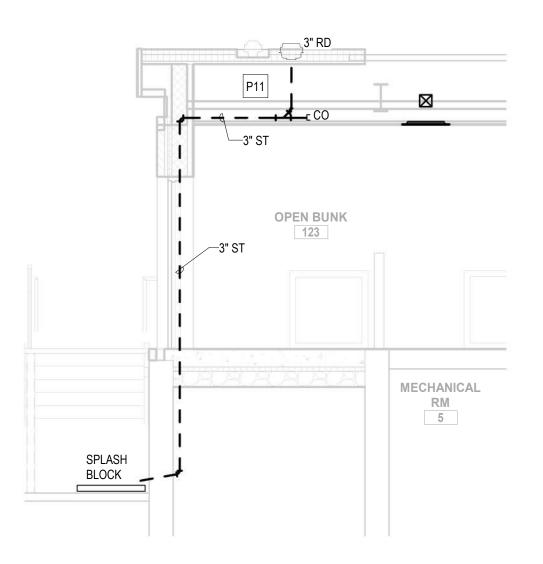

NEW ROOF DRAIN SECTION

1/4" = 1'-0"

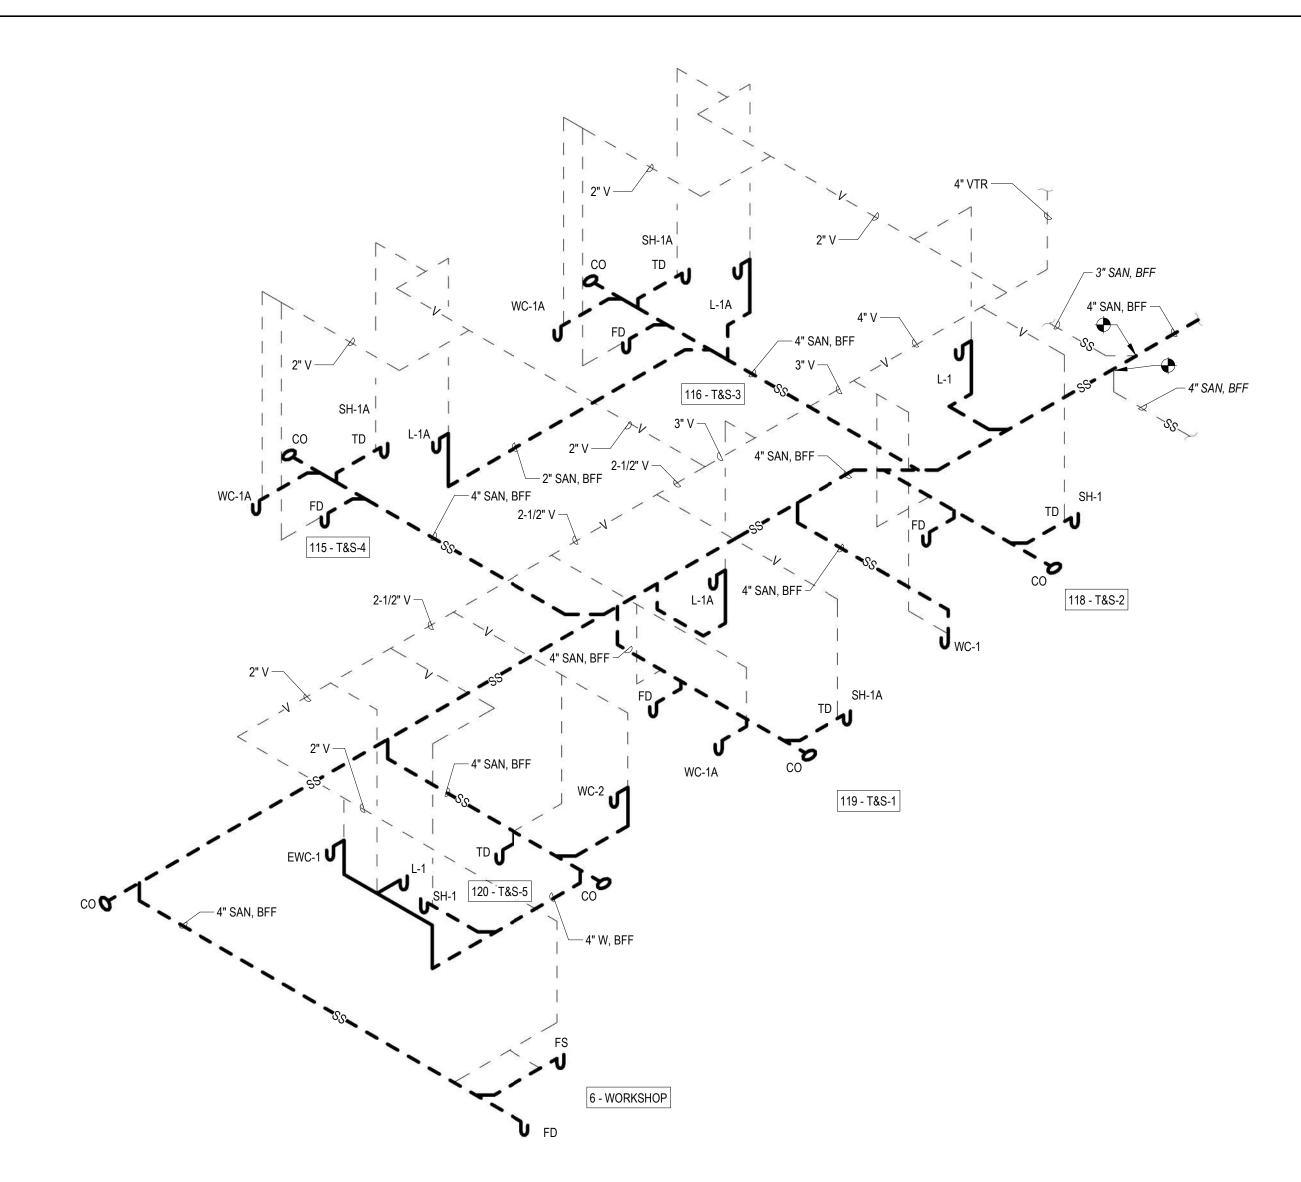

# PLUMBING - PARTIAL SANITARY AND VENT RISER DIAGRAM NOT TO SCALE

SUBDIVISION: FULLERTON

SEAL	PROFESSIONAL CERTIFIC	AS-BUILT / REVISION			DATE	P.W.A. NO.	KEY SHEET	POSITION SHT	DRAWING SCALE				
111' = E. IV/A . 1//2.	I HEREBY CERTIFY THAT THESE DOCUMENTS APPROVED BY ME, AND THAT I AM A DULY LIC	BID/PERMIT			9/20/24	-	MSW	27NE21 PLAN SCALE: A		AS INDICATED	APPROVED BY: Mihai T. Petrisor		
MARS	PROFESSIONAL ENGINEER UNDER THE LAWS O					R.O.W NO.	_	-	-		DIREC		
22942	MARYLAND. LICENSE NO. 22942 EXPIRATION DA	ATE: 12-24-2024					-	-	- PROFILE SCALE:		-	DATE: 10/03/2024	
	ENGINEER:	DGN BY: CCJM	BUREAU OF ENGINEERING AND CONSTRUCTION		HIGH	WAYS	STRUCTURES	STORM DRAINS	SEWER	WATER	FIELD ENGINEEF	PROPERTY MANAGEMENT	
	PRINCIPAL MECHANICAL ENGINEER C.C. JOHNSON & MALHOTRA, P.C.	DWN BY: CCJM	REVIEWED BY:									APPROVED BY:	
DATE:	400 EAST PRATT STREET, SUITE 604 BALTIMORE, MARYLAND 21202 (P) 410-461-9920	CHKD BY: CCJM	DATE REVIEWED:									DATE:	

BALTIMORE COUNTY OFFICE OF BUDGET AND FINANCE, PROPERTY MANAGEMENT

FULLERTON FIRE STATION #8 - RENOVATION & ADDITION

RISER DIAGRAMS

4401 FITCH AVENUE, NOTTINGHAM, MARYLAND, 21236

ELECTION DIST. NO.: 14C5

SHEET DESIGNATION CONTRACT NUMBER P500 22221 PFO JOB ORDER NUMBER 241-220-0054-0012 SHEET 47 of 58 DRAWING NUMBER

2022-2363

						PLUMBING FIXTURES SCHEDULE					
TAG	DESCRIPTION	CONNECTIONS ROUGH-IN SIZE (INCHES)			N SIZE	REMARKS					
IAO	DESCRIPTION	COLD WATER	HOT WATER	WASTE	VENT	REPARKS					
WC-1A	WATER CLOSET - ADA	1"	-	4"	2"	ACCESSIBLE, 1.28 GPF, FLOOR MOUNTED, WATER CLOSET WITH MANUAL EXPOSED FLUSHOMETER AND RIM HEIGHT 17" AFF. TOTO MODEL CT705ELN(G) WATER CLOSET; SC534 SEAT & SLOAN VALVE MODEL REGAL 111-1.28XL FLUSHOMETER					
WC-1	WATER CLOSET	1"	8 <del>7</del> 0	4"	2"	1.28 GPF, FLOOR MOUNTED, WATER CLOSET WITH MANUAL EXPOSED FLUSHOMETER AND RIM HEIGHT 17" AFF. TOTO MODEL CT705ELN(G) WATER CLOSET; SC534 SEAT & SLOAN VALVE MODEL REGAL 111-1.28XL FLUSHOMETER					
WC-2	WATER CLOSET - WALL MOUNTED	1"	-	4"	2"	1.28 GPF, WALL MOUNTED, WATER CLOSET WITH MANUAL EXPOSED FLUSHOMETER AND RIM HEIGHT 17" AFF. TOTO MODEL CT708E(G) WATER CLOSET; SC534 SEAT & SLOAN VALVE MODEL REGAL 111-1.28XL FLUSHOMETER					
EWC-1	ELECTRICAL WATER COOLER ADA	3/4"	-	1-1/2"	1-1/2"	ACCESSIBLE, WALL MOUNTED, HIGH EFFICIENCY, VANDAL RESISTANT, DUAL LEVEL STAINLESS STEEL WITH WATER BOTTLE FILLER AND WALTER FILTER, CANE TOUCH APRON. 8 GPH OF 50 °F WATER AT 90 °F AMBIENT AND 80 °F INLET WATER 6 FLA, 120V/1 PH/60 HZ					
SH-1A	SHOWER, INDIVIDUAL - ADA	1/2"	1/2"	3"	1-1/2"	ACCESSIBLE, 1.5 GPM, WATER SENSE CERTIFIED. BARDLEY MODEL HN300-HDT1-SF-LHV-LBJ-ST-HS-NS-NONE-AP-BP-NONE-NONE SHOWER CONTROLS. OTHER ACCESSORIES AND SHOWER MODULE SPECIFIED ON ARCHITECTURAL PLANS & SPECIFICATIONS					
SH-1	SHOWER, INDIVIDUAL	1/2"	1/2"	3"	1-1/2"	1.5 GPM, WATER SENSE CERTIFIED. BRADLEY MODEL 1C-HDT1-ST-SF-NONE-LBJ-NONE-NONE-NONE-NONE-AP SHOWER CONTROLS. OTHER ACCESSORIES AND SHOWER MODULE SPECIFIED ON ARCHITECTURAL PLANS & SPECIFICATIONS					
L-1A	UNDERCOUNTER LAVATORY - ADA	1/2"	1/2"	2"	1-1/2"	ACCESSIBLE, UNDERCOUNTER MOUNTED WITH REAR INTEGRAL OVERFLOW, CENTER FLAT STRAINER DRAIN, COLOR SELECTED BY ARCHITECT. MANUAL-TYPE SINGLE-CONTROL MIXING FAUCET WITH 0.5 GPM LAMINAR SPRAY OUTLET. TOTO MODEL LT546G LAVATORY AND MOEN FAUCET MODEL 8210 [NOTE 2, 7]					
L-1	UNDERCOUNTER LAVATORY	1/2"	1/2"	2"	1-1/2"	UNDERCOUNTER MOUNTED WITH REAR INTEGRAL OVERFLOW, CENTER FLAT STRAINER DRAIN, COLOR SELECTED BY ARCHITECT. MANUAL-TYPE SINGLE-CONTROL MIXING FAUCET WITH 0.5 GPM LAMINAR SPRAY OUTLET. TOTO MODEL LT546G LAVATORY AND MOEN FAUCET MODEL 8210 [NOTE 2, 7]					
TD	TRENCH DRAIN	-	-	3"	1-1/2"	BOTTOM DRAIN CONNECTION. SEE ARCHITECTURAL DRAWINGS. PROVIDE DEEP SEAL TRAP WITH PROSET TRAPGUARD					
MB-1	MOP SERVICE SINK	3/4"	3/4"	3"	2"	WALL-HUNG CAST IRON, 24" X 20.5" X 11" SERVICE SINK WITH BACK AND RIM GUARD, CAST IRON "P" TRAP AND 3" STRAINER. AMERICAN STANDARD MODEL AKRON 7695.008. CHICAGO MODEL 305VBRCF WALL MOUNT SERVICE FAUCET.					
FD	FLOOR DRAIN	-	-	3"	1-1/2"	DEEP SEAL TRAP WITH PROSET TRAPGUARD					
WSB-1	WATER SUPPLY CONTROL BOX	3/4"	3/4"	4"	1-1/2"	WATER SUPPLY FOR WASHER. TWO CONTROL BOXES AS PER MANUFACTURER'S REQUIREMENTS. IPS CORP. WIDE MOUTH MODEL# W8900HACP RECESSED OUTLET BOX. WATER HAMMER ARRESTORS, 1/4 TURN COPPER SWEAT VALVES, AND 2" DRAIN CONNECTION. FIRE RATED OUTLET BOX IN RATED WALLS/PARTITIONS. FIVE FEET LONG BRAIDED STAINLESS STEEL OR HEAVY DUTY PVC HOSE SEALED WITH RIGID CORRUGATED OUTER WALL WASHING MACHINE AUTO SHUT-OFF CONNECTORS.					
SCHED	ULE NOTES:										
1. COORDINATE MOUNTING HEIGHTS AND LOCATIONS FOR ALL FIXTURES BEFORE INSTALLATION, REFER TO ARCHITECTURAL ELEVATION DRAWINGS. ROUGH-IN AND INSTALL BARRIER-FREE/ACCESSIBLE FIXTURES PER ADA REQUIREMENTS. COORDINATE AUTOMATIC FLUSH VALVE HEIGHT WITH GRAB BARS.											
2.	FAUCET AS SPECIFIED; WATER SUPPLIE	ES, OFFSET TRA	P; PROVIDE IN	SULATION ON	WASTE AND \	WATER SUPPLIES.					
9235											

PROVIDE MANUFACTURED PROTECTIVE SHIELDING PIPE COVERS AND ENCLOSURES FOR COVERING EACH ADA PLUMBING FIXTURE HOT- AND COLD-WATER SUPPLIES AND TRAP AND DRAIN PIPING TO COMPLY WITH ADA REQUIREMENTS. TRUEBRO LAV GUARD2 OR APPROVED EQUAL. OMIT WHERE FRONT CLOSURE PANEL OCCURS ON ARCHITECTURAL DRAWINGS.

## 4. HEAVY DUTY, ONE-PIECE CONSTRUCTION, CHROME PLATED BRASS, VANDAL-RESISTANT BUBBLERS. PROVIDE CANE APRON LKAPREZL, FRONT ACCESS STAINLESS STEEL PANEL, MLP100 IN-WALL SUPPORT FRAME, AND 51300C WATERSENTRY PLUS FILTER AND WATERSENTRY VII FILTER KIT. 8 GPH CAPACITY. 120 VOLT, 1 PHASE, 60 HZ. 5. HEAVY DUTY, ONE-PIECE CONSTRUCTION, CHROME PLATED BRASS, VANDAL-RESISTANT BUBBLERS. PROVIDE CANE APRON LKAPREZL, FRONT ACCESS STAINLESS STEEL PANEL, MLP200 IN-WALL SUPPORT FRAME, AND 51300C WATERSENTRY PLUS FILTER AND WATERSENTRY VII FILTER KIT. 8 GPH CAPACITY. 120 VOLT, 1 PHASE, 60 HZ. 6. PIPE WASTE FROM THE FIXTURE AS INDIRECT WASTE TO NEAREST FLOOR DRAIN/FLOOR SINK. PROVIDE READY ACCESS FOR INDIRECT WASTE PIPING FOR MEANS OF FLUSH COLLECTION PER OSHA MANDATED USER TESTING.

A/C & VRF SYSTEM CONDENSATE PIPE

SIZING SCHEDULE

UNIT COOLING CAPACITY (TON)	BRANCH/MAIN (INCHES)	RUNOUTS (INCHES)
0-3.0	1-1/4	1-1/4
3.1-6.0	1-1/2	1-1/4
6.1-12.0	2	1-1/4
12.1-20.0	2-1/2	1-1/4
20.1-30.0	3	9
NOTES:		
1.	THE ABOVE SCHEDULE IS A STANDA ONLY WHERE PIPE SIZES ARE NOT S	
2.	MINIMUM PIPE SIZE SHALL BE 1-1/4" A SIZES WHICHEVER IS LARGER.	AND/OR EQUIPMENT CONNECTION
3.	PROVIDE CONDENSATE DRAIN PIPIN AND EXTEND TO NEAREST INDIRECT DISCHARGE TO ANY OTHER FLOOR I	WASTE FUNNEL DRAIN. DO NOT

COORDINATE DRAIN LOCATIONS SHOWN ON PLUMBING FLOOR PLANS.

APPLY TO PLUMBING AND MECHANICAL DRAWINGS.

### PLUMBING SPECIALTIES SCHEDULE

			PLUMBIN	IG SPECIALTIES SCHEDULE	
TAG	DESCRIPTION	MANUFACTURER	MODEL	CAPACITY	REMARKS
со	CLEANOUT - FLOOR (VCT/CERAMIC TILE)	ZURN	ZB-1400-BP-TX	MINIMUM 4" OR LINE SIZE (UNO)	NOTE 1
ECO	CLEANOUT - EXTERIOR	ZURN	Z-1400-BP-HD	MINIMUM 4", LINE SIZE (UNO)	
wco	CLEANOUT - WALL	ZURN	Z-1447-BP	MINIMUM 4" OR LINE SIZE (UNO)	NOTE 1
CO AP	CLEANOUT - ACCESS PANEL	ACUDOR	UF-5000-PS-CL-16X16	-	PROVIDE FOR ALL EXISTING AND NEW WALL CLEANOUTS
FD	FLOOR DRAIN - VCT/CERAMIC TILE	ZURN	ZN-415-6S-HD-VP	6" X 6" HEAVY DUTY STRAINER, MIN. 3" OR LINE SIZE (UNO)	PROVIDE DEEP SEAL TRAP AND PROSET TRAP GUARD. NOTE 2
FS	FLOOR SINK	ZURN	ZM1751-HD-KC-YS-19	12" X 12" X 8" TYPE 316 STAINLESS STEEL HEAVY DUTY. 23 SQ. IN. GRATE OPEN AREA. 4" SIZE (UNO)	PROVIDE DEEP SEAL TRAP AND PROSET TRAP GUARD. NOTE 2
RD	ROOF DRAIN	ZURN	ZA-100-C-EA-R-SC-VP-XJ-84	15" ALUMINUM DOME	PROVIDE ZURN ZARB199-SS NOZZLE AT 18" AFG WITH 24"LX3"HX12"W CONCRETE SPLASH BLOCK WHERE ON GRADE ROOF DRAIN DISCHARGE IS APPROVED
WHA	WATER HAMMER ARRESTER	ZURN	Z-1700	AS PER PDI	
WDT	COMMERCIAL/INDUSTRIAL WASHER DRAIN THROUGH	H-M COMPANY	HM70	SUITABLE FOR SPECIFIED 65 LB INDUSTRIAL WASHER-EXTRACTOR DRAIN CAPACITY MIN. 48" L X 24" W X 18" H, 3" TOP INLETS AND 4" SIDE / BOTTOM OUTLET	1/4" THICK POLYPROPYLENE BODY, 1/4" PVC REMOVABLE LINT FILTER WITH 3/8" PERFORATIONS, 3/4" THICK POLYPROPYLENE REMOVABLE LID AND SIDE FLANGES FASTENED WITH STAINLESS STEEL SCREWS RECESSED IN FLOOR/CONCRETE PAD.

### PLUMBING SPECIALTIES SCHEDULE NOTES:

SUBDIVISION: FULLERTON

3. PROVIDE FLOOR MOUNTED CHAIR-CARRIER TYPE FIXTURE SUPPORTS FOR EACH OFF-THE-FLOOR MOUNTED FIXTURE SUCH AS LAVATORIES, URINALS, WATER CLOSETS, WATER COOLERS, AND SIMILAR OTHER FIXTURES.

1.	REPLACE CLEANOUT COVERS TO MATCH EXISTING SIZE AND SHAPE FOR ALL FLOOR AND WALL CLEANOUTS TO SUIT NEW FINISHES, WHETHER SHOWN OR NOT.

_	DEDLACE ELOOP DRAIN CTRAINERS TO MATCH EVICTING SIZE AND SHAPE FOR ALL ELOOP DRAINS TO SHIT NEW EINIGHES MATCHES SHOWN OR NOT
<b>Z</b> .	REPLACE FLOOR DRAIN STRAINERS TO MATCH EXISTING SIZE AND SHAPE FOR ALL FLOOR DRAINS TO SUIT NEW FINISHES, WHETHER SHOWN OR NOT.
10.304	

	PROFESSIONAL CERTIFIC	CATION	AS-BUILT / REVISION		DATE	P.W.A. NO.	KEY SHEET	POSITION SHT	DRAWIN	G SCALE		
	I HEREBY CERTIFY THAT THESE DOCUMENTS V APPROVED BY ME, AND THAT I AM A DULY LICE		BID/PERMIT		9/20/24	-	MSW	27NE21 PLA	PLAN SCALE:	NONE	APPROVED BY: Mihai T. Petrisor	
PROFESSIONAL ENGINEER UNDER THE LAWS C					R.O.W NO.	-	-		-	10/03/2024	DIRECTO	
-	LICENSE NO. 22942 EXPIRATION DATE: 12-24-2024					-	-	-	PROFILE SCALE:	-	DATE:	
,,,,,,	ENGINEER:UDAY PATEL, PE, LEED BD+C	DGN BY: CCJM	BUREAU OF ENGINEERING AND CONSTRUCTION	HIG	HWAYS	STRUCTURES	STORM DRAINS	SEWER	WATER	FIELD ENGINEER	PROPERTY MANAGE	MENT
PRINCIPAL MECHANICAL ENGINEER  C.C. JOHNSON & MALHOTRA, P.C.  400 EAST PRATT STREET, SUITE 604  BALTIMORE, MARYLAND 21202  (P) 410-461-9920	C.C. JOHNSON & MALHOTRA, P.C.	DWN BY: CCJM REVIEWED BY:									APPROVED BY:	СНІЕ
	CHKD BY: CCJM	DATE REVIEWED:								DATE:		

BALTIMORE COUNTY OFFICE OF BUDGET AND FINANCE, PROPERTY MANAGEMENT

FULLERTON FIRE STATION #8 - RENOVATION & ADDITION

SCHEDULES

4401 FITCH AVENUE, NOTTINGHAM, MARYLAND, 21236

	22221 PFO
	JOB ORDER NUMBI
	241-220-0054-00
	SHEET 48 of 58
' /	DRAWING NUMBE
	2022-2364

SHEET DESIGNATION | CONTRACT NUMBER

R NUMBER 0054-0012 48 of 58 G NUMBER -2364

## ELECTRICAL, COMMUNICATION, ELECTRONIC SAFETY AND SPECIAL SYSTEMS LEGEND

	ABBREVIATIONS											
ABBREV	DESCRIPTION	ABBREV	DESCRIPTION									
AS/AF	AMPERES SWITCH & FUSE RATING	HTR	HEATER									
A, AMP	AMPERES	HV	HIGH VOLTAGE									
AC	ALTERNATING CURRENT, ARMORED CABLE	MDP	MAIN DISTRIBUTION PANEL									
ACU	AIR CONDITIONING UNIT	MTD	MOUNTED									
AF	AMPERE FRAME	MLO	MAIN LUGS ONLY									
AFF	ABOVE FINISHED FLOOR	MTG	MOUNTING									
AFG	ABOVE FINISHED GRADE	N NEC	NEUTRAL									
AHU	AIR HANDLING UNIT		NATIONAL ELECTRICAL CODE									
AIC	AMPERE INTERRUPTING CAPACITY	NIC	NOT-IN-CONTRACT									
ATC	AUTOMATIC TEMPERATURE CONTROL	NL NO	NIGHT LIGHT									
ATS	AUTOMATIC TRANSFER SWITCH	NO NTC	NORMALLY OPEN NOT TO SCALE									
AUX	AUXILIARY	NTS NFSS	NON FUSED SAFETY SWITCH									
AWG	AMERICAN WIRE GAUGE	OC NF35	ON CENTER									
BES	BLDG ELECTRICAL SYSTEM	OL OL	OVERLOAD									
BIL BLDG	BASIC IMPLUSE LEVEL BUILDING	P	POLE OR POLES									
BKBD	BACKBOARD	PF	POWER FACTOR									
BRKR	BREAKER	РΗ, φ	PHASE									
C	CONDUIT	VT	POTENTIAL TRANSFORMER									
CEC		PNL	PANELBOARD									
CB	CIRCUIT BREAKER	PVC	POLYVINYL CHLORIDE									
CCTV	CLOSED CIRCUIT TELEVISION	R	REMOVE									
CKT	CIRCUIT	RAF	RETURN AIR FAN									
CR	CARD READER	RECEPT	RECEPTACLE									
CL	CURRENT LIMITING	REQD	REQUIRED									
CLG	CEILING	RGS	RIGID GALVANIZED STEEL									
CPT	CONTROL POWER TRANSFORMER	RMS	ROOT MEAN SQUARE									
СТ	CURRENT TRANSFORMER	RS	RAPID START									
CUH	CABINET UNIT HEATER	RVAT	REDUCED VOLTAGE AUTOTRANSFORMER									
CW	COOL WHITE	S/N	SOLID NEUTRAL									
DGS	DIESEL GENERATOR SET	SD SEC	SMOKE DETECTOR SECONDARY									
DIA	DIAMETER	SFA	SPRINKLER FLOW ALARM									
DISC	DISCONNECT	SMR	SURFACE METAL RACEWAY									
DIST	DISTRIBUTION	ST	SHUNT TRIP									
DN	DOWN	SS	SUB STATION									
DP	DISTRIBUTION PANEL	STR	STARTER									
DVR	DIGITAL VIDEO RECORDER	SW	SWITCH									
DWG	DRAWING	SWBD	SWITCHBOARD									
Е	EMERGENCY ELECTRIC BASEBOARD HEATER	SWGR	SWITCHGEAR									
EBH EC	EMPTY CONDUIT	SYS	SYSTEM									
ECB	ENCLOSED CIRCUIT BREAKER	SYM	SYMMETRICAL									
EF	EXHAUST FAN	SOPN	SPACE OR POLE NUMBER									
EGS	ELECTRIC GENERATOR SET	TA	TRIP AMPERE									
EH	ELECTRIC HEATER	ТВ	TERMINAL BOX									
ELECT	ELECTRICAL	TC	TIME CLOCK									
EMT	ELECTRICAL METALLIC TUBING	TD	TIME DELAY									
ENCL	ENCLOSURE	TTB	TELEPHONE TERMINAL BOARD/BLOCK									
EQUIP	EQUIPMENT	TTC	TELEPHONE TERMINAL CLOSET									
ER	EXISTING RELOCATED	TYP	TYPICAL									
ETR	EXISTING-TO-REMAIN	TV	TELEVISION									
EX	EXISTING	UC	UNDER COUNTER									
EXH	EXHAUST	UG UOI	UNDERGROUND UNLESS OTHERWISE INDICATED									
F	FUSED OR FUSIBLE	UON	UNLESS OTHERWISE INDICATED  UNLESS OTHERWISE NOTED									
FA	FRAME AMPERE	USB	UNIVERSAL SERIAL BUS									
FAAP	FIRE ALARM ANNUNCIATOR PANEL	028	VOLT (S) OR VOLTAGE									

V VOLT (S) OR VOLTAGE

VFD VARIABLE FREQUENCY DRIVE

WP | WEATHER PROOF, WORK PHONE

VA VOLT AMPERE

WITH

WW WIREWAY

XFMR TRANSFORMER

POWER DISTRIBUTION									
PANELBOARD - SURFACE MTD									
	PANELBOARD - RECESSED								
J , ①	JUNCTION BOX								
D <sub>D</sub> ,O <sub>D</sub>	JUNCTION BOX FOR SYSTEM FURNITURE DATA - 18" AFF								
	CIRCUIT BREAKER								
	MOTOR CONNECTION								
	SAFETY SWITCH NONFUSED, SIZE AS INDICATED								
Εh	SAFETY SWITCH FUSED, SIZE AS INDICATED								
	ELECTRICAL DEVICE AS INDICATED								
<b>⊠</b> h	COMBINATION TYPE MOTOR STARTER, SIZE AS INDICATED								
	CONDUIT, CONCEALED IN CEILING OR WALL OR CHASE								
	CONDUIT CONCEALED IN FLOOR OR UNDERFLOOR OR UNDERGROUND								
—  II	SYSTEM GROUND OR EQUIPMENT GROUND								
_	208 VOLT PANELBOARD								
	480 VOLT PANELBOARD								
	MEDIA CENTER								

WIRING DEVICES										
Φ	DUPLEX RECEPTACLE - 20A, 2P, 3W, 120V									
	DUPLEX RECEPTACLE - FLUSH MOUNTED FLOOR BOX									
<b>+</b>	TWO DUPLEX RECEPTACLE IN TWO-GANG BOX - 20A, 2P, 3W, 120V									
•	RANGE RECEPTACLE									
Φ	SWITCH DUPLEX RECEPTACLE CIRCUIT - 20A, 2P, 3W, 120V									
	SPECIAL RECEPTACLE, SIZE AND TYPE AS NOTED									
₩P	GFCI WP RECEPTACLE WITH IN-USE BUBBLE COVER									
ФGFI	DUPLEX RECEPTACLE WITH GROUND FAULT CIRCUIT 20A, 2P, 3W, HOSPITAL GRADE									
₽м	RECEPTACLE - FLAT DISPLAY PANEL									
Фwс	DUPLEX RECEPTACLE FOR ELECTRIC WATER COOLER									
⊕ <sup>EM</sup>	RECEPTACLE - EMERGENCY POWER									
ФС	DUPLEX RECEPTACLE - CEILING									
Фusв	DUPLEX RECEPTACLE WITH (2) UNIVERSAL SERIAL BUS PORTS									
φIG	DUPLEX RECEPTACLE ISOLATED GROUND - 20A, 2P, 3W, 120V									
Hτν	TV POWER OUTLET WITH CABLE HOOK-UP (SEE TELECOMMUNICATION/ NETWORK LEGEND FOR SPECIFICATIONS)									

#### LIGHTING LIGHTING FIXTURE 0 LIGHTING FIXTURE ON NORMAL / EMERGENCY OR EMERGENCY 0 ONLY OR BATTERY INVERTER CIRCUIT <u></u>, 9 WALL MOUNTED LIGHTING FIXTURE ---INDUSTRIAL TYPE STRIPLINE FIXTURE; NORMAL, EMERGENCY CEILING MOUNTED DOWN LIGHT; NORMAL, EMERGENCY CIRCUIT WALL MOUNTED LIGHTING FIXTURE —ILLUMINATED FACE EXIT SIGN - WALL MTD WITH DIRECTIONAL ARROW AS REQUIRED $\otimes$ $\uparrow$ EXIT SIGN - SINGLE FACE, CEILING MTD WITH DIRECTIONAL ARROW AS REQUIRED $\dagger \otimes \dagger$ EXIT SIGN - DUAL FACE, CEILING MTD WITH DIRECTIONAL ARROWS AS REQUIRED EMERGENCY LIGHTING UNIT & EXIT LIGHT - WITH 2 REMOTE HEADS EMERGENCY LIGHTING UNIT - BATTERY TYPE WITH NUMBER OF HEADS AS INDICATED EMERGENCY LIGHTING UNIT - REMOTE HEAD WITH NUMBER OF HEADS AS INDICATED


### SWITCHING SYMBOLS SINGLE POLE SWITCH THREE WAY SWITCH MANUAL MOTOR STARTER WITH THERMAL OVERLOAD AND HOA SWITCH LOW VOLTAGE SWITCH LOW VOLTAGE DIMMER TWO BUTTON ENTRY ROOM CONTROL STATION (LIGHTING) gL3 THREE BUTTON ENTRY ROOM CONTROL STATION (LIGHTING) OCCUPANCY SENSOR VACANCY SENSOR PHOTO SENSOR PP POWER PACK

## WIRING NOTES

- A. BRANCH CIRCUIT WIRING FOR 120 VOLT 20 AMP CIRCUITS WIRED TO 208Y/120V SYSTEMS SHALL BE ADJUSTED FOR DISTANCE VOLTAGE DROP AND LOAD HARMONIC CONTENTS AS FOLLOWS: 1. GENERAL RECEPTACLES AND RESISTIVE LOADS: UP TO 100 FEET IN LENGTH: 3#12, 1#12N, 1#12G - 3/4"C
- OVER 100 FEET IN LENGTH: 3#10, 1#10N, 1#10G 3/4"C 2. COMPUTER RECEPTACLES, LED LIGHTING: UP TO 100 FEET IN LENGTH: 3#12, 1#10N, 1#12G - 3/4"C OVER 100 FEET IN LENGTH: 3#10, 1#8N, 1#10G - 3/4"C
- B. ALL WORK IS NEW, UNLESS NOTED OTHERWISE

SUBDIVISION: FULLERTON

C. ALL CONDUIT SHALL BE 3/4" MINIMUM. ALL CONDUCTORS SHALL BE #12 THHN,

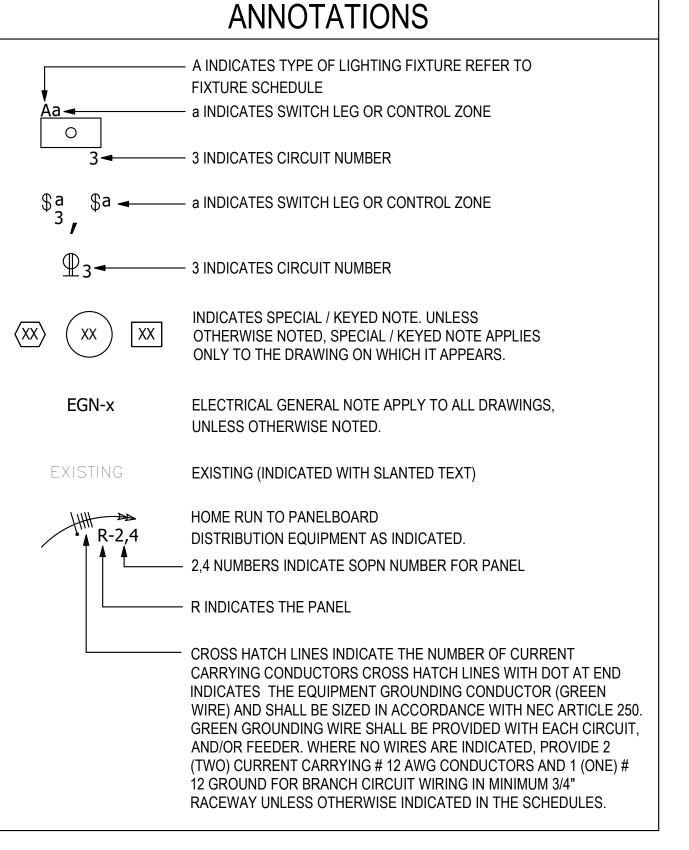

### MOUNTING HEIGHTS

NOTE: UNLESS OTHERWISE INDICATED, STANDARD MOUNTING HEIGHTS FOR OUTLET BOXES FOR THE FOLLOWING EQUIPMENT/DEVICE SHALL BE ABOVE FINISHED FLOOR AND SHALL BE TO THE CENTER LINE OF EQUIPMENT & FIELD COORDINATED.

EQUIPMENT/DEVICE	MOUNTING HEIGHT
SWITCHES	48 INCH
RECEPTACLE-GENERAL	18 INCH
RECEPTACLE-SPECIAL	18 INCH
RECEPTACLE-SINGLE	18 INCH
RECEPTACLE-REST ROOM	9 INCH ABOVE BASIN
RECEPTACLE-COUNTER	8 INCH ABOVE COUNTER
RECEPTACLE- MONITOR (DISPLAY)	78 INCH OR DIRECTED BY OWNER
RECEPTACLE-EXTERIOR	30 INCH
CABLE TV OUTLET	78 INCH, 18 INCH FOR APARTMENTS, UON
TELEPHONE/DATA-GENERAL	18 INCH
TELEPHONE-WALL TYPE	54 INCH, (48 INCH ADA ACCESSIBLE)
FIRE ALARM PULL STATION	48 INCH
FIRE ALARM AUDIO/VISUAL DEVICE	80 INCH
CARD READER	40 INCH
EXIT LIGHT WALL MOUNTED	MAX. 90 INCH
SAFETY SWITCH	72 INCH TO HANDLE
PANELBOARD	72 INCH TO TOP CB
MANUAL MOTOR STARTER	48 INCH
PUSH BUTTON	48 INCH
AUTOMATIC DOOR OPENER	36 INCH
APARTMENT UNITS	
TELEPHONE/DATA, KITCHEN ONLY	48 INCH
REFRIGERATOR RECEPTACLE	48 INCH
WASHER/DRYER RECEPTACLE	36 INCH

I	
	SEAL  OF MAR  CHIH  A4664  A4664
	DATE 9/20/24

FADS | FIRE ALARM AND DETECTION SYSTEM

FACP | FIRE ALARM CONTROL PANEL

FBO FURNISHED BY OTHERS

FSS | FUSED SAFETY SWITCH

GRS | GALVANIZED RIGID STEEL

HID HIGH INTENSIFY DISCHARGE

HOA HAND-OFF-AUTOMATIC

HPS HIGH PRESSURE SODIUM

HP HORSE POWER

FVNR | FULL VOLTAGE NON REVERSING

GFCI GROUND FAULT CURRENT INTERRUPTER

FDR FEEDER

GND GROUND

FLUOR | FLUORESCENT

FT | FOOT OR FEET

GW GROUND WIRE HC HANDICAP HD | HEAVY DUTY


	PROFESSIONAL CERTIFIC	CATION	AS-BUILT / REVISION		DATE	P.W.A. NO.	KEY SHEET	POSITION SHT	DRAWIN	G SCALE	
APPROVED BY ME, AND TO PROFESSIONAL ENGINEE MARYLAND. LICENSE NO. 44664  ENGINEER: TA CHIH LIN, PE	I HEREBY CERTIFY THAT THESE DOCUMENTS APPROVED BY ME, AND THAT I AM A DULY LICI	BID/PERMIT		9/20/24	-	MSW	27NE21	PLAN SCALE:	NONE	APPROVED BY: Mihai T. Petrisor	
	PROFESSIONAL ENGINEER UNDER THE LAWS O MARYLAND.				R.O.W NO.	- - -	- - -	PROFILE SCALE:	-	DATE: 10/03/2024 DIRECTOR	
	TA CHIH LIN, PE	DGN BY: CCJM	BUREAU OF ENGINEERING AND CONSTRUCTION	HIGH	HWAYS	STRUCTURES	STORM DRAINS	SEWER	WATER	FIELD ENGINEER	PROPERTY MANAGEMENT
	C.C. JOHNSON & MALHOTRA, P.C.	DWN BY: CCJM	REVIEWED BY:								APPROVED BY: CHIEF
	BALTIMORE, MARYLAND 21202	CHKD BY: CCJM	DATE REVIEWED:								DATE:

BALTIMORE COUNTY OFFICE OF BUDGET AND FINANCE, PROPERTY MANAGEMENT

FULLERTON FIRE STATION #8 - RENOVATION & ADDITION

SYMBOLS AND ABBREVIATIONS

4401 FITCH AVENUE, NOTTINGHAM, MARYLAND, 21236

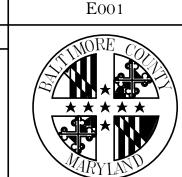


SHEET DESIGNATION | CONTRACT NUMBER 22221 PFO JOB ORDER NUMBER 241-220-0054-0012 SHEET 49 of 58 DRAWING NUMBER


2022-2365 FILE NO.: 20-120


### POWER AND SYSTEMS DEMOLITION GENERAL NOTES

- EXISTING ELECTRICAL SYSTEM IS DESCRIBED BASED ON SITE CONDITIONS VISIBLE AT THE TIME OF 7. THE SURVEY. THE CONTRACTOR SHALL VISIT THE JOB SITE TO FAMILIARIZE HIMSELF WITH THE EXTENT OF EXISTING WORK TO BE DEMOLISHED
- ELECTRICAL CONTRACTOR SHALL REMOVE ALL ELECTRICAL EQUIPMENT AFFECTED BY THE DEMOLITION. COORDINATE EXACT SCOPE OF WORK WITH ARCHITECTURAL, MECHANICAL AND PLUMBING DRAWINGS
- ALL EXPOSED CONDUITS, HANGERS, SUPPORTS, ETC. THAT ARE ABANDONED SHALL BE REMOVED. 8. CONDUIT WHICH IS BURIED IN CONCRETE OR OTHERWISE INACCESSIBLY POSITIONED MAY BE ABANDONED. IN SUCH CASES, WIRE SHALL BE PULLED OUT OF THE CONDUIT AND THE CONDUIT ITSELF PLUGGED AT EACH END
- WHERE EXISTING DEVICES, CONDUIT WIRE, SUPPORTS, HANGERS AND OTHER ELECTRICAL EQUIPMENT MUST BE REMOVED AS A RESULT OF THE ALTERATIONS, THEY SHALL BE COMPLETELY 10. REMOVED, BACK TO THE FIRST OUTLET WHICH IS LEFT UNAFFECTED. IF REMOVED BACK TO THE PANEL, LABEL THAT CIRCUIT AS SPACE
- PATCH ALL HOLES IN SLABS, WALLS AND CEILING WHERE ELECTRICAL DEVICES AND/OR CONDUIT ARE REMOVED. IF THE REMOVAL OF CONDUIT, BOXES, EQUIPMENT, ETC. COMPROMISES THE FIRE RATING OF THESE ITEMS, THE CONTRACTOR SHALL SEAL OPENINGS WITH CODE APPROVED FIRE STOPPING MATERIAL
- WHERE EXISTING ELECTRICAL WORK PREVENTS PROPER CONSTRUCTION OF NEW WORK, REMOVE, REROUTE, RELOCATE, OR IN OTHER WAYS ALTER EXISTING WORK TO ACCOMMODATE

- SOME EXCEPTIONS MAY ARISE WHEREIN EQUIPMENT, EITHER IN ALTERED AREAS OR OTHER AREAS, MUST BE KEPT IN SERVICE, REQUIRING THAT FEEDERS, SIGNAL CONDUCTORS, CONDUITS, BOXES ETC. SERVING THE SAME ALSO BE KEPT IN SERVICE. IN SUCH CASES, THE ELECTRICAL FEEDERS, SIGNAL CONDUCTORS, CONDUITS, ETC. SHALL BE REROUTED AND RECONNECTED BEFORE PRESENT WORK IS REMOVED. IF THIS IS NOT POSSIBLE, TEMPORARY WIRING SHALL BE PROVIDED TO ALLOW FOR INSTALLATION OF NEW WORK, AFTER WHICH TEMPORARY WIRING SHALL BE REMOVED
- ALL PROPOSED DEMOLITION WORK SHALL BE THOROUGHLY COORDINATED WITH ALL OTHER
- CONTRACTOR IS TO PERFORM DEMOLITION WORK IN A NEAT, SKILLFUL, AND CAREFUL MANNER SO AS NOT TO DAMAGE OR DEFACE EXISTING CONSTRUCTION THAT IS TO REMAIN 1
- CONFIRM WITH THE MANUFACTURERS OF EXISTING EQUIPMENT THAT IS TO BE REVISED OR EXTENDED. ENSURE THAT EXISTING EQUIPMENT COMPLIES WITH NEW WORK REQUIREMENTS
- 11. ELECTRICAL CONTRACTOR TO REROUTE, AND REFEED ALL EXISTING EQUIPMENT/DEVICES TO REMAIN BUT MAY BE AFFECTED BY EQUIPMENT BEING DEMOLISHED

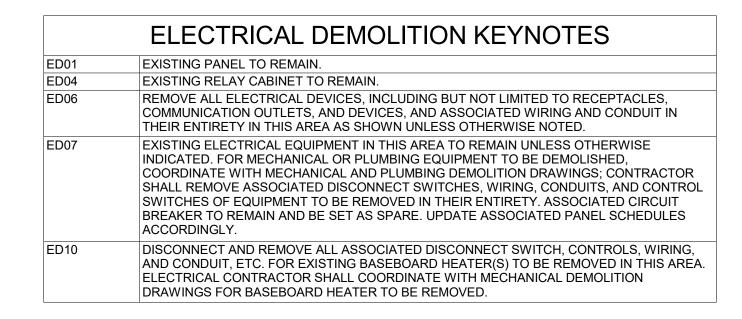

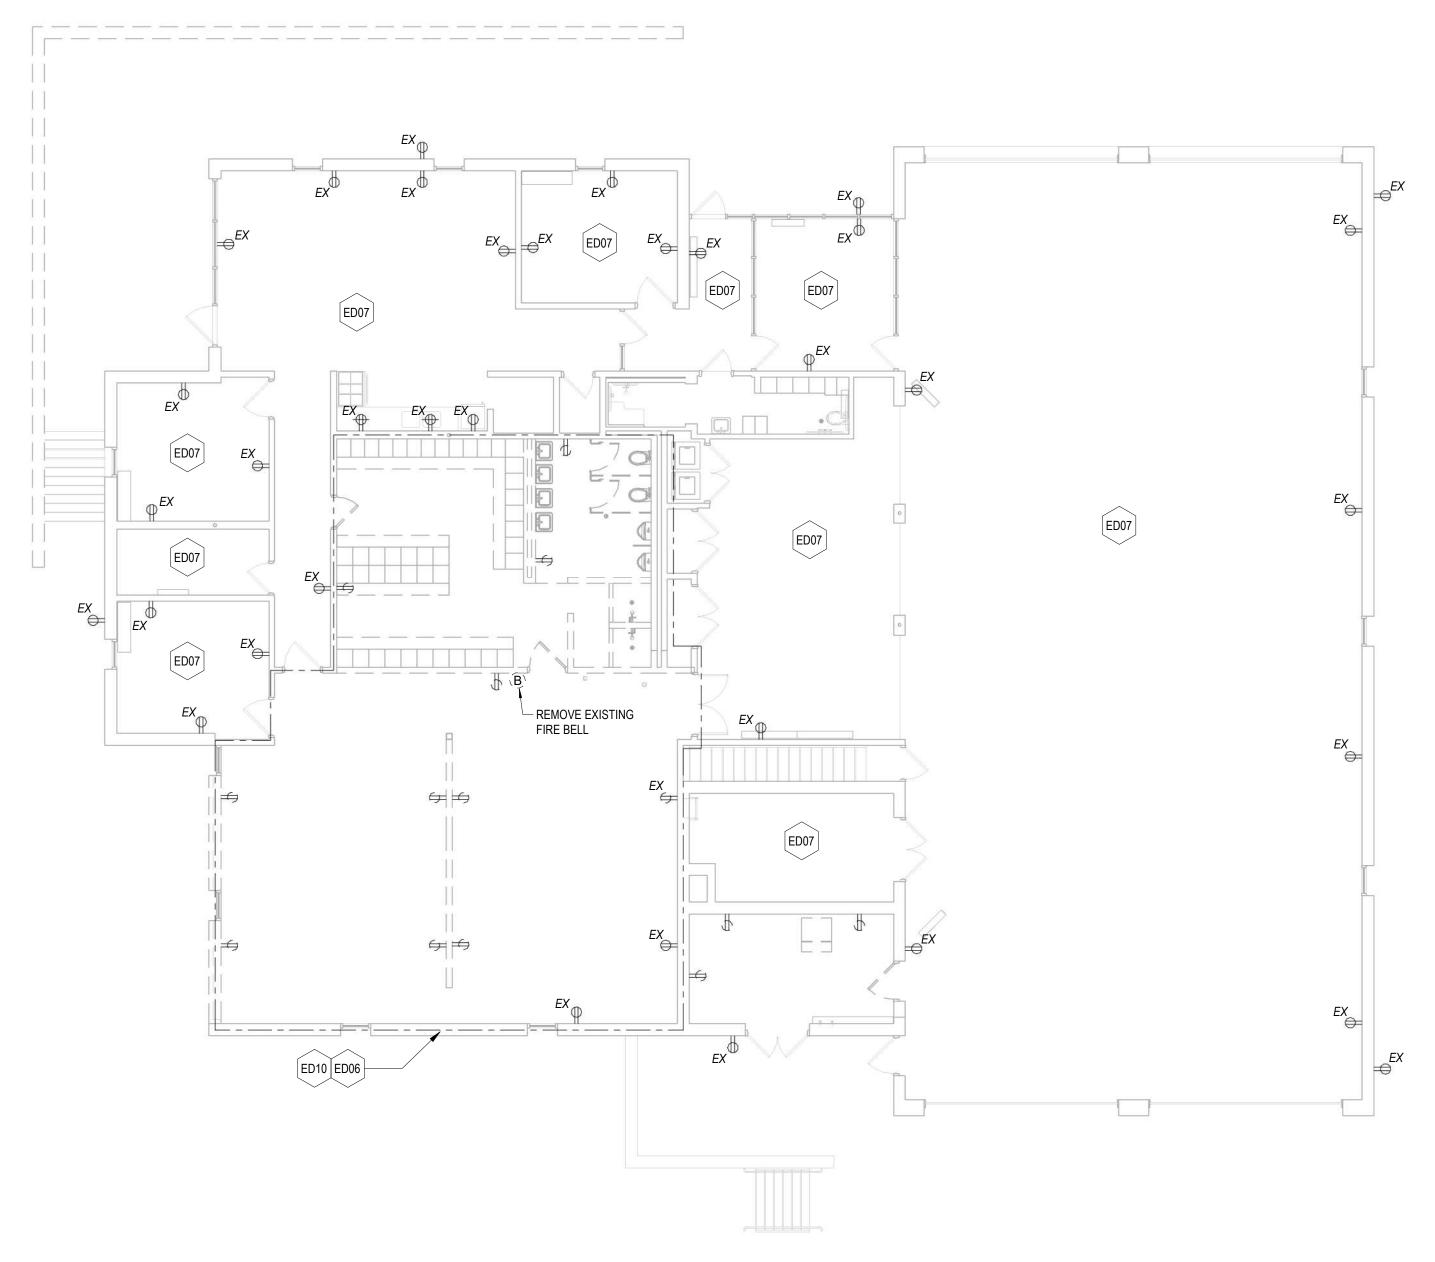

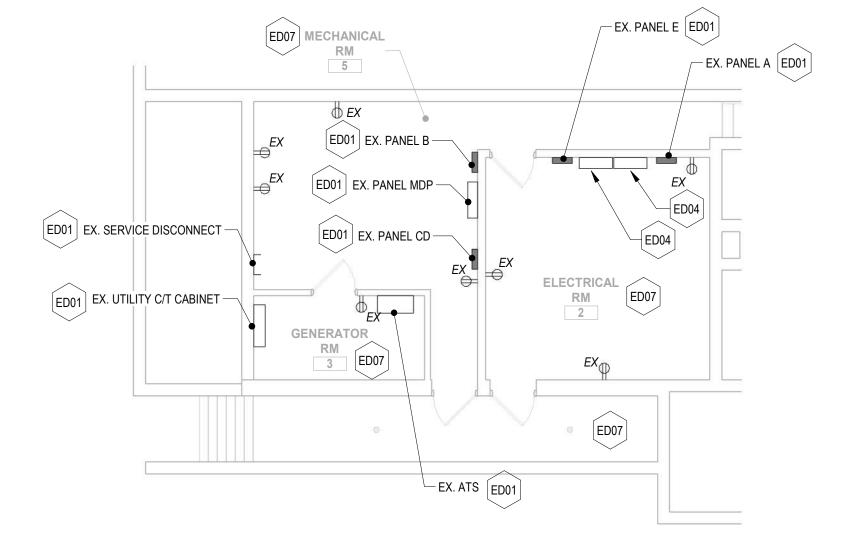

**ELECTRICAL - FIRST FLOOR PLAN - DEMOLITION** 

2 ELECTRICAL - BASEMENT FLOOR PLAN - DEMOLITION

1/8" = 1'-0"

SEAL	PROFESSIONAL CERTIFIC	CATION	AS-BUILT / REV	VISION	BY	DATE	P.W.A. NO.	KEY SHEET	POSITION SHT	DRAWIN	G SCALE	
(V) (1) (W/A), (7)	I HEREBY CERTIFY THAT THESE DOCUMENTS WERE PREPARED OR APPROVED BY ME, AND THAT I AM A DULY LICENSED PROFESSIONAL ENGINEER UNDER THE LAWS OF THE STATE OF MARYLAND. LICENSE NO. 44664 EXPIRATION DATE: 06-18-2025		BID/PERMIT			9/20/24	-	MSW	27NE21	PLAN SCALE:	AS INDICATED	APPROVED BY: Mihai T. Petrisor
CHIH							R.O.W NO.	1 :   :				10/03/2024
							-	-	-	PROFILE SCALE:	-	DATE:
	ENGINEER: TA CHIH LIN, PE	DGN BY: CCJM	BUREAU OF ENGINEERING AND CONSTRUCTION		HIGH	IWAYS	STRUCTURES	STORM DRAINS	SEWER	WATER	FIELD ENGINEER	PROPERTY MANAGEMENT
4466A (KILLING)	PRINCIPAL ELECTRICAL ENGINEER  C.C. JOHNSON & MALHOTRA, P.C. 400 EAST PRATT STREET, SUITE 604	DWN BY: CCJM	REVIEWED BY:									APPROVED BY: CHIEF
	BALTIMORE MARYLAND 91909	CHKD BY: CCJM	DATE REVIEWED:									DATE:

BALTIMORE COUNTY OFFICE OF BUDGET AND FINANCE, PROPERTY MANAGEMENT

FULLERTON FIRE STATION #8 - RENOVATION & ADDITION

SUBDIVISION: FULLERTON

POWER AND SYSTEMS - FIRST & BASEMENT FLOOR PLANS - DEMOLITION

4401 FITCH AVENUE, NOTTINGHAM, MARYLAND, 21236

ELECTION DIST. NO.: 14C5

ED100

SHEET DESIGNATION CONTRACT NUMBER 22221 PFO JOB ORDER NUMBER 241-220-0054-0019 SHEET 50 of 58 DRAWING NUMBER 2022-2366

### POWER AND SYSTEMS DEMOLITION GENERAL NOTES


1. SEE ED100 FOR ADDITIONAL POWER AND SYSTEMS DEMOLITION GENERAL NOTES

ED12 REMOVE EXISTING EXHAUST FAN AND ASSOCIATED DISCONNECT, WIRING, AND CONDUIT BACK TO SOURCE. COORDINATE ALL WORK WITH MECHANICAL CONTRACTOR.

ED13 REMOVE EXISTING MECHANICAL EQUIPMENT, HEAT PUMP UNIT, AND ASSOCIATED INDOOR UNIT, DISCONNECT SWITCH, WIRING, AND CONDUIT BACK TO SOURCE. COORDINATE ALL WORK WITH MECHANICAL CONTRACTOR.

ED14 EXISTING TO REMAIN

ED15 EXISTING INCOMING CABLES TO REMAIN AND BE REROUTED. DISCONNECT EXISTING CABLES AND MAKE READY FOR REROUTING. ASSOCIATED TERMINATION POINT TO REMAIN AND BE RECONNECTED. SEE NEW WORK PLAN FOR ADDITIONAL INFORMATION.

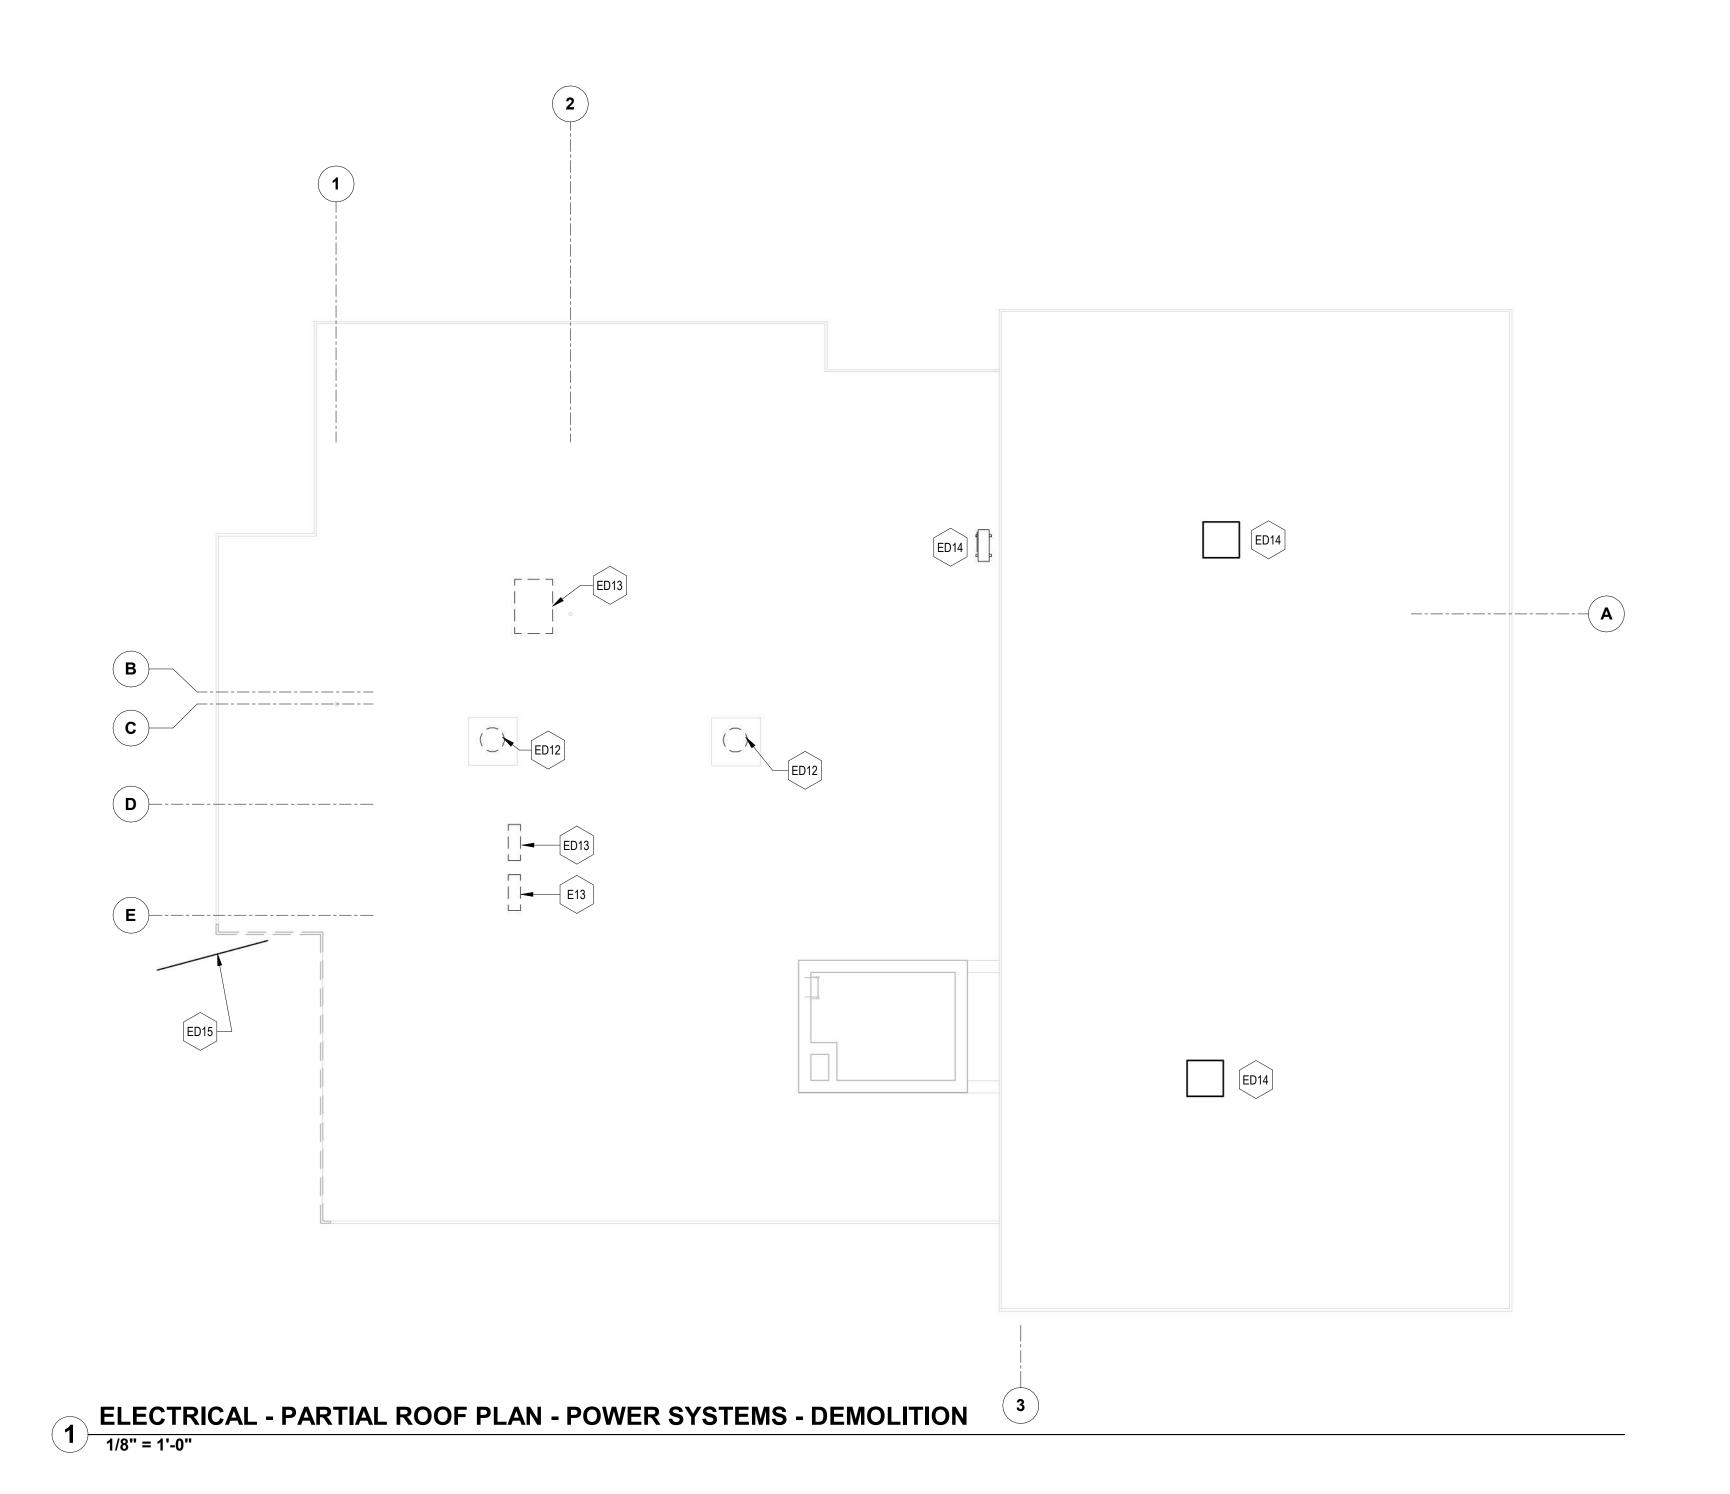

SEAL	PROFESSIONAL CERTIFIC	CATION	AS-BUILT / REV	ISION	BY	DATE	P.W.A. NO.	KEY SHEET	POSITION SHT	DRAWIN	G SCALE	
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CHIH IN THE CHIH							R.O.W NO.	- - -	- - -	PROFILE SCALE:	-	DATE: 10/03/2024
	ENGINEER:	DGN BY: CCJM	BUREAU OF ENGINEERING AND CONSTRUCTION		HIGH	WAYS	STRUCTURES	STORM DRAINS	SEWER	WATER	FIELD ENGINEER	PROPERTY MANAGEMENT
4466A 16 11 11 11 11 11 11 11 11 11 11 11 11	PRINCIPAL ELECTRICAL ENGINEER C.C. JOHNSON & MALHOTRA, P.C.	DWN BY: CCJM	REVIEWED BY:									APPROVED BY:
DATE: 9/20/24	400 EAST PRATT STREET, SUITE 604 BALTIMORE, MARYLAND 21202 (P) 410-461-9920	CHKD BY: CCJM	DATE REVIEWED:									DATE:

BALTIMORE COUNTY OFFICE OF BUDGET AND FINANCE, PROPERTY MANAGEMENT

FULLERTON FIRE STATION #8 - RENOVATION & ADDITION

SUBDIVISION: FULLERTON

POWER AND SYSTEMS - ROOF PLAN - DEMOLITION

4401 FITCH AVENUE, NOTTINGHAM, MARYLAND, 21236

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JOB ORDER NUMBER	8 A
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SHEET 51 of 58	4 10.


CONTRACT NUMBER

SHEET DESIGNATION

ED101

### LIGHTING GENERAL DEMOLITION NOTES

- BEFORE THE PERFORMANCE OF ANY DEMOLITION WORK, THE ELECTRICAL CONTRACTOR SHALL VERIFY THE EXISTING CONDITIONS OF LIGHT FIXUTRES. THE ELECTRICAL CONTRACTOR SHALL BE RESPONSIBLE FOR PROVIDING, INSTALLING, AND MAINTAINING ALL SUPPORTS AND BRACING REQUIRED TO COMPLETE THE WORK.
- LIGHTING DEMOLITION WORK IS INDICATED IN THE DRAWING BELOW. IT IS THE ELECTRICAL CONTRACTOR RESPONSIBILITY OF THE CONTRACTOR TO REVIEW ALL DOCUMENTS FOR ALL DISCIPLINES FOR ANY ADDITIONAL DEMOLITION WORK.
- THE OWNER SHALL BE MAINTAINING OCCUPANCY OF THE SITE AND PORTIONS OF THE BUILDING DURING THE CONSTRUCTION PROCESS. THE GENERAL CONTRACTOR SHALL COORDINATE WITH THE OWNER AND THE OWNER'S REPRESENTATIVE THROUGHOUT THE CONSTRUCTION TO MINIMIZE ANY DISRUPTIONS IN THE OWNER'S WORKING PROCEDURES. PHASING SHALL BE DETERMINED BY THE ELECTRICAL CONTRACTOR AND SHALL NOT BE A REASON FOR ADDITIONAL FEES. THE ELECTRICAL CONTRACTOR SHALL COORDINATE WITH THE OWNER A MINIMUM OF 72 HOURS BEFORE ANY DISRUPTION OF SERVICES/UTILITIES IS REQUIRED TO COMPLETE THE WORK.
- ALL LIGHTING INDICATED TO BE REMOVED SHALL REMAIN THE PROPERTY OF THE OWNER UNLESS OTHERWISE NOTED. THE CONTRACTOR SHALL COORDINATE WITH THE OWNER OF ANY ITEMS TO BE REMOVED AND RETAINED BY THE OWNER BEFORE ANY DEMOLITION WORK IS PERFORMED. ALL ITEMS TO BE RETAINED BY THE OWNER SHALL BE REMOVED BY THE CONTRACTOR AND DELIVERED TO THE OWNER IN THE CONDITION FOUND. ALL OTHER ITEMS INDICATED TO BE REMOVED SHALL BE DISPOSED OF OFF-SITE BY THE CONTRACTOR IN A LAWFUL MANNER.

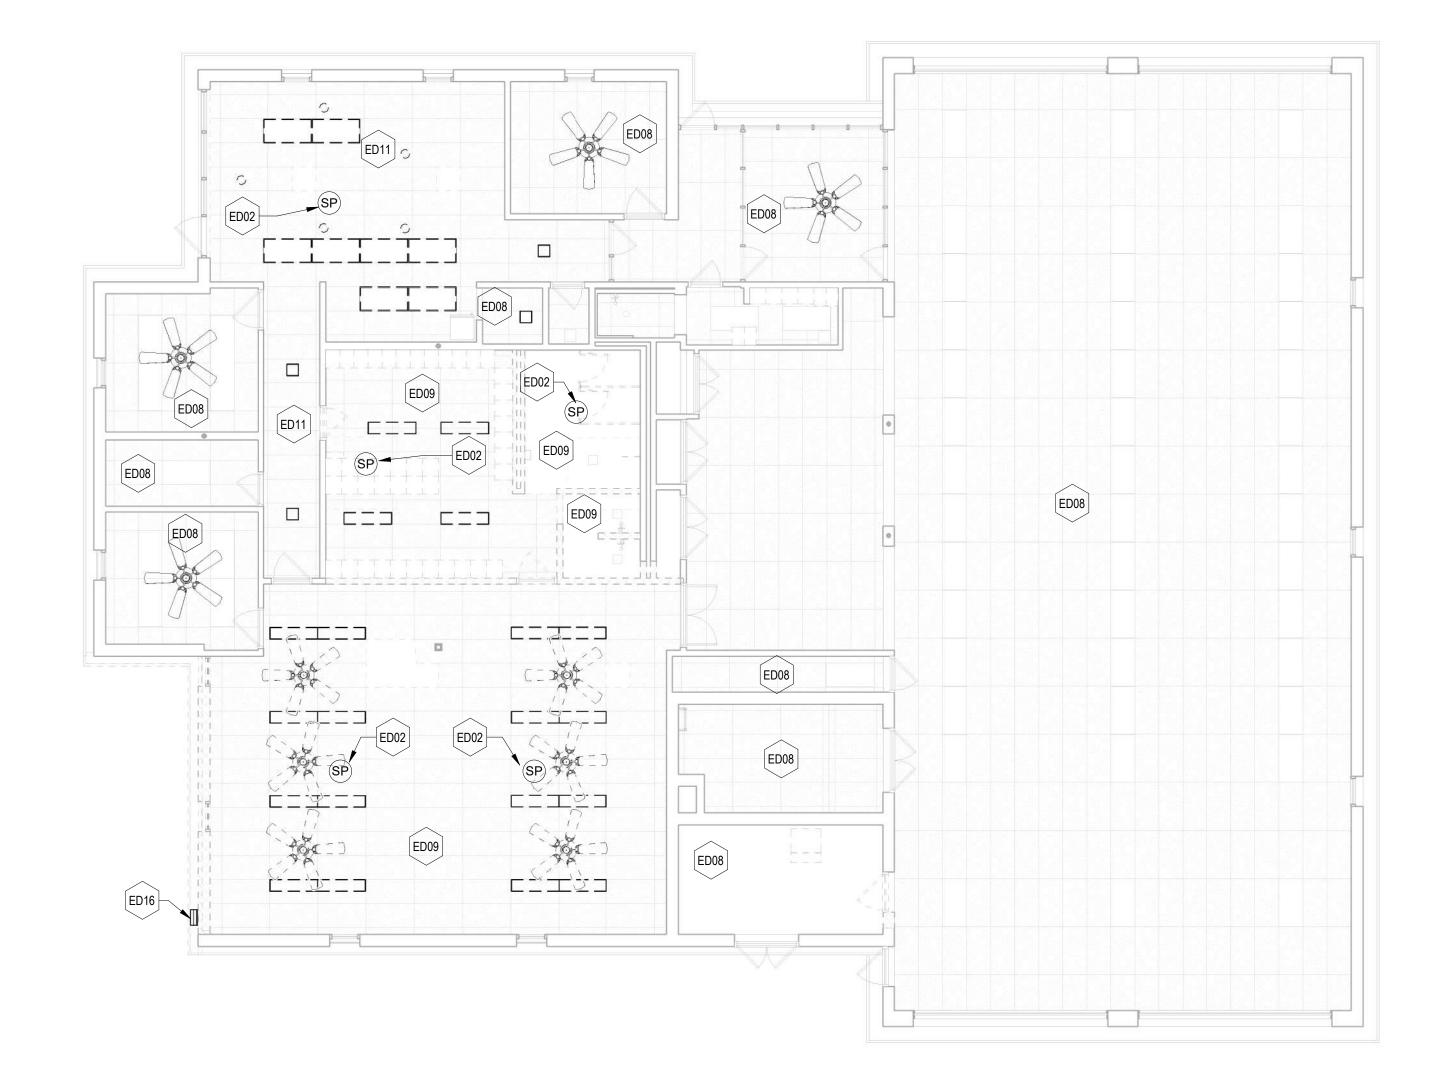

**ELECTRICAL - FIRST FLOOR PLAN - LIGHTING DEMOLITION** 

SEAL	PROFESSIONAL CERTIFICATION		AS-BUILT / REV	VISION	BY	DATE	P.W.A. NO.	KEY SHEET	POSITION SHT	DRAWIN	G SCALE	
1 (1) (1) (1) (1) (2)	I HEREBY CERTIFY THAT THESE DOCUMENTS WERE PREPARED OR APPROVED BY ME, AND THAT I AM A DULY LICENSED PROFESSIONAL ENGINEER UNDER THE LAWS OF THE STATE OF MARYLAND.  LICENSE NO. 44664 EXPIRATION DATE: 06-18-2025		BID/PERM	IT		9/20/24	-	MSW	27NE21	PLAN SCALE:	AS INDICATED	APPROVED BY: Mihai T. Petrisor
P P CHIH							R.O.W NO.	-	-		_	DIRECTOR
							-	-	-	PROFILE SCALE:		DATE: 10/03/2024
	ENGINEER: TA CHIH LIN, PE	DGN BY: CCJM	BUREAU OF ENGINEERING AND CONSTRUCTION		HIGH	WAYS	STRUCTURES	STORM DRAINS	SEWER	WATER	FIELD ENGINEER	PROPERTY MANAGEMENT
44664 44664	PRINCIPAL ELECTRICAL ENGINEER  C.C. JOHNSON & MALHOTRA, P.C.	DWN BY: CCJM	REVIEWED BY:									APPROVED BY: CHIEF
	400 EAST PRATT STREET, SUITE 604 BALTIMORE, MARYLAND 21202 (P) 410-461-9920	CHKD BY: CCJM	DATE REVIEWED:									DATE:

BALTIMORE COUNTY OFFICE OF BUDGET AND FINANCE, PROPERTY MANAGEMENT

FULLERTON FIRE STATION #8 - RENOVATION & ADDITION

LIGHTING - FIRST FLOOR PLAN - DEMOLITION

4401 FITCH AVENUE, NOTTINGHAM, MARYLAND, 21236

SUBDIVISION: FULLERTON

ELECTION DIST. NO.: 14C5

SHEET DESIGNATION CONTRACT NUMBER ED102 22221 PFO JOB ORDER NUMBER 241-220-0054-0012

SHEET 52 of 58 DRAWING NUMBER 2022-2368

FILE NO.: 20-120

ELECTRICAL DEMOLITION KEYNOTES

CABLING AND MAKE READY FOR REINSTALLATION AT NEW LOCATION.

DETERMINE WORKING CONDITIONS.

EXISTING INTERCOMMUNICATION DEVICE TO BE RELOCATED TO NEW LOCATION AS

INDICATED ON NEW WORK PLAN. CAREFULLY DISCONNECT DEVICE AND ASSOCIATED

EXISTING LIGHTING FIXTURES, INCLUDING COMBINATION LIGHT AND CEILING FANS, IN THIS AREA AND ASSOCIATED WIRING, CONDUIT, AND LIGHTING CONTROL DEVICES TO REMAIN.

CONTRACTOR TO FIELD VERIFY ALL ELECTRICAL EQUIPMENT AND EXISTING LIGHTING TO

REMOVE EXISTING LIGHTING FIXTURES IN THIS AREA AND ASSOCIATED WIRING, CONDUIT, AND LIGHTING CONTROL DEVICES BACK TO SOURCE. EXISTING COMBINATION LIGHT AND

CEILING FANS IN THE AREA TO BE CAREFULLY REMOVED, SALVAGED, AND RETURNED TO

EXISTING LIGHTING FIXTURES IN THIS AREA ARE TO BE RELOCATED. CAREFULLY REMOVE

EXISTING LIGHTING FIXTURE AND MAKE READY FOR INSTALLATION AT NEW LOCATION.

REMOVE ASSOCIATED WIRING AND CONDUIT BACK TO JUNCTION POINT. ASSOCIATED

AND REMOVE ASSOCIATED WIRING AND CONDUIT AS REQUIRED FOR FIXTURE

RELOCATION. SEE NEW WORK PLAN FOR ADDITIONAL INFORMATION.


LIGHTING CONTROL DEVICE TO REMAIN AND BE REUSED. CONTRACTOR TO COORDINATE

WITH ARCHITECTURAL DRAWING BEFORE INSTALLATION. EXISTING COMBINATION LIGHT AND CEILING FANS IN THE AREA TO BE CAREFULLY REMOVED, SALVAGED, AND RETURNED

EXISTING OUTDOOR LIGHT FIXTURE TO BE RELOCATED. CAREFULLY DISCONNECT FIXTURE

### POWER AND SYSTEMS NEW WORK GENERAL NOTES

- 1. SEE E601 FOR ADDITIONAL POWER AND SYSTEMS NEW WORK GENERAL NOTES.
- 2. THE ELECTRICAL CONTRACTOR SHALL BE RESPONSIBLE FOR VERIFYING THE INTEGRITY AND CONDITION OF THE EXISTING BRANCH CIRCUIT. WIRING IS TO BE REUSED FOR NEW EQUIPMENT CIRCUITING ACCORDING TO THE NATIONAL ELECTRIC CODE. ALL DAMAGED WIRING OR WIRING FOUND TO BE NONFUNCTIONAL SHALL BE REPLACED.
- 3. EXISTING BRANCH CIRCUITS SHALL BE EXTENDED AND CONNECTED TO ALL EXISTING RELOCATED EQUIPMENT, AS REQUIRED FOR A COMPLETE WORKING SYSTEM.
- 4. RECONNECT ALL EXISTING CIRCUITING THAT ORIGINATES OR PASSES THROUGH THE RENOVATED AREAS BUT SERVES OTHER AREAS NOT BEING RENOVATED. EXTEND THESE CIRCUITS AS MAY BE NECESSARY TO THE EXISTING DESIGNATED PANELBOARDS. UTILIZE SPARE CIRCUIT BREAKERS.
- 5. DRAWINGS ARE DIAGRAMMATIC ONLY; EXACT LOCATIONS, MOUNTING HEIGHTS OF EQUIPMENT, AND ROUTING OF RACEWAYS SHALL BE COORDINATED WITH EQUIPMENT SPECIFICATIONS AND FIELD CONDITIONS.
- 6. THE ELECTRICAL CONTRACTOR SHALL FURNISH AND INSTALL ALL INCIDENTAL ACCESSORIES NECESSARY TO MAKE ELECTRICAL WORK COMPLETE AND READY TO OPERATE.
- 7. ALL ELECTRICAL WORK SHALL BE DONE PER THE NATIONAL ELECTRICAL CODE AND LOCAL GOVERNING AUTHORITIES.
- 8. THE ELECTRICAL CONTRACTOR SHALL COORDINATE WITH THE HVAC AND PLUMBING DRAWINGS FOR THE EXACT LOCATION AND ROUGH IN DIMENSIONS; ALL EQUIPMENT SHALL MAKE ALL FINAL POWER CONNECTIONS AS REQUIRED, I.E., POWER, CONTROLS, INTERLOCKS, ETC.

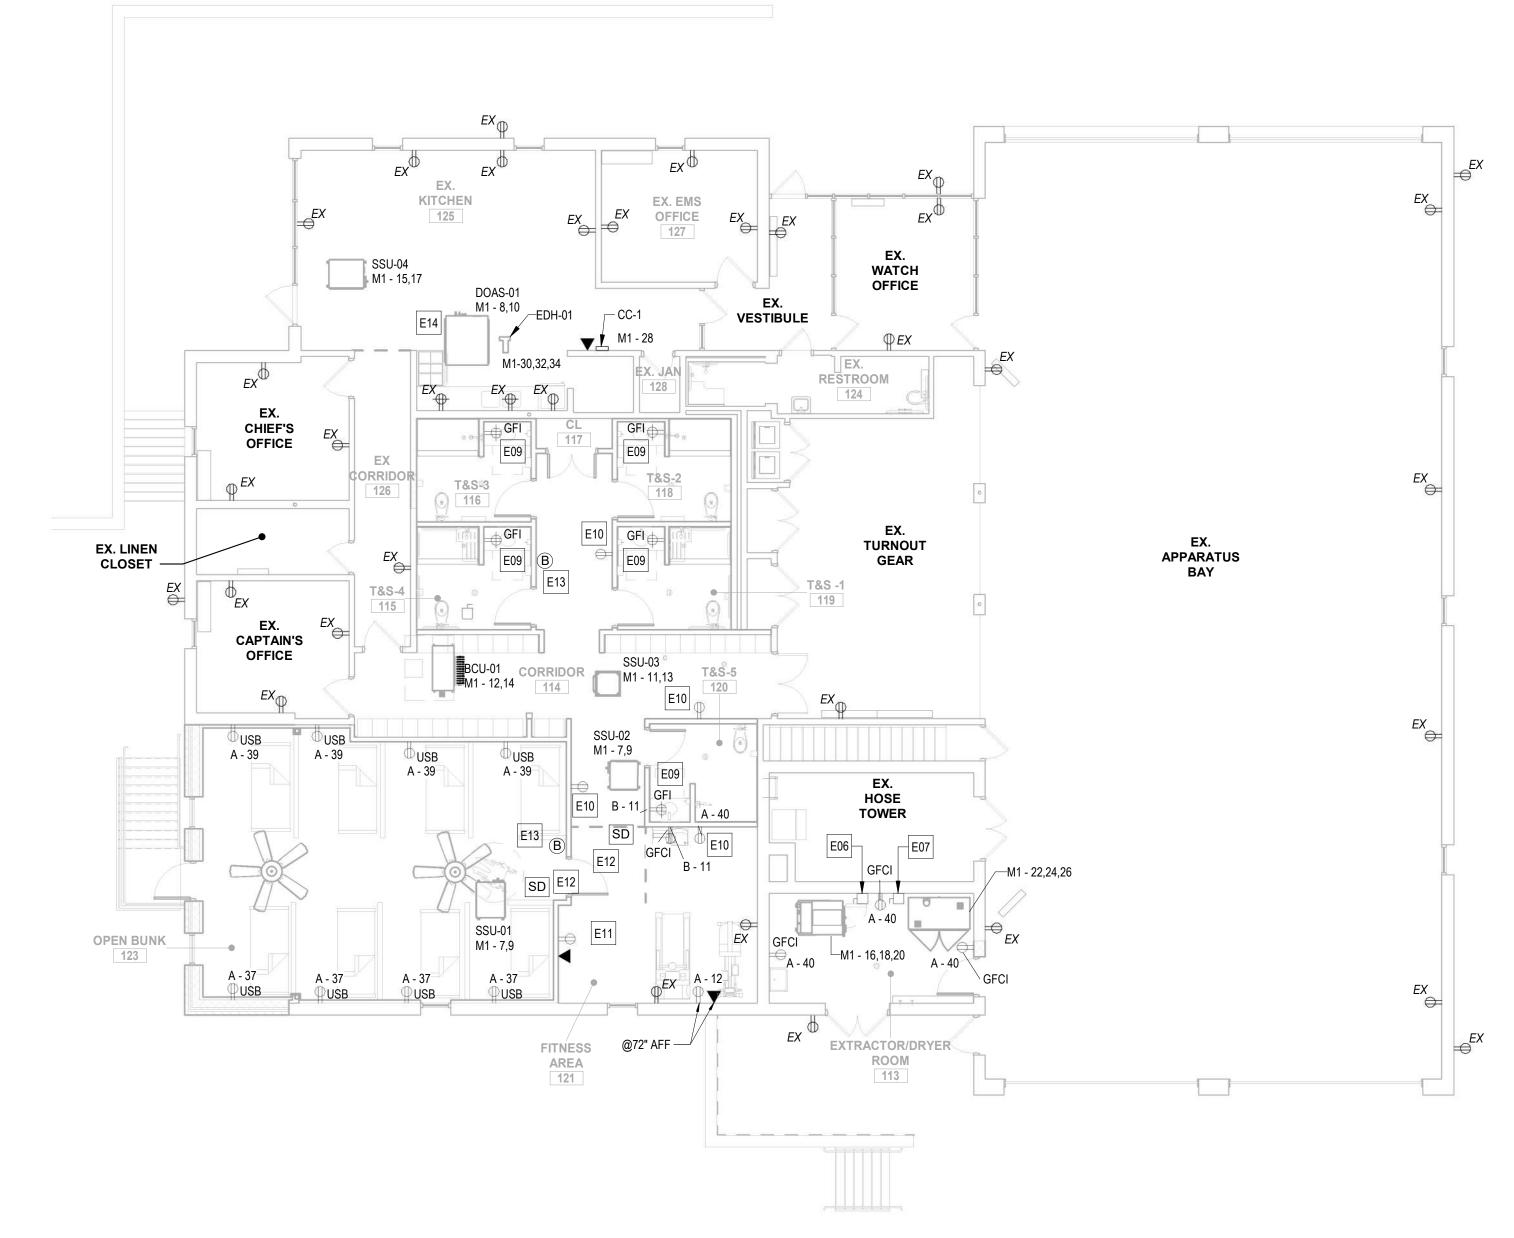

EX. SERVICE DISCONNECT

EX. UTILITY C/T CABINET

EX. PANEL MDP

EX

**MECHANICAL** 

EXISTING SERVER LOCATION: -

SUBDIVISION: FULLERTON

2 ELECTRICAL - BASEMENT FLOOR PLAN - NEW WORK

EX. PANEL E

1 ELECTRICAL - FIRST FLOOR PLAN - NEW WORK

L															
	SEAL	PROFESSIONAL CERTIFIC	CATION	AS-BUILT / REV	ISION	BY	DATE	P.W.A. NO.	KEY SHEET	POSITION SHT	DRAWIN	G SCALE			
	WILLIAM OF MARLIN	I HEREBY CERTIFY THAT THESE DOCUMENTS APPROVED BY ME, AND THAT I AM A DULY LIC		BID/PERM	ΙΤ		9/20/24	-	MSW	27NE21	PLAN SCALE:	AS INDICATED	APPROVED BY	: Mihai T. Petr	isor
	SAN CHIH IN COM	PROFESSIONAL ENGINEER UNDER THE LAWS (						R.O.W NO.	-	-			1/	2/03/2024	DIRECTO
		MARYLAND. LICENSE NO. 44664 EXPIRATION D.	ATE: 06-18-2025					-	-	-	PROFILE SCALE:	-	DATE:	7/03/2024	
	PR	ENGINEER: TA CHIH LIN, PE	DGN BY: CCJM	BUREAU OF ENGINEERING AND CONSTRUCTION		HIGH	IWAYS	STRUCTURES	STORM DRAINS	SEWER	WATER	FIELD ENGINEER	PROF	PERTY MANAGEM	1ENT
	44664 44664	PRINCIPAL ELECTRICAL ENGINEER  C.C. JOHNSON & MALHOTRA, P.C. 400 EAST PRATT STREET, SUITE 604	DWN BY: CCJM	REVIEWED BY:									APPROVED BY	:	CHIE
	DATE : 9/20/24	400 EAST FRATT STREET, SUITE 604 BALTIMORE, MARYLAND 21202 (P) 410-461-9920	CHKD BY: CCJM	DATE REVIEWED:									DATE:		CITE

BALTIMORE COUNTY OFFICE OF BUDGET AND FINANCE, PROPERTY MANAGEMENT

FULLERTON FIRE STATION #8 - RENOVATION & ADDITION

POWER AND SYSTEMS - FIRST & BASEMENT FLOOR PLANS - NEW WORK

4401 FITCH AVENUE, NOTTINGHAM, MARYLAND, 21236

4C5

SHEET DESIGNATION

E100

ELECTRICAL NEW WORK KEYNOTES

PROVIDE 2#12 + 1#12G IN 3/4"C TO AREA GFI BATHROOM RECEPTACLE CIRCUIT.

PROVIDE 2#12 + 1#12G IN 3/4"C FOR RECEPTACLES IN THIS ROOM TO AREA DORM

REINSTALL SALVAGED OR NEW INTERCOMMUNICATION SYSTEM DEVICE, FIRE BELL,

INTERCOMMUNICATION SYSTEM. PROVIDE ADDITIONAL WIRING AND RACEWAYS AS

DEMOLITION AT PANEL A-15. FIELD VERIFY CIRCUIT LOCATION AND LOAD.

COMPATIBLE WITH EXISTING SYSTEM AND RECONNECT TO EXISTING

REQUIRES FOR A COMPLETE AND FULLY OPERATIONAL SYSTEM.

ENCLOSURE, FUSED @ 15A, FOR WASHER EXTRACTOR.

DETECTOR CIRCUIT ON PANEL A WITH 2#12 +1#12G IN 3/4"C.

ENCLOSURE, FUSED @ 35A, FOR DRYER.

WORKING CLEARANCE REQUIREMENTS

CIRCUIT LOCATION AND LOAD.

PROVIDE AND INSTALL 3 PHASE, 30A, 208V, FUSIBLE DISCONNECT SWITCH IN NEMA 4X

PROVIDE AND INSTALL 3 PHASE, 60A, 208V, FUSIBLE DISCONNECT SWITCH IN NEMA 4X

RECEPTACLE CIRCUIT MADE SPARE DURING DEMOLITION AT PANEL A-17. FIELD VERIFY

COMBINATION SMOKE AND CARBON MONOXIDE DETECTOR. LOCATE DEVICE MINIMUM 3

PROVIDE 15 AMP, 208 VOLT, 2 POLE DISCONNECT AND MOUNT ON THE UNIT OR NEAR THE UNIT, WITH BRANCH CIRCUIT WIRING/RACEWAY AS INDICATED. COORDINATE LOCATION

WITH THE MECHANICAL CONTRACTOR IN THE FIELD BEFORE ROUGH-INS TO MEET ALL THE

FEET AWAY FROM ANY AND ALL CEILING FANS IN THE AREA. CONNECT TO EXISITNG SMOKE

PROVIDE 2#12 + 1#12G IN 3/4"C TO AREA DORM RECEPTACLE CIRCUIT MADE SPARE DURING

22221 PFO

JOB ORDER NUMBER

241-220-0054-0012


SHEET 53 of 58

DRAWING NUMBER

2022-2369

FILE NO.: 20-120

CONTRACT NUMBER

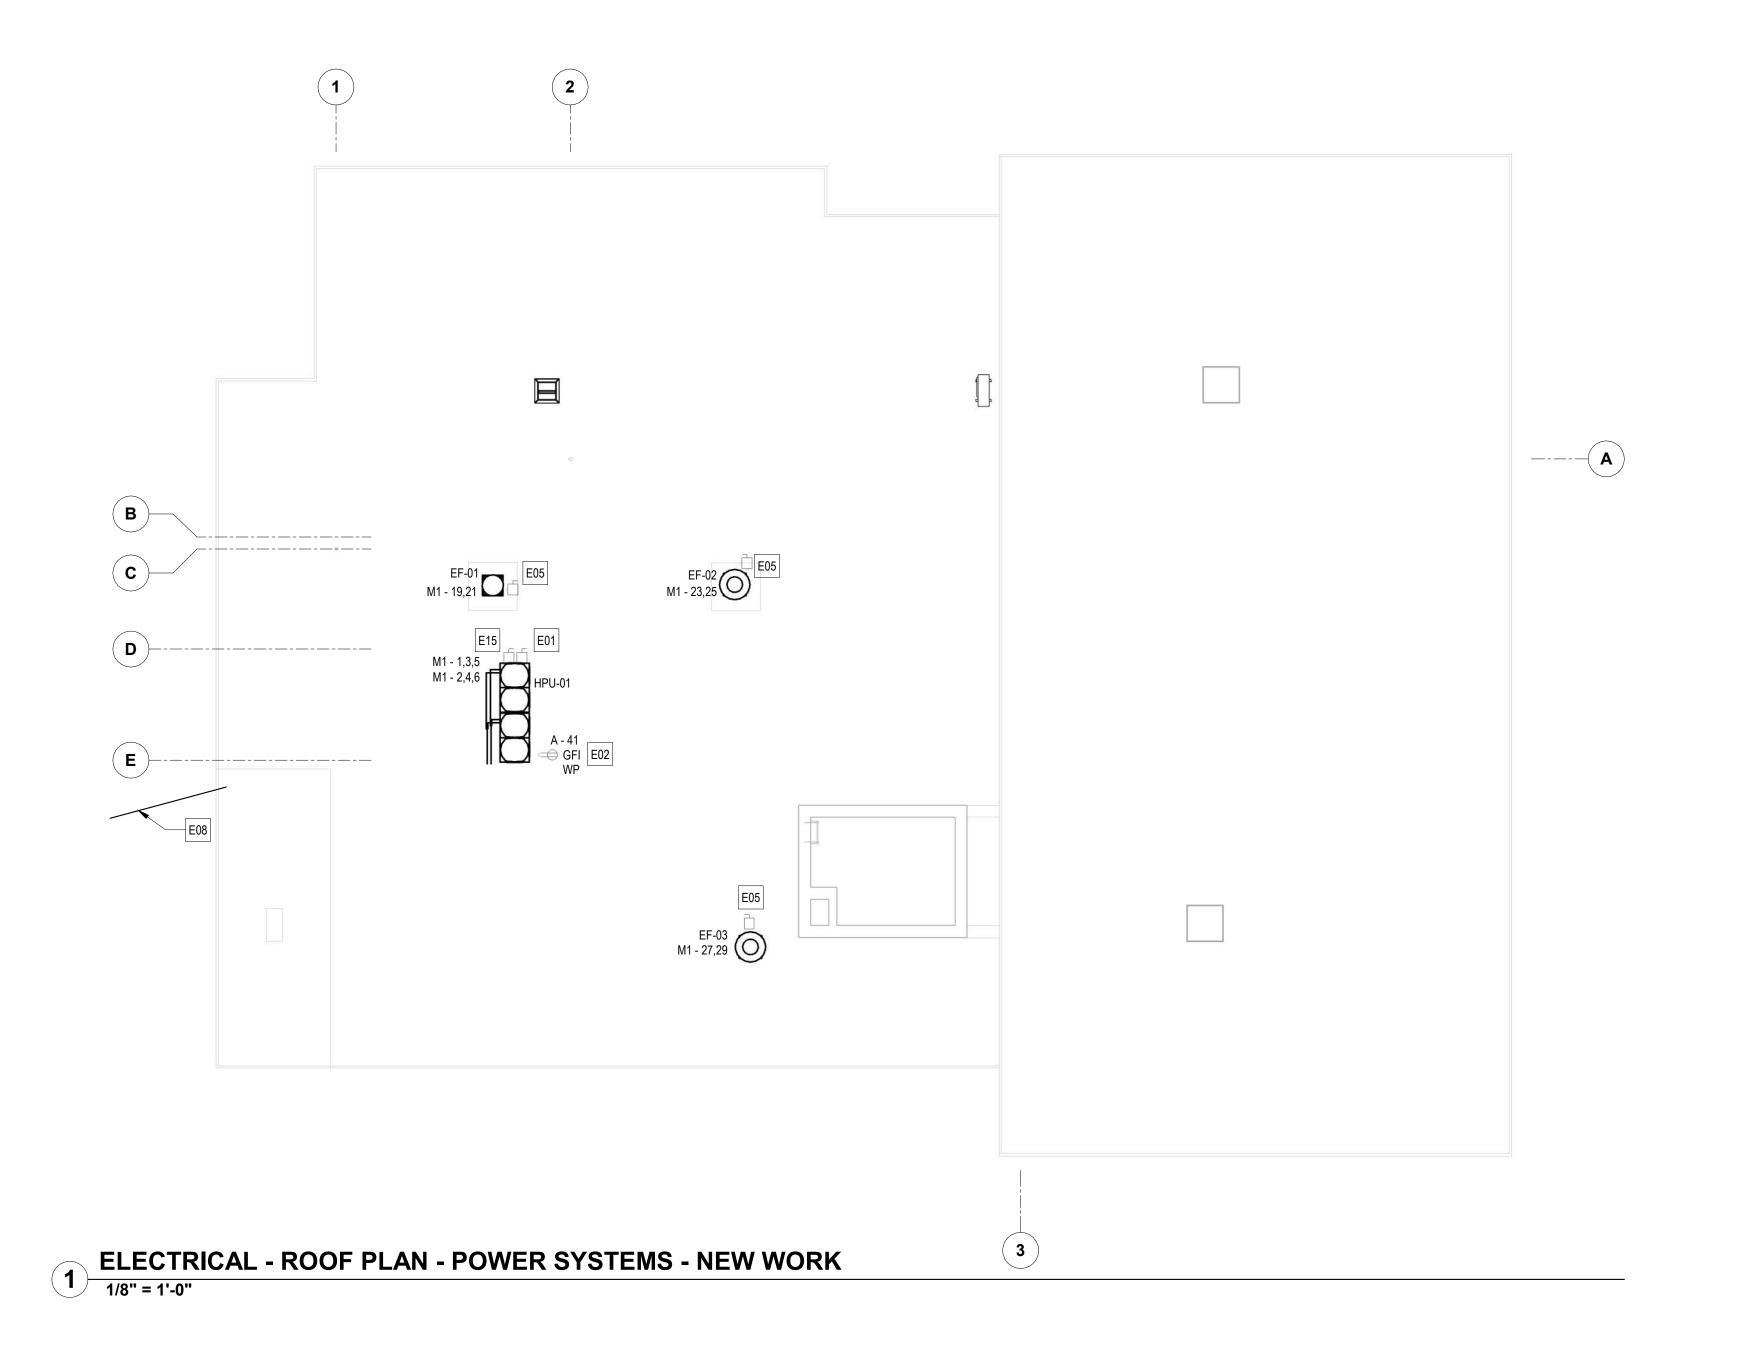

	ELECTRICAL NEW WORK KEYNOTES
E01	FURNISH AND INSTALL 3 PHASE, 100A, 208V, FUSIBLE DISCONNECT SWITCH IN NEMA 3R ENCLOSURE, FUSED AT 90A. PROVIDE INDEPENDANT SUPPORTS.
E02	PROVIDE INDEPENDENT SUPPORTS FOR ROOFTOP RECEPTACLE. PROVIDE 2#12 + 1#12G IN 3/4"C TO PANEL AS INDICATED.
E05	PROVIDE AND INSTALL 1 PHASE, 30A, 208V, NON-FUSIBLE DISCONNECT SWITCH IN NEMA 3R ENCLOSURE, FOR EXHAUST FAN.
E08	RECONNECT EXISTING CABLING TO ASSOCIATED TERMINATION POINTS. PROVIDE ADDITIONAL CONNECTORS, SPLITTERS, AND COMPATIBLE ACCESSORIES AS REQUIRED TO RESTORE CONTINUITY OF CABLING TO ASSOCIATED TERMINATION POINTS. COORDINATE EXACT ROUTING OF CABLING IN THE FIELD.
E15	FURNISH AND INSTALL 3 PHASE, 100A, 208V, FUSIBLE DISCONNECT SWITCH IN NEMA 3R

### POWER AND SYSTEMS NEW WORK GENERAL NOTES

ENCLOSURE, FUSED AT 80A. PROVIDE INDEPENDANT SUPPORTS.

- 1. SEE E601 FOR ADDITIONAL POWER AND SYSTEMS NEW WORK GENERAL NOTES.
- 2. THE ELECTRICAL CONTRACTOR SHALL BE RESPONSIBLE FOR VERIFYING THE INTEGRITY AND CONDITION OF THE EXISTING BRANCH CIRCUIT. WIRING IS TO BE REUSED FOR NEW EQUIPMENT CIRCUITING ACCORDING TO THE NATIONAL ELECTRIC CODE. ALL DAMAGED WIRING OR WIRING FOUND TO BE NONFUNCTIONAL SHALL BE REPLACED.
- 3. EXISTING BRANCH CIRCUITS SHALL BE EXTENDED AND CONNECTED TO ALL EXISTING RELOCATED EQUIPMENT, AS REQUIRED FOR A COMPLETE WORKING SYSTEM.
- 4. RECONNECT ALL EXISTING CIRCUITING THAT ORIGINATES OR PASSES THROUGH THE RENOVATED AREAS BUT SERVES OTHER AREAS NOT BEING RENOVATED. EXTEND THESE CIRCUITS AS MAY BE NECESSARY TO THE EXISTING DESIGNATED PANELBOARDS. UTILIZE SPARE CIRCUIT BREAKERS.
- 5. DRAWINGS ARE DIAGRAMMATIC ONLY; EXACT LOCATIONS, MOUNTING HEIGHTS OF EQUIPMENT, AND ROUTING OF RACEWAYS SHALL BE COORDINATED WITH EQUIPMENT SPECIFICATIONS AND FIELD CONDITIONS.
- 6. THE ELECTRICAL CONTRACTOR SHALL FURNISH AND INSTALL ALL INCIDENTAL ACCESSORIES NECESSARY TO MAKE ELECTRICAL WORK COMPLETE AND READY TO OPERATE.
- 7. ALL ELECTRICAL WORK SHALL BE DONE PER THE NATIONAL ELECTRICAL CODE AND LOCAL GOVERNING AUTHORITIES.
- THE ELECTRICAL CONTRACTOR SHALL COORDINATE WITH THE HVAC AND PLUMBING DRAWINGS FOR THE EXACT LOCATION AND ROUGH IN DIMENSIONS; ALL EQUIPMENT SHALL MAKE ALL FINAL POWER CONNECTIONS AS REQUIRED, I.E., POWER, CONTROLS, INTERLOCKS, ETC.

SUBDIVISION:	FULLE

	PROFESSIONAL CERTIFIC	CATION	AS-BUILT / REVISION	BY	DATE	P.W.A. NO.	KEY SHEET	POSITION SHT	DRAWIN	G SCALE	
,	I HEREBY CERTIFY THAT THESE DOCUMENTS V APPROVED BY ME, AND THAT I AM A DULY LICI		BID/PERMIT		9/20/24	-	MSW	27NE21	PLAN SCALE:	NONE	APPROVED BY: Mihai T. Petrisor
	PROFESSIONAL ENGINEER UNDER THE LAWS O MARYLAND.					R.O.W NO.		-		-	DIRECTOR 10/03/2024
5=	LICENSE NO. 44664 EXPIRATION DA	TE: 06-18-2025				-	-	-	PROFILE SCALE:	-	DATE: /0/03/2024
	ENGINEER: TA CHIH LIN, PE	DGN BY: CCJM	BUREAU OF ENGINEERING AND CONSTRUCTION	HIGH	HWAYS	STRUCTURES	STORM DRAINS	SEWER	WATER	FIELD ENGINEEF	PROPERTY MANAGEMENT
1111	PRINCIPAL ELECTRICAL ENGINEER  C.C. JOHNSON & MALHOTRA, P.C.  400 EAST PRATT STREET, SUITE 604	DWN BY: CCJM	REVIEWED BY:								APPROVED BY: CHIEF
~	400 EAST FRAIT STREET, SUITE 004 BALTIMORE, MARYLAND 21202 (P) 410-461-9920	CHKD BY: CCJM	DATE REVIEWED:								DATE:

BALTIMORE COUNTY OFFICE OF BUDGET AND FINANCE, PROPERTY MANAGEMENT

FULLERTON FIRE STATION #8 - RENOVATION & ADDITION

POWER AND SYSTEMS - ROOF PLAN - NEW WORK

4401 FITCH AVENUE, NOTTINGHAM, MARYLAND, 21236

SHEET DESIGNATION

E101

JOB ORDER NUMBER

241-220-0054-0012

SHEET 54 of 58

DRAWING NUMBER

SHEET 54 of 58

DRAWING NUMBER

2022-2370


FILE NO.: 20-120 REV. 10/13

CONTRACT NUMBER

22221 PFO

### LIGHTING NEW WORK GENERAL NOTES

- THE ELECTRICAL CONTRACTOR SHALL PROVIDE ALL LIGHTING FIXTURES COMPLETE WITH MOUNTING ACCESSORIES TO MEET JOB REQUIREMENTS.
- 2. THE ELECTRICAL CONTRACTOR SHALL VERIFY FIXTURE MOUNTING AND LOCATION WITH AN ARCHITECTURAL REFLECTED CEILING PLAN. CONFIRM THE EXACT LOCATION OF ALL FIXTURES WITH THE ARCHITECT BEFORE ROUGHING IN.
- REFER TO LIGHTING FIXTURE SCHEDULE ON ELECTRICAL DRAWING E601 FOR LIGHTING ELECTRICAL SPECIFICATIONS, VOLTAGE, AND LAMP REQUIREMENTS.

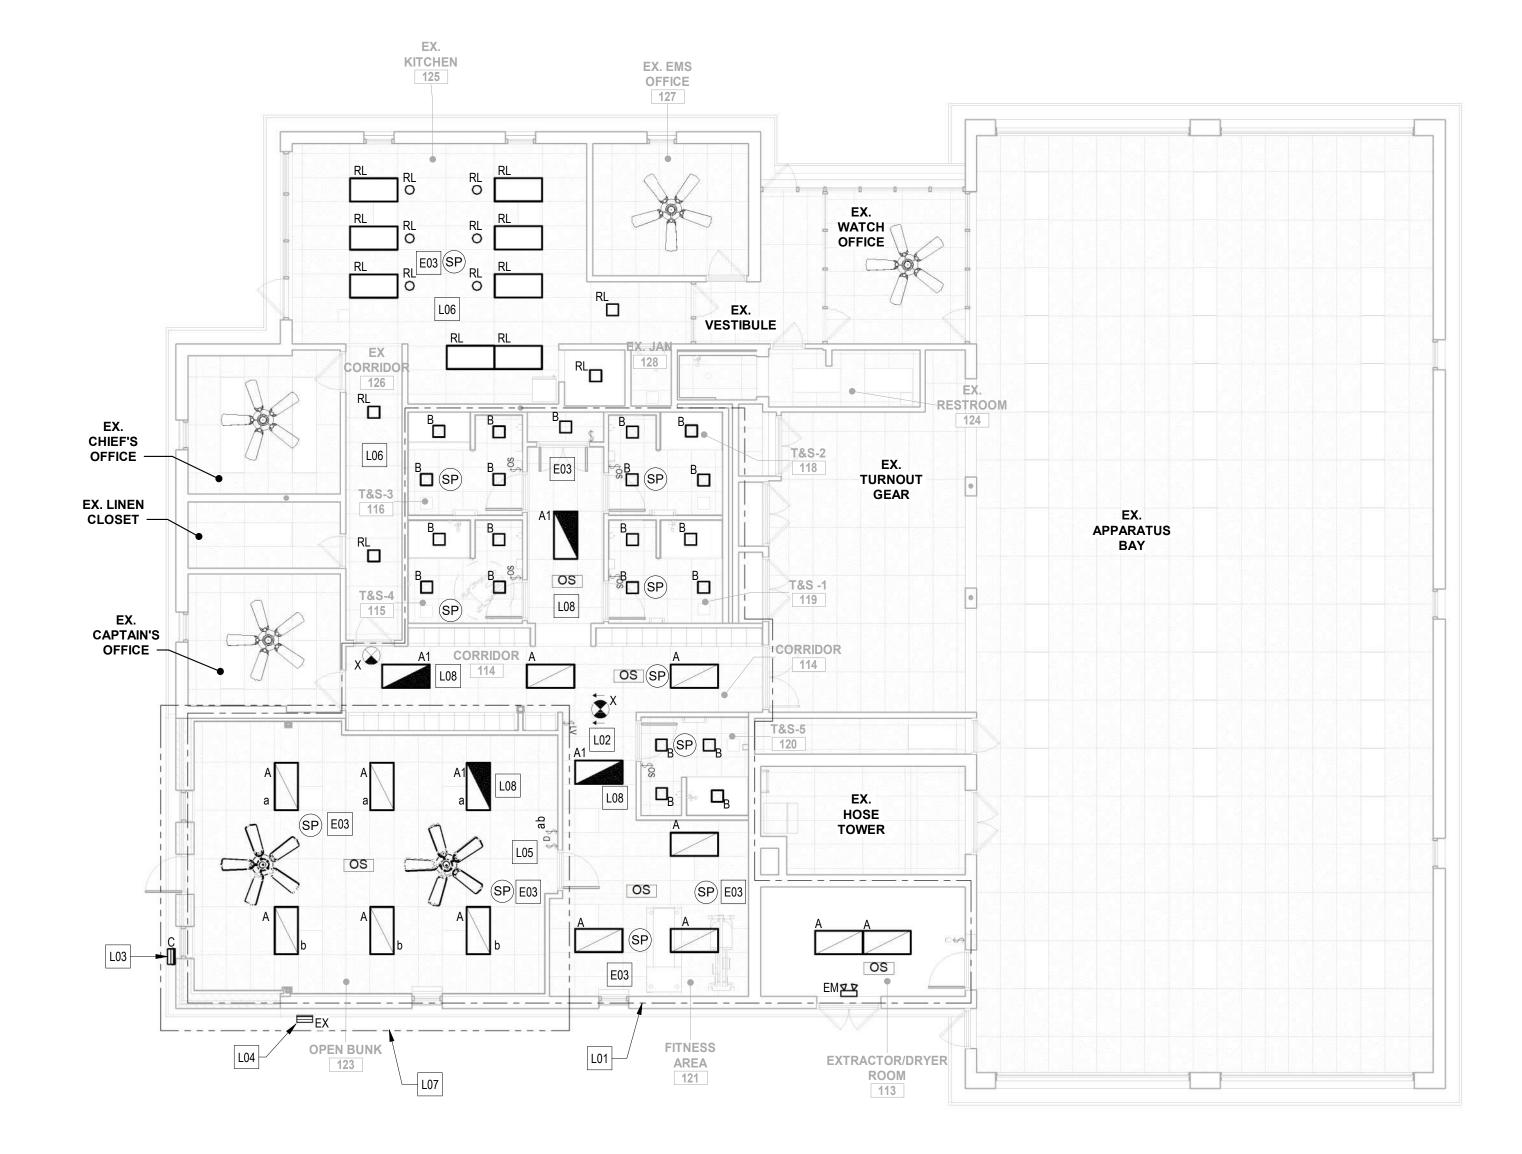

1 ELECTRICAL - FIRST FLOOR PLAN - LIGHTING NEW WORK
1/8" = 1'-0"

SEAL	PROFESSIONAL CERTIFIC	CATION	AS-BUILT / REV	ISION	BY	DATE	P.W.A. NO.	KEY SHEET	POSITION SHT	DRAWIN	IG SCALE			
	I HEREBY CERTIFY THAT THESE DOCUMENTS APPROVED BY ME, AND THAT I AM A DULY LIC		BID/PERM	ΙΤ		9/20/24	-	MSW	27NE21	PLAN SCALE:	AS INDICATED	APPROVED BY:	Mihai T. Petrisor	
CHIH IN THE	PROFESSIONAL ENGINEER UNDER THE LAWS OMARYLAND.						R.O.W NO.	-	-		-	10	DIR 103/2024	RECTOR
70	LICENSE NO. 44664 EXPIRATION DA	ATE: 06-18-2025					-	-	-	PROFILE SCALE:	-	DATE:	10312024	
PR	ENGINEER:	DGN BY: CCJM	BUREAU OF ENGINEERING AND CONSTRUCTION		HIGH	WAYS	STRUCTURES	STORM DRAINS	SEWER	WATER	FIELD ENGINEER	PROPE	RTY MANAGEMEN	Т
TINGSION ENGLIS	PRINCIPAL ELECTRICAL ENGINEER  C.C. JOHNSON & MALHOTRA, P.C. 400 EAST PRATT STREET, SUITE 604	DWN BY: CCJM	REVIEWED BY:									APPROVED BY:		CHIEF
DATE: 9/20/24	400 EAST PRATT STREET, SUITE 604 BALTIMORE, MARYLAND 21202 (P) 410-461-9920	CHKD BY: CCJM	DATE REVIEWED:									DATE:		———

### **ELECTRICAL NEW WORK KEYNOTES**

REINSTALL SALVAGED OR NEW INTERCOMMUNICATION SYSTEM DEVICE COMPATIBLE WITH EXISTING SYSTEM AND RECONNECT TO EXISTING INTERCOMMUNICATION SYSTEM.
PROVIDE ADDITIONAL WIRING AND RACEWAYS AS REQUIRES FOR A COMPLETE AND FULLY OPERATIONAL SYSTEM.

	LIGHTING NEW WORK KEYNOTES
L01	PROVIDE 2#12 + 1#12G IN 3/4"C TO EXISTING AREA LIGHTING CIRCUIT IN THIS AREA UNLESS FIXTURE IS DESIGNATED AS AN EMERGENCY OR EXIT LIGHT FIXTURE.
L02	EMERGENCY OR EXIT LIGHT FIXTURE. PROVIDE 2#12 + 1#12G IN 3/4"C TO EXISTING AREA EMERGENCY LIGHTING CIRCUIT.
L03	CONNECT NEW EXTERIOR LIGHT FIXTURE TO EXISTING 120V, EXTERIOR LIGHTING BRANCH CIRCUIT WITH 2#12 + 1#12G IN 3/4"C. ELECTRICAL CONTRACTOR SHALL VERIFY FIXTURE MOUNTING HEIGHT AND LOCATION WITH ARCHITECTURAL PLANS. EXACT LOCATION OF ALL FIXTURES SHALL BE CONFIRMED PRIOR TO BID.
L04	EXISTING EXTERIOR FIXTURE AT NEW LOCATION. SPLICE, EXTEND, AND PROVIDE WIRING AND CONDUIT TO EXISTING EXTERIOR LIGHTING CIRCUIT. WIRING AND CONDUIT TO EQUAL EXISTING BUT NOT LESS THAN WHAT IS REQUIRED BY THE NEC. LIGHTING CONTROL TO BE RESTORED TO EXISTING OPERATIONAL CONDITION AND SCHEDULE.
L05	PROVIDE 120V WALL CONTROL BY FAN SUPPLIER FOR CEILING FAN(S) INSTALLED IN THIS AREA. SEE MECHANICAL DRAWINGS FOR CEILING FAN EXACT MOUNTING LOCATIONS AND SPECIFICATIONS.
L06	REINSTALL EXISTING LIGHTING FIXTURES IN THIS AREA AT NEW LOCATIONS AT NEW CEILING AS INDICATED. PROVIDE 2#12 + 1#12G IN 3/4"C TO EXISTING AREA LIGHTING CIRCUIT. RECONNECT FIXTURES TO ASSOCIATED LIGHTING CONTROL DEVICES. LIGHTING CONTROL SCHEME TO MATCH EXISTING.
L07	PROVIDE CONTROL RELAY FOR LIGHTING FIXTURES IN THIS AREA TO CONTROL LIGHTS VIA FIREMAN'S MASTER CONTROL STATION.
L08	EMERGENCY LIGHT FIXTURE WITH UL924 GENERATOR TRANSFER DEVICE ON LOCAL AREA CONTROL. PROVIDE 2#12 + 1#12G IN 3/4"C FOR NORMAL POWER OF FIXTURE TO AREA LIGHTING CIRCUIT. PROVIDE 2#12 + 1#12G IN 3/4"C FOR EMERGENCY POWER OF FIXTURE TO UNSWITCHED AREA EMERGENCY LIGHTING CIRCUIT. UPON NORMAL POWER LOSS, EMERGENCY LIGHTING FIXTURE TO BE POWERED TO FULL ILLUMINATION.

SHEET DESIGNATION CONTRACT NUMBER E102 22221 PFO

BALTIMORE COUNTY OFFICE OF BUDGET AND FINANCE, PROPERTY MANAGEMENT

LIGHTING - FIRST FLOOR PLAN - NEW WORK


SUBDIVISION: FULLERTON

FULLERTON FIRE STATION #8 - RENOVATION & ADDITION

4401 FITCH AVENUE, NOTTINGHAM, MARYLAND, 21236

JOB ORDER NUMBER 241-220-0054-0012

SHEET 55 of 58 DRAWING NUMBER 2022-2371 FILE NO.: 20-120

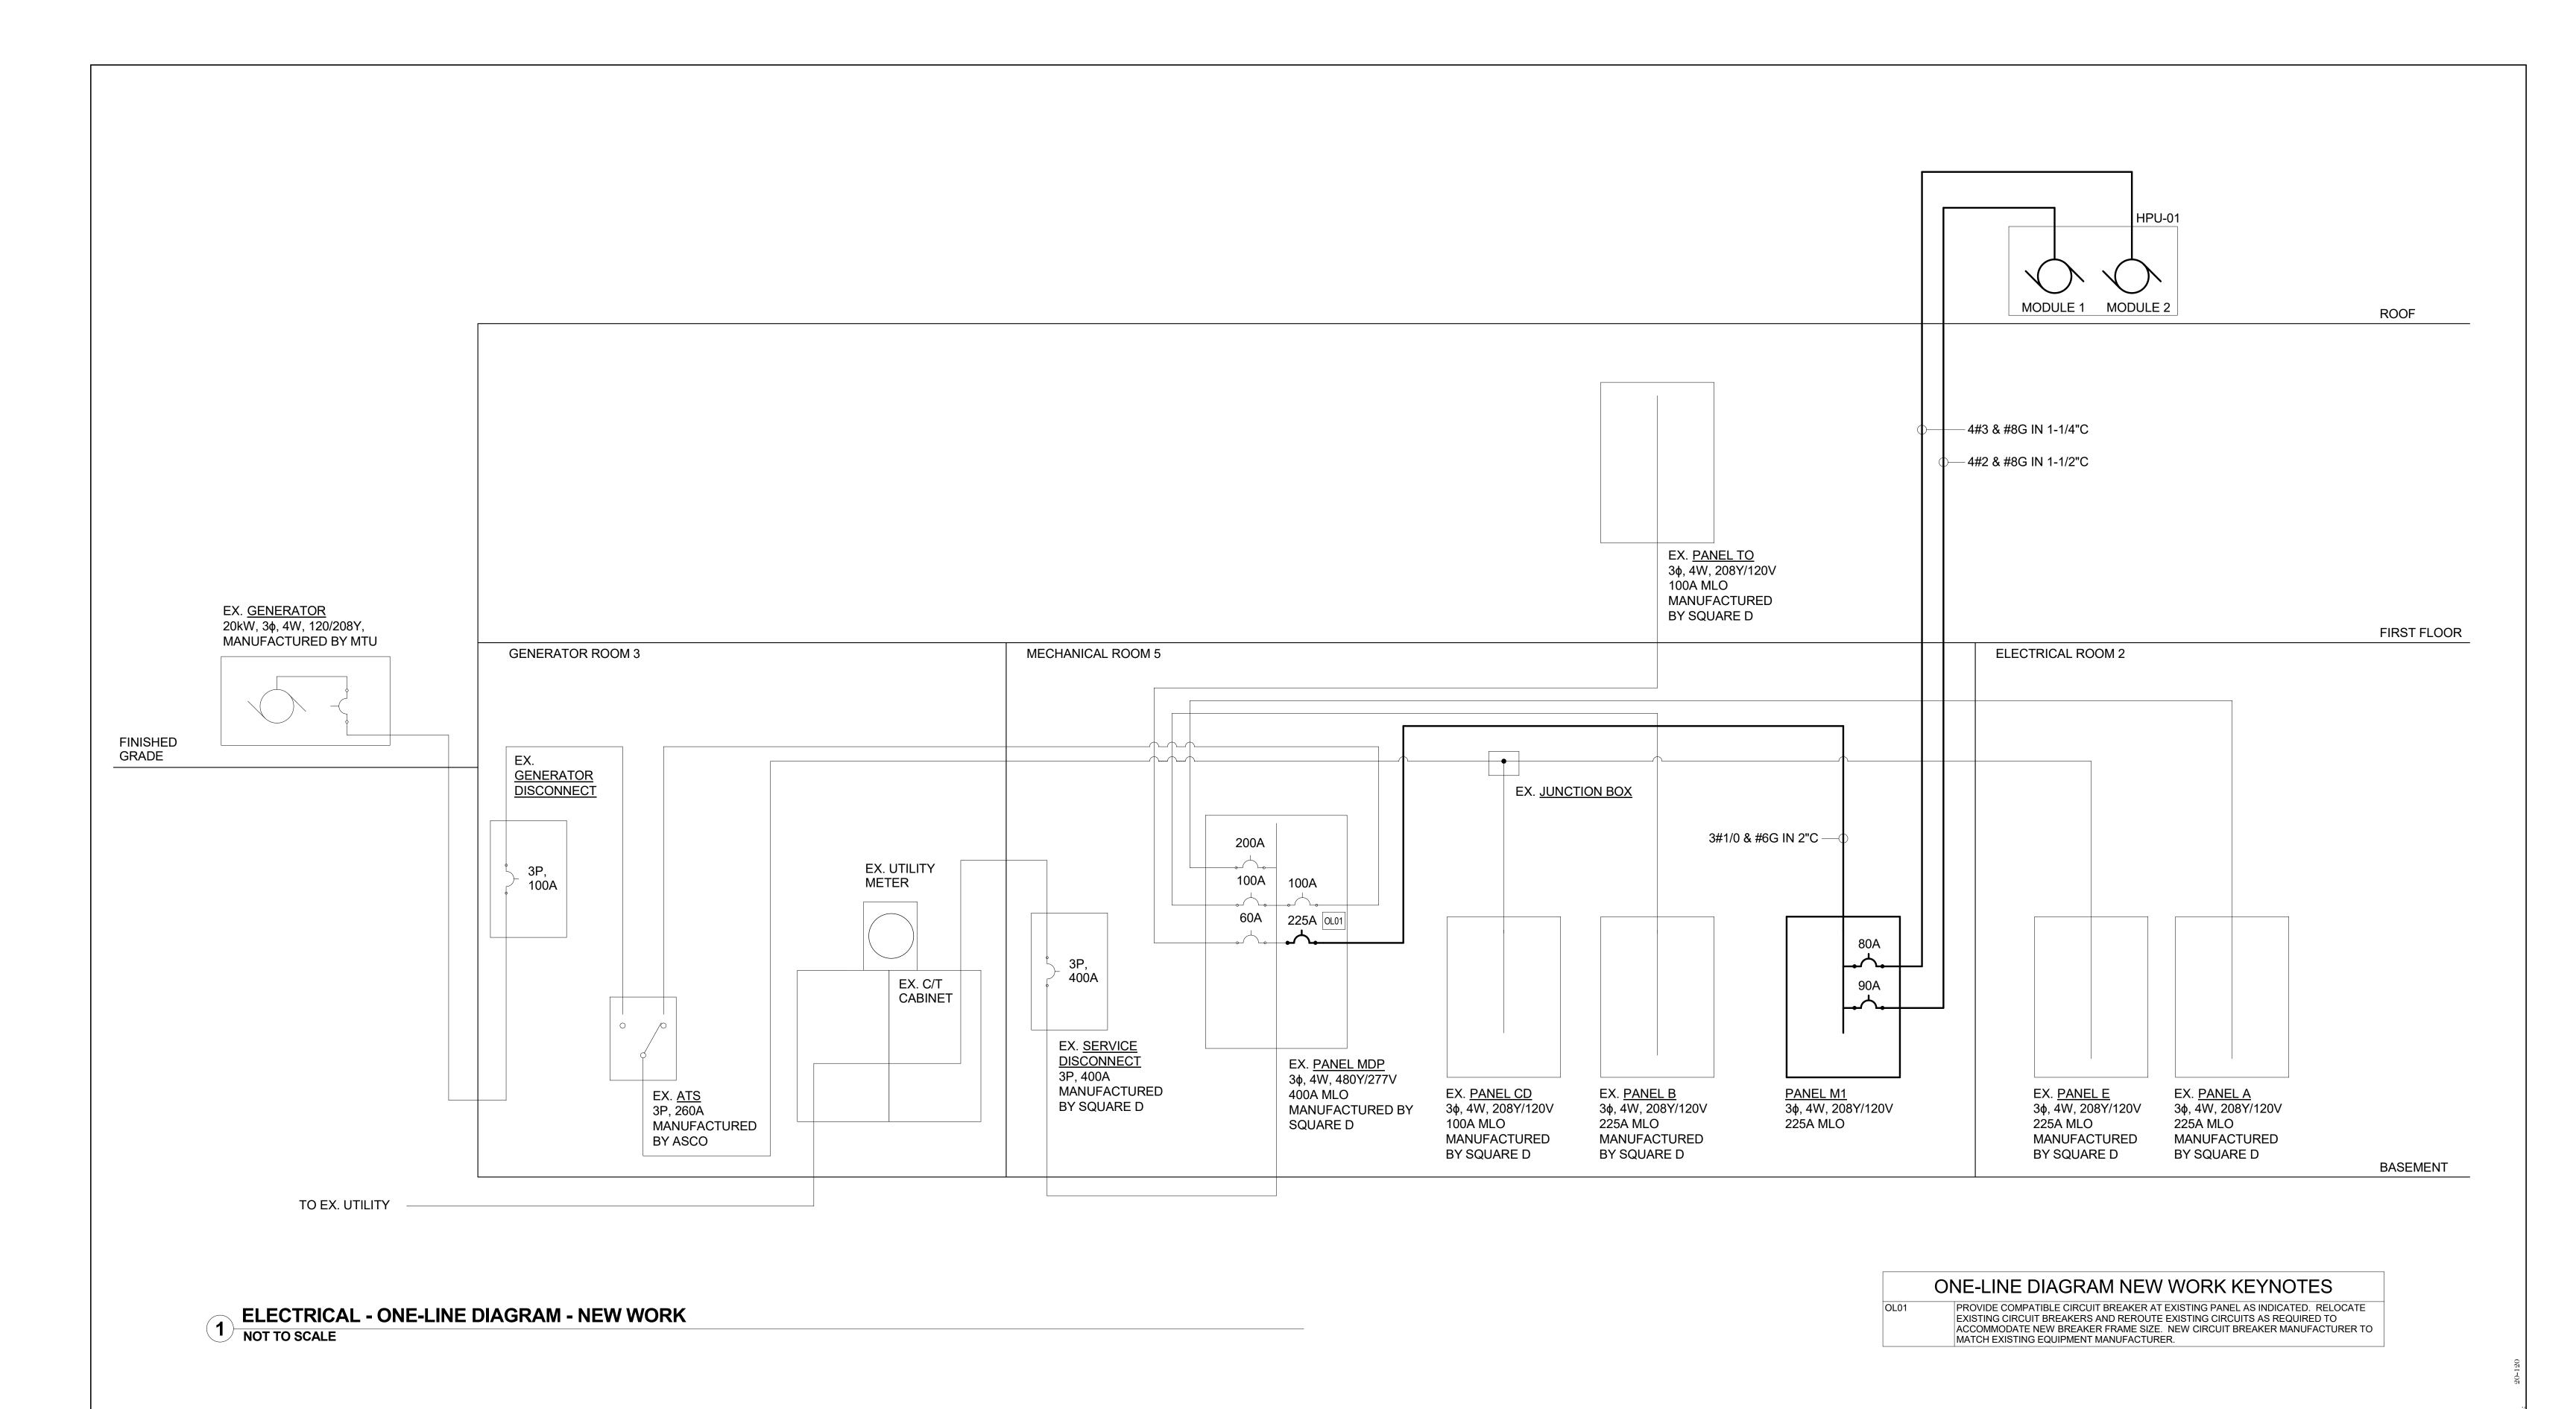

AS-BUILT / REVISION BY DATE P.W.A. NO. KEY SHEET POSITION SHT DRAWING SCALE PROFESSIONAL CERTIFICATION BID/PERMIT I HEREBY CERTIFY THAT THESE DOCUMENTS WERE PREPARED OR APPROVED BY: Mihai T. Petrisor PLAN SCALE: APPROVED BY ME, AND THAT I AM A DULY LICENSED PROFESSIONAL ENGINEER UNDER THE LAWS OF THE STATE OF R.O.W NO. 10/03/2024 MARYLAND. LICENSE NO. 44664 EXPIRATION DATE: 06-18-2025 BUREAU OF ENGINEERING AND CONSTRUCTION ENGINEER: \_\_\_\_\_ HIGHWAYS STRUCTURES STORM DRAINS PROPERTY MANAGEMENT SEWER WATER 'A CHIH LIN, PE REVIEWED BY: APPROVED BY: C.C. JOHNSON & MALHOTRA, P.C. 00 EAST PRATT STREET, SUITE 604 ALTIMORE, MARYLAND 21202 DATE REVIEWED:

FULLERTON FIRE STATION #8 - RENOVATION & ADDITION

BALTIMORE COUNTY OFFICE OF BUDGET AND FINANCE, PROPERTY MANAGEMENT

ELECTRICAL RISER DIAGRAM

4401 FITCH AVENUE, NOTTINGHAM, MARYLAND, 21236

ELECTION DIST. NO.: 14C5

22221 PFO

JOB ORDER NUMBER

241-220-0054-0012

SHEET 56 of 58

DRAWING NUMBER

CONTRACT NUMBER

SHEET DESIGNATION

E501

DRAWING NUMBER
2022-2372

FILE NO.: 20-120

REV. 10/13

Ex. Branch Panel: A  Location: ELE Supply From: Mounting: Surfa Enclosure: Type	CTRICAL RM 2		Volts: 120/208 Wye Phases: 3 Wires: 4		A.I.C. Rating: 10 Mains Type: ML0 Mains Rating: 225 MCB Rating: N/A	O A A		Panel: B  Location: MECHANICA  upply From:  Mounting: Surface  Enclosure: Type 1	AL RM 5	F	Volts: 120/208 Wy Phases: 3 Wires: 4	/ye	A.I.C. Rati Mains Ty Mains Rati MCB Rati	ing: 100 A		Supp N	anel: E  Location: ELECTRIC ply From: Mounting: Surface nclosure: Type 1	CAL RM 2	Ph	Volts: 120/208 Wye nases: 3 Nires: 4		A.I.C. Rating: 10 k Mains Type: MLC Mains Rating: 225 MCB Rating: N/A	A
<b>otes:</b> UPPLIED FROM 3P, 200A BREAKER AT PANEL I	MDP						Notes: SUPPLIED FROM 3P, 100A BREA	AKER AT PANEL MDP								Notes: PANEL BACKED UP BY EXISTING 3	30KW GENERATOR.	SUPPLIED FROM 3P, 10	00A CIRCUIT BREAKEF	R AT PANEL MDP. BF	REAKER IS SHARED WITH EX	ISTING PANEL CD.	
CKT Circuit Description Wire Siz	Condui te t Size Trip Po	alaa A	D. D.	C Boloo Tvi	Condui p t Size Wire Size	Circuit Description CK	CKT Circuit Description	Wire Size	Condui t Size Trip Poles		В	C Pales	Condui rip t Size Wi	ire Size Circuit Des	scription CKT	CKT Circuit Description	Wire Size	Condui t Size Trip Poles		<b>D</b>	C Poles Trip t	ondui Size Wire Size	Circuit Description
DORM CEILING	20 A	1 0 VA 0 VA	В	1 20	A	BATHROOM LIGHTING 2	1 BASMENT UNIT HEATER		20 A 1	0 VA 0 VA	В	Toles 1	0.4	BATHROOM GF	FI 2	1 DORM LIGHTS		20 A 1	0 VA 0 VA	D	1 20 A	Size Wife Size	LOCKER ROOM LIGHTS
FIRE WATCH RECEPTACLE LOCKER RECEPTACLE		1	0 VA 0 VA 0 VA	0 VA 1 20		TOWER LIGHTING 4 FIRE WATCH LIGHT 6	3 EQUIP. AREA UNIT 5 SPARE		20 A 1 20 A 1		0 VA 0 VA			BATHROOM HE EXHAUST FAN		3 REC ROOM 5 CAPTIAN ROOM LIGHTS		20 A 1 20 A 1		0 VA 0 VA 0 VA	1 20 A A O VA 1 20 A		HALLWAY EMER. LIGHT
REC ROOM RECETACLE	20 A			1 20	A	MICROWAVE 8	7 EQUIP. AREA UNIT		20 A 1	0 VA 0 VA		1	0 A	BOILER RM CIR		7 DRIVEWAY LIGHTS		20 A 1	0 VA 0 VA		1 20 A		DRIVER LIGHTS
HEATER			0 VA 0 VA 0 VA	1 20 180 VA 1 20		ICE MAKER	9 EXISTING LOAD 11 RECEPTACLES 105, 106	 1-#12, 1-#12, 1-#12	20 A 1 3/4" 20 A 1		0 VA 0 VA 38	•		SPARE RECEPTACLES	S 10	9 CANOPY LIGHTS 11 RELAY CABINET (LOW		20 A 1 20 A 1		0 VA 0 VA 0 VA	1 20 A A 0 VA 1 20 A		CANOPY LIGHTS LIGHTS
3 UNIT HEATER #1		1 0 VA 0 VA		1 20	A	HALLWAY LIGHTS 14	13 SPARE		20 A 1	0 VA 0 VA			0 A	BOILER ROOM		13 EMERGENCY		20 A 1	0 VA 0 VA		1 20 A		CHIEF ROOM LIGHTS
5 DORM RECEPTACLE 7 DORM RECEPTACLE		1	0 VA 0 VA 0 VA	0 VA 1 20		DRIVER'S ROOM LIGHTS 16 DRIVEWAY LIGHTS 18	15 SPARE 17 EXISTING LOAD		20 A 1 20 A 1		0 VA 0 VA	0 VA 0 VA 1		RECETACLES BOILER ROOM	16 18	15 TURRET 17 EXIT LIGHT		20 A 1 20 A 1		0 VA 0 VA 0 VA	2 20 A A 0 VA		FIRE WATCH
9 DORM RECEPTACLE	20 A	1 0 VA 0 VA		1 20	A	CHIEF'S ROOM LIGHTS 20	19 SPARE		20 A 1	0 VA 0 VA		1		EXHAUST FAN	1 20	19 TELEPHONE RECETPACLE		20 A 1	0 VA 0 VA		1 20 A		ELECTRIC HEATING UN
1 SHOP RECEPTACLE(S) 3 EQUIP. RECEPTACLE		1	0 VA 0 VA 0 VA	0 VA 1 20		CAPTAIN ROOM LIGHTS 22 LIGHTS 24	21 SPARE 23 SPARE		20 A 1		0 VA 0 VA	•		RECEPTACLES EXHAUST FAN		21 RACK RECEPTACLE 23 SUB PANEL BOILER		20 A 1 20 A 2		0 VA 0 VA 0 VA	3 40 A A 0 VA		AIR COMPRESSOR
5 UNIT HEATER #2		1 0 VA 0 VA		1 20	A	DORM LIGHTS 26	25 HEATING UNIT		20 A 1	0 VA 0 VA				SPACE	26	25							
7 SMOKE DETECTOR 9 KITCHEN HOOD FAN	20.1	1	0 VA 0 VA 0 VA	0 VA 1 20		LIGHTS 28 DRIVEWAY LIGHTS 30	27 HEATING UNIT 29		20 A 2		0 VA 0 VA			SPACE HEATING UNIT	T 30	27 MOTORIZED DOOR 29		40 A 2		0 VA 0 VA 0 VA	1 20 A A 0 VA 1 20 A		MODEM HPDNET MAIN TOILET OVERHEA
REFRIGERATOR	20 A	1 0 VA 0 VA		1 20	A	REC ROOM LIGHTS 32	31 FLOOD LIGHTS		20 A 2	0 VA 0 VA					32	31 UNKNOWN CIRCUIT		20 A 3	0 VA 0 VA		3 20 A		UNKNOWN CIRCUIT
KITCHEN RECEPTACLE(S) WATER COOLER	20 A	1	0 VA 0 VA 0 VA	0 VA 1 20	· •	CAPTAIN ROOM 34 RECEPTACLE(S) 36	33 35 SPACE				0 VA 0 VA	0 VA 0 VA	*	EXISTING LOAD	34 36	33				0 VA 0 VA 0 VA	A 0 VA		
RECEP. OPEN BUNK 123 1-#12, 1-#12,	1-#12 3/4" 20 A	1 720 VA 370 VA		1 20	A 3/4" 1-#12, 1-#12, 1-	#12 EWC-1 EXERCISE 106 38	37 SPACE					3	0 A	EXISTING LOAD		37 UNKNOWN CIRCUIT		20 A 3	0 VA 0 VA		3 20 A		UNKNOWN CIRCUIT
9 RECEP. OPEN BUNK 123 1-#12,	1-#12 3/4" 20 A 1-#12 3/4" 20 A	1	720 VA 720 VA 180 VA		A 3/4" 1-#12, 1-#12, 1- 	#12 RECEPTACLES 106, 105 40 SPACE 42	39 SPARE 41		20 A 2		0 VA 0 VA	0 VA 0 VA		 	40	39				0 VA 0 VA 0 V	A 0 VA		
	Total Lo			0 VA					Total Load	0 VA	0 VA	380 VA			1			Total Load:			0 VA		
egend:	Total An	nps: 10 A	13 A	3 A			Legend:		Total Amps	0 A	0 A	3 A				Legend:		Total Amps:	0 A	0 A	0 A		
pad Classification	Connect	ted Load De	emand Factor Esti	mated Demand	P	anel Totals	Load Classification		Connected	Load Dem	and Factor	Estimated Demand		Panel Totals		Load Classification		Connected	Load Dema	nd Factor E	stimated Demand	Pa	nel Totals
AC		VA	0.00%	0 VA			HVAC		0 VA		0.00%	0 VA				HVAC		0 VA		.00%	0 VA		
nting ver		VA VA	0.00%	0 VA 0 VA	Total Conn. L Total Est. Dem		Lighting Power		0 VA 0 VA		0.00%	0 VA 0 VA		Conn. Load: 380 VA		Lighting Power		0 VA 0 VA		.00%	0 VA 0 VA	Total Conn. Lo	
ceptacle	-			2520 VA	Total Co		Receptacle		380 VA		00.00%	380 VA		Total Conn.: 1 A		Receptacle		0 VA		.00%	0 VA	Total Co	
					Total Est. Dem	and: 8 A							Total E	st. Demand: 1 A								Total Est. Dema	
tes: ADS BASED ON FIELD SURVEY OF PANEL SC	HEDULE AND ARE PROVID	DED FOR INFORMATION	NAL PURPOSES. FIELD V	ERIFY AND CONFIRM	EXISTING LOADS PRIOR TO	COMMENCING WORK.	Notes: LOADS BASED ON FIELD SURV	EY OF PANEL SCHEDULE	E AND ARE PROVIDED	FOR INFORMATION	AL PURPOSES. FIE	ELD VERIFY AND CONFI	M EXISTING LOADS P	RIOR TO COMMENCING WOR	RK.	Notes: LOADS BASED ON FIELD SURVEY	OF PANEL SCHEDU	JLE AND ARE PROVIDED	FOR INFORMATIONA	L PURPOSES. FIELD	VERIFY AND CONFIRM EXIS	TING LOADS PRIOR TO	COMMENCING WORK.
Panelboard M	DP						Branch	Panel: M1															
	CHANICAL RM 5		<b>Volts:</b> 120/208 Wye		A.I.C. Rating:			Location: MECHANICA			Volts: 120/208 Wy	/ye		ing: 22KAIC									
Supply From:	face		Phases: 3 Wires: 4		Mains Type: ML		S	upply From: PANEL MDP	1		Phases: 3 Wires: 4			rpe: MLO									
<b>Mounting:</b> Sur <b>Enclosure:</b> Indo			¥1163. 4		Mains Rating: 400 MCB Rating: 400			Mounting: Surface Enclosure: Type 1			VVII CO. 4		Mains Rati MCB Rati										
es: A SERVICE DISCONNECT					Š		Notes:							<b>.</b>									
CKT Circ	uit Description		# of Poles Fram	ne Size   Trip Rat	ing Load Re	marks	CKT Circuit Description		Condui t Size Trip Poles		В	C Poles	Condui	re Size Circuit Des	scription CKT								
1 PANEL A	-		3	200 A	2890 VA DO	OUBLE WIDTH BREAKER	1 HPU-01 (MODULE 1)		1-1/2" 90 A 3	6845 VA 6365	_	3	• 1	1-#3, 1-#8 HPU-01 (MODU									
2 PANEL B	-e			100 A			_ 3 5				6845 VA 6365 VA	6845 6365 VA			4								
<ul><li>3 PANEL E &amp; PANEL CD VIA AT</li><li>4 GAS RANGE</li></ul>	<b>ა</b>		3	100 A			7 SSU - 01, 02	2-#14, 1-#14, 1-#14		330 \/\Delta 3/3 \/\Delta	0			 1-#14, 1-#14 DOAS - 01	8								

CKT	Circuit Description	# of Poles	Frame Size	Trip Rating	Load	Remarks
1	PANEL A	3		200 A	2890 VA	DOUBLE WIDTH BREAKER
2	PANEL B	3		100 A	380 VA	
3	PANEL E & PANEL CD VIA ATS	3		100 A	0 VA	
4	GAS RANGE	3		20 A	0 VA	
5	TOWER FAN	3		60 A	0 VA	
6	PANEL TO (TURNOUT)	3		60 A	0 VA	
7	AC-2 (DORM)	3		60 A	0 VA	
8	AC-1 (KITCHEN)	3		30 A	0 VA	
9	SPARE	3		30 A	0 VA	
10	PANEL M1	3		225 A	60213 VA	
11						
12						
13						
14						
			Tot	al Conn. Load:	63483 VA	
				Total Amps:	176 A	

Load Classification	Connected Load	Demand Factor	Estimated Demand	Panel	Totals
Equipment	0 VA	0.00%	0 VA		
HVAC	0 VA	0.00%	0 VA	Total Conn. Load:	63483 VA
Lighting	0 VA	0.00%	0 VA	Total Est. Demand:	63483 VA
Other	0 VA	0.00%	0 VA	Total Conn.:	176 A
Power	0 VA	0.00%	0 VA	Total Est. Demand:	176 A
Receptacle	0 VA	0.00%	0 VA		

EXISTING LOADS BASED ON FIELD SURVEY OF PANEL SCHEDULE AND ARE PROVIDED FOR INFORMATIONAL PURPOSES. FIELD VERIFY AND CONFIRM EXISTING LOADS PRIOR TO COMMENCING WORK.

CKT	Circuit Description	Wire Size	Condui t Size	Trip	Poles	A	1		В		С	Poles	Trip	Condui t Size	Wire Size	Circuit Description	С
	HPU-01 (MODULE 1)	3-#2, 1-#2, 1-#8	1-1/2"	90 A	3	6845 VA						3	80 A	1-1/4"	3-#3, 1-#3, 1-#8	HPU-01 (MODULE 2)	
3								6845 VA	6365 VA								
5		-								6845	6365 VA						
7	SSU - 01, 02	2-#14, 1-#14, 1-#14	3/4"	15 A	2	339 VA	343 VA					2	15 A	3/4"	2-#14, 1-#14, 1-#14	DOAS - 01	
9		-						339 VA	343 VA								
11	SSU - 03	2-#14, 1-#14, 1-#14	3/4"	15 A	2					75 VA	86 VA	2	15 A	3/4"	2-#14, 1-#14, 1-#14	BCU-01	
13						75 VA	86 VA										
15	SSU - 04	2-#14, 1-#14, 1-#14	3/4"	15 A	2			219 VA	841 VA			3	15 A	3/4"	3-#14, 1-#14, 1-#14	WASHER EXTRACTOR	
17	-	-								219 VA	841 VA						
19	EF-01	2-#12, 1-#12, 1-#12	3/4"	20 A	2	93 VA	841 VA										
21	-	-						93 VA	2402 VA			3	35 A	1/2"	3-#8, 1-#8, 1-#10	DRYER	
23	EF-02	2-#12, 1-#12, 1-#12	3/4"	20 A	2					186 VA	2402 VA						
25	-					186 VA	2402										
27	EF-03	2-#12, 1-#12, 1-#12	3/4"C	20 A	2			186 VA	500 VA			1	20 A	3/4"	1-#12, 1-#12, 1-#12	CC-1	
29					-					186 VA	2600 VA	3	20 A	3/4"	3-#10, 1-#10, 1-#10	EDH-01	
	SPARE			20 A	1	0 VA	2600										
	SPARE			20 A	1			0 VA	2600 VA								
	SPARE			20 A	1					0 VA	0 VA	1	20 A			SPARE	
	SPACE					0 VA	0 VA					1	20 A			SPARE	
	SPACE							0 VA	0 VA							SPACE	
41	SPACE									0 VA	0 VA					SPACE	
				Total	Load:	2017	5 VA	2073	33 VA	1980	05 VA						
				Total	Amps:	169	9 A	17	3 A	16	55 A	•					
egeno	d: Classification			Conn	ected L	oad	De	mand Fac	etor	Fstir	nated Der	nand			Panel	Totals	
VAC	, adding a light a lig				0 VA	Jour		0.00%	, , , , , , , , , , , , , , , , , , ,	Lottii	0 VA	- Iuiiu			T uno	Totalo	
	<u> </u>				0 VA			0.00%			0 VA				Total Conn. Load:	60213 \/A	
ghting	}																
ower					728 VA			100.00%			9728 VA		Total Est. Demand:				
ecept	acle				0 VA			0.00%			0 VA				Total Conn.:		
															Total Est. Demand:	167 A	

SUBDIVISION: FULLERTON

SEA	L	PROFESSIONAL CERTIFIC	CATION	AS-BUILT / REV	ISION	BY	DATE	P.W.A. NO.	KEY SHEET	POSITION SHT	DRAWIN	IG SCALE	
	IIIII OF MARLIN	I HEREBY CERTIFY THAT THESE DOCUMENTS APPROVED BY ME, AND THAT I AM A DULY LIC		BID/PERMI	Т		9/20/24	-	MSW	27NE21	PLAN SCALE:	NONE	APPROVED BY: Mihai T. Petrisor
	A CHIH I	PROFESSIONAL ENGINEER UNDER THE LAWS OF THE STATE OF MARYLAND.				-		R.O.W NO.	-	-	PROFILE SCALE:	-	DIRECTOR 10/03/2024
'		LICENSE NO. 44664 EXPIRATION D.	ATE: 06-18-2025					-	-	-	TROFILE SCALE:	-	DATE:
	44664	ENGINEER: TA CHIH LIN, PE	DGN BY: CCJM	BUREAU OF ENGINEERING AND CONSTRUCTION		HIGH	IWAYS	STRUCTURES	STORM DRAINS	SEWER	WATER	FIELD ENGINEEF	PROPERTY MANAGEMENT
	11.00 11- VIO 11	PRINCIPAL ELECTRICAL ENGINEER  C.C. JOHNSON & MALHOTRA, P.C.	DWN BY: CCJM	REVIEWED BY:									APPROVED BY: CHIEF
<u>dat</u>	9/20/24 Milin	400 EAST PRATT STREET, SUITE 604 BALTIMORE, MARYLAND 21202 (P) 410-461-9920	СНКО ВҮ: ССЈМ	DATE REVIEWED:									DATE:

BALTIMORE COUNTY OFFICE OF BUDGET AND FINANCE, PROPERTY MANAGEMENT

FULLERTON FIRE STATION #8 - RENOVATION & ADDITION

ELECTRICAL PANEL SCHEDULES

E600

22221 PFO JOB ORDER NUMBER 241-220-0054-0012 SHEET 57 of 58

DRAWING NUMBER 2022-2373 ELECTION DIST. NO.: 14C5 FILE NO.: 20-120

SHEET DESIGNATION CONTRACT NUMBER

4401 FITCH AVENUE, NOTTINGHAM, MARYLAND, 21236

### GENERAL ELECTRICAL NOTES (APPLIES TO ALL ELECTRICAL WORK)

- ALL DOCUMENTS AND PUBLICATIONS (SUCH AS, BUT NOT LIMITED TO, MANUALS, HANDBOOKS, CODES, STANDARDS AND SPECIFICATIONS) WHICH ARE CITED IN THIS CONTRACT OR THE SPECIFICATIONS INCORPORATED HEREIN, FOR THE PURPOSE OF ESTABLISHING REQUIREMENTS APPLICABLE TO EQUIPMENT. MATERIALS OR WORKMANSHIP UNDER THIS CONTRACT SHALL BE DEEMED TO BE INCORPORATED HEREIN AS FULLY AS IF PRINTED AND BOUND WITH THIS CONTRACT. WHEREVER REFERENCE IS MADE TO ANY SUCH DOCUMENT, THE CONTRACTOR SHALL COMPLY WITH THE REQUIREMENTS SET OUT IN THE EDITION SPECIFIED IN THIS CONTRACT, OR IF NOT SPECIFIED, THE LATEST EDITION OR REVISION THEREOF, AS WELL AS THE LATEST AMENDMENT OR SUPPLEMENT OR SUPPLEMENT THERETO, EXCEPT AS MODIFIED BY, OR OTHERWISE PROVIDED IN THE SPECIFICATIONS OR THIS CONTRACT.
- CONTRACTOR SHALL COORDINATE THE WORK WITH EXISTING FIELD CONDITIONS & THE WORK OF OTHER TRADES. UNRESOLVABLE CONFLICTS OR INTERFERENCES SHALL BE BROUGHT TO THE IMMEDIATE ATTENTION OF THE ARCHITECT/ENGINEER AND OWNER.
- ALL AUXILIARY ELECTRICAL COMPONENTS. OR CONTROL & POWER WIRING. REQUIRED TO ENSURE THE FUNCTIONALITY OF THE ITEMS SHOWN ON THE DRAWINGS SHALL BE PROVIDED, EVEN IF NOT SPECIFICALLY SHOWN ON THE DRAWINGS. THIS INCLUDES SUCH ITEMS AS LOW VOLTAGE CONTROL POWER AND WIRING TO REMOTE MOUNTED INTERLOCK DEVICES. CONTRACTOR SHALL CONSULT ALL TRADES FURNISHING EQUIPMENT & OBTAIN FROM THEM ALL DATA AND INSTALLATION INSTRUCTIONS TO ENSURE THAT ALL ELECTRICAL REQUIREMENTS ARE INCLUDED.
- DRAWINGS ARE DIAGRAMMATIC AND DO NOT SHOW ALL OF THE RACEWAY, BOXES, PENETRATIONS, SUPPORTS AND OTHER COMPONENTS THAT ARE REQUIRED TO COMPLETE THE WORK ONLY MAJOR ITEMS ARE SHOWN ON THE DRAWINGS. PROVIDE ALL WORK AS REQUIRED FOR A COMPLETE AND FULLY FUNCTIONAL ELECTRICAL SYSTEM.
- EQUIPMENT MANUFACTURER'S WRITTEN INSTALLATION INSTRUCTIONS AND ALL LABELS AND WARNINGS AFFIXED TO THE INSTALLED EQUIPMENT SHALL BE STRICTLY ADHERED TO.
- ALL WORK SHALL BE DONE IN ACCORDANCE WITH THE LATEST REQUIREMENTS OF ALL APPLICABLE CODES & REGULATIONS.
- CONDUCTOR SIZING, BREAKER TRIP RATINGS AND FUSE SIZES FOR MECHANICAL EQUIPMENT FEEDERS AS SHOWN ON THE DRAWINGS ARE BASED ON PRELIMINARY DESIGN INFORMATION. CONTRACTOR SHALL VERIFY THE PROPER SIZING AND RATINGS FROM THE FURNISHED EQUIPMENT WRITTEN DATA OR EQUIPMENT NAMEPLATES PRIOR TO ROUGH IN. IMMEDIATELY ADVISE THE ARCHITECT/ENGINEER AND OWNER OF ANY DISCREPANCIES.
- PROVIDE EQUIPMENT DISCONNECT SWITCHES IN STRICT COMPLIANCE WITH CODE REQUIREMENTS. (NOT ALL LOCAL DISCONNECT SWITCHES ARE SHOWN)
- ALL OUTLET BOXES SHALL BE PROVIDED WITH PROPER COVER PLATES.
- 10. IN AREAS WHERE COUNTERS ARE PROVIDED, COORDINATE EXACT LOCATION OF OUTLETS AND WIRING WITH CASEWORK.
- 11. CONDUITS SHALL BE CONCEALED IN WALLS AND CEILINGS TO THE GREATEST EXTENT POSSIBLE. INTERIOR SURFACE METAL RACEWAY (WIREMOLD OR EQUAL) MAY BE USED FOR LIGHTING FIXTURES OR WIRING DEVICES LOCATED ON INACCESSIBLE BUILDING ELEMENTS, SUCH AS CONCRETE CEILINGS OR MASONRY WALLS. SURFACE METAL RACEWAY SHALL BE MOUNTED TIGHT TO WALLS OR CEILINGS. LOCATION AND ROUTING SHALL BE APPROVED BY ARCHITECT AND OWNER. SEE TECHNICAL SPECIFICATION FOR FURTHER INFORMATION.
- 12. ALL OUTDOOR RECEPTACLES SHALL BE WEATHERPROOF (W.P.) AND THE GFI TYPE.
- 13. ALL OUTDOOR ENCLOSURES SHALL BE NEMA 3R. THE PADLOCKED TYPE WITH TAMPER PROOF SCREWS.
- 14. THE CONTRACTOR SHALL PROVIDE ALL LABOR AND MATERIALS NECESSARY FOR A COMPLETE AND FUNCTIONING ELECTRICAL SYSTEM.
- 15. ALL MATERIALS AND EQUIPMENT SHALL BE ERECTED, INSTALLED, CONNECTED, CLEANED, ADJUSTED, TESTED, CONDITIONED, AND PLACED IN SERVICE IN ACCORDANCE WITH THE MANUFACTURER'S DIRECTIONS AND RECOMMENDATIONS.
- 16. CONDUIT RUNS OR PULL BOXES SHALL NOT BLOCK OR PREVENT FULL COMPLETE ACCESS AND/OR OPERATION OF HVAC EQUIPMENT, ACCESS DOORS, PIPING VAULTS, JUNCTION BOXES MAIN RETURN AIR DUCTS, PULL BOXES, CLEANOUTS, ETC.

SEAL

- 17. VERIFY CLEARANCES FOR ALL NEW ELECTRICAL WORK BEFORE PROCEEDING WITH CONSTRUCTION. COORDINATE USAGE OF AVAILABLE SPACE WITH ALL TRADES. IN THE EVENT OF CONFLICTS, NOTIFY THE ARCHITECT/ENGINEER AND OWNER BEFORE PROCEEDING WITH THE WORK.
- 18. SEAL ALL NEW WALL AND FLOOR CONDUIT PENETRATIONS.
- 19. CIRCUITS ARE SIZED ASSUMING THAT NO MORE THAN THREE CURRENT CARRYING CONDUCTORS ARE IN A SINGLE CONDUIT FOR CONDUITS CONTAINING MORE THAN THREE. PROVIDE APPROPRIATE DERATING OF CONDUCTORS PER CODE.
- 20. NUMBERED CIRCUITS ARE CREATED FOR THE CONVENIENCE OF DESIGN ONLY. DESIGN INTENT MUST BE FOLLOWED THROUGHOUT, INDICATE THE CIRCUIT NUMBERS AND CORRESPONDING ROOM NUMBERS USED ON THE "AS-BUILT" DRAWINGS. EMERGENCY PANEL CIRCUIT NUMBERS MAY VARY. ACTUAL FIELD CONDITIONS SHALL BE VERIFIED.
- 21. NO WIRING SHALL BE INSTALLED PRIOR TO THE CONTRACTOR'S REVIEW OF THE PROJECT EQUIPMENT SHOP DRAWINGS AND COORDINATION WITH THE DESIGN DOCUMENTS. ANY DISCREPANCIES SHALL BE BROUGHT TO THE ARCHITECT/ENGINEER AND OWNER ATTENTION FOR FINAL RESOLUTION. WORK THAT HAS TO BE REPLACED DUE TO LACK OF PROPER SHOP DRAWINGS COORDINATION SHALL BE DONE AT CONTRACTOR'S EXPENSE.
- 22. MOTOR SIZES AND LOCATIONS SHOWN ON THE DRAWINGS ARE BASED ON INFORMATION OBTAINED DURING DESIGN. VERIFY THE ACTUAL LOCATIONS AND PROVIDE WIRING AND PROTECTION OF PROPER SIZES AS REQUIRED. WIRE THE MOTORS FOR PROPER DIRECTION OF ROTATION AND CHECK ROTATION AT START-UP.
- 23. ALL INCOMING POWER & LOW VOLTAGE CONDUCTORS SHALL RUN IN CONCEALED CONDUIT. UTILIZE EXISTING CONDUIT WHERE POSSIBLE.
- 24. ALL EQUIPMENT INSTALLED IN MECHANICAL AIR PLENUM SPACE SHALL BE RATED FOR THAT USE PER LOCAL REQUIREMENT.
- 25. FOR 15A OR 20A BRANCH CIRCUITS, PROVIDE WIRE SIZES AND RACEWAYS AS PER WIRING NOTES ON DRAWING E001
- 26. NOTIFY ARCHITECT AND OWNER NO FEWER THAN SEVEN (7) DAYS IN ADVANCE OF PROPOSED INTERRUPTION OF ELECTRICAL SERVICE. DO NOT PROCEED WITH INTERRUPTION OF ELECTRICAL SERVICE WITHOUT ARCHITECT'S AND OWNER WRITTEN PERMISSION.
- 27. SURFACE MOUNTED METAL RACEWAYS ONLY PERMISSIBLE ON EXISTING WALLS, WHERE CONDUIT CANNOT BE CONCEALED, IN OCCUPIED. OR NON-OCCUPIED SPACES.
- 28. REFER TO ARCHITECTURAL DRAWINGS FOR TEMPORARY LIVING FACILITY TRAILERS. PROVIDE TRAILERS WITH TEMPORARY ELECTRIC, DATA, SECURITY, FIRE ALARM, AND OTHER UTILITIES THROUGHOUT THE DURATION OF CONSTRUCTION.

111111	PROFESSIONAL CERTIFIC	CATION	AS-BUILT / REV	ISION	BY	DATE	P.W.A. NO.	KEY SHEET	POSITION SHT	DRAWIN	G SCALE	
MARLI	I HEREBY CERTIFY THAT THESE DOCUMENTS APPROVED BY ME, AND THAT I AM A DULY LIC		BID/PERM	ΙΤ		9/20/24	-	MSW	27NE21	PLAN SCALE:	NONE	APPROVED BY: Mihai T. Petrisor
MARLUN AZO	PROFESSIONAL ENGINEER UNDER THE LAWS O MARYLAND.						R.O.W NO.	-	-		-	DIRECTO DIRECTO
		ATE: 06-18-2025					-	-	-	PROFILE SCALE:	-	DATE:
ND day	ENGINEER:	DGN BY: CCJM	BUREAU OF ENGINEERING AND CONSTRUCTION		HIGH	IWAYS	STRUCTURES	STORM DRAINS	SEWER	WATER	FIELD ENGINEER	PROPERTY MANAGEMENT
664 MGHILLIAM	C.C. JOHNSON & MALHOTRA, P.C.	DWN BY: CCJM	REVIEWED BY:									APPROVED BY:
Millin	400 EAST PRATT STREET, SUITE 604 BALTIMORE, MARYLAND 21202 (P) 410-461-9920	СНКО ВҮ: ССЈМ	DATE REVIEWED:									DATE:

LIGHTING FIXTURE SCHEDULE								
TYPE	DESCRIPTION	BASIS OF DESIGN		LAMP				COMMENTS
		MANUFACTURER	MODEL	TYPE	WATTS	EFFICACY	VOLTAGE	COMMENTS
Α	GTL 2X4 7200 NOMINAL LUMENS A12 LENS 3500K	LITHONIA LIGHTING	2GTL 4 40L A19 EZ1 LP835	LED	34 W	149 lm/W		
A1	GTL 2X4 7200 NOMINAL LUMENS A12 LENS 3500K FOR EMERGENCY LIGHTING	LITHONIA LIGHTING	2GTL 4 40L A19 EZ1 LP835 N80 BGTD	LED	34 W	149 lm/W		
В	4" SQUARE LED RECESSED DOWNLIGHT UL LISTED FOR WET LOCATION	GOTHAM LIGHTING	EVO4SQSH-SQ-35-20-DFR-SMO-MVOLT-EZ10	LED	20 W	81 lm/W		
С	EXTERIOR WALL MOUNTED LED	LITHONIA LIGHTING	TWP LED ALO 40K T3M MVOLT PE SF DBLXD	LED	48 W	149 lm/W		
EM	EMERGENCY BATTERY PACK	LITHONIA LIGHTING	ELM2L-LP220L-W-UVOLT-SDRT	LED				WALL MOUNTED 7'-11" AFF
RL	EXISTING FIXTURE RELOCATED TO NEW LOCATION	EXISTING	-	EX.	0 W			
Х	EXIT DIRECTIONAL SIGN	LITHONIA LIGHTING	LQM S W 1 G MVOLT	LED			120 V	

### LIGHT FIXTURE GENERAL NOTES

- REFER TO ARCHITECTURAL DRAWING FOR MOUNTING CONSTRUCTION.
- 2. LISTED CATALOG NUMBER AND MANUFACTURER CONSTITUTES "BASIS OF DESIGN". LISTING OF ALTERNATE MANUFACTURER'S NAMES DOES NOT IMPLY ACCEPTANCE OF THEIR STANDARD PRODUCT. MANUFACTURERS ARE RESPONSIBLE FOR PROVIDING FIXTURES THAT ARE EQUAL IN ALL RESPECTS TO THE "BASIS OF DESIGN" FIXTURES. "INTENT IS TO ALLOW FOR COMPETITIVELY BID LIGHTING PACKAGE, FOR FIXTURES WITH MULTIPLE NAMED MANUFACTURERS."
- SUBSTITUTIONS OF FIXTURES ONLY ALLOWED WHEN APPROVED IN ADVANCE BEFORE SHOP DRAWINGS SUBMITTAL AND REQUEST FOR SUBSTITUTION IS SUBMITTED IN ACCORDANCE WITH SPECIFICATION REQUIREMENTS.
- 4. LIGHTING FIXTURES SUBMITTALS SHALL INCLUDE, AS A MINIMUM: A) FIXTURE TYPE (TO MATCH WITH SCHEDULE), DIMENSIONS AND FINISH. B) LAMP DATA/LED DATA FOR EACH TYPE OF FIXTURE INCLUDING: TYPE, QUANTITY, WATTAGE, AND PHOSPHOR COLOR. C) DRIVER FOR EACH FIXTURE TYPE AND FIXTURE VOLTAGE.
- PROVIDE UNIVERSAL 120/277 VOLT, 0-10V DIMMING DRIVER FOR DIMMING TO 1% UNLESS OTHERWISE INDICATED.
- VERIFY CEILING/WALL TRIM COMPATIBILITY PRIOR TO SUBMITTING THE FIXTURES. COLOR AND FIXTURE FINISHES AS SELECTED BY ARCHITECT WHETHER SHOWN OR NOT. PROVIDE ADAPTER AND ADDITIONAL MOUNTING EQUIPMENT AS REQUIRED TO MOUNT FIXTURE TO SURFACE.
- PROVIDE LABOR AND EQUIPMENT FOR FOCUSING OF ADJUSTABLE FIXTURES AND PRESETTING OF LIGHTING CONTROL SYSTEMS. FOCUSING AND PRESETTING SHALL BE DONE IN THE PRESENCE OF THE OWNER AND ARCHITECT/ENGINEER.
- PROVIDE ALL CONTROL WIRES FOR 0-10V DIMMING. PROVIDE DIMMING BALLAST (DIMMABLE FROM 10%-100%)
- 9. IF THE CONTRACTOR OPTS TO USE THE FIXTURE OF ALTERNATE MANUFACTURER (WHERE ACCEPTABLE), THE CONTRACTOR SHALL BE RESPONSIBLE TO PROVIDE POINT-TO-POINT CALCULATIONS FOR ALL AREAS AS DIRECTED BY THE ENGINEER AT THE TIME OF SUBSTITUTION REQUEST.
- 10. PROVIDE ALL CHANNELS, HANGERS, CABLES, SUPPORTS AND OTHER ACCESSORIES AS REQUIRED FOR SUSPENDED FIXTURES FOR COMPLETE WORKING SYSTEM WITHOUT ADDITIONAL COST TO OWNER. PROVIDE SIDE BRACKETS TO MOUNT TO WALL /COVE/SUPPORTS.
- 11. IF MULTIPLE VOLTAGES ARE INDICATED, FIXTURE IS COMPATIBLE WITH MULTIPLE VOLTAGES. FIXTURE TO BE WIRED TO VOLTAGE INDICATED IN PARENTHESES ().
- 12. PROVIDE INSTALLED UL LABELS WITH THE MAXIMUM SCHEDULED WATTAGE.
- LED SHALL BE 3500K COLOR TEMPERATURE.

SUBDIVISION: FULLERTON

- 14. REFER TO LIGHTING PLANS FOR (\*) ROW LENGTH
- 15. LIGHTING FIXTURES IN EQUIPMENT ROOMS TO BE INSTALLED AFTER ALL EQUIPMENT, PIPING, DUCTWORK, ETC. HAS BEEN INSTALLED SO AS NOT TO CREATE INTERFERENCES AND TO MAXIMIZE ILLUMINATION LEVELS.
- THE BATTERY BACKUP SYSTEM SHALL MEET LOCAL REQUIREMENTS (MINIMUM 90 MIN. BACKUP TIME. TEST SWITCH & INDICATOR). BALLAST SELECTION FOR ALL FIXTURES SHALL BE COORDINATED WITH THE LIGHTING CONTROL MANUFACTURER BEFORE BID. PROVIDE DIMMING BALLAST AS IT IS INDICATED ON LIGHTING PLANS, MOUNTING METHOD AND HEIGHT FOR PENDANT-TYPE FIXTURES SHALL BE COORDINATED WITH THE ARCHITECT AND ARCHITECTURAL PLANS. PROVIDE PLENUM-RATED FIXTURE WHERE IT IS APPLICABLE. REFER TO MECHANICAL DRAWING FOR INFORMATION

SHEET DESIGNATION CONTRACT NUMBER E601 22221 PFO

FULLERTON FIRE STATION #8 - RENOVATION & ADDITION

LIGHT FIXTURE SCHEDULE

BALTIMORE COUNTY OFFICE OF BUDGET AND FINANCE, PROPERTY MANAGEMENT

4401 FITCH AVENUE, NOTTINGHAM, MARYLAND, 21236

ELECTION DIST. NO.: 14C5



JOB ORDER NUMBER 241-220-0054-0012 SHEET 58 of 58 DRAWING NUMBER 2022-2374