# FULLERTON FIRE STATION #8 - RENOVATION & ADDITION 4401 FITCH AVENUE, NOTTINGHAM, MARYLAND, 21236

# **BID/PERMIT**

DESCRIPTION			
DOOR TAG			
CASEWORK TAG  AS OUTLINED IN THE ARCHITECTURAL WOODWORK INSTITUTE (AWI) STANDARDS			
SPECIALTY EQUIPMENT TAG			
COLUMN LINE DESIGNATION TAG			
LEVEL ELEVATION TAG			
NORTH ARROW TAG T = TRUE NORTH P = PROJECT NORTH			
ROOM NAME & NUMBER TAG			
SECTION TAG			
CALLOUT / DETAIL			
SPOT ELEVATION TAG			
DETAIL / DRAWING TITLE TAG			
CEILING TAG			
PARTITION TAG			
MATERIAL TAG			
WINDOW TAG			
ROOF SLOPE ANNOTATION			

PATTERN	DESCRIPTION
	BRICK
	CMU MASONRY
	CONCRETE SECTION
)5050505050505050	POROUS FILL
	EARTH
	PLYWOOD
	GYPSUM BOARD SECTION
	RIGID INSULATION
	BATT INSULATION
	END GRAIN LUMBER
	WOOD BLOCK OR SHIM
	FINISH WOOD

	c		EINI		EINICH	DCE		DOLINDS DED COLLADE ECOT
SYMBOL &	- -	AND	FIN FIN FL	-	FINISH FINISHED FLOOR	PSF PSI	-	POUNDS PER SQUARE FOOT POUNDS PER SQUARE INCH
@	-	AT	FL	-	FLOOR	PT	-	PRESSURE TREATED
Φ	-	DIAMETER	FLEX	-	FLEXIBLE	PTD	-	PAINTED
Ф	-	SQUARE	FLUOR		FLUORESCENT	PVC	-	POLYVINYL CHLORIDE
			FND	-	FOUNDATION		-	PAVEMENT
	•••••	ANCHOR BOLT	FPM	-	FEET PER MINUTE	PWT	-	PREFABRICATED WOOD TRUS
AB ABV	-	ANCHOR BOLT ABOVE	FRT FSK	-	FIRE RETARDANT TREATED FOIL SCRIM KRAFT	D		
ADV ACOUST		ACOUSTICAL	FT FT	-	FEET, FOOT	R	_	RADIUS
	-	ACOUSTICAL ACOUSTIC CEILING TILE	FT	_	FLOOR TRANSITION	RCP	-	REFLECTED CEILING PLAN
AFF	-	ABOVE FINISH FLOOR	FTG	_	FOOTING		-	REINFORCING, REINFORCED
AHJ	-	AUTHORITY HAVING JURISDICTION				RES	-	RESINOUS
ALUM	-	ALUMINUM	G			REQD	-	REQUIRED
AP	-	ACCESS PANEL	GA	-	GAGE, GAUGE	REV	-	REVISION
APPROX		APPROXIMATELY	GALV	-	GALVANIZED	RGD	-	RIGID
ARCH	-	ARCHITECTURAL	GL	-	GLASS, GLAZING	RM	-	ROOM
_			GND	-	GROUND	RO	-	ROUGH OPENING
B		DOTTOM CHODD	GRTG		GRATING	RST	-	REINFORCING STEEL
B.C. BLK	-	BOTTOM CHORD	GWB	-	GYPSUM WALL BOARD	c		
	-	BLOCK Building	ш			<b>S</b> B		SMART BOARD
	-	BLOCKING	<b>п</b> Н		HIGH / HEIGHT	SCD	-	SEE CIVIL DRAWINGS
BLKHD		BULKHEAD	HC	_	HANDICAPPED		_	SCHEDULE
	-	BEAM	HD	-	HEAD	SD	-	STORM DRAIN
3.O.	-	BOTTOM OF	HM	_	HOLLOW METAL	SED	-	SEE ELECTRICAL DRAWINGS
BOD	-	BASIS OF DESIGN	HORIZ	-	HORIZONTAL	SECT	-	SECTION
BOT	-	BOTTOM	HR	-	HOUR	SF	-	SQUARE FOOT
3.R.	-	BULLET RESISTANT	HT	-	HEIGHT	SI	-	SQUARE INCH
BRNG	-	BEARING				SIM	-	SIMILAR
						SLP	-	SLOPE
			ID	-	INSIDE DIAMETER	SMD	-	SEE MECHANICAL DRAWINGS
Ĺ	-	CENTER LINE	IN	-	INCH	SPCL	-	SPECIAL
CFCI	-	CONTRACTOR FURNISHED,	INFO	-	INFORMATION	SPEC	-	SPECIFICATIONS
		CONTRACTOR INSTALLED	INSUL	-	INSULATION	SPLY	-	SUPPLY
CFOI	-	CONTRACTOR FURNISHED,	_			SQ	-	SQUARE
		OWNER INSTALLED				SS	-	STAINLESS STEEL
CFLS	-	COUNTER FLASHING	JB	-	JUNCTION BOX	SSD	-	SEE STRUCTURAL DRAWINGS
	-	CONTROL JOINT	JM	-	JAMB	ST	-	STREET
	-	CLOSET CEILING	JST JT	-	JOIST		-	STANDARD
CLG CMU	-	CONCRETE MASONRY UNIT	JI	-	JOINT		-	STEEL STORAGE
CND	-	CONDUIT	i			STRUCT		STRUCTURAL
	-	COLUMN	LG	_	LONG		-	SURFACE
COOR		COORDINATE	LL	-	LIVE LOAD		-	SUSPENDED
	_	CONCRETE	LSC		LIFE SAFETY CODE		_	SWITCH
CONSTR		CONSTRUCTION	LTG	_	LIGHTING	SYS	_	SYSTEM
	_	CONTINUOUS	LIG		LIGITING	313		31312.01
c.T. / CT	• _	CERAMIC TILE	M			T		
'	-	CARPET / CARPET TILE	MACH		MACHINE		-	TOP AND BOTTOM
CTSK	-	COUNTERSUNK	MAT'L	-	MATERIAL	T.B.	-	TACK BOARD
CU	-	CUBIC	MAX	-	MAXIMUM	T.B.D.		TO BE DETERMINED
CU FT		CUBIC FOOT	MBT	-	MARBLE THRESHOLD	TEMP	-	TEMPERATURE
CU YD	-	CUBIC YARD	MECH	-	MECH	THK		THICK
_			MEP	-	MECHANICAL / ELECTRICAL /			THRESHOLD
					PLUMBING		-	TONGUE & GROOVE
)	-	DEEP / DEPTH	MFGR		MANUFACTURER	TOP	-	TOP OF BEADING POINT
DEG	-	DEGREE	MH	-	MANHOLE		-	TOP OF BEARING POINT
DIA DIM	-	DIAMETER		-	MINIMUM MASONRY ORENING		-	TOP OF CONCRETE
DIM DL	-	DIMENSION DEAD LOAD	MO MSNRY	-	MASONRY OPENING MASONRY	TOF TOM	-	TOP OF FOOTING TOP OF MASONRY
	-	DAMPER		-	METAL THRESHOLD	TOP	-	TOP OF IMASONKY  TOP OF PAVEMENT, PARAPET
ON ON	_	DOWN	MTL	-	METAL	TOS	-	TOP OF STEEL
OR OR	_	DOOR	MTD	-	MOUNTED		-	TREATED
DS	_	DOWNSPOUT				T.S.	-	TRANSITION STRIP
DTL	-	DETAIL	N			TYP	-	TYPICAL
	-	DRAWING	NA	-	NOT APPLICABLE			
			NIC	-	NOT IN CONTRACT			
Ē			NO	-	NUMBER	UGND		UNDERGROUND
Α	-	EACH	NTS	-	NOT TO SCALE		-	UNDERWRITERS LAB
EIFS	-	EXTERIOR INSULATON AND					-	UNLESS NOTED OTHERWISE
		FINISHING SYSTEM				UON	-	UNLESS OTHERWISE NOTED
LEC	-	ELECTRICAL	0/C	-	ON CENTER			
EL	-	ELEVATION	OD	-	OUTSIDE DIAMETER			
LEV	-	ELEVATION	OFIC	-	OWNER FURNISHED,	VB	-	VAPOR BARRIER
	-	ELEVATOR MACHINE ROOM	050:		CONTRACTOR INSTALLED		-	VINYL COMPOSITION TILE
. N. <del>T.</del>	-	EXPANSION JOINT	OFOI	-	OWNER FURNISHED,	VERT	-	VERTICAL VERIEV IN FIELD
NT O	-	ENTRANCE, ENTRY	ODMC		OWNER INSTALLED	VIF	-	VERIFY IN FIELD
Q	-	EQUAL	OPNG	-	OPPOSITE	VOL	-	VOLUME
ST W	-	ESTIMATE	OPP HAII	- D-	OPPOSITE OPPOSITE HAND	\A/		
:VV :XST	-	EACH WAY EXISTING	OPP HNI OV	D- -	OVER	w W		WIDE / WIDTH
XSI XT	-	EXTERIOR	OVHD		OVERHEAD	w/	-	WITH
XP	-	EXPOSED	OVIID		OVERVIEWS	W/O	-	WITHOUT
EXP JT	-	EXPOSED  EXPANSION JOINT	P				-	WHITEBOARD
-/I JI	-	FVI VIANIOIA NOIIAI	P.LAM		PLASTIC LAMINATE	w.b. WD	-	WOOD
:				-	PLYWOOD	WR	-	WATER RESISTANT
 :	-	FAHRENHEIT	PLYWD		PLYWOOD	WTRPRF		WATER RESISTANT
:D	-	FLOOR DRAIN	PLYWD		PANELBOARD		-	WELDED WIRE FABRIC
יט E	_	FICOR DRAIN FIRE EXTINGUISHER	PNT/ PT		PAINT		-	WELDED WIRE MESH
.е. .е.с.	-	FIRE EXTINGUISHER FIRE EXTINGUISHER CABINET	POLYISC		POLYISOCYANURATE	v v v v IVí	=	AAFFDFD AAIL/F IAIE3U
·.E.C. F	-	FINISHED FLOOR		) - -	PRESSURE			
·r ·F EL	-	FINISHED FLOOR FINISHED FLOOR ELEVATION	PRESS PROJ	-	PRESSURE			
-r EL -G	-	FINISHED FLOOR ELEVATION FINISHED GRADE	PROP		PROPERTY			
·G ·HY	-	FINISHED GRADE FIRE HYDRANT	FNOP	-	INOFLINIT			
-н ν	_	TINE THENAMI						

# 03/01/25

**PROJECT TEAM** 

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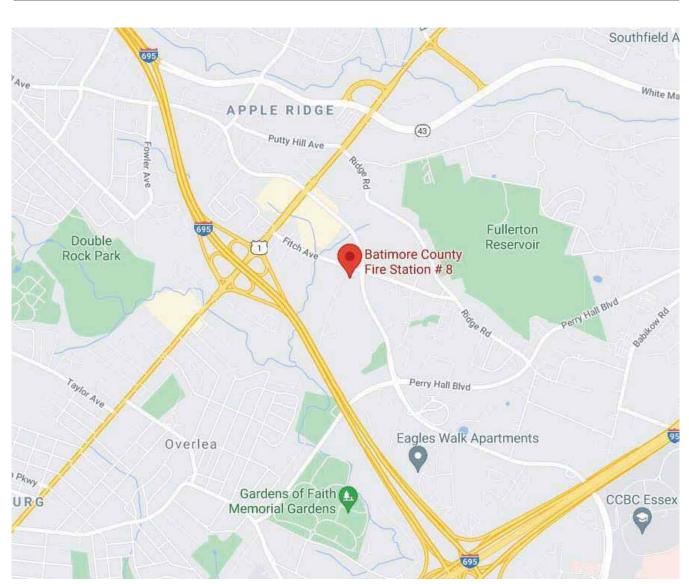
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### **CORRELATION AND INTENT OF THE CONTRACT DOCUMENTS**

MANUAL IS TO INCLUDE ALL ITEMS NECESSARY FOR THE PROPER EXECUTION AND COMPLETION OF THE EITHER DOCUMENT NOT CLARIFIED BY ADDENDUM, THE BETTER QUALITY OR GREATER QUANTITY OF



SUBDIVISION: FULLERTON

#### **VICINITY MAP** NOT TO SCALE

	DRAWING INDEX							
SHEET NUMBER	SHEET NAME							
GENERAL								
G000	COVER SHEET							
G001	CODE ANALYSIS							
G002	CODE PLANS							
G003	TYPICAL ACCESSIBILITY GUIDELINES							
CIVIL - GE								
C1.00	PLOT PLAN							
C1.01	GENERAL NOTES							
CIVIL - DE	MOLITION							
C2.00	EXISTING CONDITIONS & DEMOLITION PLAN							
CIVIL - NE	W WORK							
C3.00	SITE & GRADING PLAN							
C3.01	SITE DETAILS							
C3.02	UTILITY PLAN							
C3.03	STORM DRAIN PROFILES							
ARCHITEC	CTURAL - DEMOLITION							
	ARCHITECTURAL SITE DIAGRAMS							
AD101	DEMOLITION PLANS							
	DEMOLITION PLANS DEMOLITION - AREA OF WORK  CTURAL - NEW WORK							
AD101 AD102 ARCHITEC	DEMOLITION PLANS DEMOLITION - AREA OF WORK  CTURAL - NEW WORK REFERENCE PLAN							
AD101 AD102 ARCHITEC A100 A101	DEMOLITION PLANS DEMOLITION - AREA OF WORK  CTURAL - NEW WORK REFERENCE PLAN DIMENSION PLAN							
AD101 AD102 ARCHITEC A100 A101 A102	DEMOLITION PLANS DEMOLITION - AREA OF WORK  CTURAL - NEW WORK REFERENCE PLAN DIMENSION PLAN BUILDING ASSEMBLY TYPES & DETAILS							
AD101 AD102 ARCHITEC A100 A101 A102 A103	DEMOLITION PLANS DEMOLITION - AREA OF WORK  CTURAL - NEW WORK REFERENCE PLAN DIMENSION PLAN BUILDING ASSEMBLY TYPES & DETAILS FINISH PLAN, SCHEDULE & DETAILS							
AD101 AD102 ARCHITEC A100 A101 A102 A103 A200	DEMOLITION PLANS DEMOLITION - AREA OF WORK  CTURAL - NEW WORK REFERENCE PLAN DIMENSION PLAN BUILDING ASSEMBLY TYPES & DETAILS FINISH PLAN, SCHEDULE & DETAILS BUILDING ELEVATIONS							
AD101 AD102 ARCHITEC A100 A101 A102 A103	DEMOLITION PLANS DEMOLITION - AREA OF WORK  CTURAL - NEW WORK REFERENCE PLAN DIMENSION PLAN BUILDING ASSEMBLY TYPES & DETAILS FINISH PLAN, SCHEDULE & DETAILS							
AD101 AD102 ARCHITEC A100 A101 A102 A103 A200 A300 A400	DEMOLITION PLANS DEMOLITION - AREA OF WORK  CTURAL - NEW WORK REFERENCE PLAN DIMENSION PLAN BUILDING ASSEMBLY TYPES & DETAILS FINISH PLAN, SCHEDULE & DETAILS BUILDING ELEVATIONS BUILDING SECTIONS							
AD101 AD102 ARCHITEC A100 A101 A102 A103 A200 A300 A400 A401	DEMOLITION PLANS DEMOLITION - AREA OF WORK  CTURAL - NEW WORK REFERENCE PLAN DIMENSION PLAN BUILDING ASSEMBLY TYPES & DETAILS FINISH PLAN, SCHEDULE & DETAILS BUILDING ELEVATIONS BUILDING SECTIONS WALL SECTIONS							
AD101 AD102 ARCHITEC A100 A101 A102 A103 A200 A300	DEMOLITION PLANS DEMOLITION - AREA OF WORK  CTURAL - NEW WORK REFERENCE PLAN DIMENSION PLAN BUILDING ASSEMBLY TYPES & DETAILS FINISH PLAN, SCHEDULE & DETAILS BUILDING ELEVATIONS BUILDING SECTIONS WALL SECTIONS STAIR DETAILS							
AD101 AD102 ARCHITEC A100 A101 A102 A103 A200 A300 A400 A401 A500	DEMOLITION PLANS DEMOLITION - AREA OF WORK  CTURAL - NEW WORK REFERENCE PLAN DIMENSION PLAN BUILDING ASSEMBLY TYPES & DETAILS FINISH PLAN, SCHEDULE & DETAILS BUILDING ELEVATIONS BUILDING SECTIONS WALL SECTIONS STAIR DETAILS ROOF PLAN							
AD101 AD102  ARCHITEC A100 A101 A102 A103 A200 A300 A400 A401 A500 A501	DEMOLITION PLANS DEMOLITION - AREA OF WORK  CTURAL - NEW WORK REFERENCE PLAN DIMENSION PLAN BUILDING ASSEMBLY TYPES & DETAILS FINISH PLAN, SCHEDULE & DETAILS BUILDING ELEVATIONS BUILDING SECTIONS WALL SECTIONS STAIR DETAILS ROOF PLAN ROOF DETAILS							
AD101 AD102  ARCHITEC A100 A101 A102 A103 A200 A300 A400 A401 A500 A501 A600	DEMOLITION PLANS DEMOLITION - AREA OF WORK  CTURAL - NEW WORK REFERENCE PLAN DIMENSION PLAN BUILDING ASSEMBLY TYPES & DETAILS FINISH PLAN, SCHEDULE & DETAILS BUILDING ELEVATIONS BUILDING SECTIONS WALL SECTIONS STAIR DETAILS ROOF PLAN ROOF DETAILS DOOR/WINDOW SCHEDULE & DETAILS							
AD101 AD102  ARCHITEC A100 A101 A102 A103 A200 A300 A400 A401 A500 A501 A600 A601	DEMOLITION PLANS DEMOLITION - AREA OF WORK  CTURAL - NEW WORK  REFERENCE PLAN DIMENSION PLAN BUILDING ASSEMBLY TYPES & DETAILS FINISH PLAN, SCHEDULE & DETAILS BUILDING ELEVATIONS BUILDING SECTIONS WALL SECTIONS STAIR DETAILS ROOF PLAN ROOF DETAILS DOOR/WINDOW SCHEDULE & DETAILS DOOR/WINDOW SCHEDULE & DETAILS							
AD101 AD102  ARCHITEC A100 A101 A102 A103 A200 A300 A400 A401 A500 A501 A600 A601 A700	DEMOLITION PLANS DEMOLITION - AREA OF WORK  CTURAL - NEW WORK  REFERENCE PLAN DIMENSION PLAN BUILDING ASSEMBLY TYPES & DETAILS FINISH PLAN, SCHEDULE & DETAILS BUILDING ELEVATIONS BUILDING SECTIONS WALL SECTIONS STAIR DETAILS ROOF PLAN ROOF DETAILS DOOR/WINDOW SCHEDULE & DETAILS ENLARGED PLANS & INT. ELEVATIONS							

STRUCTURAL GENERAL NOTES & SCHEDULES

STRUCTURAL SECTIONS & DETAILS

	DRAWING INDEX
SHEET NUMBER	SHEET NAME
S402	STRUCTURAL SECTIONS & DETAILS
	CAL - GENERAL
M001	MECHANICAL LEGEND, ABBREVIATIONS & DETAILS
MECHANI	CAL - DEMOLITION
MD100	MECHANICAL - FIRST FLOOR AND ROOF PLAN - DEMOLITION
NAECHANII	CAL - NEW WORK
M100	MECHANICAL - FIRST FLOOR AND ROOF PLAN - NEW WORK
M400	MECHANICAL - FIRST FLOOR AND ROOF PLAN - NEW WORK
M500	MECHANICAL DETAILS I
M501	MECHANICAL DETAILS II
M600	MECHANICAL DETAILS II
M601	MECHANICAL SCHEDULES II
IVIOUI	MECHANICAL SCHEDULES II
PLUMBIN	G - GENERAL
P001	PLUMBING LEGEND, ABBREVIATIONS & DETAILS
PD100	PLUMBING - FIRST FLOOR PART PLANS - DEMOLITION
PLOIVIBIIN	G - NEW WORK PLUMBING - FIRST FLOOR PART PLANS - NEW WORK
P101	PLUMBING - BASEMENT FLOOR PLAN AND SITE PLAN
P500	PLUMBING RISER DIAGRAMS
P600	PLUMBING SCHEDULES
	AL - GENERAL
E001	ELECTRICAL SYMBOLS & ABBREVIATIONS
ELECTRICA	AL - DEMOLITION
ED100	POWER & SYSTEMS - FIRST & BASEMENT FLOOR PLANS - DEMOLITION
ED101	POWER & SYSTEMS - ROOF PLAN - DEMOLITION
ED102	LIGHTING - FIRST FLOOR PLAN - DEMOLITION
20102	Elemina That Feder Bir Democriter
	AL - NEW WORK
E100	POWER & SYSTEMS - FIRST & BASEMENT FLOOR PLANS - NEW WORK
E101	POWER & SYSTEMS - ROOF PLAN - NEW WORK
E102	LIGHTING - FIRST FLOOR PLAN - NEW WORK
E501	ELECTRICAL RISER DIAGRAM
E600	ELECTRICAL PANEL SCHEDULES
E601	LIGHT FIXTURE SCHEDULE

HIS LIST OF ABBREVIATIONS IS A	A GUIDE TO ABBREVIATIONS	WHICH MAY BE USED IN TH	ESE DOCUMENTS. ABBREVIATIONS
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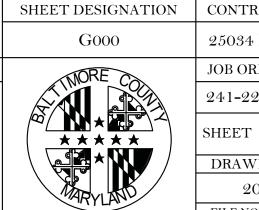
		NOT LISTED MA	AY ALSO BE USED.									
SEAL	PROFESSIONAL CERTIFICATION		AS-BUILT / RE	BY	DATE	P.W.A. NO.	KEY SHEET	POSITION SHT	DRAWIN			
A WOOD W	I HEREBY CERTIFY THAT THESE DOCUMENTS WERE PREPARED OR APPROVED BY ME, AND THAT I AM A DULY LICENSED		BID/PERN	1IT		03/01/25	-	MSW	27NE21	PLAN SCALE:	As indicated	APPROVED BY: Mihai T Petrisor
- CONCANDA SON ACTION OF THE PARTY OF THE PA	· · · · · · · · · · · · · · · · · · ·	ARCHITECT UNDER THE LAWS OF THE STATE OF					R.O.W NO.	-	-		-	DIRECT 03/26/2025
		ATE: 08-18-2026					-	-	-	PROFILE SCALE:	-	DATE: 03/20/2023
	ARCHITECT:	DGN BY:	BUREAU OF ENGINEERING AND CONSTRUCTION		HIGH	WAYS	STRUCTURES	STORM DRAINS	SEWER	WATER	FIELD ENGINEER	PROPERTY MANAGEMENT
15505 CX	PRINCIPAL ARCHITECT  MANNS WOODWARD STUDIOS 10839-D PHILADELPHIA ROAD	DWN BY:	REVIEWED BY:									APPROVED BY: Michael Goodye
10/11/11/11	WHITE MARSH, MARYLAND 21162 (P) 410-344-1460	CHKD BY:	DATE REVIEWED:									DATE: 4.4.25

BALTIMORE COUNTY OFFICE OF BUDGET AND FINANCE, PROPERTY MANAGEMENT

FULLERTON FIRE STATION #8 - RENOVATION & ADDITION

COVER SHEET

4401 FITCH AVENUE, NOTTINGHAM, MARYLAND, 21236



SHEET DESIGNATION | CONTRACT NUMBER JOB ORDER NUMBER 241**-**220**-**0054**-**0012 DRAWING NUMBER 2022-2320

#### CODE ANALYSIS - SUMMARY APPLICABLE CODES SQUARE FOOTAGE TOTALS PROJECT 2018 **EXISTING FOOTPRINT** 7,749 GSF FULLERTON FIRE NFPA 101: LIFE SAFETY STATION #8 INTERNATIONAL EXISTING BUILDING CODE 2015 RENOVATION & ADDITION INTERNATIONAL BUILDING CODE 2015 FIRST FLOOR 7,749 GSF 2015 PARTIAL BASEMENT 1,120 NSF INTERNATIONAL MECHANICAL CODE NATIONAL ELECTRIC CODE 2020 **EXISTING BUILDING** 8,869 GSF NATIONAL STANDARD PLUMBING CODE 2015 2015 PROPOSED ADDITION 194 GSF INTERNATIONAL ENERGY CODE

#### PROJECT DESCRIPTION

THE PROPOSED PROJECT IS A RENOVATION AND ADDITION TO THE EXISTING BALTIMORE COUNTY STATION 8 FIRE STATION. THE EXISTING BUILDING IS A SINGLE STORY STRUCTURE WITH PARIETAL BASEMENT. THE PROJECT PROPOSES AN INTERIOR RENOVATION TO THE CORE OF THE BUILDING BY DEMOLISHING THE EXISTING LOCKER ROOMS AND ADDING FIVE SINGLE OCCUPANT TOILET AND SHOWER ROOMS WITHIN THE EXISTING BUNK ROOM AND SHOWER LOCKER AREA. TO MAKE UP FOR THE REDUCED BUNK ROOM SPACE, THE PROJECT LOOKS TO ADD A SMALL 8'X24' (194 SF) ADDITION TO THE REMAINING BUNK ROOM AREA TO ACCOMMODATE FOR THE LOSS OF EXISTING BUNK ROOM SPACE. IN ADDITION TO THE ABOVE WORK THE PROJECT WILL ALSO UPDATE THE BUILDINGS EXISTING MECHANICAL SYSTEM WITHIN THE BUNK ROOM, KITCHEN, AND ADMINISTRATIVE AREAS OF THE BUILDING.

STATION 8'S FIRST FLOOR IS APPROXIMATELY 7,749 GSF. THE TOTAL FIRST FLOOR WORK AREA IS 2,857 SF (EXCLUSIVE OF THE 194 SF ADDITION) AND CONSTITUTES 37% OF THE BUILDING FOOTPRINT. THE STRUCTURE IS AN ASSUMED TYPE IIB CONSTRUCTION TYPE THAT IS NON-SPRINKLERED. THE EXISTING USE AND EXISTING OCCUPANT LOAD WILL REMAIN AS IS AND WILL NOT CHANGE OR INCREASE.

INTERNATIONAL EXISTING BUILDING CODE 2015								
WORK AREA SF & PERCENTAGE - IEBC 501.2	COMPLIANCE METHOD - IEBC 301 & 504							
LEVEL 1 ALTERATION - 1,212 SF OF 7,749 GSF TOTAL = 16% OF TOTAL BUILDING FOOTPRINT.	301.1.2 - WORK AREA COMPLIANCE METHOD.							
LEVEL 2 ALTERATION - 1,645 SF OF 7,749 GSF TOTAL = 21% OF TOTAL BUILDING FOOTPRINT GSF.	LEVEL 2 ALTERATION SHALL COMPLY WITH THE PROVISIONS OF CHAPTERS 7, 8, AND 9.							
TOTAL WORK AREA = 37% OF TOTAL BUILDING FOOTPRINT AND THEREFORE THE WORK AREA IS LESS THAN 50% OF THE BUILDING AREA.								
COMPLIANCE - IEBC 801.3	MEANS OF EGRESS - IEBC 805.1							
ALL NEW CONSTRUCTION ELEMENTS, COMPONENTS, SYSTEMS, AND SPACES SHALL COMPLY WITH THE REQUIREMENTS OF THE IBC.	THIS SECTION DOES NOT APPLY TO THIS PROJECT BECAUSE THERE IS ONLY A SINGLE TENANT WITHIN THE WORK AREA.							
ACCESSIBILITY - IEBC 806 & 705	STRUCTURE - IEBC 807.3							
ALL NEW WORK SHALL COMPLY WITH THE ACCESSIBILITY REQUIREMENTS. ALL EXISTING ELEMENTS TO REMAIN CURRENTLY COMPLY.	THE MINIMUM DESIGN LOADS ON EXISTING ELEMENTS OF A STRUCTURE THAT DO NOT SUPPORT ADDITIONAL LOADS AS A RESULT OF AN ALTERATION SHALL BE THE LOADS APPLICABLE AT THE TIME THE BUILDING WAS CONSTRUCTED.							
ELECTRICAL - IEBC 808	MECHANICAL - IEBC 809							
ALL NEWLY INSTALLED ELECTRICAL EQUIPMENT & WIRING SHALL COMPLY WITH THE REQUIREMENTS OF NFPA 70.	ALL NEWLY INSTALLED MECHANICAL WORK SHALL COMPLY WITH THE INTERNATIONAL MECHANICAL CODE.							
PLUMBING - IEBC 810	ENERGY CONSERVATION - IEBC 811 & 707							
ALL NEWLY INSTALLED PLUMBING WORK SHALL COMPLY WITH THE INTERNATIONAL PLUMBING CODE.	THE ALTERATIONS SHALL COMPLY TO THE ENERGY REQUIREMENTS OF THE IECC AS THEY RELATE TO NEW CONSTRUCTION ONLY.							
ADDITIONS - IEBC 1102								
NEW ADDITION SHALL NOT EXCEED THE HEIGHT AND AREA LIMITATIONS BEYOND THAT PERMITTED UNDER CHAPTER 5 OF THE IBC.								

INTERNATIONAL BUILDING CODE 2015								
EXISTING USE CLASSIFICATIONS - CH. 3	MEANS OF EGRESS CAPACITY 1005.3.2							
B - BUSINESS - FIRE DEPARTMENT ADMINISTRATION R2 - RESIDENTIAL - DORMITORY	FACTOR: 0.2 INCHES PER OCCUPANT							
S-2 - STORAGE - APPARATUS BAY/ANCILLARY SPACES	NUMBER OF EXITS & ACCESS DOORWAYS - 1006							
EXISTING USE CLASSIFICATIONS TO REMAIN UNALTERED.	PER TABLE 1006.3.1 AN OCCUPANT LOAD OF 560 PER STORY REQUIRES A MINIMAL OF 3 EXITS FROM STORY.							
CONSTRUCTION TYPE - CH.6	EVIT CEDADATION DICTANCE 4046 2							
IIB	EXIT SEPARATION DISTANCE - 1016.2							
BUILDING HEIGHT & AREA - CH.5	<ul> <li>MEANS OF EGRESS ARE NOT PROHIBITED THROUGH</li> <li>ADJOINING OR INTERVENING ROOMS OR SPACES THAT ARI</li> </ul>							
EXISTING BUILDING HEIGHT WILL NOT BE INCREASED	OF A HIGHER HAZARD THAN THE ORIGINAL ROOM OF EGRESS.							
EXISTING STORY QUANTITY WILL NOT BE INCREASED	COMMON PATH OF EGRESS - TABLE 1006.2.1							
BUILDING AREA SHALL BE INCREASED VIA <b>194 GSF</b> PROPOSED ADDITION	ALLOWABLE 75 FEET ACTUAL 31 FEET							
FIRE REC REQ C FOR RUBG FUENERUTC TARLE COA	TRAVEL DISTANCE - TABLE 1017.2							
FIRE-RES. REQ.S FOR BLDG ELEMENTS - TABLE 601	ALLOWABLE 200 FEET							
PER TABLE 602 NO FIRE RATING IS REQUIRED FOR ANY BUILDING ELEMENT UNLESS NOTED OTHER WISE.	ACTUAL 98 FEET							
7 KKT BOILDING ELEMENT ONLESS NOTED OTHER WISE.	DEAD-END CORRIDORS - 1020.4							
	ALLOWABLE 20 FEET							
	ACTUAL 15 FEET							

SUBDIVISION: FULLERTON

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OF MARY WOOD
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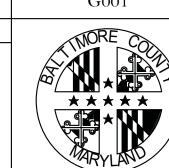
,	PROFESSIONAL CERTIFICATION		AS-BUILT / REVISION	BY	DATE	P.W.A. NO.	KEY SHEET	POSITION SHT	DRAWIN	G SCALE	
	I HEREBY CERTIFY THAT THESE DOCUMENTS WERE PREPARED OR APPROVED BY ME, AND THAT I AM A DULY LICENSED PROFESSIONAL ARCHITECT UNDER THE LAWS OF THE STATE OF MARYLAND.  LICENSE NO. 15505 EXPIRATION DATE: 08-18-2026		BID/PERMIT		03/01/25	-	MSW	27NE21	PLAN SCALE:		APPROVED BY: Mihai T Petrisor
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	WHITE MARSH, MARYLAND 21162 (P) 410-344-1460	CHKD BY:	DATE REVIEWED:								DATE:
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BALTIMORE COUNTY OFFICE OF BUDGET AND FINANCE, PROPERTY MANAGEMENT

FULLERTON FIRE STATION #8 - RENOVATION & ADDITION


CODE ANALYSIS

4401 FITCH AVENUE, NOTTINGHAM, MARYLAND, 21236





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	241-220-0054-0012
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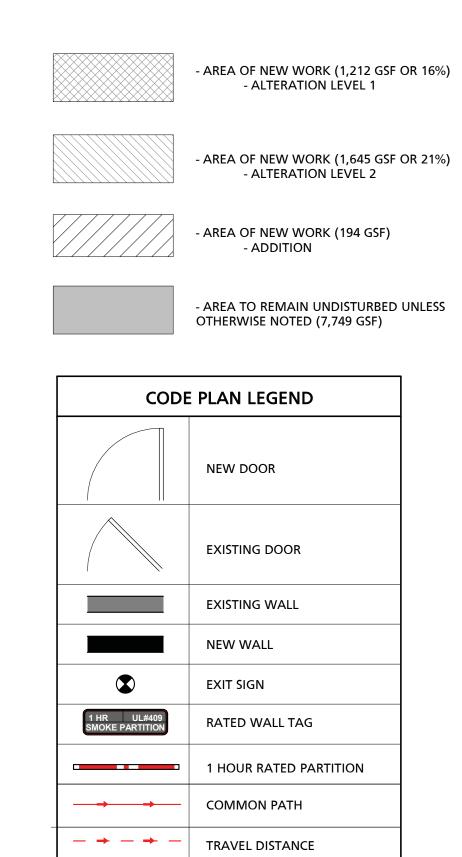




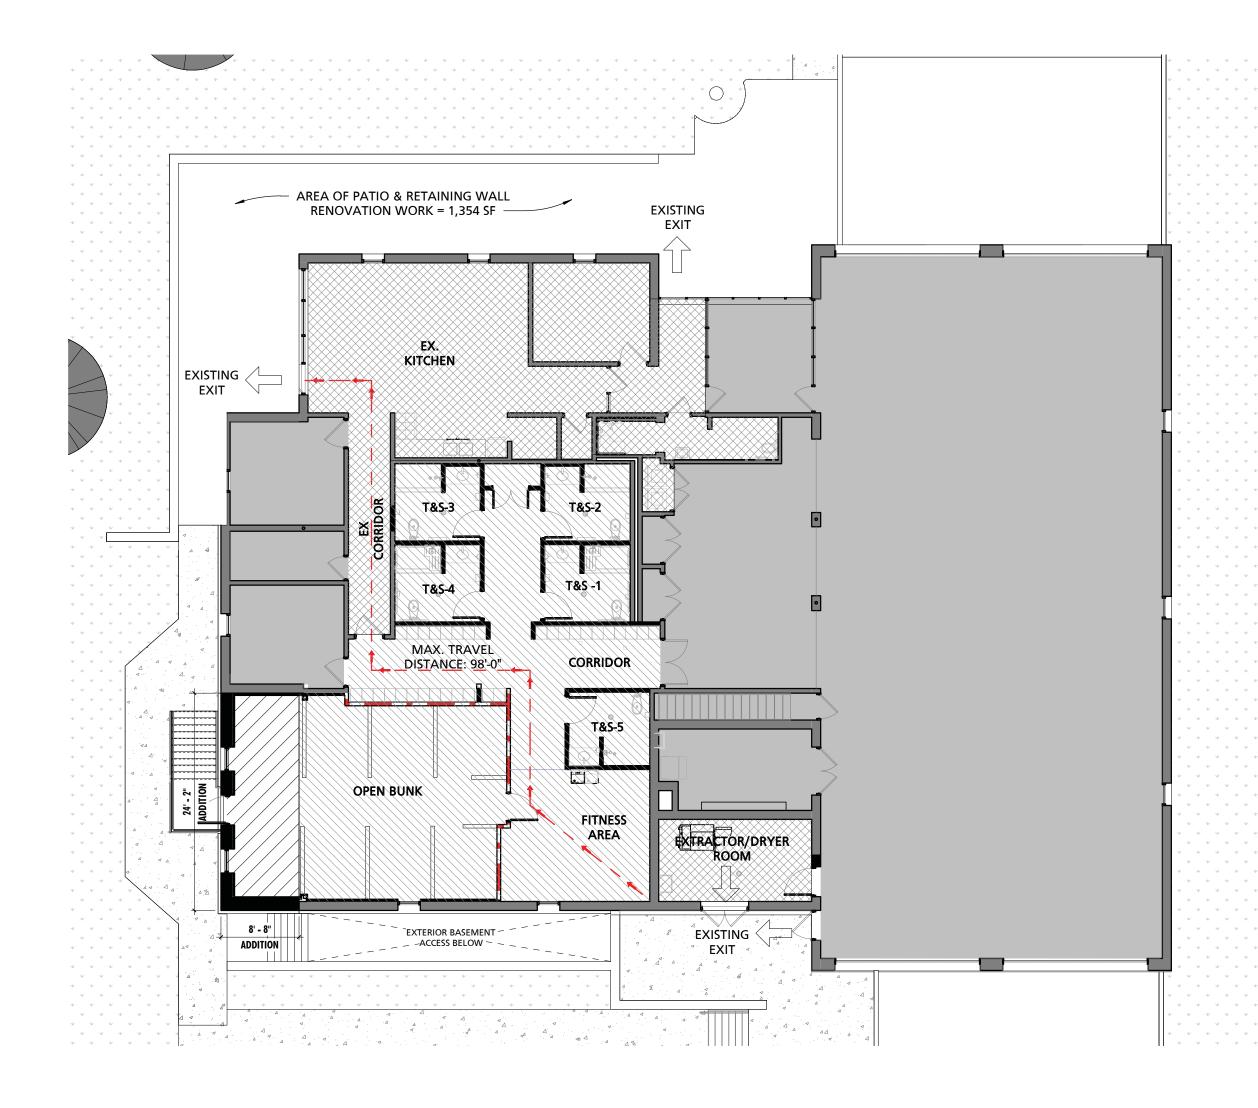

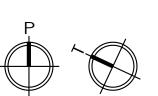

SUBDIVISION: FULLERTON

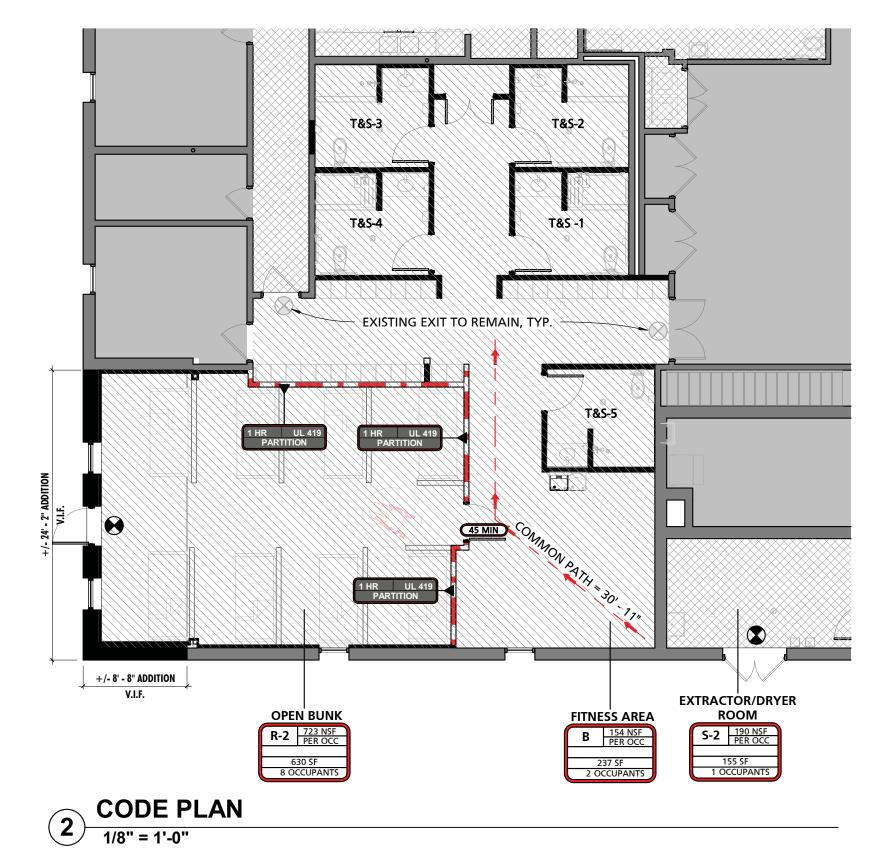

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		PROFESSIONAL ARCHITECT UNDER THE LAWS					R.O.W NO.	-	-			DIRECT
		MARYLAND. LICENSE NO. 15505 EXPIRATION DA	ATE: 08-18-2026				-	-	-	PROFILE SCALE:	-	DATE: 03/26/2025
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		ARCHITECT: DAVID WOODWARD, AIA	DGN BY:	BUREAU OF ENGINEERING AND CONSTRUCTION	HIGH	HWAYS	STRUCTURES	STORM DRAINS	SEWER	WATER	FIELD ENGINEER	PROPERTY MANAGEMENT
	15505.	PRINCIPAL ARCHITECT  MANNS WOODWARD STUDIOS	DWN BY:	REVIEWED BY:								APPROVED BY:
<u> </u>	DATE: 03/01/25	10839-D PHILADELPHIA ROAD WHITE MARSH, MARYLAND 21162 (P) 410-344-1460	СНКО ВҮ:	DATE REVIEWED:								DATE:

BALTIMORE COUNTY OFFICE OF BUDGET AND FINANCE, PROPERTY MANAGEMENT


FULLERTON FIRE STATION #8 - RENOVATION & ADDITION


CODE PLANS

4401 FITCH AVENUE, NOTTINGHAM, MARYLAND, 21236

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JOB ORDER NUMBE
241-220-0054-001
SHEET 3 of 58
DRAWING NUMBER
2022-2322
FILE NO.: 8

SHEET DESIGNATION CONTRACT NUMBER

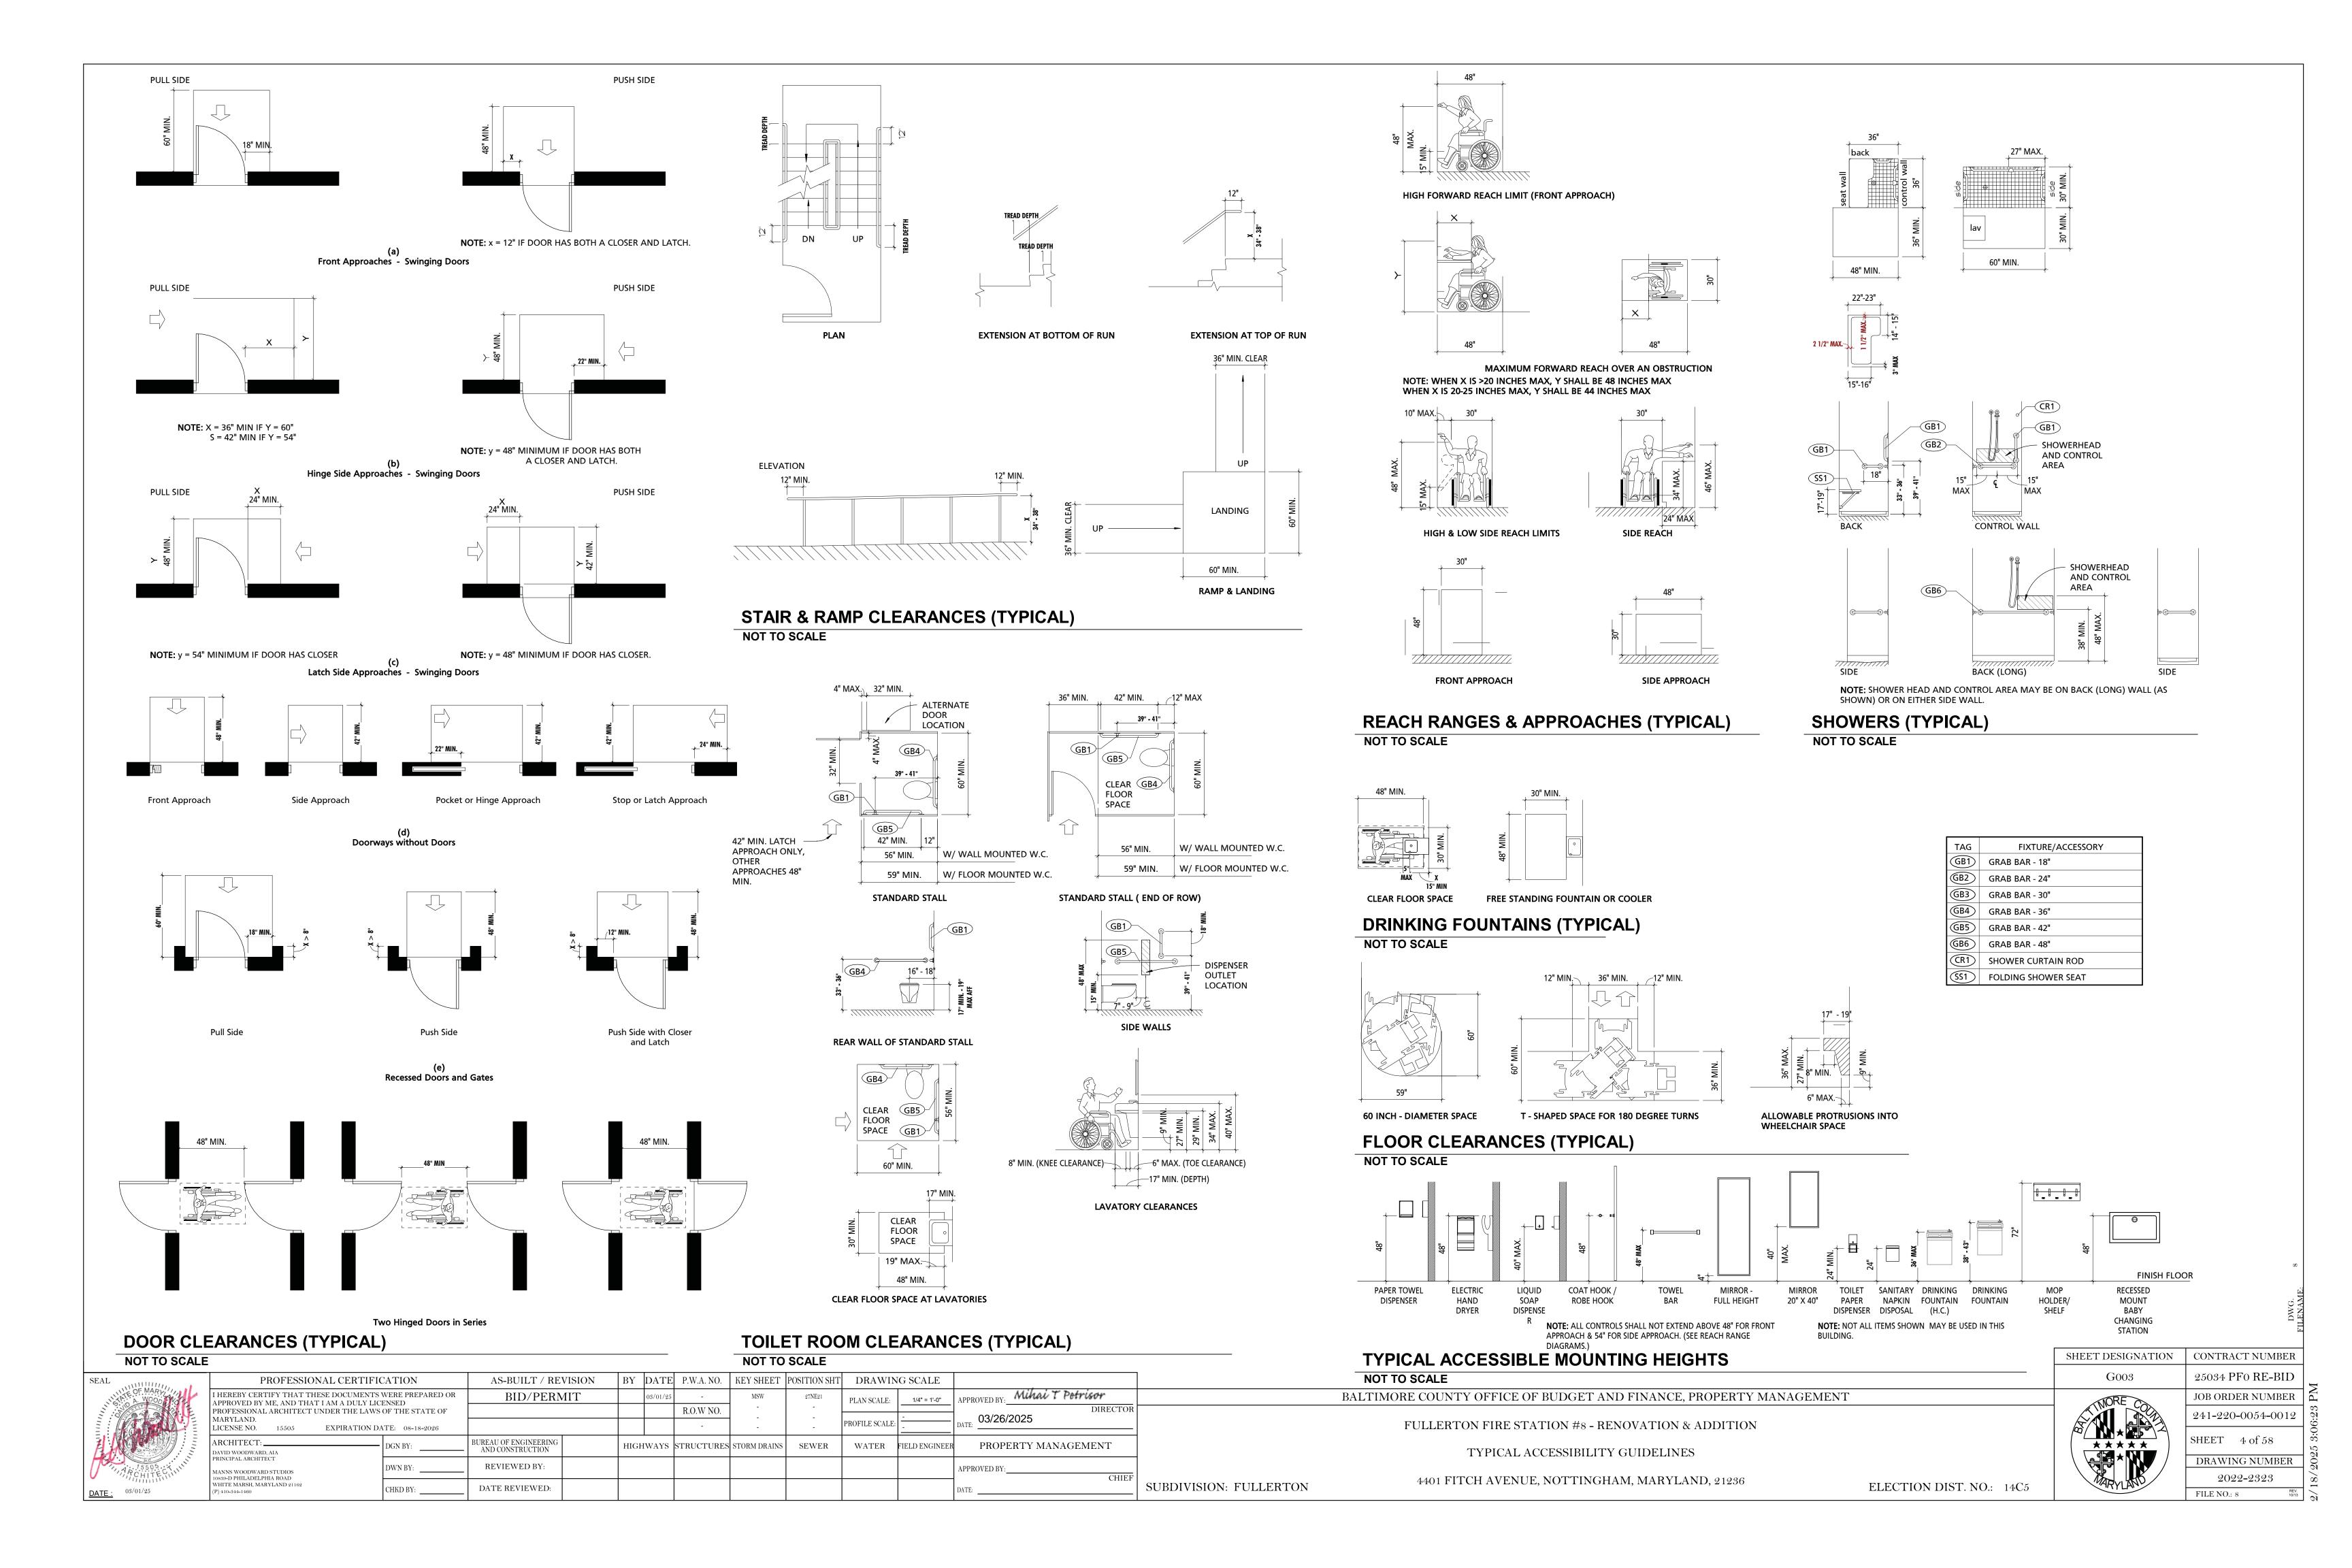

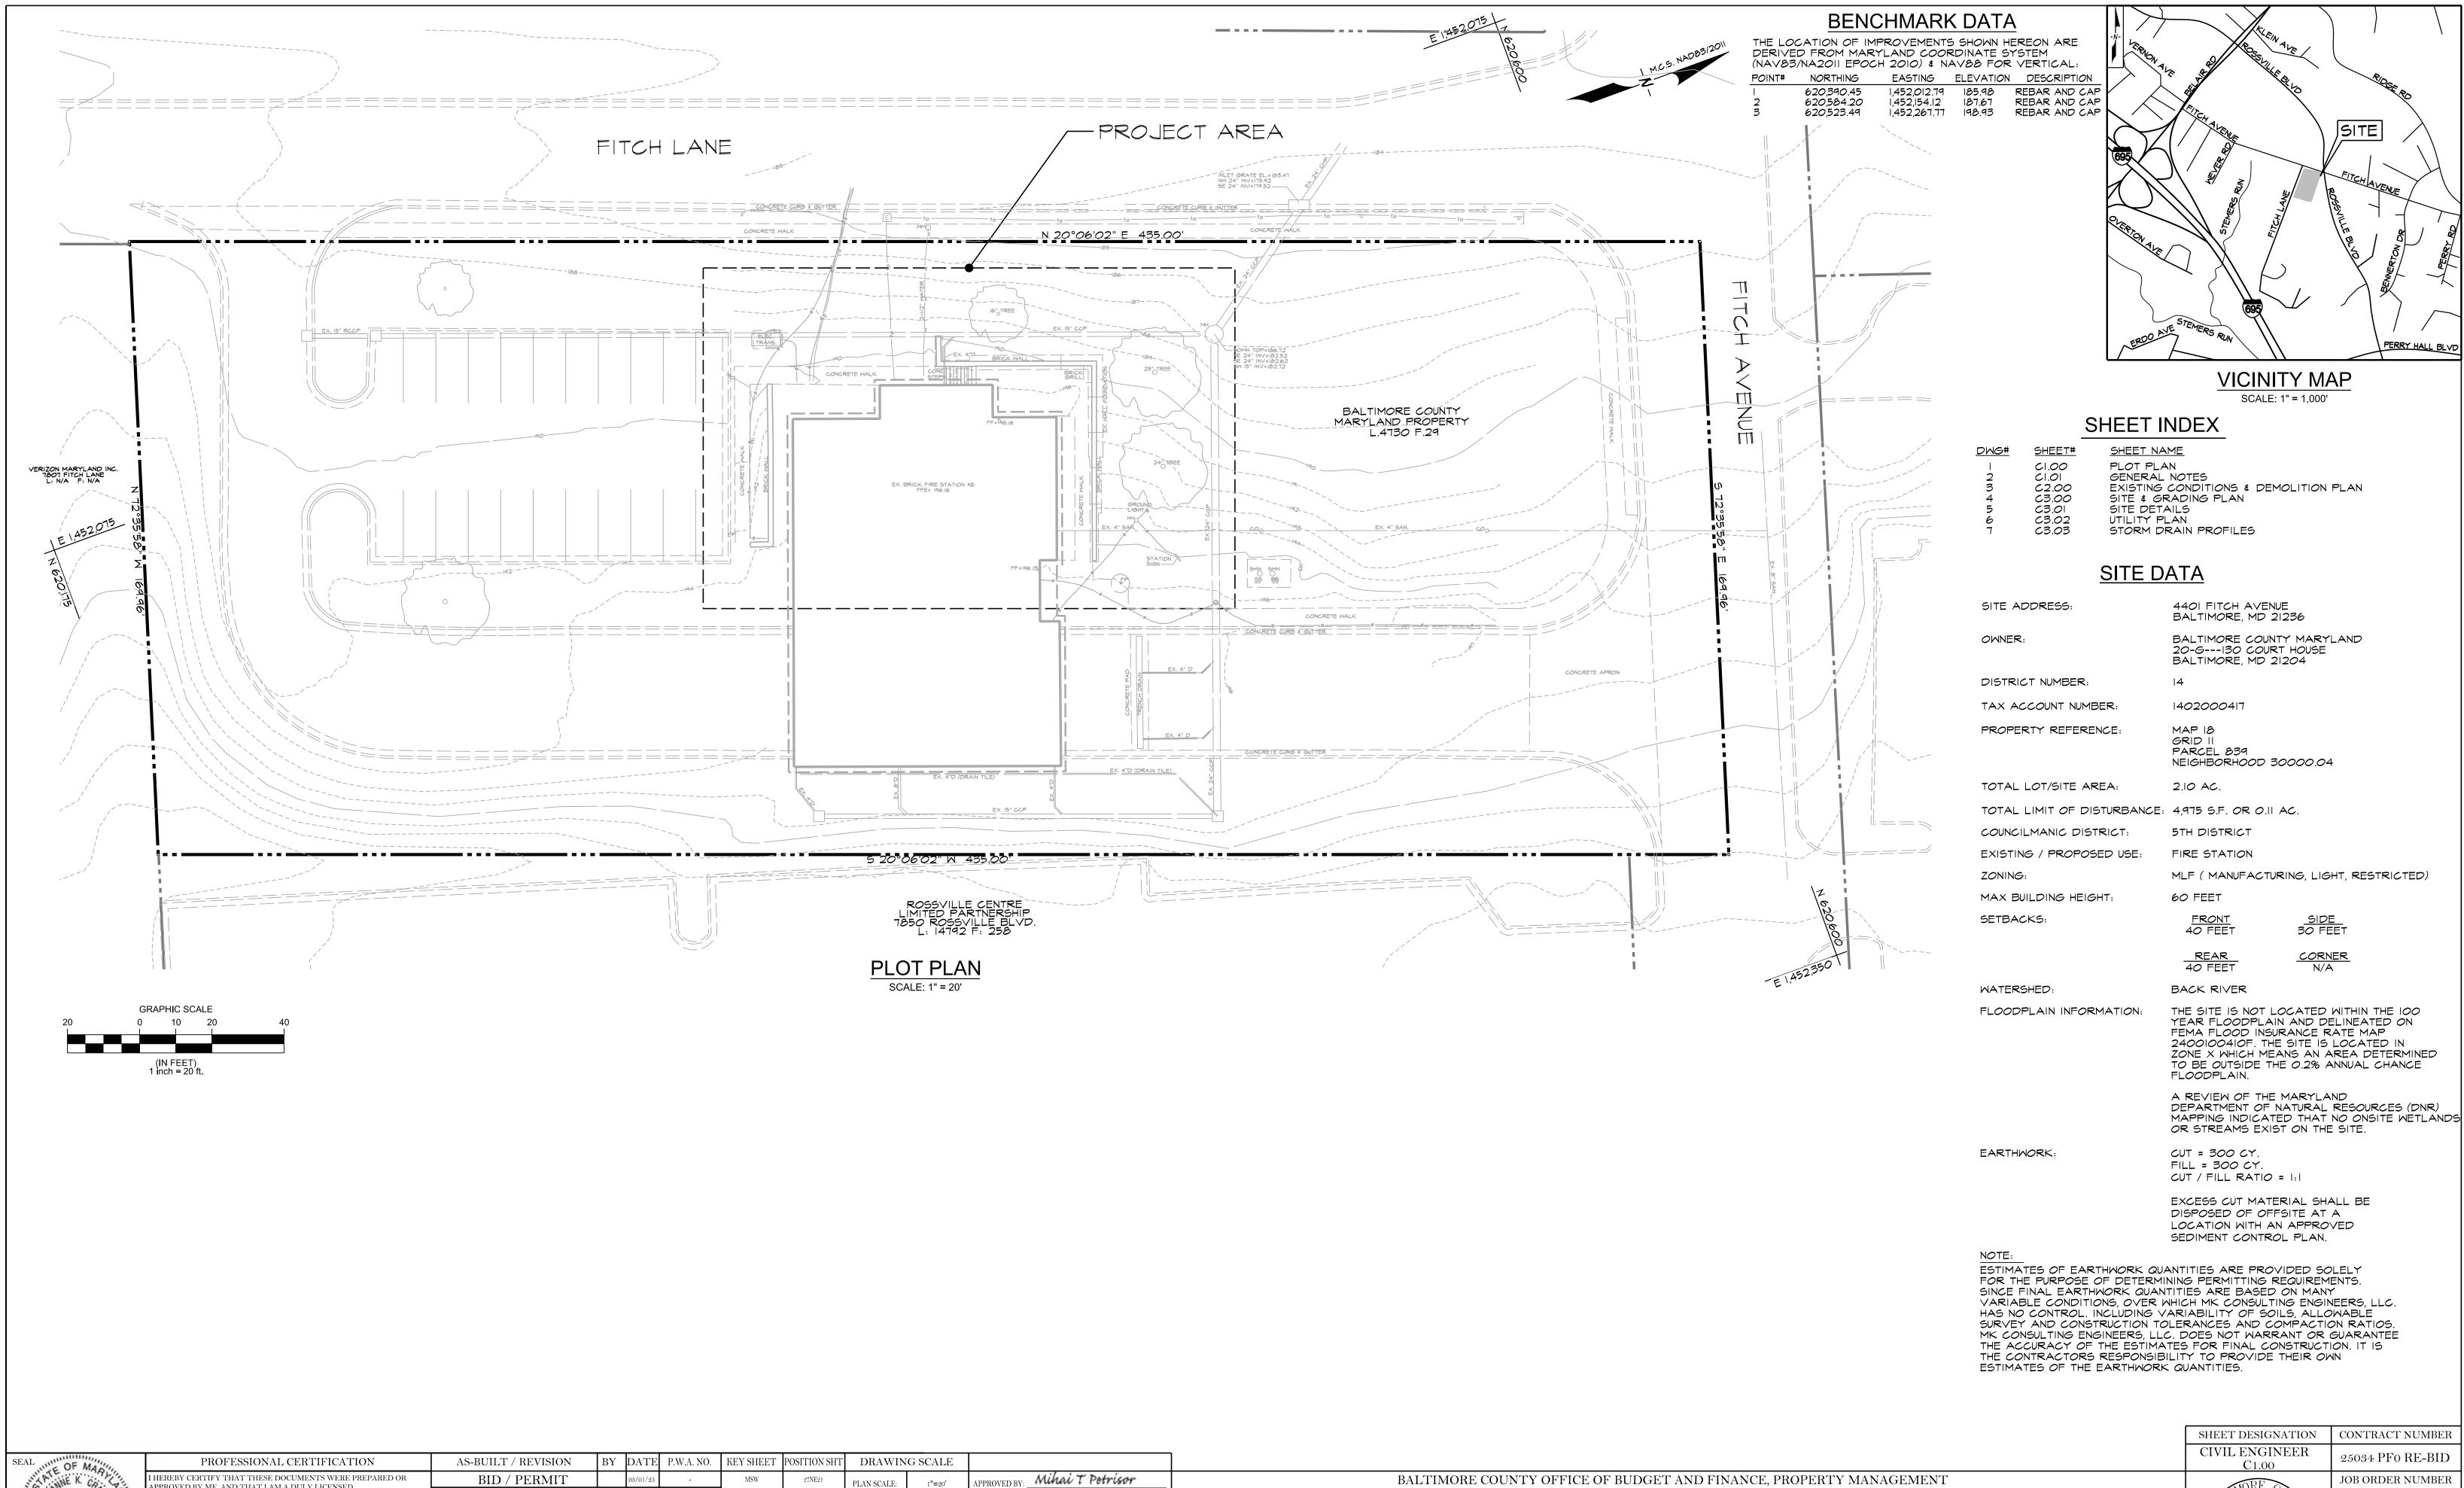

JOB ORDER NUMBER 241-220-0054-0012 SHEET 5 of 58 \*\*\* DRAWING NUMBER 2022-2324 FILE NO.: 8

ELECTION DIST. NO.: 14C5

SUBDIVISION: FULLERTON

4401 FITCH AVENUE, NOTTINGHAM, MARYLAND, 21236

FULLERTON FIRE STATION #8 - RENOVATION & ADDITION

PLOT PLAN

PLAN SCALE:

WATER

SEWER

03/26/2025

APPROVED BY:

PROPERTY MANAGEMENT

R.O.W NO.

HIGHWAYS STRUCTURES STORM DRAINS

APPROVED BY ME, AND THAT I AM A DULY LICENSED PROFESSIONAL ENGINEER UNDER THE LAWS OF THE STATE OF

LICENSE NO.

2.20.25

CIVIL ENGINEER \_\_\_

LTIMORE, MD 21230

ARIANNE CRAMPTON, PE

1 PORTER STREET, SUITE 401

EXPIRATION DATE: 11-17-26

BUREAU OF ENGINEERING AND CONSTRUCTION

REVIEWED BY:

DATE REVIEWED:

#### **GENERAL NOTES**

- I. THE CONTRACTOR SHALL NOTIFY "MISS UTILITY" (I-800-257-7777) AT LEAST FIVE (5) WORKING DAYS PRIOR TO STARTING ANY WORK.
- 2. EXISTING UTILITY INFORMATION SHOWN HEREON IS BASED ON THE BEST AVAILABLE INFORMATION, WHICH INCLUDES A FIELD SURVEY CONDUCTED BY PRECISION MAPPING AND SURVEYING, DURING APRIL, 2022. AS-BUILT WATER, WASTEWATER AND STORM DRAIN PLANS FROM BALTIMORE COUNTY DEPARTMENT OF PUBLIC WORKS AND BALTIMORE GAS AND ELECTRIC COMPANY PLANS.
- 3. OBSTRUCTIONS SHOWN ON THIS DRAWING ARE FOR THE CONVENIENCE OF THE CONTRACTOR ONLY. MK CONSULTING ENGINEERS, LLC. DOES NOT WARRANT OR GUARANTEE THE CORRECTNESS OR THE COMPLETENESS OF THE INFORMATION GIVEN. THE CONTRACTOR MUST VERIFY ALL SUCH INFORMATION TO HIS OWN SATISFACTION. IN THE EVENT THAT INFORMATION IS IN CONFLICT WITH INFORMATION OUTLINED, THE CONTRACTOR SHALL IMMEDIATELY NOTIFY THE ARCHITECT PRIOR TO STARTING ANY WORK.
- 4. TOPOGRAPHIC INFORMATION SHOWN HEREON IS BASED ON AVAILABLE AS-BUILT PLANS PROVIDED BY BALTIMORE COUNTY DEPARTMENT OF PUBLIC WORKS AND BALTIMORE COUNTY DPW, A SUPPLEMENTAL SURVEY CONDUCTED BY PRECISION MAPPING AND SURVEYING DURING APRIL, 2022.
- 5. REMOVAL OF ANY SIDEWALK AND/OR CURB AND GUTTER SHALL BE TO THE NEAREST JOINT. NO PATCHING SHALL BE PERMITTED.
- 6. ADJUST TOP OF CURB GRADES TO PROVIDE SMOOTH TRANSITION.
- 7. SAWCUT EXISTING PAVING AS NEEDED TO INSTALL NEW CONSTRUCTION.
- 8. STRIP & RESURFACE EXISTING PAVING AS NEEDED TO PROVIDE SMOOTH TRANSITION TO EX. SURFACE.
- 9. IT SHALL BE DISTINCTLY UNDERSTOOD THAT FAILURE TO MENTION SPECIFICALLY ANY WORK WHICH WOULD NORMALLY BE REQUIRED TO COMPLETE THIS PROJECT SHALL NOT RELIEVE THE CONTRACTOR OF HIS RESPONSIBILITY TO COMPLETE SUCH WORK.
- IO. IT SHALL BE THE RESPONSIBILITY OF THE CONTRACTOR TO NOTIFY THE ENGINEER OF ANY DEVIATION FROM THIS PLAN PRIOR TO ANY CHANGE BEING MADE. ANY DEVIATION FROM THIS PLAN WITHOUT WRITTEN AUTHORIZATION FROM THE ENGINEER WILL BE THE RESPONSIBILITY OF THE CONTRACTOR.
- II. SHOULD THE CONTRACTOR DISCOVER DISCREPENCIES BETWEEN THE PLANS AND FIELD CONDITIONS, THE ENGINEER IS TO BE NOTIFIED IMMEDIATELY TO RESOLVE THE SITUATION. SHOULD THE CONTRACTOR MAKE FIELD CORRECTIONS OR ADJUSTMENTS WITHOUT NOTIFYING THE ENGINEER, THEN THE CONTRACTOR ASSUMES ALL RESPONSIBILITY FOR THOSE CHANGES.
- 12. THE CONTRACTOR SHALL NOTE THAT IN CASE OF ANY DISCREPANCY BETWEEN THE SCALED AND FIGURED DIMENSIONS SHOWN ON THESE PLANS, THE FIGURED DIMENSIONS SHALL GOVERN.
- 13. PRIOR TO BEGINNING CONSTRUCTION, THE CONTRACTOR SHALL VERIFY ALL TIE-IN ELEVATIONS.
- 14. ALL EXCAVATION SHALL BE BACKFILLED IN ACCORDANCE WITH THE PROJECT SPECIFICATIONS. IN THE EVENT THAT A PORTION OF A UTILITY IS TO BE REMOVED THE CONTRACTOR SHALL TERMINATE AND CAP TO THE LIMITS INDICATED IN ACCORDANCE WITH ALL STATE AND LOCAL REQUIREMENTS.
- 15. THE CONTRACTOR IS SOLELY RESPONSIBLE FOR THE PROTECTION OF THE SUB-GRADE UNTIL IT RECEIVES FINAL SURFACE TREATMENT AND SHALL MAINTAIN THE SUB-GRADE AS SUITABLE AND ACCEPTABLE TO THE OWNER OR OWNER'S REPRESENTATIVE AT ALL TIMES. HE SHALL BE COMPLETELY RESPONSIBLE FOR THE RESTORATION OR REPLACEMENT OF THE SUB-GRADE DUE TO MOISTURE DAMAGE, CONSTRUCTION TRAFFIC, OR ANY OTHER CAUSE. REPAIR OR REPLACEMENT OF THE SUB-GRADE SHALL BE PERFORMED AT NO ADDITIONAL COST TO THE OWNER.
- 16. UNLESS OTHERWISE NOTED, ALL CONSTRUCTION AND WORKMANSHIP SHALL BE IN ACCORDANCE WITH:

  A. BALTIMORE COUNTY DEPARTMENT OF PUBLIC WORKS STANDARD SPECIFICATIONS FOR
  - CONSTRUCTION MATERIALS, DECEMBER 2007, ERRATA & ADDENDA.

    B. NATURAL RESOURCES CONSERVATION SERVICE OF MARYLAND STANDARDS AND
  - SPECIFICATIONS, POND, CODE 378, JANUARY 2000.

    C. MARYLAND DEPARTMENT OF TRANSPORTATION STATE HIGHWAY ADMNISTRATION, JULY, 2022, STANDARD SPECIFICATIONS FOR CONSTRUCTION AND MATERIALS.
- 17. CONTRACTOR SHALL ADJUST ALL FRAMES, GRATES AND COVERS OF ALL EXISTING UTILITIES WITHIN THE LIMITS OF THE CONTRACT TO THE PROPOSED GRADES, AS REQUIRED.
- 18. THE CONTRACTOR SHALL MAINTAIN POSITIVE DRAINAGE TO SWALES AND/ OR STORM DRAIN
- SYSTEMS AT ALL TIMES.

  19. PAVING REPAIR SHALL BE IN ACCORDANCE WITH BALTIMORE COUNTY STANDARD DETAIL R-38
- 20. ALL NEW CONCRETE SHALL BE SHA MIX NO. 3, 3,500 PSI (MIN.) AT 28 DAYS.
- 21. CONSTRUCTION OF THE PROPOSED ON-SITE UTILITIES WILL BE IN ACCORDANCE WITH THE BALTIMORE COUNTY PLUMBING CODE AND BY A CONTRACTOR PRE-QUALIFIED BY BALTIMORE COUNTY.
- 22. CONTRACTOR SHALL COORDINATE THE LOCATION OF THE UNDERGROUND ELECTRIC SERVICE WITH THE BALTIMORE GAS & ELECTRIC COMPANY. SEE ELECTRICAL PLANS FOR DETAILS.
- 23. UNLESS OTHERWISE NOTED, ALL SEWER PIPE SHALL BE PVC SDR-26 CONFORMING TO THE REQUIREMENTS OF A.S.T.M. SPECIFICATION D-3034.
- 24. SEE STRUCTURAL AND ARCHITECTURAL PLANS FOR SIZE AND LOCATIONS OF TURNED DOWN SLABS AT EXTERIOR DOORS.
- 25. ALL WORK IDENTIFIED AS PUBLIC AND PRIVATE ON THESE PLANS SHALL BE COMPLETED BY THE CONTRACTOR.
- 26. THE AREAS BETWEEN THE SIGHT LINE AND THE CURB LINE MUST BE CLEARED, GRADED AND KEPT FREE OF ANY OBSTRUCTIONS.
- 27. THE CONTRACTOR SHALL PROVIDE A PRIVATE UTILITY LOCATOR TO LOCATE ALL EXISTING UNDERGROUND UTILITIES PRIOR TO BEGINNING ANY CONSTRUCTION.
- 28. TRENCH CRADLE AND ENCASEMENT SHALL BE PER BALTIMORE COUNTY STD. DETAIL G-8.

#### **DEMOLITION NOTES**

- THE CONTRACTOR SHALL NOTIFY "MISS UTILITY" 1-800-257-7777 AT LEAST FIVE (5) WORKING DAYS PRIOR TO STARTING ANY WORK.
- 2. TOPOGRAPHIC INFORMATION SHOWN HEREON IS BASED ON AVAILABLE AS-BUILT PLANS PROVIDED BY BALTIMORE COUNTY DEPARTMENT OF PUBLIC WORKS AND BALTIMORE COUNTY DPW, A SUPPLEMENTAL SURVEY CONDUCTED BY PRECISION MAPPING AND SURVEYING DIRING APPIL 2022
- 3. EXISTING UTILITY INFORMATION SHOWN HEREON IS BASED ON THE BEST AVAILABLE INFORMATION, WHICH INCLUDES A FIELD SURVEY CONDUCTED BY PRECISION MAPPING AND SURVEYING, DURING APRIL, 2022. AS-BUILT WATER, WASTEWATER AND STORM DRAIN PLANS FROM BALTIMORE COUNTY DEPARTMENT OF PUBLIC WORKS AND BALTIMORE GAS AND ELECTRIC COMPANY PLANS.
- 4. OBSTRUCTIONS SHOWN ON THIS DRAWING ARE FOR THE CONVENIENCE OF THE CONTRACTOR ONLY. MK CONSULTING ENGINEERS, LLC. DOES NOT WARRANT OR GUARANTEE THE CORRECTNESS OR THE COMPLETENESS OF THE INFORMATION GIVEN. THE CONTRACTOR MUST VERIFY ALL SUCH INFORMATION TO HIS OWN SATISFACTION. IN THE EVENT THAT INFORMATION IS IN CONFLICT WITH INFORMATION OUTLINED, THE CONTRACTOR SHALL IMMEDIATELY BRING IT TO THE ATTENTION OF THE ARCHITECT PRIOR TO STARTING ANY WORK.
- 5. CONTRACTOR SHALL VERIFY LOCATION AND ELEVATION OF EXISTING UTILITIES SHOWN HEREON BEFORE STARTING ANY WORK ON THESE PLANS. CONTRACTOR AGREES TO BE FULLY RESPONSIBLE FOR THE COST OF ANY AND ALL DAMAGES WHICH OCCUR AS A RESULT OF A FAILURE TO EXACTLY LOCATE AND PRESERVE ANY AND ALL EXISTING UTILITIES INDICATED TO REMAIN.
- 6. ALL WORK SHALL BE ACCOMPLISHED IN ACCORDANCE WITH THE CONTRACT
- CONTRACTOR SHALL ADJUST ALL FRAMES, GRATES AND COVERS OF ALL EXISTING UTILITIES WITHIN THE LIMITS OF THE CONTRACT TO THE PROPOSED GRADES AS REQUIRED.
- 8. THE CONTRACTOR SHALL MAINTAIN POSITIVE DRAINAGE AWAY FROM STRUCTURES
- 9. CONTRACTOR SHALL COORDINATE ALL DISCONNECTIONS AND REMOVAL OF EXISTING GAS, ELECTRIC AND TELEPHONE SERVICES AND EQUIPMENT WITH BALTIMORE GAS & ELECTRIC, VERIZON.
- IO. CONTRACTOR SHALL REMOVE AND DISPOSE OF ALL EXISTING MECHANICAL AND ELECTRICAL EQUIPMENT AND ACCESSORIES NOT REMOVED BY LOCAL UTILITY COMPANIES, OR SPECIFIED TO BE REMOVED BY OWNER.
- II. ALL EXCAVATION SHALL BE BACKFILLED IN ACCORDANCE WITH THE PROJECT SPECIFICATIONS. IN THE EVENT THAT A PORTION OF A UTILITY IS TO BE REMOVED THE CONTRACTOR SHALL TERMINATE AND CAP TO THE LIMITS INDICATED IN
- 12. IT SHALL BE DISTINCTLY UNDERSTOOD THAT FAILURE TO MENTION SPECIFICALLY ANY WORK WHICH WOULD NORMALLY BE REQUIRED TO COMPLETE THIS PROJECT SHALL NOT RELIEVE THE CONTRACTOR OF HIS RESPONSIBILITY TO COMPLETE

ACCORDANCE WITH ALL STATE AND LOCAL REQUIREMENTS.

- 13. IT SHALL BE THE RESPONSIBILITY OF THE CONTRACTOR TO NOTIFY THE ENGINEER OF ANY DEVIATION FROM THIS PLAN PRIOR TO ANY CHANGE BEING MADE. ANY DEVIATION FROM THIS PLAN WITHOUT WRITTEN AUTHORIZATION FROM THE ENGINEER WILL BE THE RESPONSIBILITY OF THE CONTRACTOR.
- 14. SHOULD THE CONTRACTOR DISCOVER DISCREPANCIES BETWEEN THE PLANS AND FIELD CONDITIONS, THE ENGINEER IS TO BE NOTIFIED IMMEDIATELY TO RESOLVE THE SITUATION. SHOULD THE CONTRACTOR MAKE FIELD CORRECTIONS OR ADJUSTMENTS WITHOUT NOTIFYING THE ENGINEER, THEN THE CONTRACTOR ASSUMES ALL RESPONSIBILITY FOR THOSE CHANGES.
- 15. CONTRACTOR SHALL SECURE THE CONSTRUCTION AREA AT THE END OF EACH WORKING DAY AND WILL INSPECT THE SECURITY FENCING TO INSURE ITS INTEGRITY.
- I6. ALL CONSTRUCTION DEBRIS WILL BE REMOVED FROM THE SITE AND TAKEN TO AN APPROVED, PERMITTED DISPOSAL FACILITY. NO RUBBLE IS TO BE LEFT ON SITE.
- 17. CONTRACTOR SHALL INSPECT AND TAKE PICTURES OF ADJACENT BUILDING WALLS PRIOR TO THE COMMENCEMENT OF ANY DEMOLITION ON THE SITE. EXISTING WALL CRACKS (IF ANY) WILL BE NOTED.
- 18. CONTRACTOR SHALL CONTINUALLY MONITOR THE WALLS OF THE ADJACENT BUILDINGS FOR ANY SIGNS OF STRUCTURAL DISTRESS. IF ANY DISTRESS IS NOTED, CONTRACTOR SHALL STOP WORK IMMEDIATELY AND NOTIFY OWNER.
- 19. CONTRACTOR SHALL NOT EXPOSE, UNDERMINE, OR IMPACT THE ZONE OF INFLUENCE FOR FOOTINGS AND FOUNDATIONS OF ADJACENT BUILDINGS. CONTRACTOR WILL BE RESPONSIBLE FOR THE COST TO REPAIR ADJACENT BUILDINGS THAT ARE DAMAGED DUE TO HIS OPERATION.
- 20. CONTRACTOR SHALL PROVIDE THE NECESSARY MEANS TO CONTROL DUST AND MAINTAIN BALTIMORE COUNTY AIR QUALITY STANDARDS DURING THE DEMOLITION
- AND REMOVAL OF SITE DEBRIS AND THE NEW CONSTRUCTION.

  21. CONTRACTOR SHALL SAWCUT EXISTING PAVING TO MINIMIZE DAMAGE TO EXISTING
- 22. CONTRACTOR SHALL REMOVE EXISTING CURBS & CONCRETE WALKS TO THE NEAREST JOINT. NO PATCHING WILL BE PERMITTED.

PAVING REMAINING.

- 23. THE DEMOLITION INFORMATION SHOWN ON THIS DRAWINGS IS FOR THE CONVENIENCE OF THE CONTRACTOR ONLY. IT IS THE CONTRACTORS RESPONSIBILITY TO DETERMINE THE EXACT LIMITS OF DEMOLITION AND REMOVAL OF AFFECTED SITE ITEMS.
- 24. CONTRACTOR SHALL PROVIDE 8' HIGH TEMPORARY CONSTRUCTION FENCE AROUND THE LIMITS OF DISTURBANCE AS REQUIRED. REFER TO THE EROSION AND SEDIMENT CONTROL PLANS FOR LOCATIONS OF LOD DURING PHASES.
- 25. THE CONTRACTOR SHALL PROVIDE A PRIVATE UTILITY LOCATOR TO LOCATE ALL EXISTING UNDERGROUND UTILITIES PRIOR TO BEGINNING ANY CONSTRUCTION.

#### SPECIAL DEMOLITION AND CONSTRUCTION NOTES

- . ALL EXISTING WALL, FOOTING, AND BUILDING INFORMATION IS TAKEN FROM RECORD DRAWINGS LABELED "FULLERTON FIRE STATION FOR BALTIMORE COUNTY" DATED 10/21/1971.
- . CONTRACTOR SHALL TAKE MEASURE TO PROTECT EXISTING BUILDING, INCLUDING BUT NOT LIMITED TO WALLS, WINDOWS, DOORS, AND BUILDING FOUNDATIONS. CONTRACTOR TO TAKE CARE AND USE MEASURES TO MINIMIZE VIBRATIONS TO NOT DAMAGE EXISTING BUILDING DURING DEMOLITION AND CONSTRUCTION.

SUBDIVISION: FULLERTON

#### **UTILITY NOTES**

- I. CONTRACTOR SHOULD OPEN ONLY THAT SECTION OF TRENCH THAT CAN BE BACKFILLED AND STABILIZED EACH DAY. IF TRENCH MUST REMAIN OPEN LONGER THAN ONE DAY, SILT FENCE MUST BE PLACED BELOW (DOWN SLOPE) THE TRENCH.
- 2. PLACE ALL EXCAVATED MATERIAL ON UPHILL SIDE OF THE TRENCH.
- 3. ANY SEDIMENT CONTROLS DISTURBED BY UTILITY CONSTRUCTION ARE TO BE REPAIRED IMMEDIATELY.
- 4. FIRE LINE CONSTRUCTION SHALL BE ACCOMPLISHED IN ACCORDANCE WITH N.F.P.A. 24.
- 5. UNLESS OTHERWISE NOTED, PIPE ELEVATIONS FOR WATER MAINS REFER TO TOP OF PIPE AND SANITARY SEWER ELEVATIONS REFER TO THE INVERT.
- 6. ALL WATER PIPING, TUBING, FITTINGS AND JOINING METHODS SHALL BE ACCORDING TO THE FOLLOWING APPLICATIONS:
- 4 INCHES (DN 100) TO 8 INCHES (DN 200): CLASS 250, DUCTILE IRON PIPE, DUCTILE IRON COMPACT FITTINGS AND MECHANICAL JOINTS WITH RETAINER GLANDS.
- 7. UNLESS OTHERWISE NOTED, ALL SEWER PIPE SHALL BE PVC SDR-26 CONFORMING TO THE REQUIREMENTS OF A.S.T.M. SPECIFICATION D-3034.
- 8. ALL UTILITY STRUCTURE DIMENSIONS SHALL REFER TO THE CENTERLINE OF THE "STRUCTURES"
- 9. ALL CLEANOUTS LOCATED IN PAVED AREAS SHALL HAVE COUNTERSUNK LIDS.
- IO. SEE MECHANICAL, ELECTRICAL AND PLUMBING PLANS FOR CONTINUATION OF UTILITY CONNECTIONS TO BUILDING AND SITE LIGHTING INFORMATION.
- II. CONTRACTOR SHALL CONNECT ALL ON-SITE UTILITIES TO THE PROPOSED BUILDING CONNECTIONS AS
- 12. SEE MECHANICAL, ELECTRICAL, PLUMBING PLANS FOR GAS, ELECTRIC AND UTILITIES LOCATED WITHIN 5' OF THE BUILDING FOOTPRINT.
- 13. OBSTRUCTIONS SHOWN ON THIS DRAWING ARE FOR THE CONVENIENCE OF THE CONTRACTOR ONLY. MK CONSULTING ENGINEERS, LLC. DOES NOT WARRANT OR GUARANTEE THE CORRECTNESS OR THE COMPLETENESS OF THE INFORMATION GIVEN.
- 14. THE CONTRACTOR MUST VERIFY ALL SUCH INFORMATION TO HIS OWN SATISFACTION
- 15. CONTRACTOR SHALL CALL "MISS UTILITY" (800-257-7777) AT LEAST FIVE (5) WORKING DAYS PRIOR TO STARTING WORK.
- 16. CONSTRUCTION OF THE PROPOSED UTILITIES WILL BE IN ACCORDANCE WITH THE BALTIMORE COUNTY PLUMBING CODE AND BY A QUALIFIED CONTRACTOR.
- 17. NO WORK IS TO COMMENCE UNTIL ALL PERMITS HAVE BEEN OBTAINED.
- 18. CONTRACTOR SHALL TEST PIT FOR LOCATION OF EXISTING UTILITIES PRIOR TO STARTING CONSTRUCTION.
- 19. EXISTING CURB AND GUTTER & CONCRETE SIDEWALK SHALL BE REMOVED TO THE NEAREST JOINT. NO PATCHING SHALL BE PERMITTED.
- 20. SHOULD THE CONTRACTOR DISCOVER DISCREPANCIES BETWEEN THE PLANS AND FIELD CONDITIONS THE ENGINEER IS TO BE NOTIFIED IMMEDIATELY TO RESOLVE THE SITUATION.
- 21. CONTRACTOR SHALL COORDINATE THE LOCATION OF THE UNDERGROUND ELECTRIC SERVICE AND THE UNDERGROUND GAS SERVICE WITH THE BALTIMORE GAS, ELECTRIC COMPANY. SEE ELECTRICAL PLANS
- 22. CONTRACTOR SHALL ADJUST TOP OF EXISTING UTILITIES, I.E. MANHOLE FRAME AND COVER, INLET GRATES, ETC. TO FINISHED GRADE.
- 23. ON SITE FIRE HYDRANTS ARE TO BE PAINTED RED AND FIRE HYDRANTS STEAMER NOZZLE TO FACE DRIVE AISLES.
- 24. ALL EXCAVATION SHALL BE BACKFILLED IN ACCORDANCE WITH THE PROJECT SPECIFICATIONS. IN THE EVENT THAT A PORTION OF A UTILITY IS TO BE REMOVED, THE CONTRACTOR SHALL TERMINATE AND CAP TO THE LIMITS INDICATED IN ACCORDANCE WITH ALL STATE AND LOCAL REQUIREMENTS.
- 25. THE CONTRACTOR IS RESPONSIBLE FOR PERFORMING ALL WORK SHOWN ON THESE DRAWINGS UNLESS OTHERWISE NOTED.
- 26. IT SHALL BE THE RESPONSIBILITY OF THE CONTRACTOR TO NOTIFY THE ENGINEER OF ANY DEVIATION FROM THE PLANS PRIOR TO ANY CHANGE BEING MADE. ANY DEVIATION FROM THIS PLAN WITHOUT WRITTEN AUTHORIZATION FROM THE ENGINEER WILL BE THE RESPONSIBILITY OF THE CONTRACTOR.
- 27. PRIOR TO BEGINNING ANY UTILITY CONSTRUCTION THE CONTRACTOR SHALL VERIFY THAT ALL EXISTING UTILITIES WILL TIE IN WITH PROPOSED UTILITIES AS SHOWN.
- 28. ALL VALVES SHALL BE IN STANDARD CONCRETE VAULTS IN ACCORDANCE WITH BALTIMORE COUNTY STANDARD DETAILS.
- 29. ALL PUBLIC WORK IDENTIFIED ON THESE PLANS IS SUBJECT TO A BALTIMORE COUNTY UTILITY AGREEMENT AND SHALL BE PERFORMED BY A BALTIMORE COUNTY PREQUALIFIED CONTRACTOR HAVING PREQUALIFICATIONS AI, A2, B, FI, F2, F3 AND E.
- 30. THE CONTRACTOR SHALL PROVIDE A PRIVATE UTILITY LOCATOR TO LOCATE ALL EXISTING UNDERGROUND UTILITIES PRIOR TO BEGINNING ANY CONSTRUCTION.
- 31. TRENCH CRADLE AND ENCASEMENT SHALL BE PER BALTIMORE COUNTY STD. DETAIL 6-8.

#### CONCRETE RETAINING WALL NOTES

- I. SPECIFICATIONS TO BE PER MDOT SHA STANDARD SPECIFICATIONS FOR CONSTRUCTION AND MATERIALS.
- 2. CONCRETE SHALL BE SHA MIX NO. 3 (3500 PSI) EXCEPT AS NOTED.
- 3. REINFORCING STEEL SHALL CONFORM TO A 615, GRADE 60. ALL SPLICES, NOT SHOWN, SHALL BE LAPPED AS PER BAR LAP CHARTS. MINIMUM COVER FOR ANY BAR SHALL BE 2" UNLESS OTHERWISE NOTED, WITH THE EXCEPTION OF BARS AT THE BOTTOM AND SIDES OF ALL FOOTINGS WHICH SHALL HAVE 3" MINIMUM COVER.
- 4. ALL DIMENSIONS AFFECTED BY THE GEOMETRY AND/OR LOCATION OF THE EXISTING STRUCTURES: EXISTING STRUCTURES SHALL BE CHECKED IN THE FIELD BY THE CONTRACTOR BEFORE ANY MATERIAL IS ORDERED OR FABRICATED OR CONSTRUCTION BEGINS.
- 5. CONCRETE FORMLINER TO BE UTILIZED WHEN POURING RETAINING WALL. MODEL #1206 ROYALITE STONE, HIGH STRENGTH URETHANE ELASTOMERIC REUSABLE FORMS, AS MANUFACTURED BY CUSTOM ROCK, ST. PAUL, MN 1-800-637-2447. PATTERN SHALL CONTINUOUSLY WRAP AROUND OUTSIDE AND INSIDE CORNERS, AND BE EXPOSED ON INTERIOR AND EXTERIOR FACE OF WALL ABOVE FINISHED GRADE. FINISHED STONE PATTERN SHALL BE STAINED FOR COLORIZATION ACCORDING TO THE SPECIFICATIONS.

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	I HEREBY CERTIFY THAT THESE DOCUMENTS WI APPROVED BY ME, AND THAT I AM A DULY LICEN		BID / PEF	RMIT		03/01/25	-	MSW	27NE21	PLAN SCALE:		APPROVED BY: Mihai T Petrisor
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	MARYLAND. LICENSE NO. 25058 EXPIRATION DATE: 11-17-26						-	-	-	PROFILE SCALE:	-	DATE: 03/26/2025
11111	CIVIL ENGINEER MARIANNE CRAMPTON, PE	DGN BY: MC	BUREAU OF ENGINEERING AND CONSTRUCTION		HIGH	WAYS	STRUCTURES	STORM DRAINS	SEWER	WATER	FIELD ENGINEER	PROPERTY MANAGEMENT
PRINCIPAL  MK CONSULTING ENGINEERS, LLC 1801 PORTER STREET, SUITE 401 BALTIMORE, MD 21230 (P) 667-309-6193 EMAIL: MCRAMPTON@MKCENG.COM	MK CONSULTING ENGINEERS, LLC	DWN BY: SG	REVIEWED BY:									APPROVED BY:CHIE
	BALTIMORE, MD 21230 (P) 667-309-6193	CHKD BY: MC	DATE REVIEWED:									DATE:

BALTIMORE COUNTY OFFICE OF BUDGET AND FINANCE, PROPERTY MANAGEMENT

FULLERTON FIRE STATION #8 - RENOVATION & ADDITION

GENERAL NOTES

4401 FITCH AVENUE, NOTTINGHAM, MARYLAND, 21236

C1.01

SHEET DESIGNATION

CIVIL ENGINEER

JOB ORDER NUMBER

241-220-0054-0012


SHEET 6 of 58


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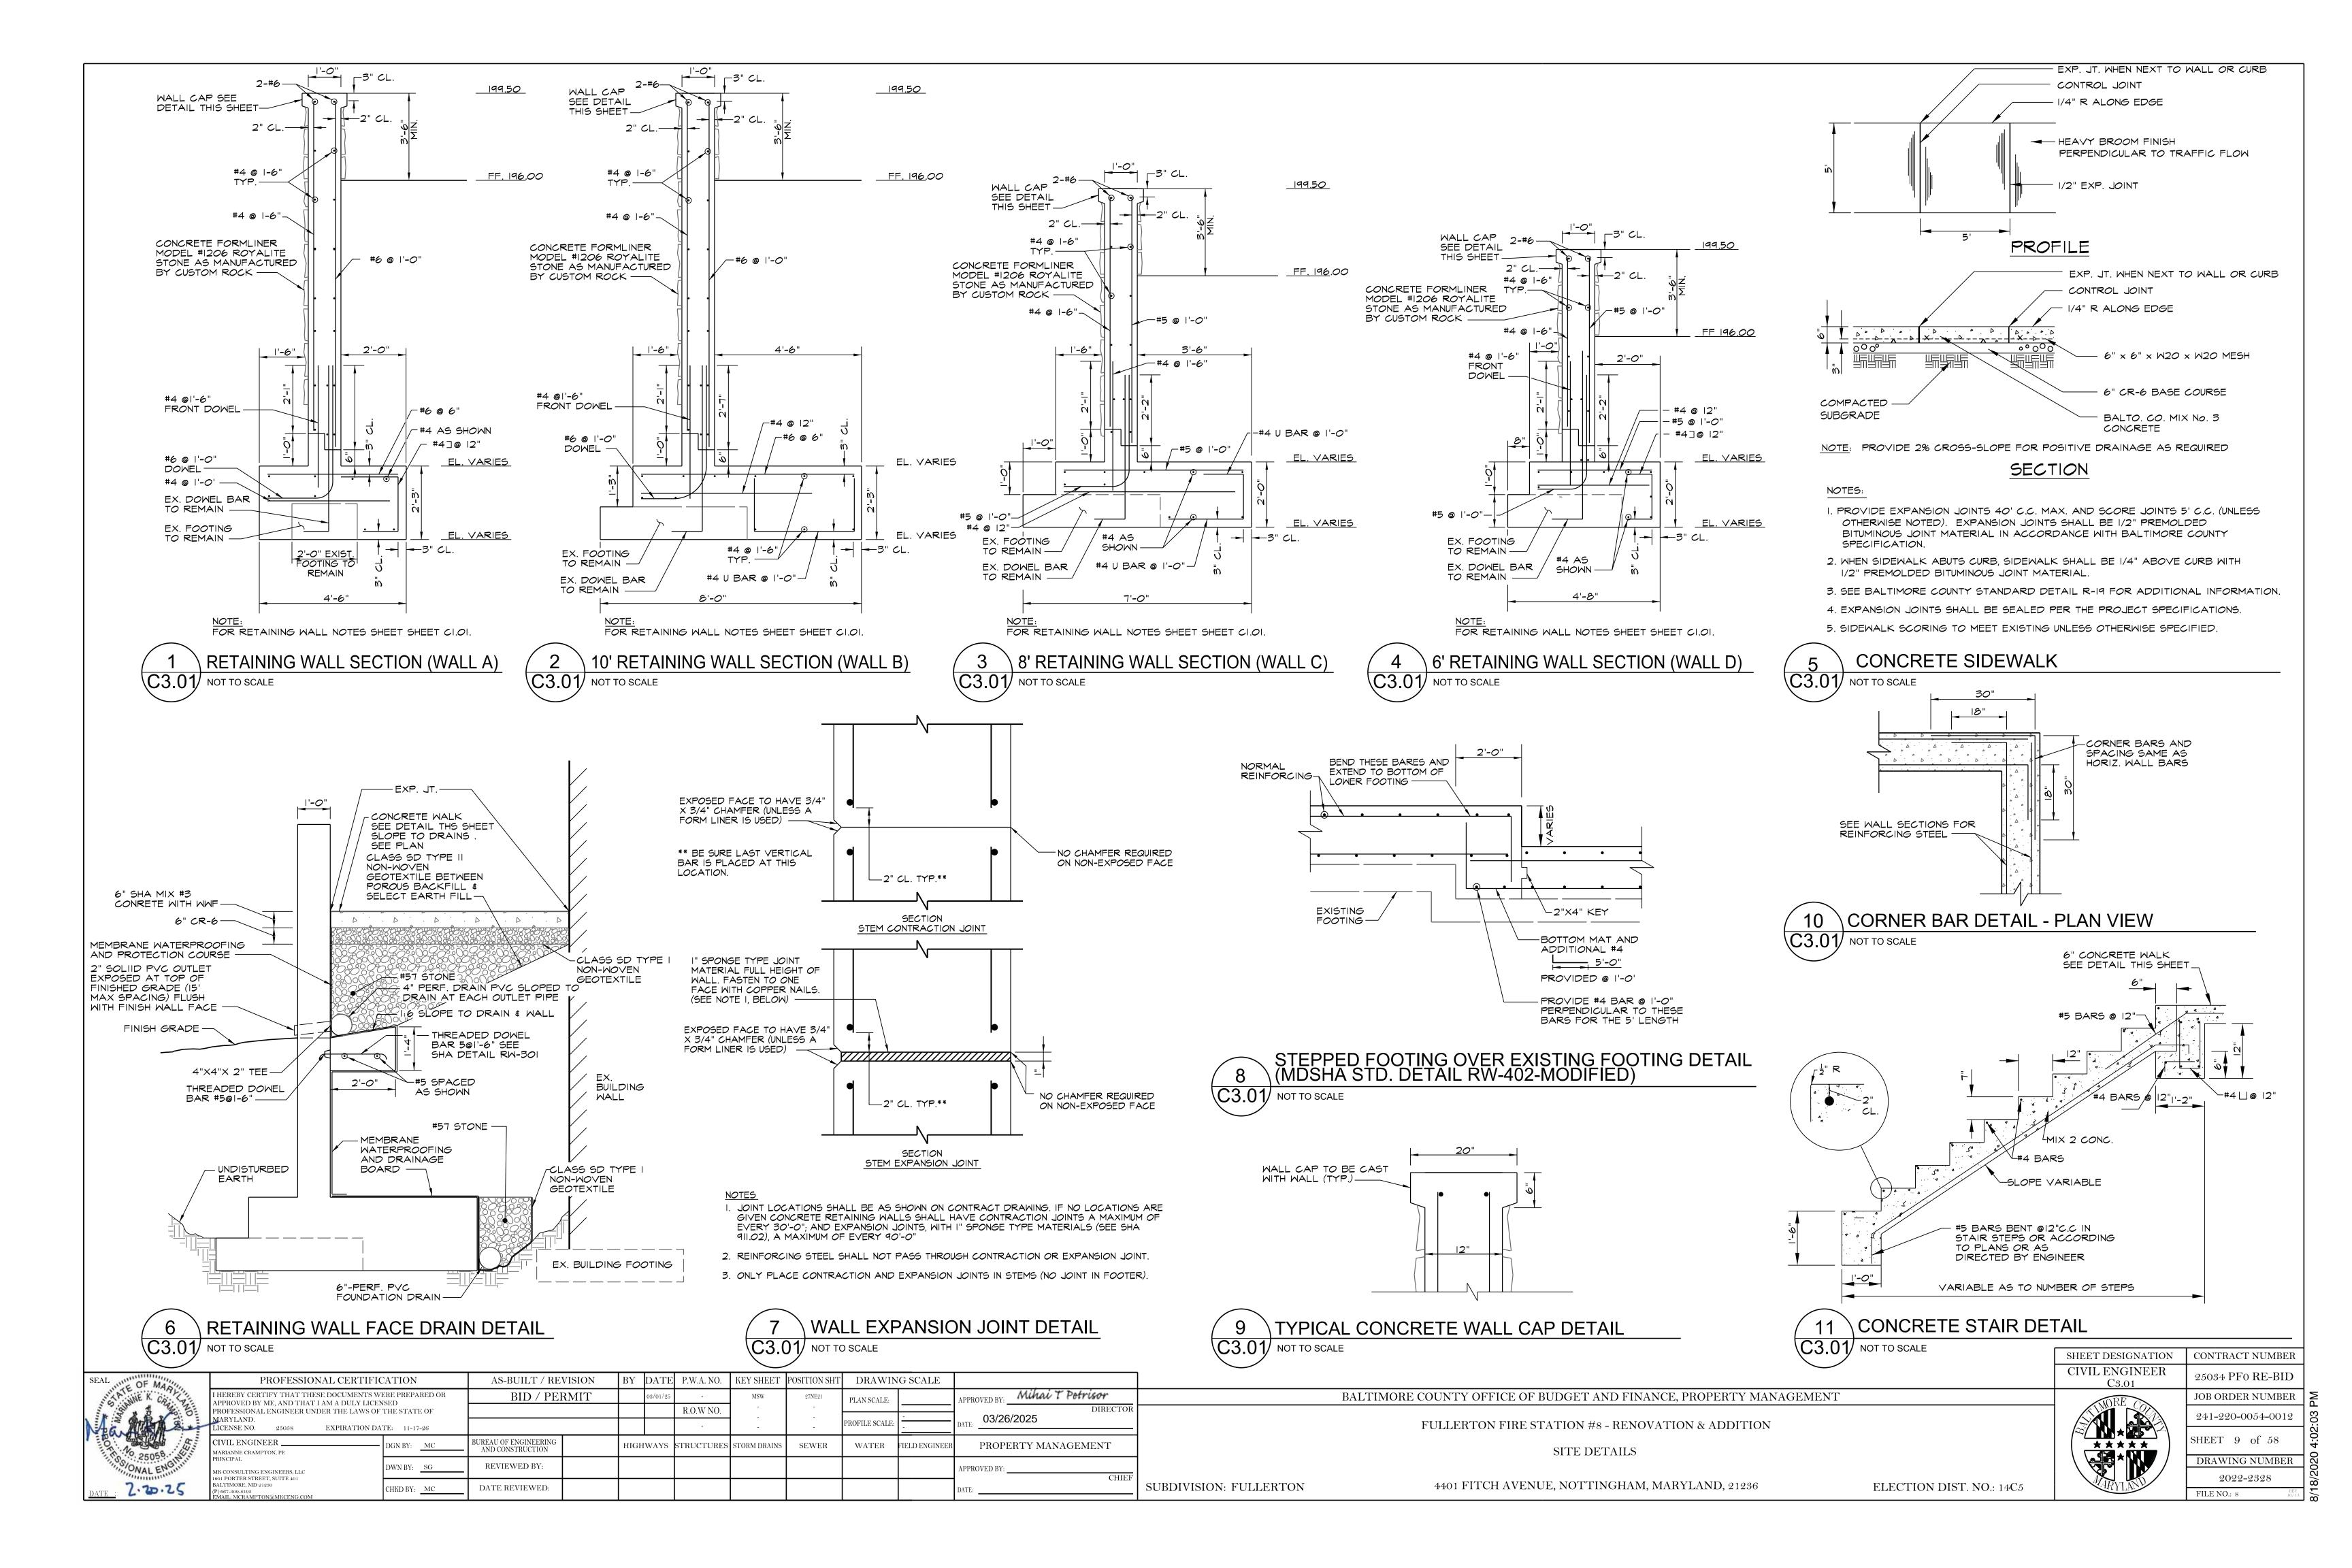
FILE NO.: 8


2022-2325


CONTRACT NUMBER



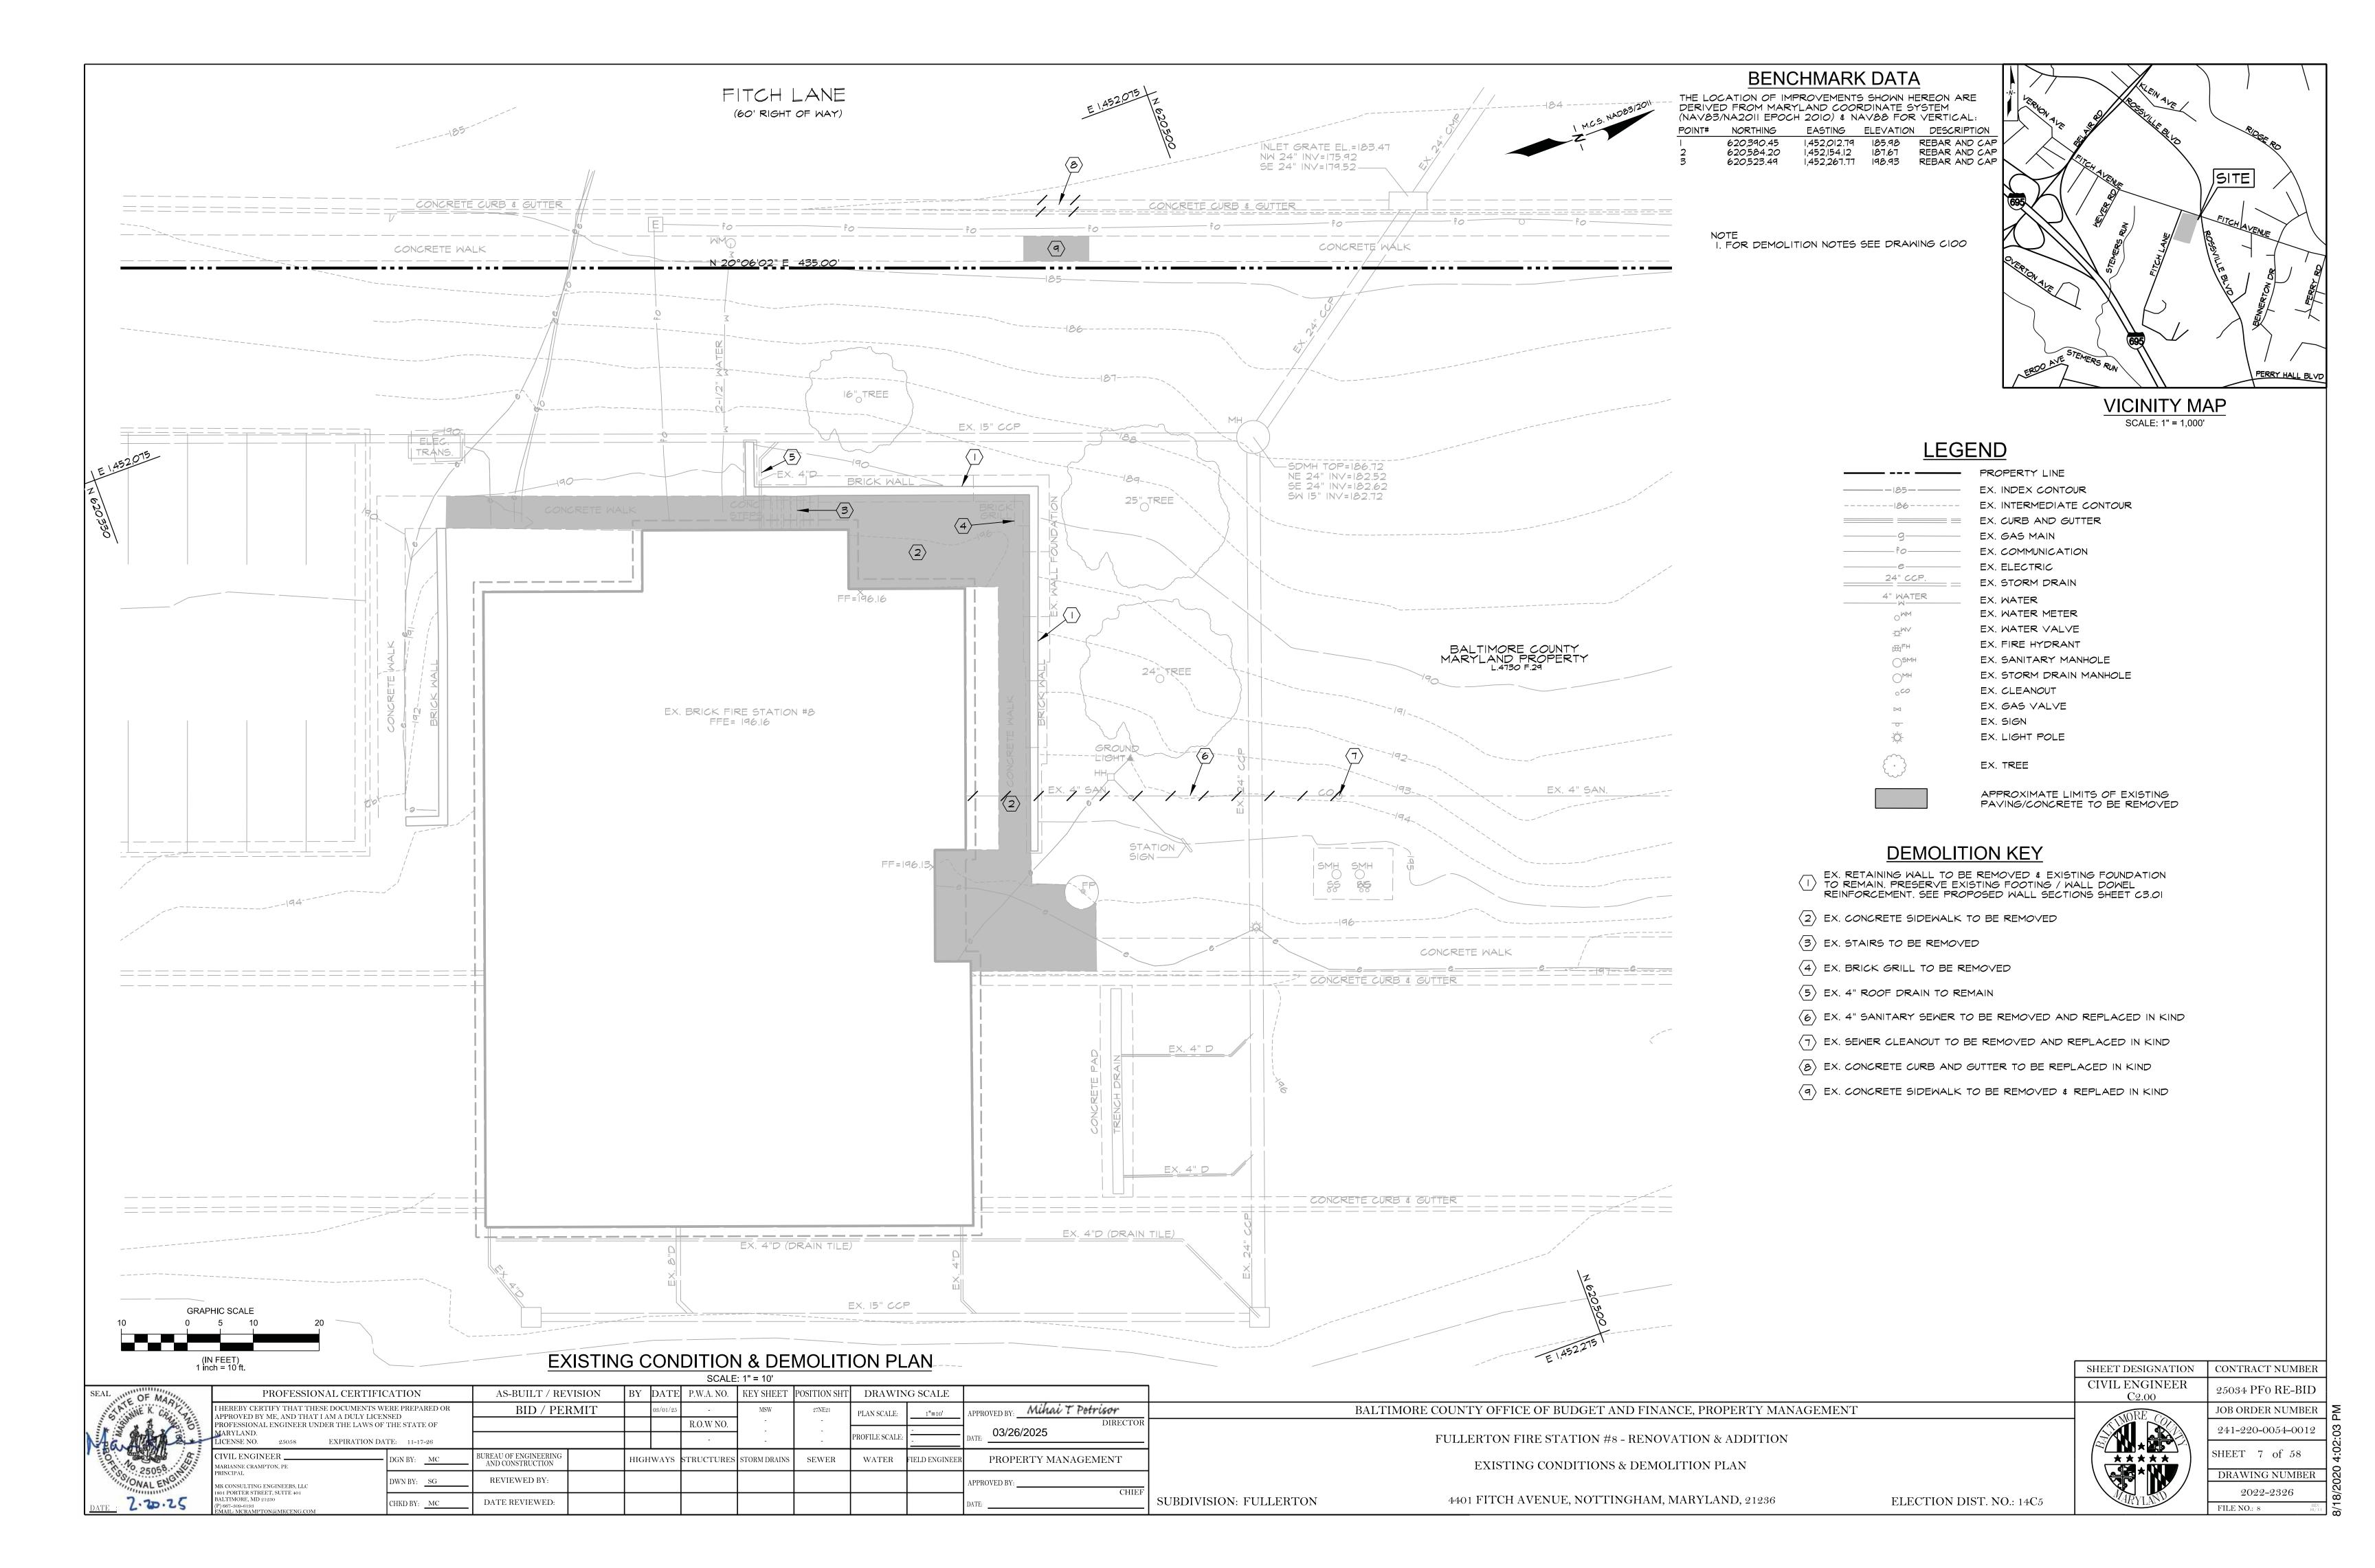


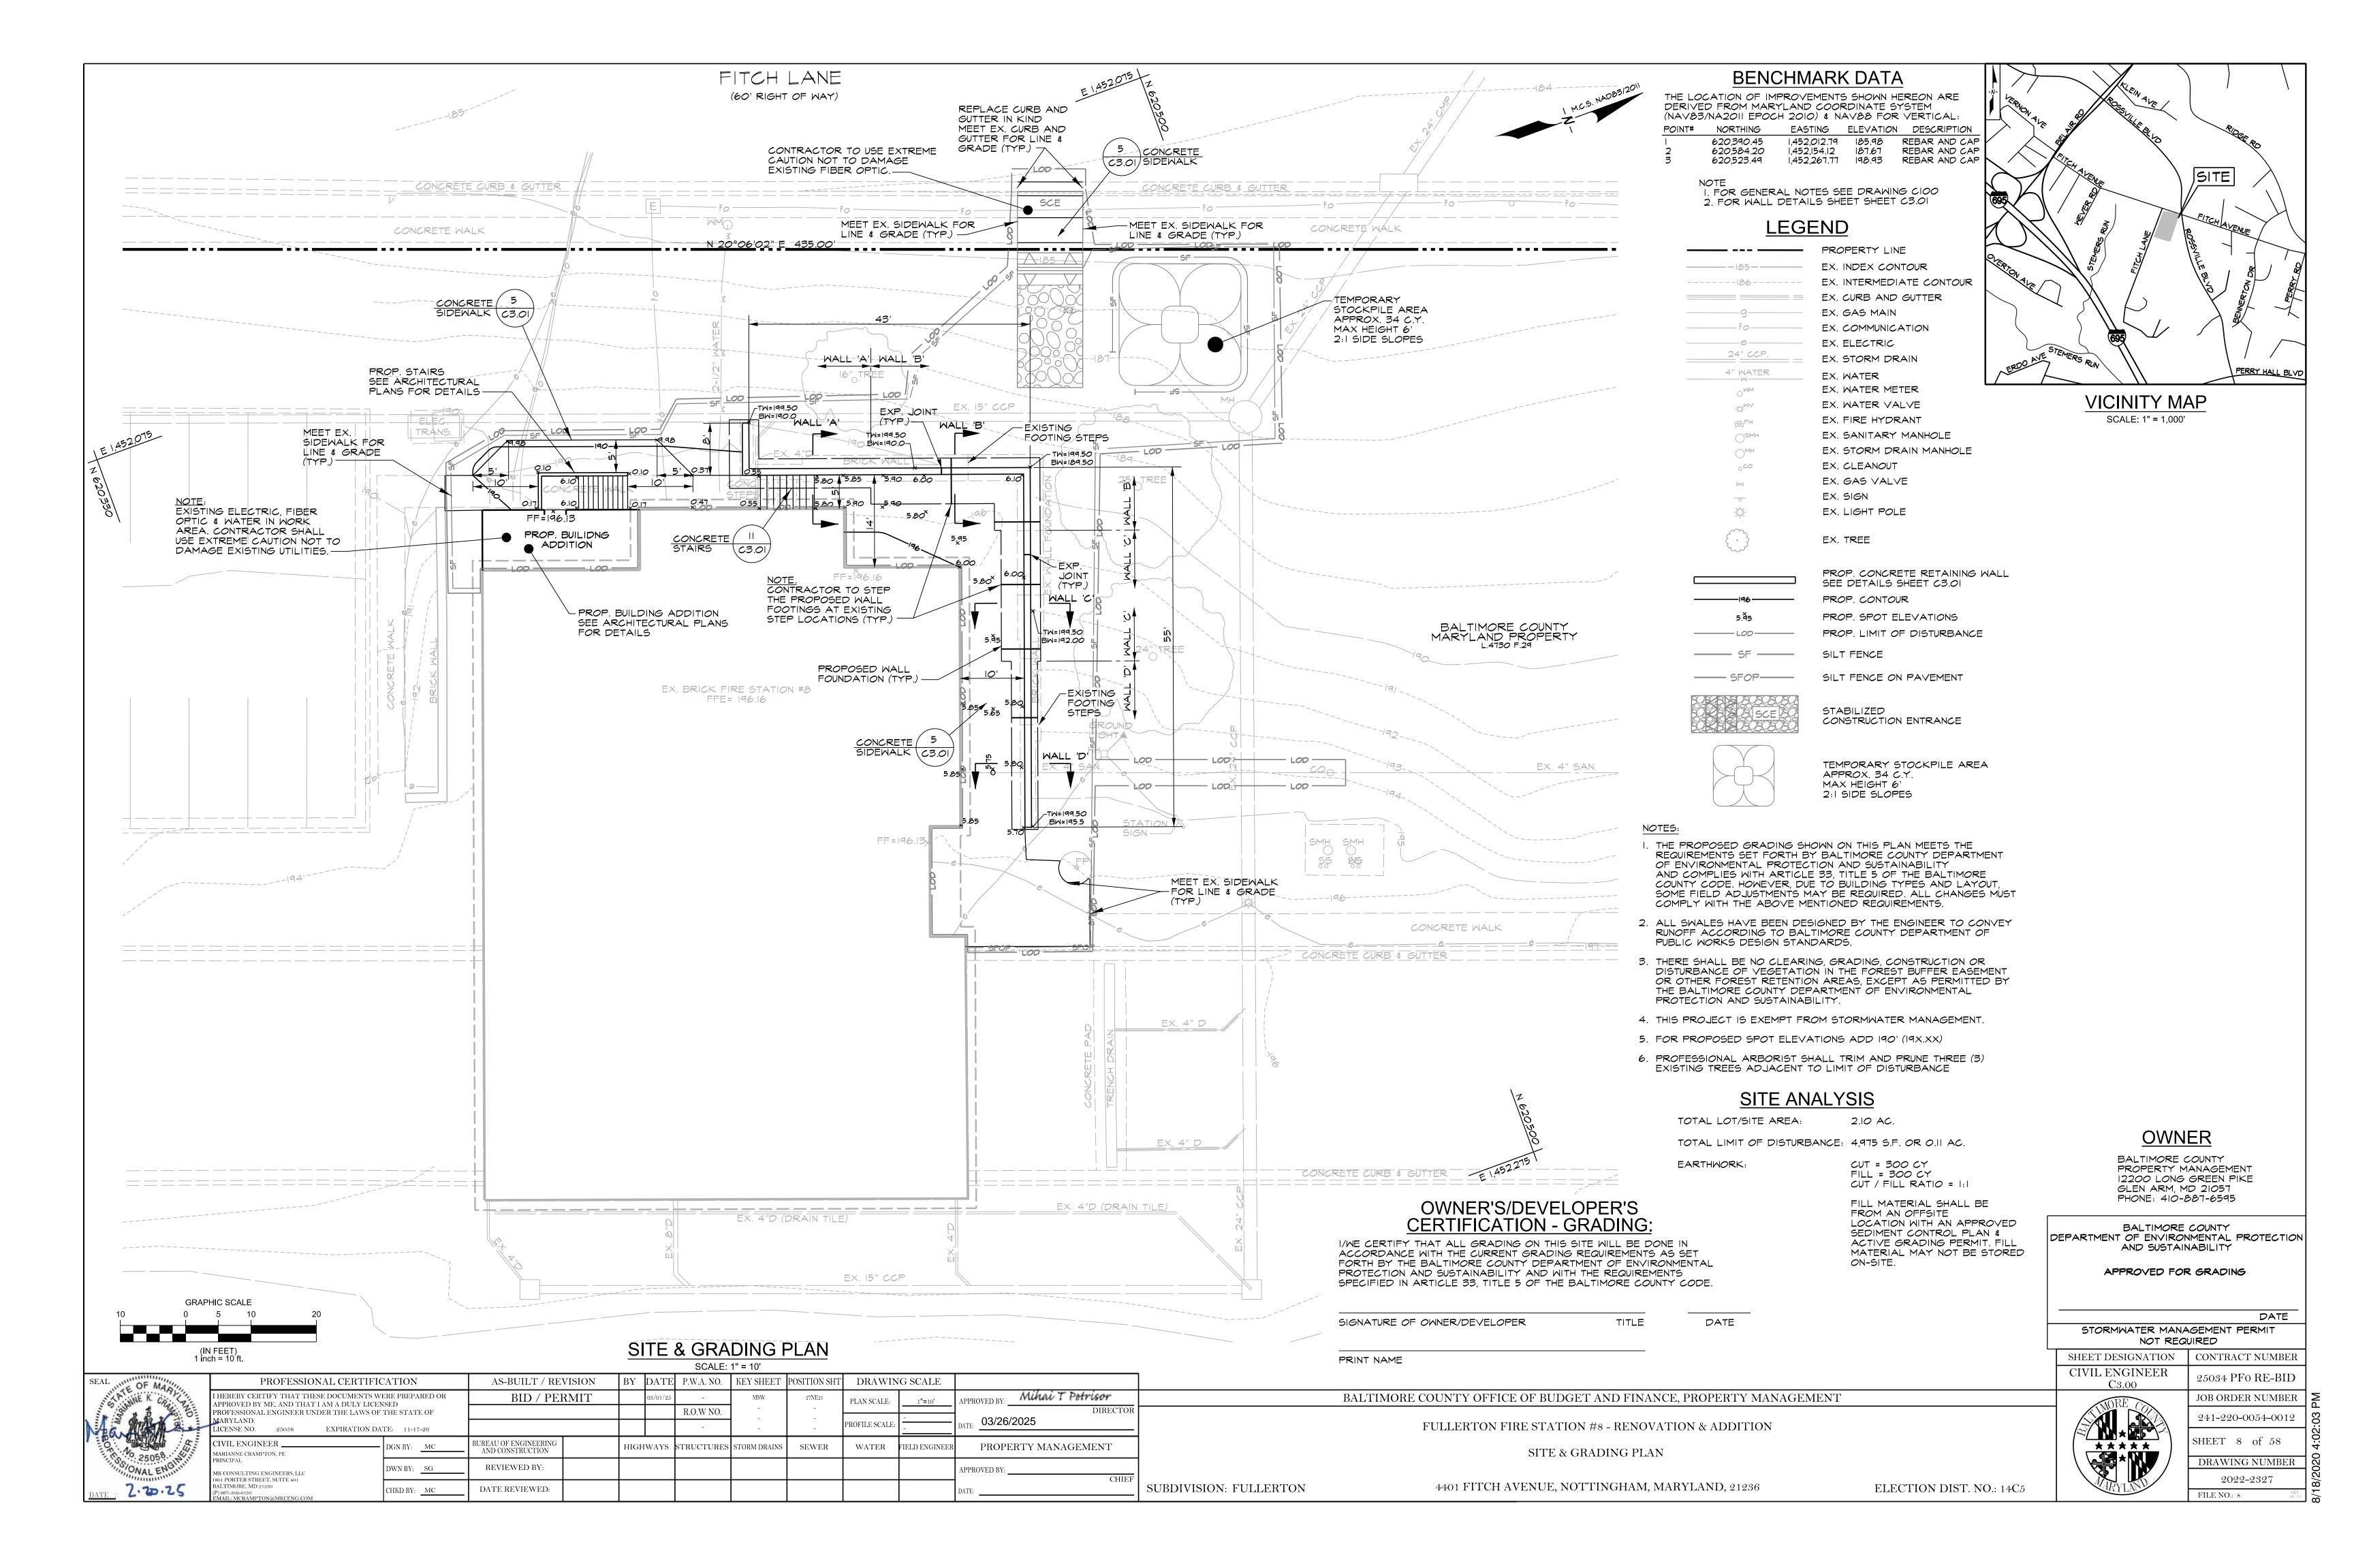

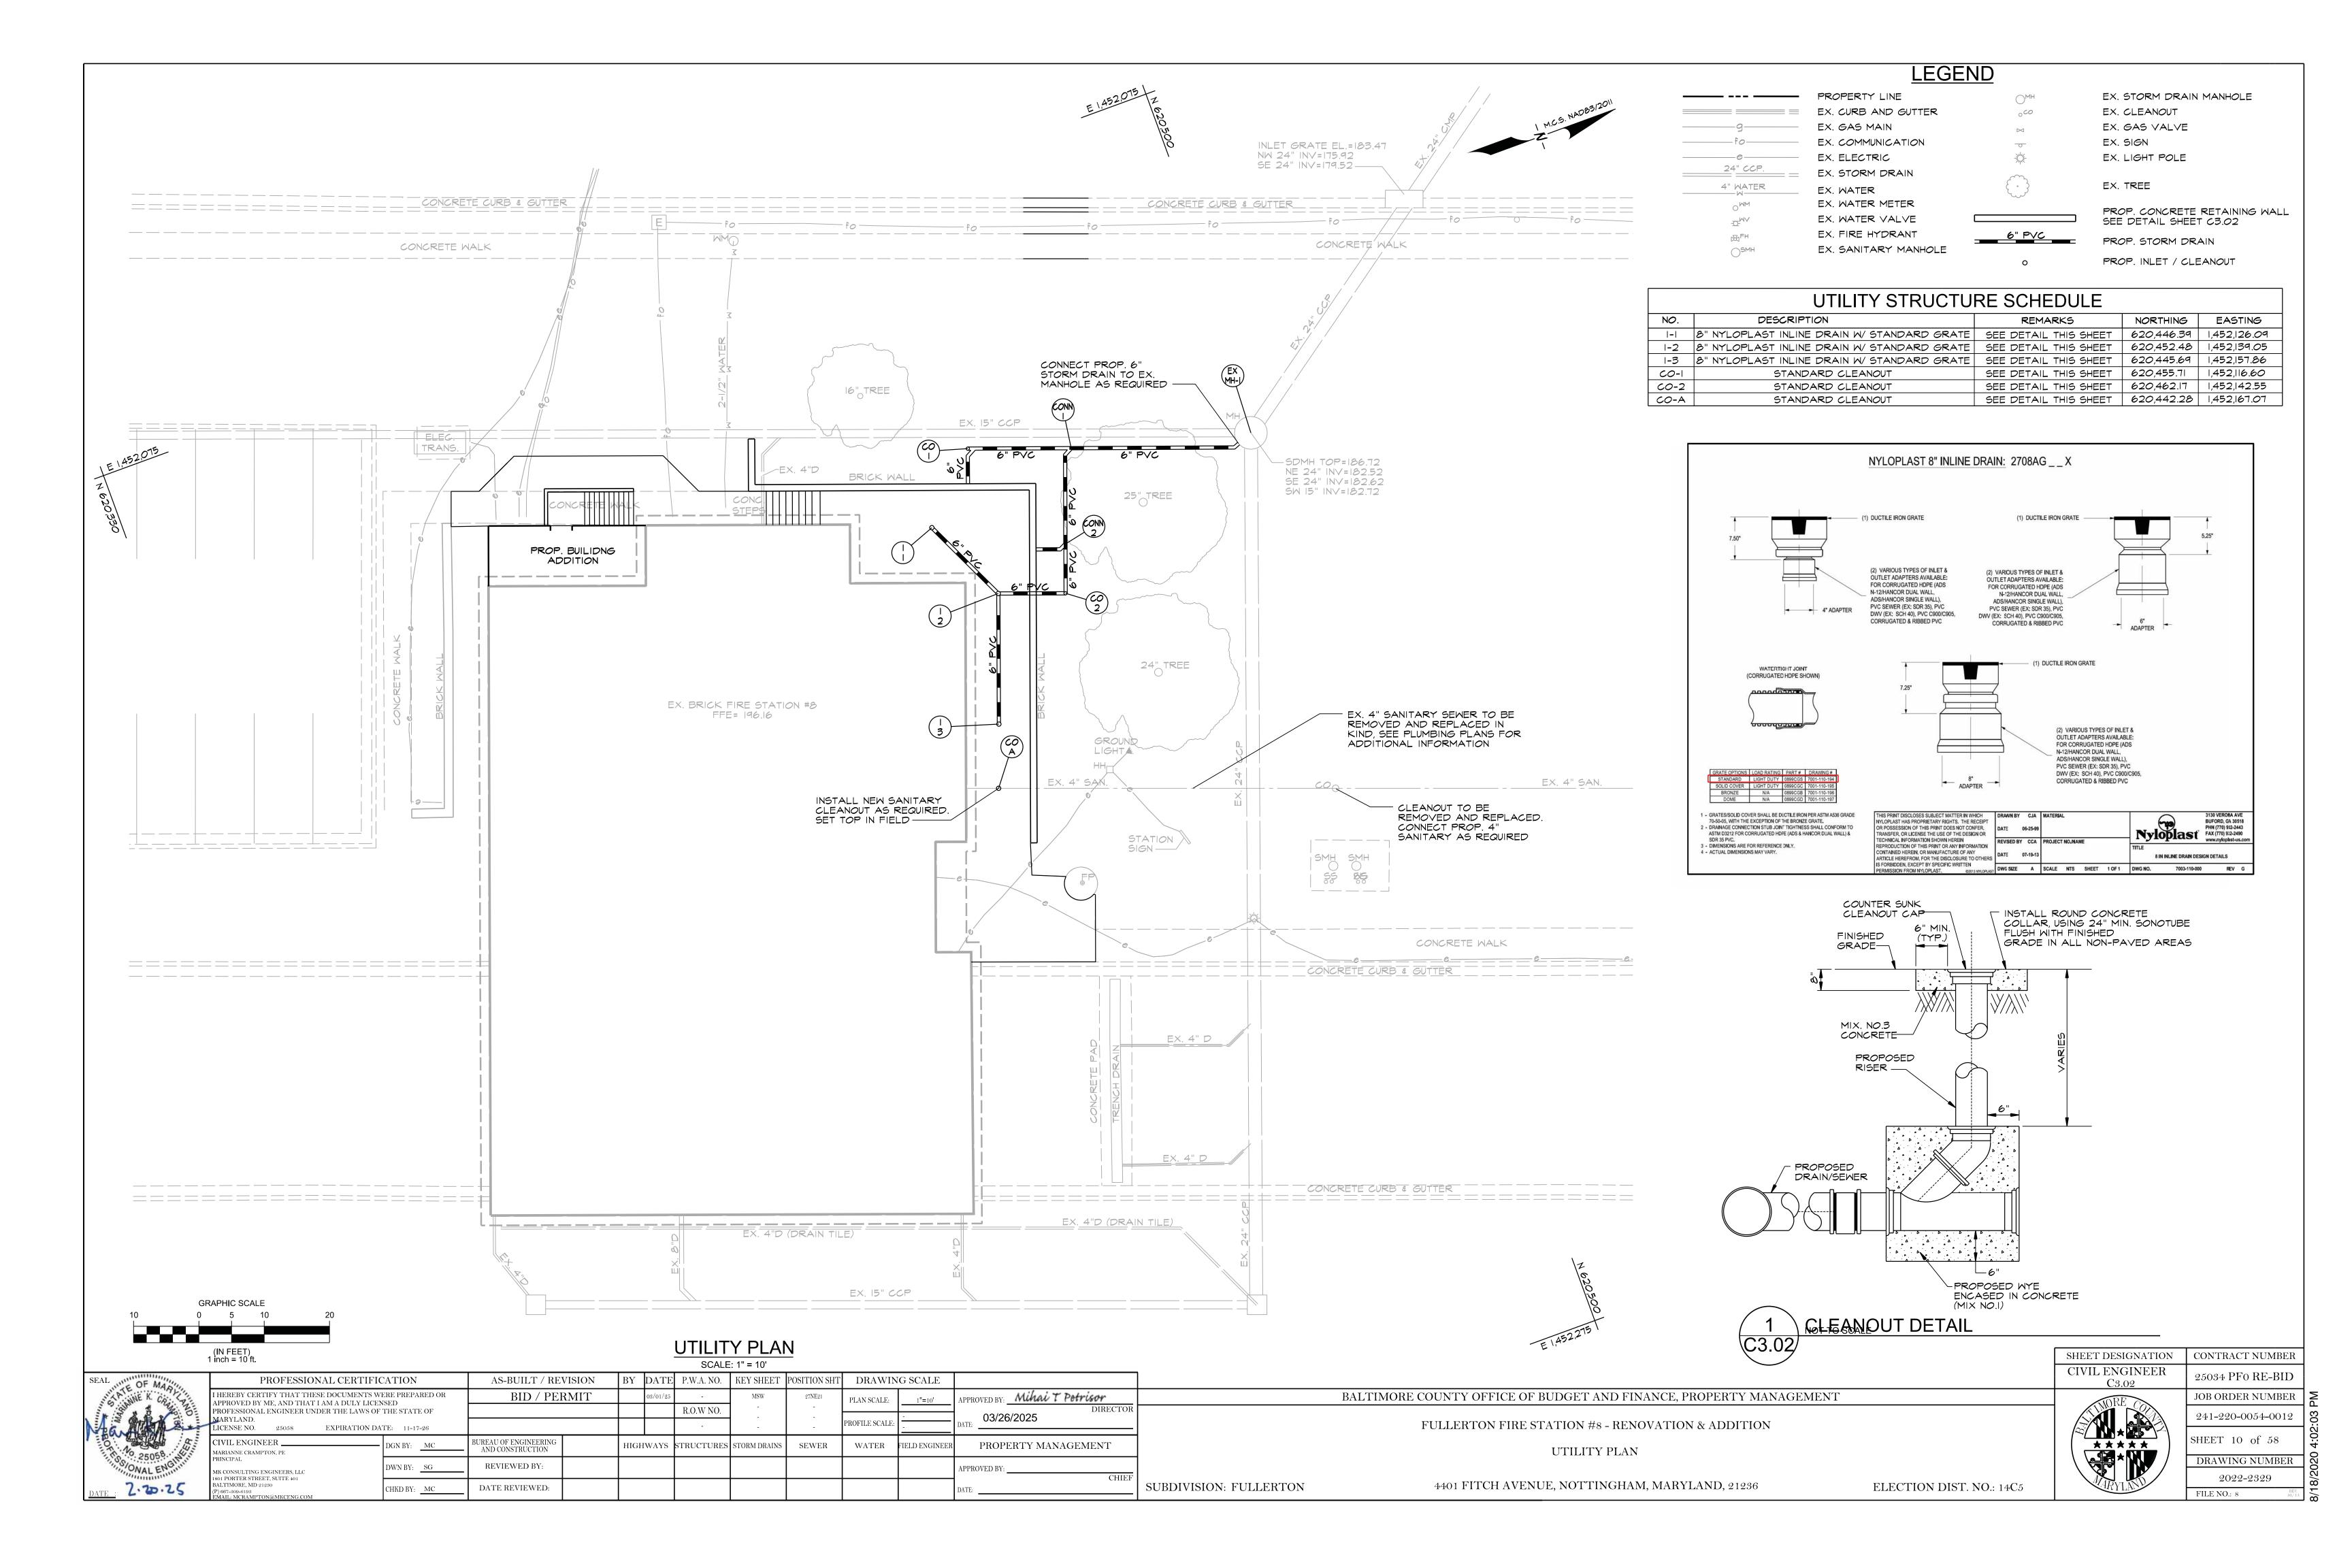

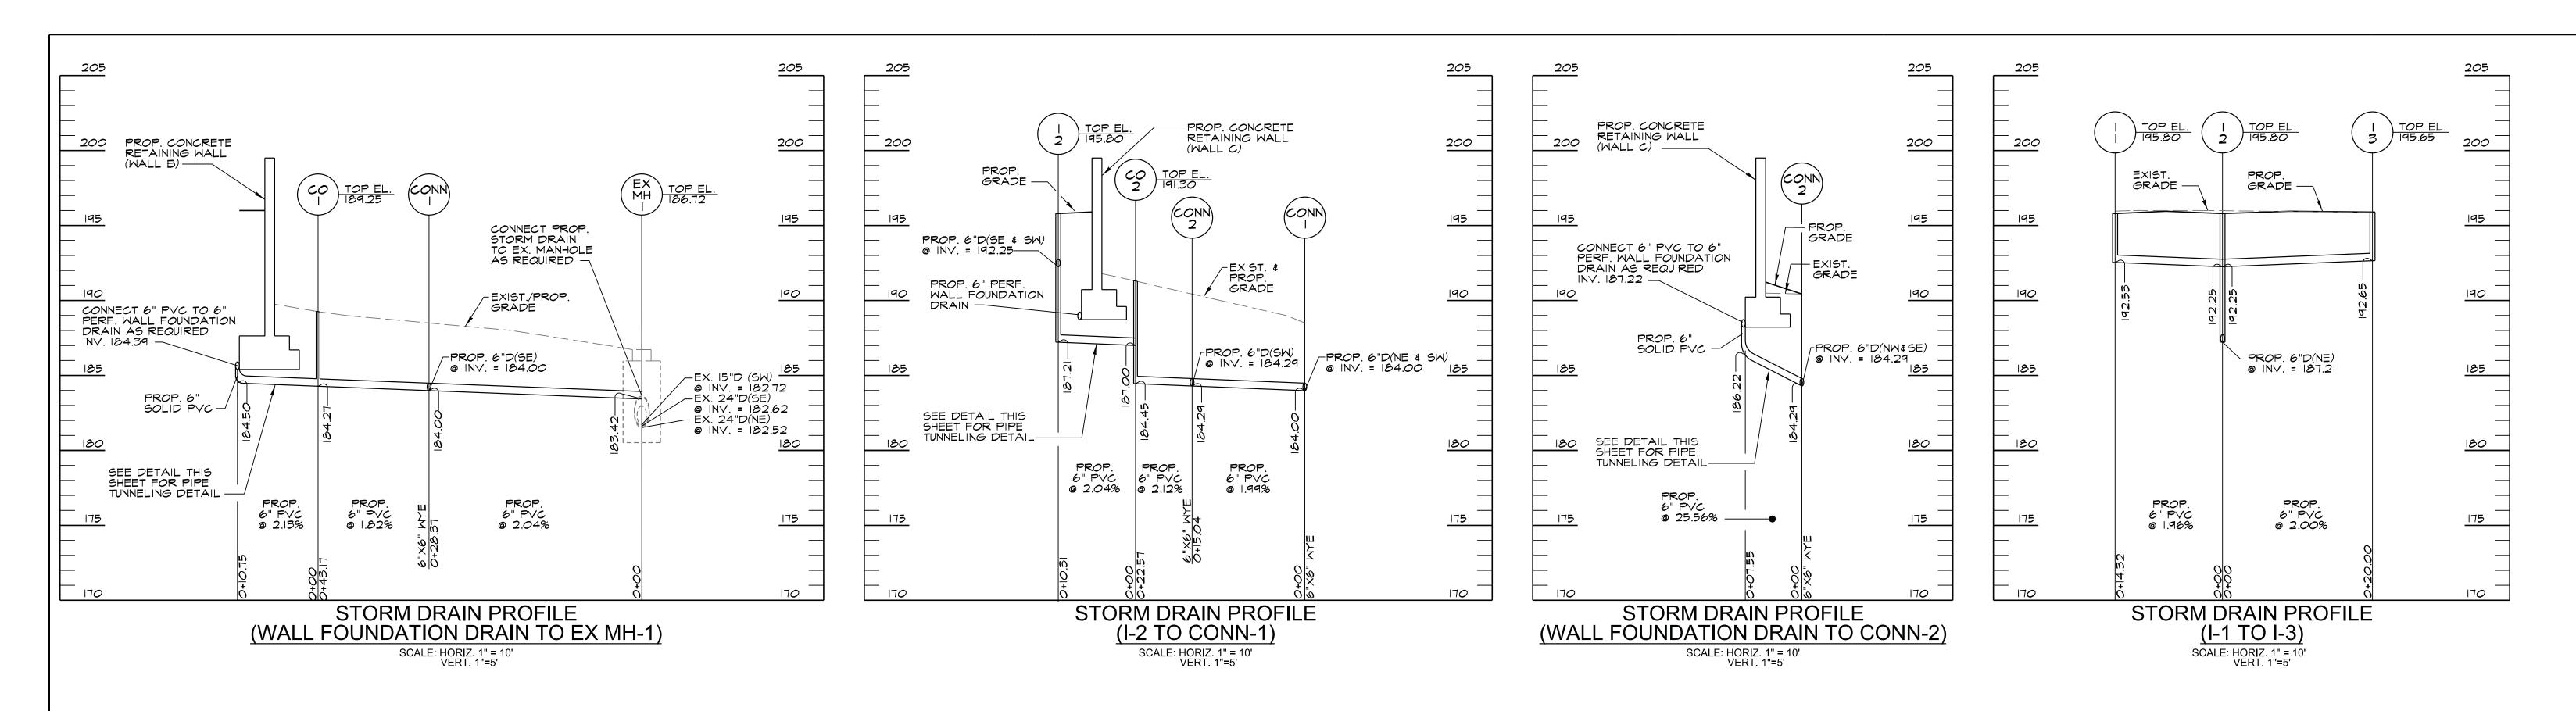

SUBDIVISION: FULLERTON

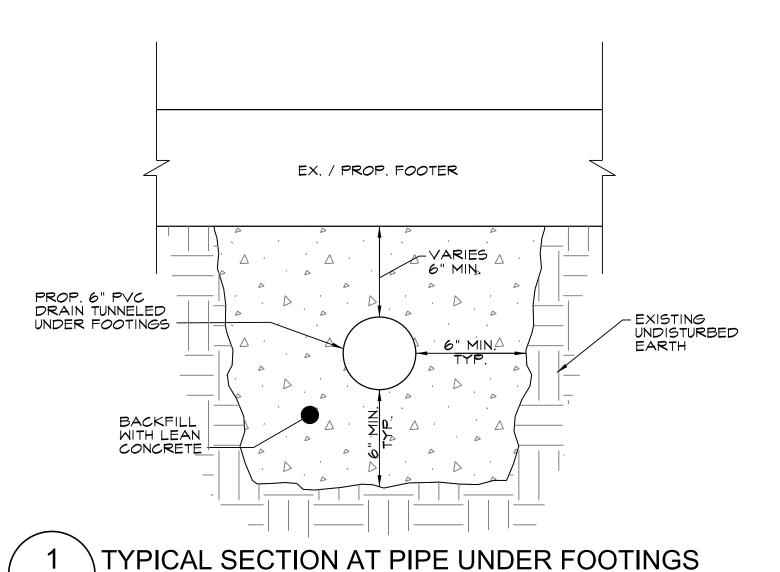

C3.03 NOT TO SCALE

BY DATE P.W.A. NO. KEY SHEET POSITION SHT DRAWING SCALE PROFESSIONAL CERTIFICATION APPROVED BY: Mihai T Petrisor BID / PERMIT HEREBY CERTIFY THAT THESE DOCUMENTS WERE PREPARED OR APPROVED BY ME, AND THAT I AM A DULY LICENSED PROFESSIONAL ENGINEER UNDER THE LAWS OF THE STATE OF R.O.W NO. 03/26/2025 BUREAU OF ENGINEERING AND CONSTRUCTION PROPERTY MANAGEMENT HIGHWAYS STRUCTURES STORM DRAINS ARIANNE CRAMPTON, PE REVIEWED BY: MK CONSULTING ENGINEERS, LLC 1801 PORTER STREET, SUITE 401 2.20.25 ALTIMORE, MD 21230 DATE REVIEWED:

BALTIMORE COUNTY OFFICE OF BUDGET AND FINANCE, PROPERTY MANAGEMENT


FULLERTON FIRE STATION #8 - RENOVATION & ADDITION


STORM DRAIN PROFILES

SHEET DESIGNATION CONTRACT NUMBER CIVIL ENGINEER C3.03 25034 PF0 RE-BID JOB ORDER NUMBER 241-220-0054-0012 SHEET 11 of 58 DRAWING NUMBER 2022-2330

FILE NO.: 8

401 FITCH AVENUE, NOTTINGHAM, MARYLAND, 21236	ELECTION DIST. NO.: 14C5

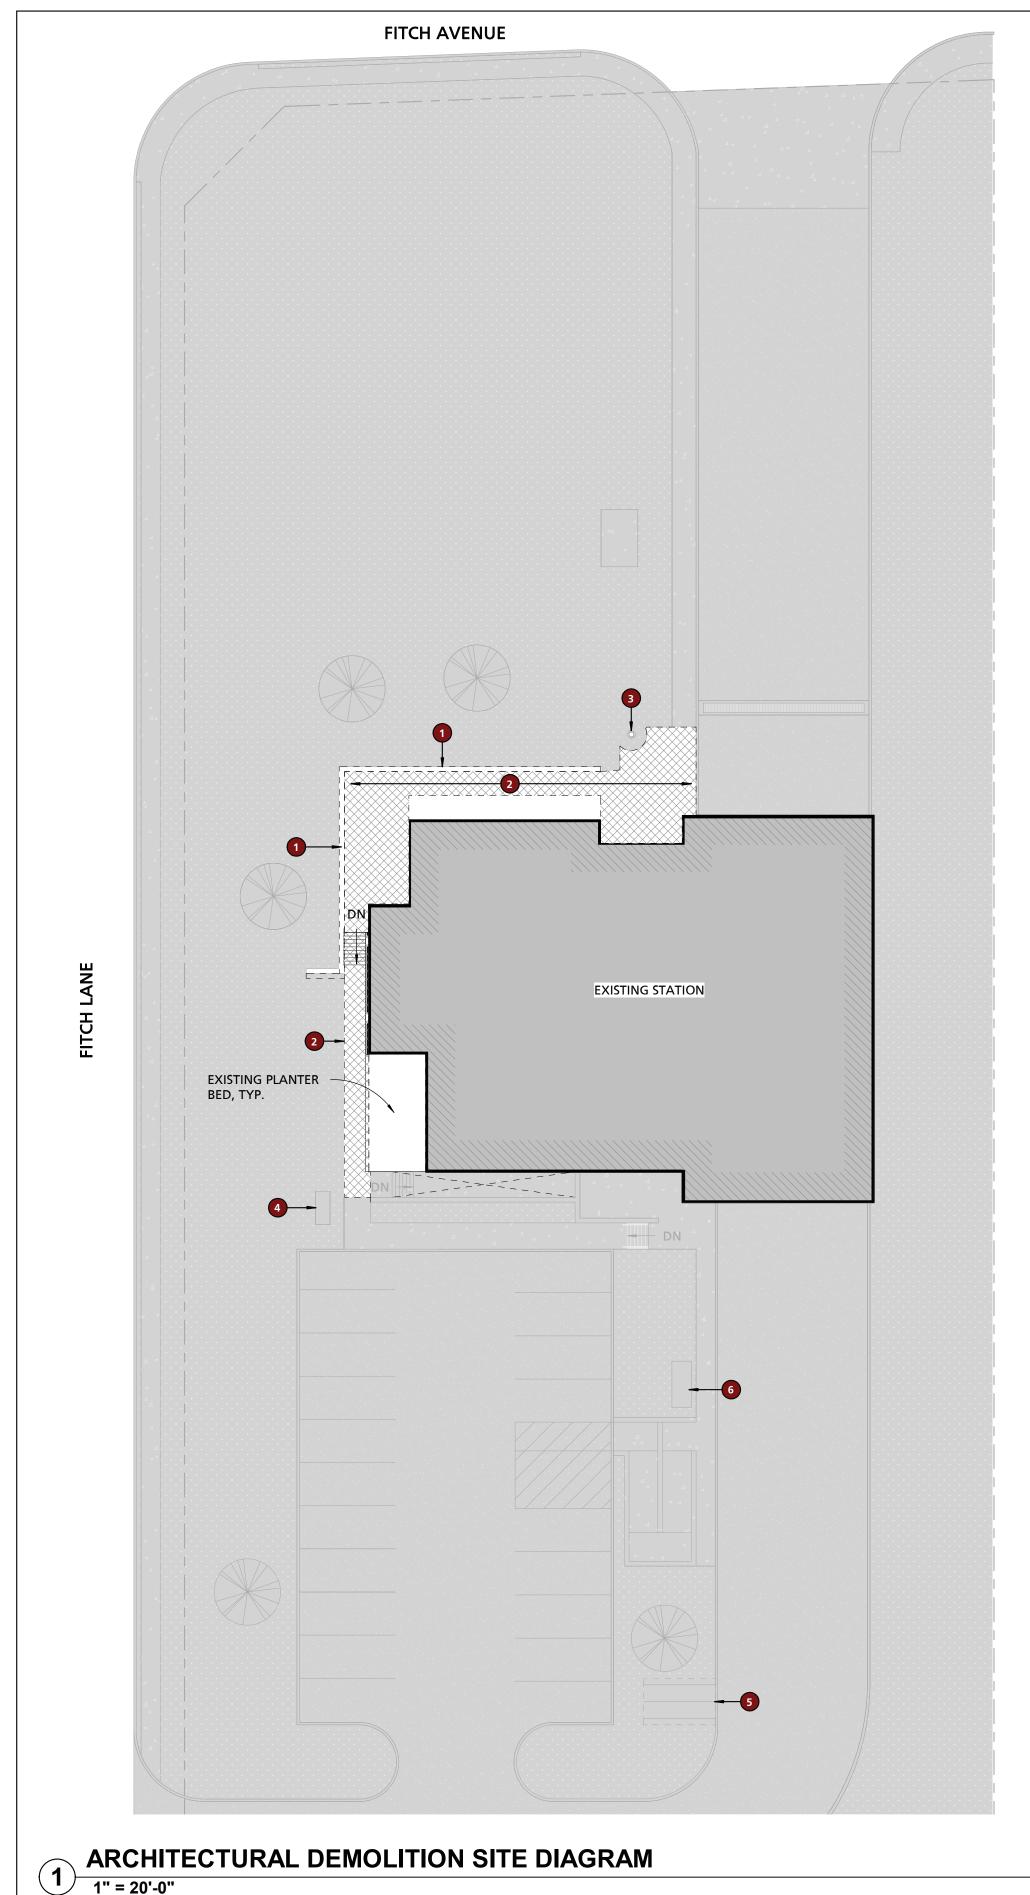

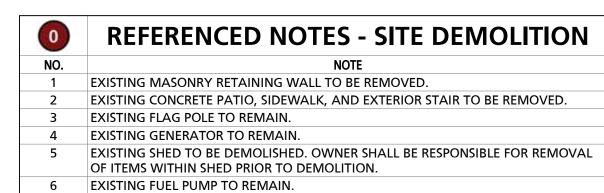

**LEGEND** EXISTING ELEMENTS TO REMAIN CONCRETE PATIO TO BE REMOVED 

TRAILER 3 PRIVACY FENCE -TRAILER 2 RAMP UP TRAILER 1 TO TRAILER (14) CONTROL JOINTS EQUALLY SPACED EXISTING STATION PROPOSED ADDITION SHED LOCATION

FITCH AVENUE

**TYPICAL REFERENCE NOTES - SITE DIAGRAM** CONCRETE PATIO & CAST-IN-PLACE CONCRETE RETAINING WALL. 2 LOCATION FOR TEMPORARY LIVING FACILITY TRAILERS. CONTRACTOR TO PROVIDE TRAILERS WITH TEMPORARY WATER, SANITARY, ELECTRIC, THROUGHOUT THE DURATION OF CONSTRUCTION. 3 ALIGN CONTROL JOINTS WITH BUILDING EDGE 4 GRAVEL PAD AREA FOR STORAGE SHED. GRAVEL PAD AREA SHALL BE MADE LEVEL AS NECESSARY WITH PRESSURE TREATED 6x6 KNEE WALL. GRAVEL TO BE COMPACTED #57 STONE 5 PRE-FABRICATED WOODEN STORAGE SHED PROVIDED BY CONTRACTOR. CONTRACTOR SHALL CONFIRM FINAL LAYOUT AND LOCATION OF SHED WITH COUNTY PRIOR TO INSTALLATION OF GRAVEL PAD/SHED. 6 CONTRACTOR TO DEMO 6' OF EXISTING CURB AND REPOUR CURB AS DEPRESSED CURB. DEPRESSED CURB LOCATION TO ALIGN WITH OPENING OF STORAGE SHED. CAST IN PLACE CONCRETE STAIR 8 FRONT RESPONSE APRON MUST STAY CLEAR OF ALL CONSTRUCTION OPERATIONS DURING ENTIRE CONSTURCTION PROCCESS. 9 COUNTY TO PROVIDE TEMPORARY DATA, TELEPHONE, CABLE, AND FIREHOUSE ALERTING SYSTEM TO TEMPORARY LIVING FACILITIES. 10 EXISTING PARKING AREA MUST BE KEPT CLEAR OF ALL CONSTRUCTION ACTIVITIES TO ENSURE PARKING IS AVAILABLE TO FIRE DEPARTMENT PERSONNEL. 11 TEMPORARY WALKWAY TO BE DEMOLISHED AFTER CONSTRUCTION, REGRADED AND SEEDED TO TURN BACK INTO LAWN

#### TRAILER BASIS OF DESIGN REQUIREMENTS AS PROVIDED BY CONTRACTOR

#### TRAILER 1 - LOUNGE: APPROX. 25'x50' LOUNGE AREA FOR 11 RECLINERS SMALL KITCHENETTE (4 BURNER STOVE W/ OVEN, ONCE COMPARTMENT EXTA DEEP SINK, (2) FULL REFRIGERATOR, FREEZER, (2) MICROWAVE. 2 OFFICES TO FIT A DESK W/ COMPUTER AND PHONE, 2 CHAIRS, FILE CABINET AND BED TEMPORARY CONDUIT W/ STRINGS, SIZED PER CODE, FROM EXISTING NETWORK TO TRAILER 1 TO ACCOMODATE TELECOM REQUIREMENTS. CONTRACTOR TO COORDINATE WITH OIT. TEMPORARY CONDUIT W/ STRINGS, SIZED PER CODE, FROM EXISTING COMMAND CENTER TO TRAILER 1 TO ACCOMODATE EMERGENCY NOTIFICATION REQUIREMENTS. CONTRACTOR TO COORDINATE WITH OIT. ALERTING AND DISPATCH TRAILER 2 - BUNK TRAILER: APPROX. 20'x48' TRAILER BUNK SLEEPS 11 TOTAL 2 BUNK ROOMS WITH FLOOR TO CEILING WALLS 9 BUNK ROOMS IN COMMON AREA TEMPORARY CONDUIT W/ STRINGS, SIZED PER CODE, FROM EXISTING NETWORK TO TRAILER 1

TO ACCOMODATE TELECOM REQUIREMENTS. CONTRACTOR TO COORDINATE WITH OIT. TEMPORARY CONDUIT W/ STRINGS, SIZED PER CODE, FROM EXISTING COMMAND CENTER TO TRAILER 1 TO ACCOMODATE EMERGENCY NOTIFICATION REQUIREMENTS. CONTRACTOR TO

#### TRAILER 3 - T&S: APPROX. 7'x20'

4 PERSONAL TOILET & SHOWER STALLS

COORDINATE WITH OIT. ALERTING AND DISPATCH


1 AUDIBLE ALARM

TEMPORARY CONDUIT W/ STRINGS, SIZED PER CODE, FROM EXISTING COMMAND CENTER TO TRAILER 1 TO ACCOMODATE EMERGENCY NOTIFICATION REQUIREMENTS. CONTRACTOR TO COORDINATE WITH OIT.

CONTRACTOR SHALL BE RESPONSIBLE FOR DELIVERY, INSTALLATION OF TEMPORARY LIVING FACILITIES IN ADDITION TO PROVIDING THE ASSOCIATED WALK WAYS, TEMPORARY UTILITIES, PRIVACY FENCE AND TEMPORARY FOUNDATION REQUIRED FOR SAID FACILITIES.

CONTRACTOR SHALL BE RESPONSIBLE FOR OBTAINING AND PROVIDING ALL REQUIRED PERMITS AND ASSOCIATED REVIEW FEES RELATED TO PROVIDING THE TEMPORARY LIVING FACILITIES.

CONTRACTOR SHALL BE RESPONSIBLE FOR CABLES AND CABLE INSTALLATION TO THE TEMPORARY LIVING FACILITIES.

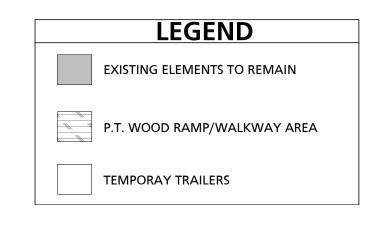

ARCHITECTURAL SITE DIAGRAM & TEMPORARY FACILITIES PLAN 2 ARCHII

SUBDIVISION: FULLERTON

					_								
PROFESSIONAL CERTIFIC	CATION	AS-BUILT / REV	VISION	BY	DATE	P.W.A. NO.	KEY SHEET	POSITION SHT	DRAWIN	IG SCALE			
I HEREBY CERTIFY THAT THESE DOCUMENTS APPROVED BY ME, AND THAT I AM A DULY LICI		BID/PERM	1IT		03/01/25	-	MSW	27NE21	PLAN SCALE:	As indicated	APPROVED BY:	Mihai T Potr	isor
PROFESSIONAL ARCHITECT UNDER THE LAWS OF THE STATE OF MARYLAND.						R.O.W NO.	-	-		-	03/2	26/2025	DIRECTOR
LICENSE NO. 15505 EXPIRATION DA	ATE: 08-18-2026					-	-	-	PROFILE SCALE:	-	DATE: OSIZ	<u> </u>	
ARCHITECT:	DGN BY:	BUREAU OF ENGINEERING AND CONSTRUCTION		HIGI	HWAYS	STRUCTURES	STORM DRAINS	SEWER	WATER	FIELD ENGINEER	PROP	PERTY MANAGEN	MENT
PRINCIPAL ARCHITECT  MANNS WOODWARD STUDIOS 10839-D PHILADELPHIA ROAD	DWN BY:	REVIEWED BY:									APPROVED BY:	:	СНІЕЯ
10559-D FRILADELFRIA ROAD WHITE MARSH, MARYLAND 21162 (P) 410-344-1460	CHKD BY:	DATE REVIEWED:									DATE:		

BALTIMORE COUNTY OFFICE OF BUDGET AND FINANCE, PROPERTY MANAGEMENT

FULLERTON FIRE STATION #8 - RENOVATION & ADDITION


ARCHITECTURAL SITE DIAGRAMS

4401 FITCH AVENUE, NOTTINGHAM, MARYLAND, 21236

SHEET DESIGNATION | CONTRACT NUMBER AD100 JOB ORDER NUMBER **241-220-**00**54-**001**2** 

SHEET 12 of 58 DRAWING NUMBER 2022-2331

FILE NO.: 8

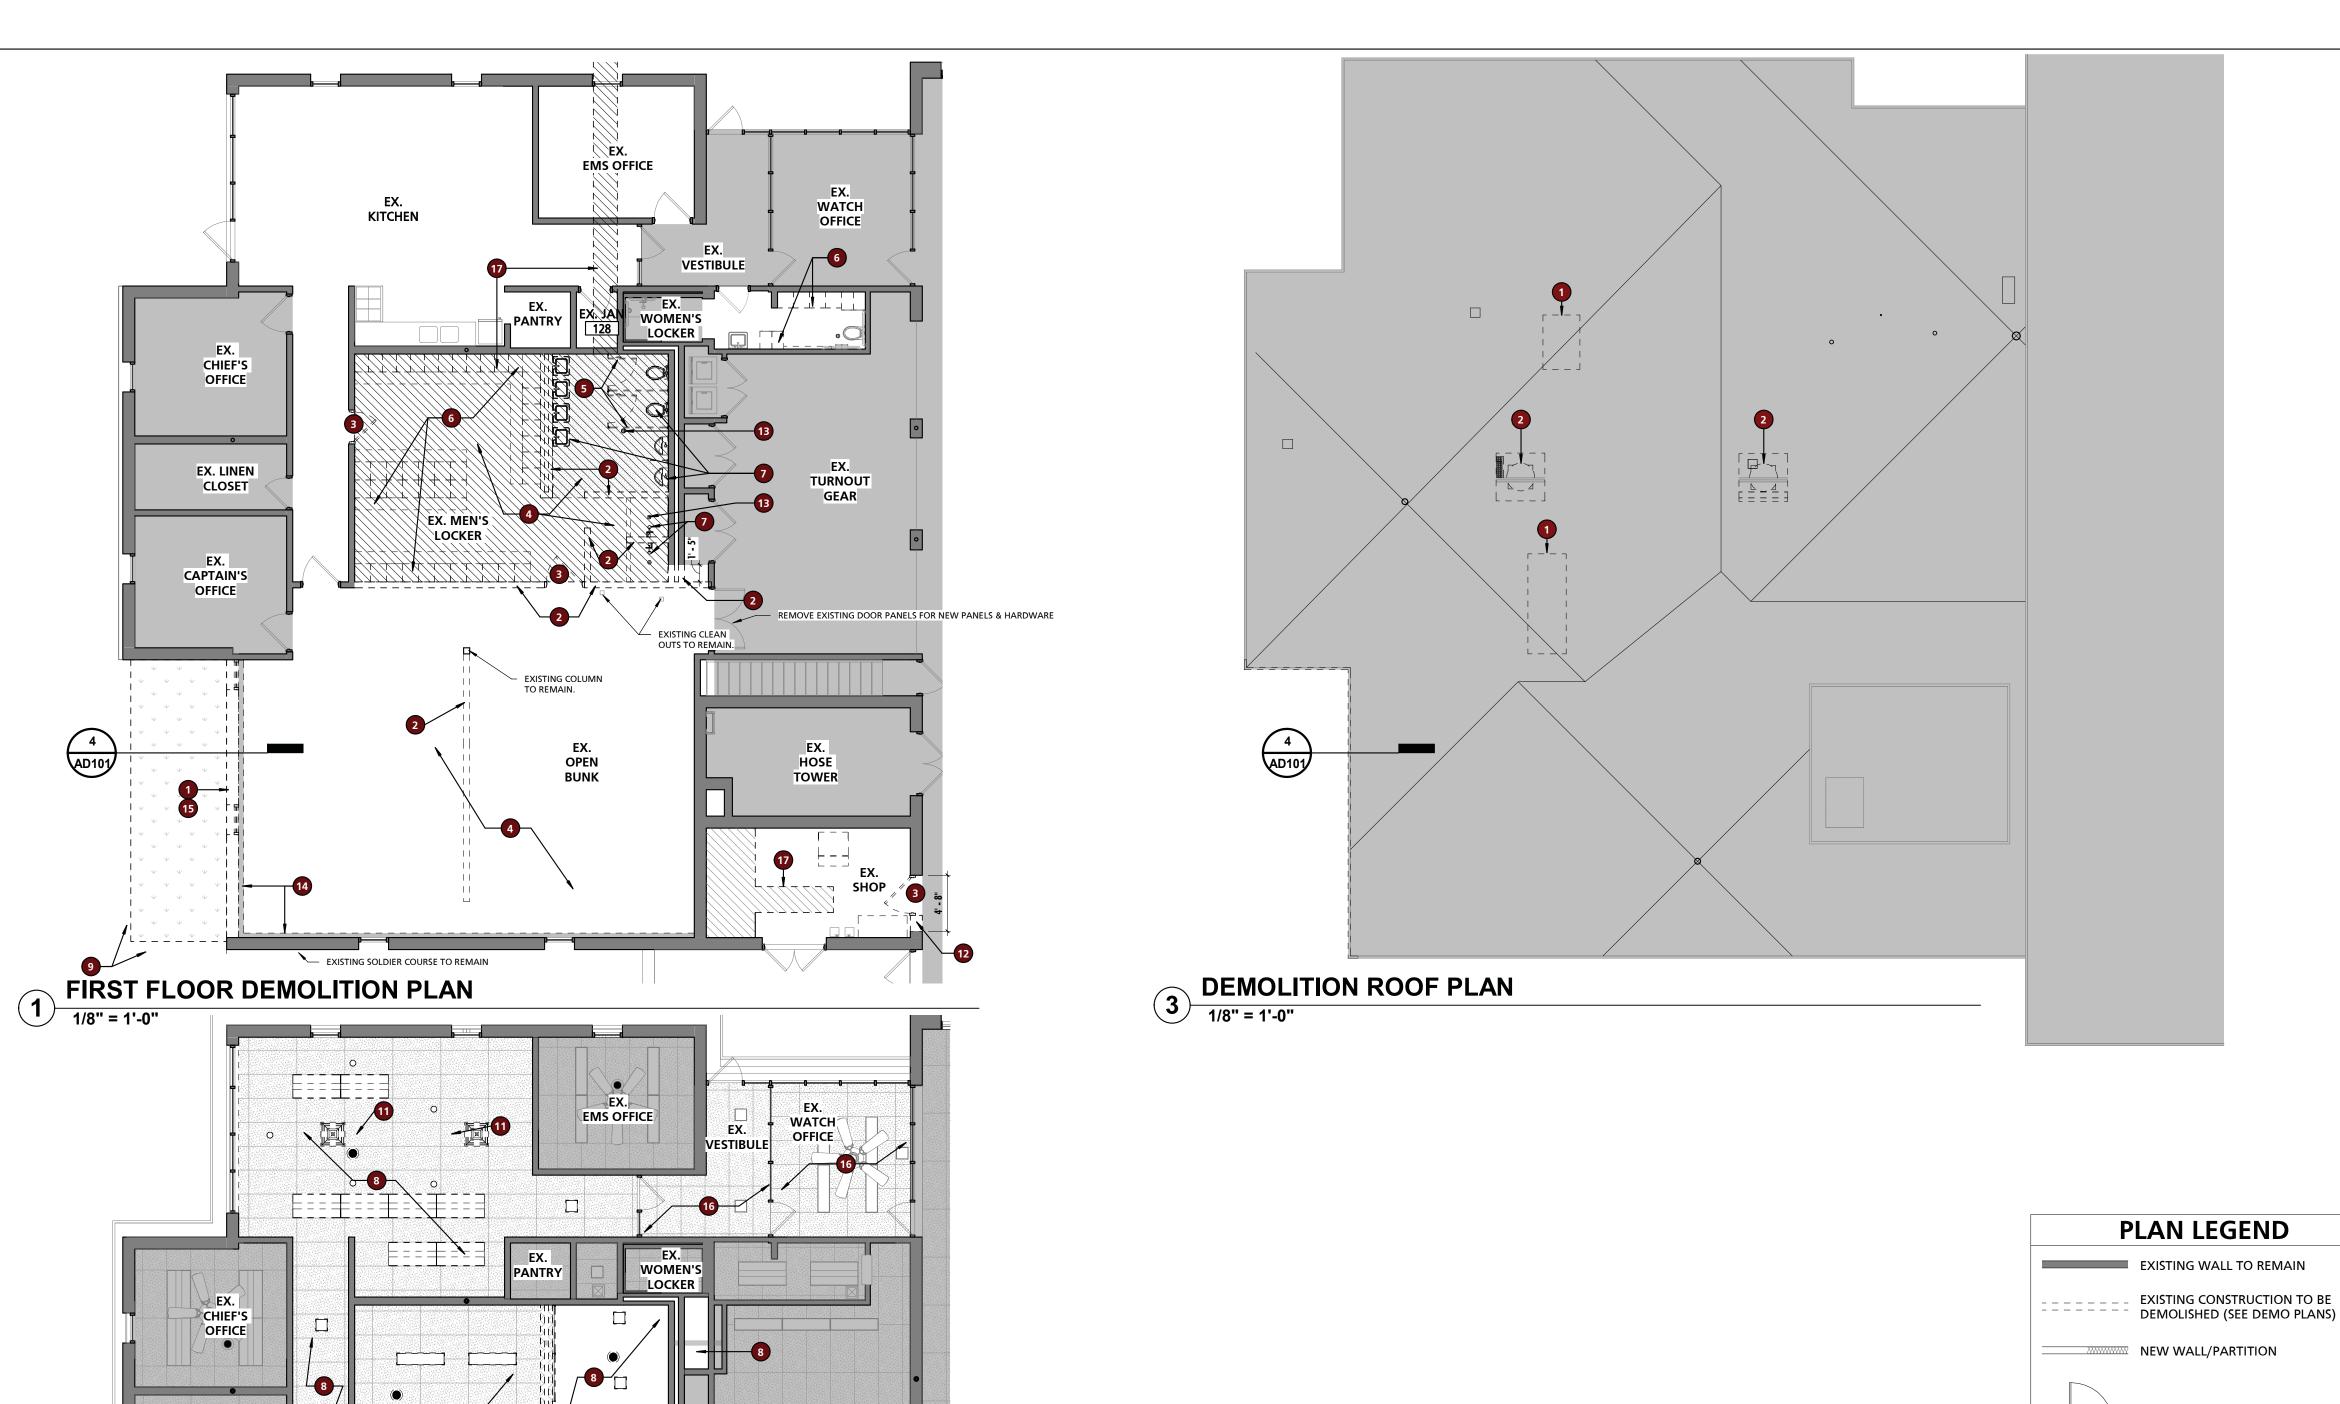


#### **GENERAL DEMOLITION NOTES**

- 1 ALL BIDDERS SHALL MAKE THEMSELVES FAMILIAR WITH THE EXISTING PROJECT CONDITIONS PRIOR TO SUBMITTING A BID. THIS IS INCLUSIVE OF CONDITIONS ABOVE ACCESSIBLE CEILINGS TO DETERMINE WORKING CONDITIONS.
- PRIOR TO THE PERFORMANCE OF ANY DEMOLITION WORK THE CONTRACTOR SHALL MAKE THEMSELVES FAMILIAR WITH THE EXISTING CONDITIONS OF THE PROJECT. THE CONTRACTOR SHALL BE RESPONSIBLE FOR DESIGNING, PROVIDING, INSTALLING, AND MAINTAINING ALL TEMPORARY SUPPORT AND BRACING REQUIRED TO COMPLETE THE WORK.
- THE CONTRACTOR SHALL BE RESPONSIBLE FOR VERIFYING ALL EXISTING CONDITIONS, DIMENSIONS, CONSTRUCTION ASSEMBLIES AND THE LIKE PRIOR TO FABRICATING, INSTALLING, OR PURCHASING ANY NEW WORK. DETAILS INDICATING EXISTING MATERIALS OF CONDITIONS MAY BE SHOWN WITHIN THE DOCUMENTS BUT ARE NOT INTENDED TO FULLY DEFINE **EXISTING CONDITIONS.**
- DEMOLITION WORK MAY BE INDICATED THROUGHOUT THE CONTRACT DOCUMENTS. IT IS THE RESPONSIBILITY OF THE CONTRACTOR TO REVIEW ALL DOCUMENTS FOR ADDITIONAL DEMOLITION WORK.
- IT IS THE CONTRACTORS RESPONSIBILITY TO MAINTAIN SAFE WORKING CONDITIONS THROUGHOUT THE CONSTRUCTION SITE. THE CONTRACTOR SHALL PROVIDE TEMPORARY BARRIERS AS REQUIRED TO PROTECT PERSONS AND PROPERTY AND OTHERWISE MAINTAIN SAFE WORKING CONDITIONS.
- 6 THE CONTRACTOR SHALL MAINTAIN A CLEAR, CLEAN, USEABLE CONSTRUCTION SITE THROUGH DAILY CLEANUP OF WORK
- PROCESS. THE CONTRACTOR SHALL COORDINATE WITH THE OWNER AND THE OWNER'S PERSONNEL THROUGHOUT THE CONSTRUCTION TO MINIMIZE, TO THE GREATEST EXTENT POSSIBLE, ANY DISRUPTIONS IN THE OWNER'S WORKING PROCEDURES. THE PHASING OF THE PROJECT SHALL BE DETERMINED BY MWS, BCPM AND AGENCY. ADDITIONALLY, THE CONTRACTOR SHALL COORDINATE WITH THE OWNER A MINIMUM OF 72 HOURS PRIOR TO ANY DISRUPTION OF SERVICES/UTILITIES REQUIRED TO COMPLETE THE WORK.
- THE CONTRACTOR SHALL PROVIDE TEMPORARY DUST AND DEBRIS BARRIERS BETWEEN AREAS TO REMAIN IN OPERATION AND WORK AREAS. BARRIERS SHALL BE PROVIDED AT, BUT NOT LIMITED TO, HVAC SUPPLY AND RETURN OPENINGS, TRANSFER VENTS, EXHAUST VENTS, AND OTHER SUCH OPENINGS. BARRIERS SHALL BE A MINIMUM OF 10 MIL PLASTIC SHEETING SECURED AND SEALED TO EXISTING CONSTRUCTION AND/OR TEMPORARY FRAMING. PLASTIC SHEETING SHALL BE OVERLAPPED A MINIMUM OF 12" AND TAPED BOTH SIDES.
- 9 THE CONTRACTOR SHALL PROVIDE PROTECTION FROM THE WEATHER FOR PORTIONS OF EXISTING CONSTRUCTION THAT ARE
- CONTRACTOR SHALL REVIEW WITH THE OWNER IF ANY ITEMS TO BE REMOVED AND/OR DEMOLISHED ARE TO BE RETAINED BY THE OWNER PRIOR TO ANY DEMOLITION WORK BEING PERFORMED. ALL ITEMS TO BE RETAINED BY THE OWNER SHALL BE REMOVED BY THE CONTRACTOR AND DELIVERED TO THE OWNER IN THE CONDITION FOUND PRIOR TO ANY WORK BEING PERFORMED. ALL OTHER ITEMS INDICATED TO BE REMOVED AND/OR DEMOLISHED SHALL BE DISPOSED OF OFF SITE BY THE
- CONTRACTOR IN A LAWFUL MANNER. 11 THE CONTRACTOR SHALL REPLACE OR REPAIR ANY ITEMS DAMAGED BY THE CONTRACTOR OR ANY OF ITS AGENTS TO A MINIMUM CONDITION MATCHING THE ITEMS' CONDITION AT THE START OF CONSTRUCTION AT NO ADDITIONAL COST TO THE
- 12 THE CONTRACTOR SHALL REPAIR ANY MATERIALS, SYSTEMS, OR FINISHES WITHIN OR OUTSIDE OF THE GENERAL WORK AREA THAT ARE REQUIRED TO BE DISTURBED TO COMPLETE THE ENTIRE SCOPE OF WORK ASSOCIATED WITH BUILDING SYSTEM
- 13 THE CONTRACTOR SHALL PREPARE ALL SURFACES AFFECTED BY DEMOLITION OPERATIONS TO RECEIVE NEW WORK AS BOTH INDICATED WITHIN THESE DRAWINGS AND SPECIFICATIONS/PROJECT MANUAL AND AS RECOMMENDED BY THE
- MANUFACTURERS' WRITTEN INSTRUCTIONS FOR THE INSTALLATION OF EACH RESPECTIVE PRODUCT 14 THE CONTRACTOR SHALL REMOVE EXISTING FINISHES AS INDICATED THROUGHOUT THE CONTRACT DOCUMENTS AND ENSURE THAT SUBSTRATE CONDITIONS ARE SMOOTH AND IN SATISFACTORY CONDITION TO RECEIVE NEW WORK.
- 15 THE CONTRACTOR SHALL REMOVE ALL ANCHORS, FASTENERS, WALL HANGERS, AND MISCELLANEOUS EXTRUSIONS AND APPURTENANCES OF ITEMS BOTH NO LONGER INSTALLED AND ITEMS REMOVED THROUGH DEMOLITION PROCEDURES. PATCH 16 THE CONTRACTOR SHALL COORDINATE ANY SAW CUTS WITHIN THE EXISTING SLABS WITHIN THE NEW WORK AREA AS
- REQUIRED TO INSTALL NEW ELECTRICAL CONDUIT, PLUMBING, AND/OR STRUCTURAL ELEMENTS. CONTRACTOR SHALL COORDINATE SIZE, LOCATION, AND DEPTH WITH THE FULL SET OF DOCUMENTS. REPLACE AND REPAIR CONCRETE AND FLASH AS REQUIRED TO CREATE A FLUSH SUBSTRATE AFTER COMPLETION OF WORK TASKS. CONTRACTOR TO LOCATE ANY IN-SLAB SERVICES. IF DAMAGED DURING DEMOLITION, CONTRACTOR TO REPLACE AT THEIR EXPENSE.

## **REFERENCED NOTES - ROOF DEMOLITION**

**REFERENCED NOTES - DEMOLITION** 

- CONTRACTOR TO DISSCONNECT AND REMOVE EXISTING ROOF TOP UNIT, EQUIPMENT CURB AND ALL ASSOCIATED APPURTENANCES IN THEIR ENTIRETY. PREPARE OPENING TO RECEIVE NEW WORK
- CONTRACTOR TO DISSCONNECT AND REMOVE EXISTING ROOF TOP EXHAUST FAN, EQUIPMENT CURB AND ALL ASSOCIATED APPURTENANCES IN THEIR ENTIRETY, PREPARE OPENING TO RECEIVE NEW WORK

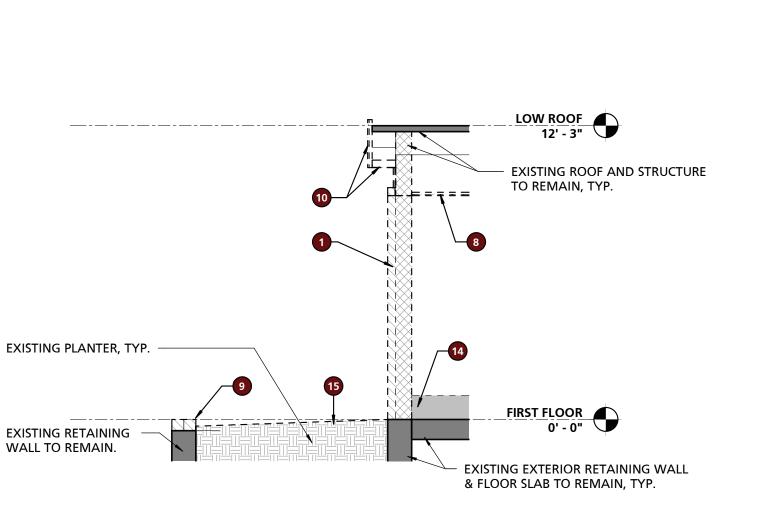

SUBDIVISION: FULLERTON

**DEMOLITION WALL SECTION** 

DEMOLISH EXTERIOR WALL AS REQUIRED TO MAKE WAY FOR NEW WORK, DEMOLITION INCLUDES BUT IS NOT LIMITED TO ALL. ASSOCIATED WINDOW OPENINGS. SEE OTHER NOTES AND DRAWINGS FOR ADDITIONAL INFORMATION. REMOVE EXISTING INTERIOR WALL AND ALL ASSOCIATED APPURTENANCES IN THEIR ENTIRETY. REMOVE EXISTING DOOR, FRAME AND HARDWARE. 4 REMOVE EXISTING FLOOR FINISHES, ASSOCIATED FASTENERS AND ADHESIVES. PATCH & GRIND SMOOTH EXISTING CONCRETE

SLAB UNDERLAYMENT. REMOVE EXISTING TOILET PARTITIONS

0

6 LOCKERS, BENCHES AND OTHER ITEMS SHALL BE REMOVED WITH CARE AND STORED IN A LOCATION ON PROJECT SITE DESIGNATED BY THE OWNER.

REMOVE EXISTING SINKS, TOILETS, URINALS, SHOWER HEADS AND ALL ASSOCIATED APPURTENANCES. SEE MEP DRAWINGS

FOR ADDITIONAL INFORMATION 8 REMOVE EXISTING FINISHED CEILING AND ALL ASSOCIATED APPURTENANCES. SEE MEP DEMO PLANS FOR ADDITIONAL INFORMATION REGARDING REMOVAL OF LIGHTS, HVAC REGISTERS, A/V AND ALERTING EQUIPMENT.

9 REMOVE EXISTING PLANTER BED SOLDIER COURSE

10 EXISTING SOFFIT, FASCIA & ASSOCIATED ROOF EDGE BLOCKING TO BE REMOVED AND PREPARED FOR NEW WORK. 11 REMOVE EXISTING CEILING FANS WITH CARE AND STORE IN A LOCATION ON PROJECT SITE DESIGNATED BY THE OWNER.

12 SAWCUT PORTIONS OF EXISTING WALL TO ACCOMMODATE NEW OPENINGS. COORDINATE ROUGH OPENING REQUIREMENTS WITH BOTH MANUFACTURERS OF PRODUCT TO BE USED AND NEW WORK INDICATED WITHIN CONTRACT DOCUMENTS. 13 SAW CUT PORTION OF CONCRETE SLAB TO ACCOMMODATE REMOVAL OF EXISTING FLOOR DRAINS AND REMEDIATE SLOPED

PORTION OF FLOOR SLAB. CONTRACTOR SHALL PREPARE SURFACE FOR NEW WORK. 14 DISCONNECT AND REMOVE BASEBOARD HEATER(S). SEE MEP DRAWINGS FOR ADDITIONAL INFORMATION.

15 REMOVE LAYER OF ORGANIC SOIL AS REQUIRED TO BACKFILL STONE FILL BASE FOR NEW SLAB.

16 TEMPORARILY REMOVE CEILING FOR ASSOCIATED MEP WORK WITHIN THIS AREA. UPON COMPLETION OF WORK EXISTING

CEILING TO BE REINSTALLED. 17 SAW CUT PORTIONS OF EXISTING SLAB AS REQUIRED TO ACCOMODATE NEW WORK.

18 EXISTING BRICK RETAINING WALL, CONCRETE PATIO AND STAIR TO BE DEMOLISHED.

19 PROTECT EXISTING CONDUITS AS REQUIRED DURING DURATION OF CONSTRUCTION.

BALTIMORE COUNTY OFFICE OF BUDGET AND FINANCE, PROPERTY MANAGEMENT

FULLERTON FIRE STATION #8 - RENOVATION & ADDITION

DEMOLITION PLANS

**NEW DOOR** 

**EXISTING DOOR** 

OTHERWISE NOTED

ROOMS SHADED GRAY ARE NOT

WITHIN THE SCOPE OF WORK, UNLESS

4401 FITCH AVENUE, NOTTINGHAM, MARYLAND, 21236

AD101 25034 PF0 RE-BID JOB ORDER NUMBER

SHEET DESIGNATION

241-220-0054-0012 SHEET 13 of 58 DRAWING NUMBER 2022-2332 FILE NO.: 8

CONTRACT NUMBER

BY DATE P.W.A. NO. KEY SHEET POSITION SHT DRAWING SCALE PROFESSIONAL CERTIFICATION AS-BUILT / REVISION APPROVED BY: Mihai T Petrisor HEREBY CERTIFY THAT THESE DOCUMENTS WERE PREPARED OR BID/PERMIT PLAN SCALE: APPROVED BY ME, AND THAT I AM A DULY LICENSED PROFESSIONAL ARCHITECT UNDER THE LAWS OF THE STATE OF R.O.W NO. 03/26/2025 MARYLAND. PROFILE SCALE: EXPIRATION DATE: 08-18-2026 LICENSE NO. 15505 BUREAU OF ENGINEERING HIGHWAYS STRUCTURES STORM DRAINS SEWER WATER FIELD ENGINEER PROPERTY MANAGEMENT VID WOODWARD, AIA REVIEWED BY: DWN BY: APPROVED BY: ANNS WOODWARD STUDIOS 10839-D PHILADELPHIA ROAD WHITE MARSH, MARYLAND 21162 DATE REVIEWED: CHKD BY:

EX.

TURNOUT

GEAR

EX.

HOSE

TOWER

EX. SHOP

EX. LINEN

CLOSET

EX.

CAPTAIN'S


OFFICE


**DEMOLITION CEILING PLAN** 


03/01/25


EX. MEN'S


LOCKER

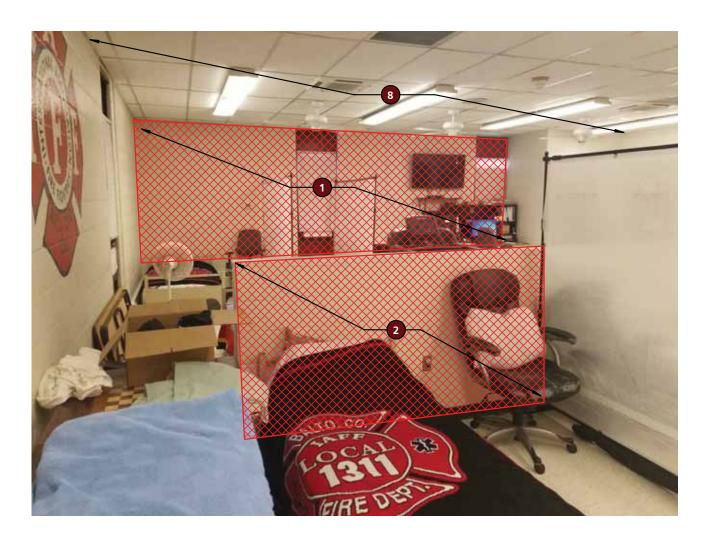

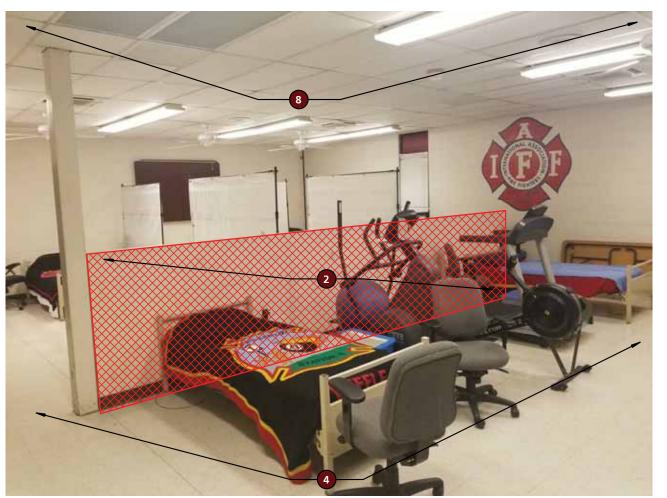

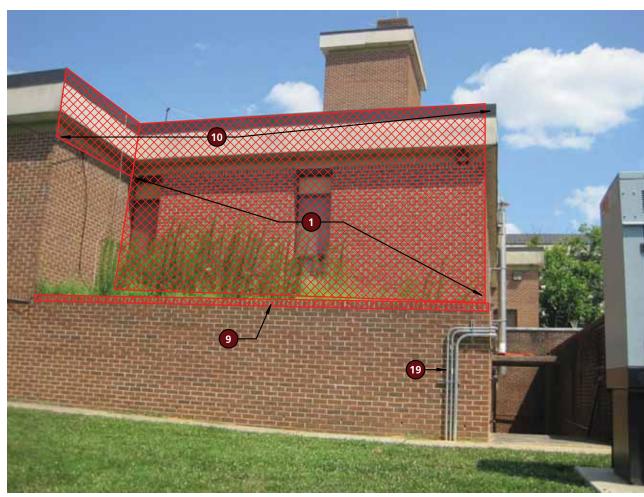

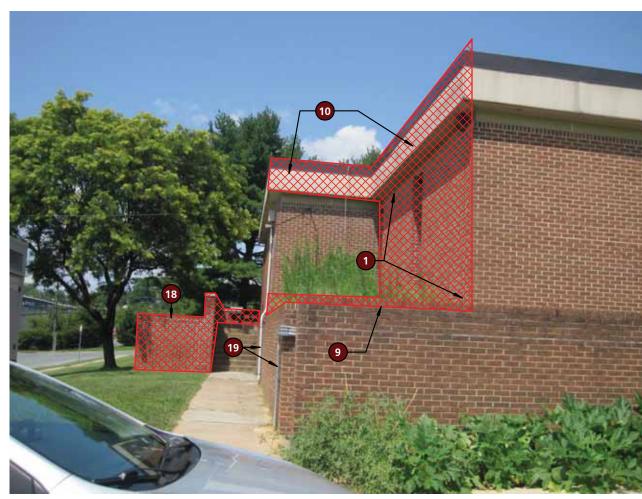

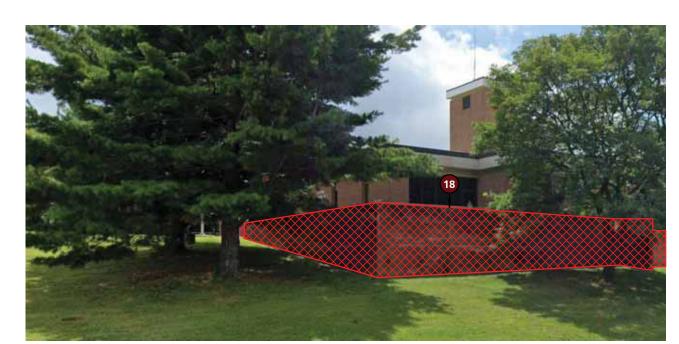

**AREA OF DEMO WORK** 

111111	PROFESSIONAL CERTIFIC	CATION	AS-BUILT / REV	VISION	BY DAT	E P.W.A. NO.	KEY SHEET	POSITION SHT	DRAWIN	G SCALE		7
NOO CONTRACTOR OF THE PROPERTY	I HEREBY CERTIFY THAT THESE DOCUMENTS WERE PREPARED OR APPROVED BY ME, AND THAT I AM A DULY LICENSED		BID/PERMIT		03/01/2	5 -	MSW	27NE21	PLAN SCALE:	3/8" = 1'-0"	APPROVED BY: Mihai T Petrisor	T
	PROFESSIONAL ARCHITECT UNDER THE LAWS					R.O.W NO.	-	-			DIRECTOR	۱
	MARYLAND. LICENSE NO. 15505 EXPIRATION DATE: 08-18-2026				-	PROFILE SCALE: -		<sub>DATE:</sub> 03/26/2025				
- E	ARCHITECT: DAVID WOODWARD, AIA	DGN BY:	BUREAU OF ENGINEERING AND CONSTRUCTION		HIGHWAYS	STRUCTURE	S STORM DRAINS	SEWER	WATER	FIELD ENGINEER	PROPERTY MANAGEMENT	
505 c	PRINCIPAL ARCHITECT  MANNS WOODWARD STUDIOS 10839-D PHILADELPHIA ROAD	DWN BY:	REVIEWED BY:								APPROVED BY: CHIEF	5
25	WHITE MARSH, MARYLAND 21162 (P) 410-344-1460	CHKD BY:	DATE REVIEWED:								DATE:	_

BALTIMORE COUNTY OFFICE OF BUDGET AND FINANCE, PROPERTY MANAGEMENT

FULLERTON FIRE STATION #8 - RENOVATION & ADDITION

DEMOLITION - AREA OF WORK

SUBDIVISION: FULLERTON

4401 FITCH AVENUE, NOTTINGHAM, MARYLAND, 21236

**GENERAL DEMOLITION NOTES** 

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- OTHERWISE MAINTAIN SAFE WORKING CONDITIONS. 6 THE CONTRACTOR SHALL MAINTAIN A CLEAR, CLEAN, USEABLE CONSTRUCTION SITE THROUGH DAILY CLEANUP OF WORK
- THE OWNER SHALL BE MAINTAINING OCCUPANCY OF THE SITE AND PORTIONS OF THE BUILDING DURING THE CONSTRUCTION PROCESS. THE CONTRACTOR SHALL COORDINATE WITH THE OWNER AND THE OWNER'S PERSONNEL THROUGHOUT THE CONSTRUCTION TO MINIMIZE, TO THE GREATEST EXTENT POSSIBLE, ANY DISRUPTIONS IN THE OWNER'S WORKING PROCEDURES. THE PHASING OF THE PROJECT SHALL BE DETERMINED BY MWS, BCPM AND AGENCY. ADDITIONALLY, THE CONTRACTOR SHALL COORDINATE WITH THE OWNER A MINIMUM OF 72 HOURS PRIOR TO ANY DISRUPTION OF
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- MINIMUM OF 12" AND TAPED BOTH SIDES. 9 THE CONTRACTOR SHALL PROVIDE PROTECTION FROM THE WEATHER FOR PORTIONS OF EXISTING CONSTRUCTION THAT ARE TO REMAIN OCCUPIED OR USEABLE BY THE OWNER OR TO AREAS THAT CONTAIN ITEMS TO REMAIN THAT WILL BE DAMAGED
- 10 ALL ITEMS INDICATED TO BE REMOVED AND/OR DEMOLISHED SHALL REMAIN THE PROPERTY OF THE OWNER. THE CONTRACTOR SHALL REVIEW WITH THE OWNER IF ANY ITEMS TO BE REMOVED AND/OR DEMOLISHED ARE TO BE RETAINED BY THE OWNER PRIOR TO ANY DEMOLITION WORK BEING PERFORMED. ALL ITEMS TO BE RETAINED BY THE OWNER SHALL BE REMOVED BY THE CONTRACTOR AND DELIVERED TO THE OWNER IN THE CONDITION FOUND PRIOR TO ANY WORK BEING PERFORMED. ALL OTHER ITEMS INDICATED TO BE REMOVED AND/OR DEMOLISHED SHALL BE DISPOSED OF OFF SITE BY THE CONTRACTOR IN A LAWFUL MANNER.
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- 13 THE CONTRACTOR SHALL PREPARE ALL SURFACES AFFECTED BY DEMOLITION OPERATIONS TO RECEIVE NEW WORK AS BOTH INDICATED WITHIN THESE DRAWINGS AND SPECIFICATIONS/PROJECT MANUAL AND AS RECOMMENDED BY THE MANUFACTURERS' WRITTEN INSTRUCTIONS FOR THE INSTALLATION OF EACH RESPECTIVE PRODUCT.
- 14 THE CONTRACTOR SHALL REMOVE EXISTING FINISHES AS INDICATED THROUGHOUT THE CONTRACT DOCUMENTS AND ENSURE THAT SUBSTRATE CONDITIONS ARE SMOOTH AND IN SATISFACTORY CONDITION TO RECEIVE NEW WORK.
- 15 THE CONTRACTOR SHALL REMOVE ALL ANCHORS, FASTENERS, WALL HANGERS, AND MISCELLANEOUS EXTRUSIONS AND APPURTENANCES OF ITEMS BOTH NO LONGER INSTALLED AND ITEMS REMOVED THROUGH DEMOLITION PROCEDURES. PATCH AND PAINT ALL SURFACES TOUCHED, CORNER TO CORNER, TOP TO BOTTOM AND WITH SQUARE AND STRAIGHT LINES.
- 16 THE CONTRACTOR SHALL COORDINATE ANY SAW CUTS WITHIN THE EXISTING SLABS WITHIN THE NEW WORK AREA AS REQUIRED TO INSTALL NEW ELECTRICAL CONDUIT, PLUMBING, AND/OR STRUCTURAL ELEMENTS. CONTRACTOR SHALL COORDINATE SIZE, LOCATION, AND DEPTH WITH THE FULL SET OF DOCUMENTS. REPLACE AND REPAIR CONCRETE AND FLASH AS REQUIRED TO CREATE A FLUSH SUBSTRATE AFTER COMPLETION OF WORK TASKS. CONTRACTOR TO LOCATE ANY IN-SLAB SERVICES. IF DAMAGED DURING DEMOLITION, CONTRACTOR TO REPLACE AT THEIR EXPENSE.

0	REFERENCED NOTES - DEMOLITION
NO.	NOTE
1	DEMOLISH EXTERIOR WALL AS REQUIRED TO MAKE WAY FOR NEW WORK. DEMOLITION INCLUDES BUT IS NOT LIMITED TO ALL. ASSOCIATED WINDOW OPENINGS. SEE OTHER NOTES AND DRAWINGS FOR ADDITIONAL INFORMATION.
2	REMOVE EXISTING INTERIOR WALL AND ALL ASSOCIATED APPURTENANCES IN THEIR ENTIRETY.
3	REMOVE EXISTING DOOR, FRAME AND HARDWARE.
4	REMOVE EXISTING FLOOR FINISHES, ASSOCIATED FASTENERS AND ADHESIVES. PATCH & GRIND SMOOTH EXISTING CONCRETE SLAB UNDERLAYMENT.
5	REMOVE EXISTING TOILET PARTITIONS.
6	LOCKERS, BENCHES AND OTHER ITEMS SHALL BE REMOVED WITH CARE AND STORED IN A LOCATION ON PROJECT SITE DESIGNATED BY THE OWNER.
7	REMOVE EXISTING SINKS, TOILETS, URINALS, SHOWER HEADS AND ALL ASSOCIATED APPURTENANCES. SEE MEP DRAWINGS FOR ADDITIONAL INFORMATION
8	REMOVE EXISTING FINISHED CEILING AND ALL ASSOCIATED APPURTENANCES. SEE MEP DEMO PLANS FOR ADDITIONAL INFORMATION REGARDING REMOVAL OF LIGHTS, HVAC REGISTERS, A/V AND ALERTING EQUIPMENT.
9	REMOVE EXISTING PLANTER BED SOLDIER COURSE
10	EXISTING SOFFIT, FASCIA & ASSOCIATED ROOF EDGE BLOCKING TO BE REMOVED AND PREPARED FOR NEW WORK.
11	REMOVE EXISTING CEILING FANS WITH CARE AND STORE IN A LOCATION ON PROJECT SITE DESIGNATED BY THE OWNER.
12	SAWCUT PORTIONS OF EXISTING WALL TO ACCOMMODATE NEW OPENINGS. COORDINATE ROUGH OPENING REQUIREMENTS WITH BOTH MANUFACTURERS OF PRODUCT TO BE USED AND NEW WORK INDICATED WITHIN CONTRACT DOCUMENTS.
13	SAW CUT PORTION OF CONCRETE SLAB TO ACCOMMODATE REMOVAL OF EXISTING FLOOR DRAINS AND REMEDIATE SLOPED PORTION OF FLOOR SLAB. CONTRACTOR SHALL PREPARE SURFACE FOR NEW WORK.
14	DISCONNECT AND REMOVE BASEBOARD HEATER(S). SEE MEP DRAWINGS FOR ADDITIONAL INFORMATION.
15	REMOVE LAYER OF ORGANIC SOIL AS REQUIRED TO BACKFILL STONE FILL BASE FOR NEW SLAB.
16	TEMPORARILY REMOVE CEILING FOR ASSOCIATED MEP WORK WITHIN THIS AREA. UPON COMPLETION OF WORK EXISTING CEILING TO BE REINSTALLED.
17	SAW CUT PORTIONS OF EXISTING SLAB AS REQUIRED TO ACCOMODATE NEW WORK.
18	EXISTING BRICK RETAINING WALL, CONCRETE PATIO AND STAIR TO BE DEMOLISHED.
19	PROTECT EXISTING CONDUITS AS REQUIRED DURING DURATION OF CONSTRUCTION.


AD102

SHEET DESIGNATION | CONTRACT NUMBER JOB ORDER NUMBER

FILE NO.: 8

241**-**220**-**0054**-**0012 SHEET 14 of 58 DRAWING NUMBER

2022-2333

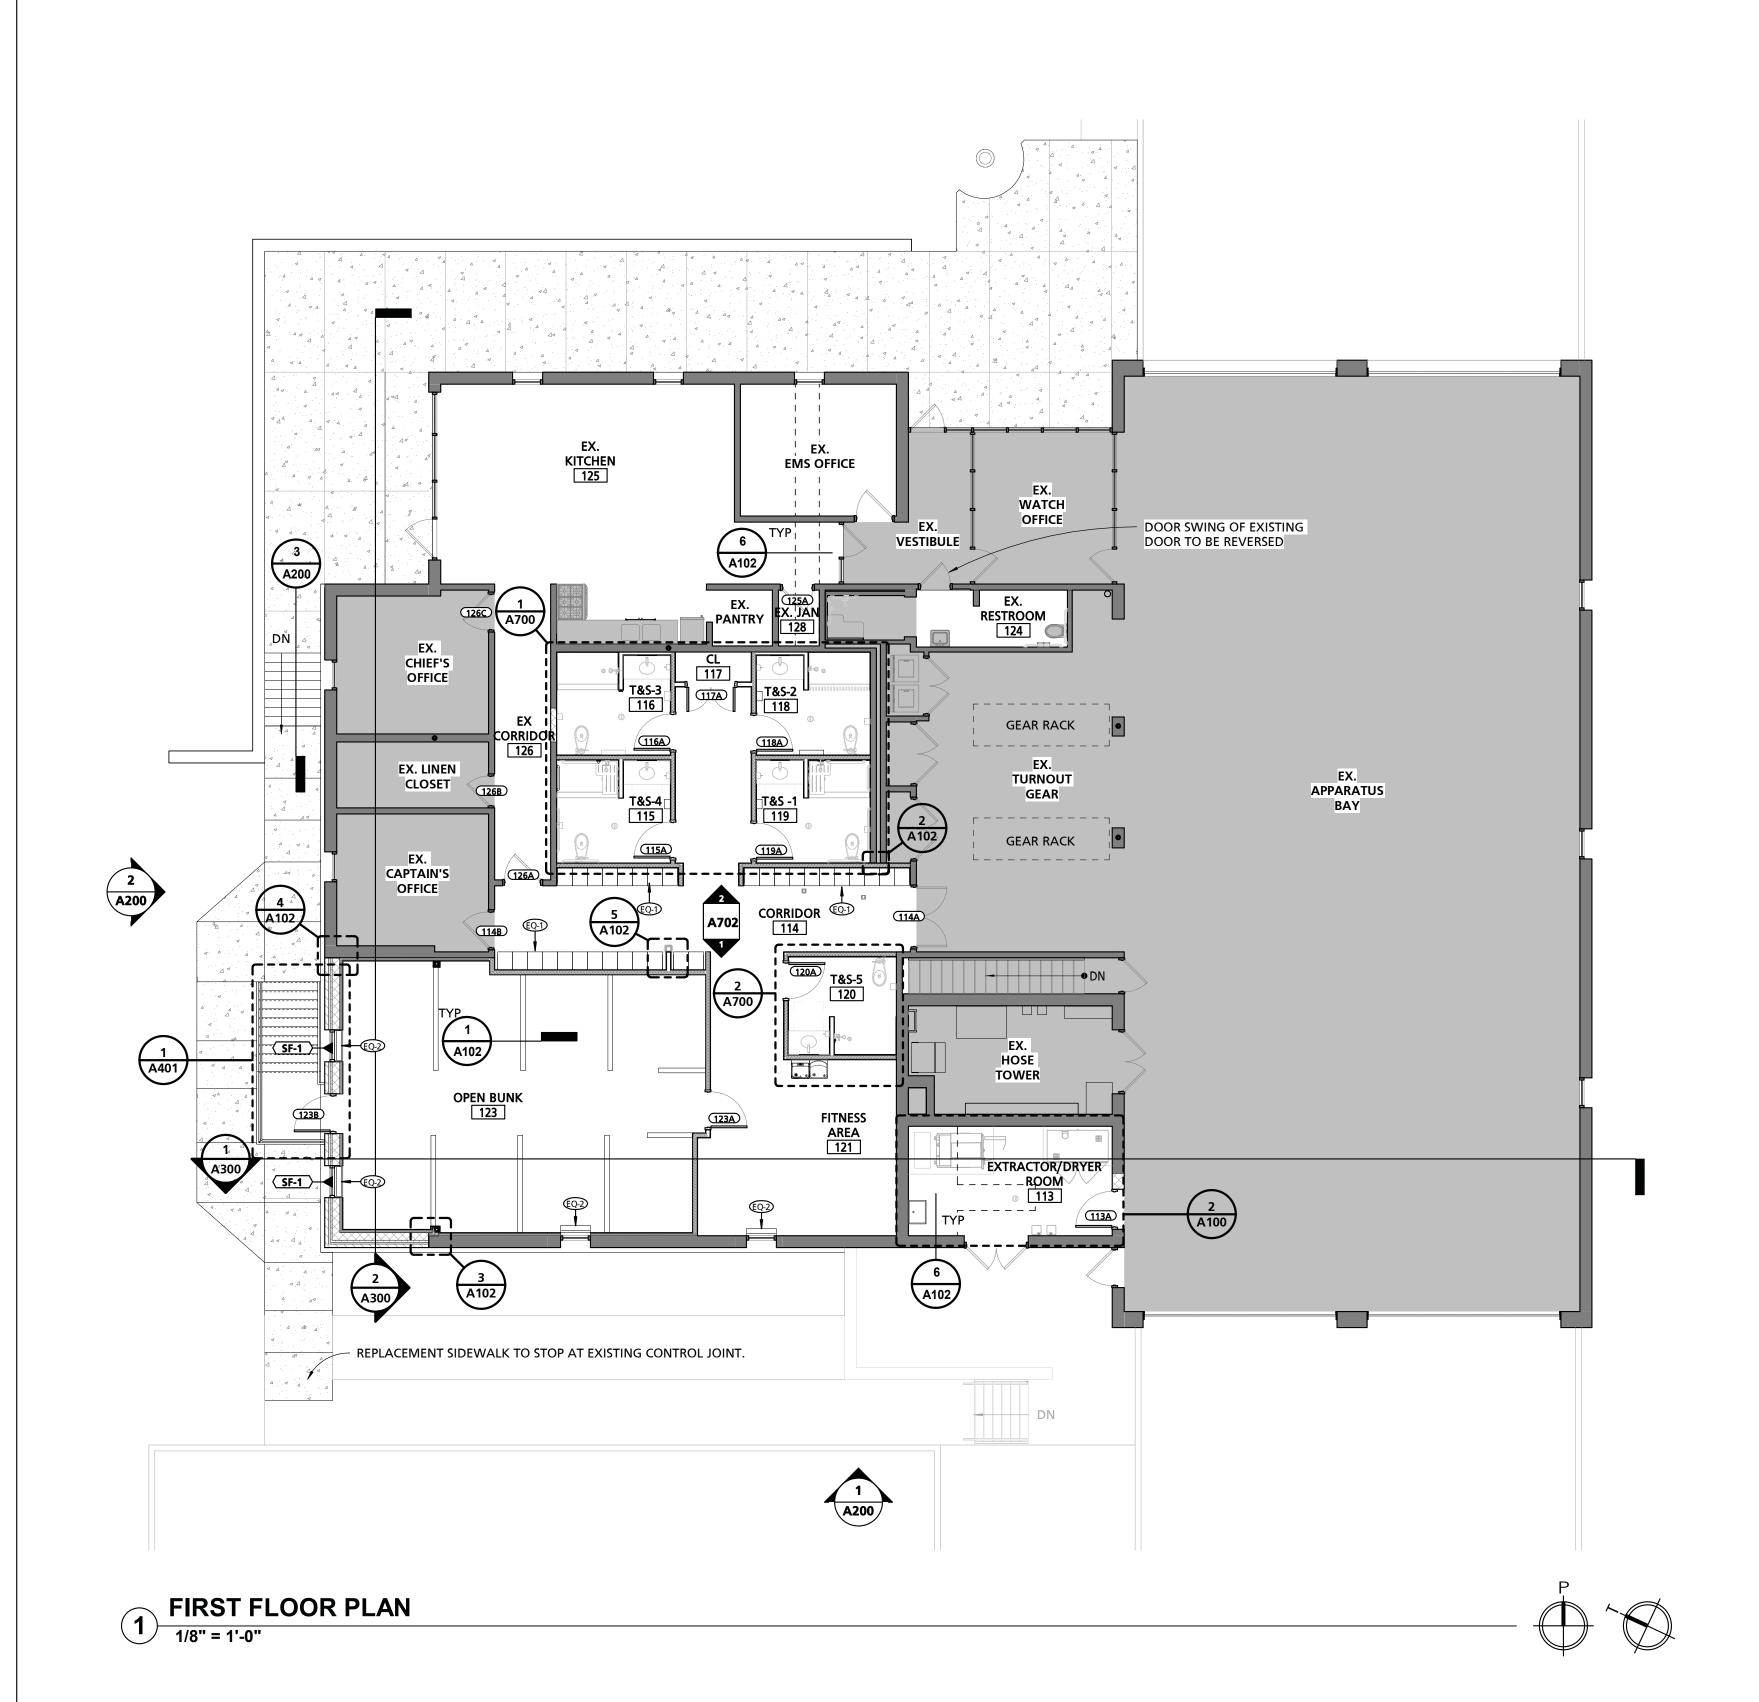

SCHEDULE - EQUIPMENT

MARK DESCRIPTION BOD MANUFACTURER BOD MODEL O.P.O.I. O.P.C.I. C.P.C.I. COMMENTS

EQ-1 15"W x 18"D x 72"H TWO-TIER SOLID PLASTIC LOCKER BRADLEY CORPORATION LENOX "Z" LOCKER

EQ-2 MANUAL ROLLER SHADE HUNTER DOUGLAS RB-500 ROLLER SHADES 


■ PROVIDE BLACK-OUT BLINDS


SCHEDULE ABBREVIATIONS:

O.P.O.I. - OWNER PROVIDED; OWNER INSTALLED

O.P.C.I. - OWNER PROVIDED; CONTRACTOR INSTALLED

C.P.C.I. - CONTRACTOR PROVIDED; CONTRACTOR INSTALLED

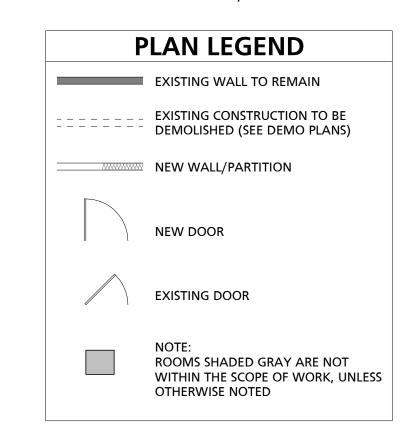

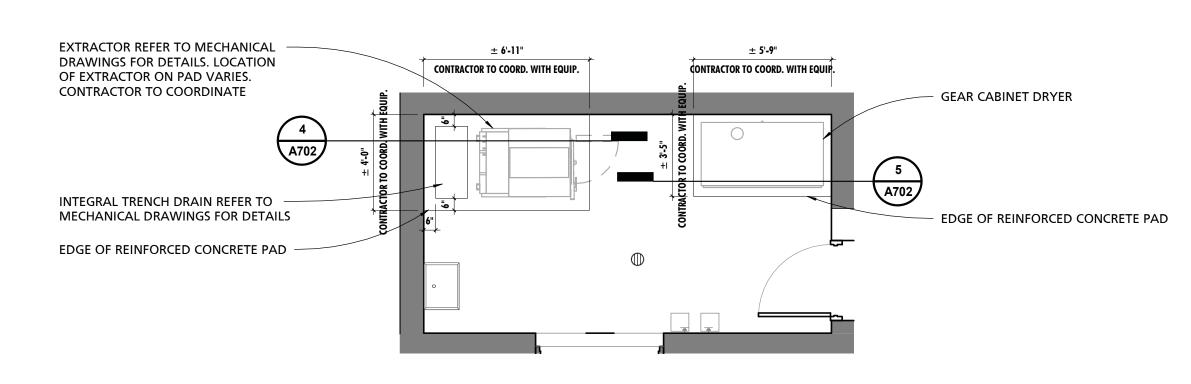

# 2 ENLARGED EXTRACTOR/DRYER ROOM PLAN 1/4" = 1'-0"

SE	AL MILLION	PROFESSIONAL CERTIF	AS-BUILT / REVISION		BY	DATE	P.W.A. NO.	KEY SHEET	POSITION SHT	DRAWIN	IG SCALE				
	A WOOD WAY	I HEREBY CERTIFY THAT THESE DOCUMENTS APPROVED BY ME, AND THAT I AM A DULY LI		BID/PERMIT			03/01/25	-	MSW	27NE21	PLAN SCALE:	As indicated	APPROVED BY:	Mihai Ti	Petrisor
		PROFESSIONAL ARCHITECT UNDER THE LAWS OF THE STATE OF						R.O.W NO.	-	-			03/26/2025		DIRECTOR
		MARYLAND. LICENSE NO. 15505 EXPIRATION I	DATE: 08-18-2026					-	] .	-	PROFILE SCALE:	-	DATE:	0/2020	
		ARCHITECT:	DGN BY:	BUREAU OF ENGINEERING AND CONSTRUCTION		HIGH	HWAYS	STRUCTURES	STORM DRAINS	SEWER	WATER	FIELD ENGINEER	PROP	ERTY MANA	GEMENT
10	15505 CTIVILI	PRINCIPAL ARCHITECT  MANNS WOODWARD STUDIOS 10889-D PHILADELPHIA ROAD	DWN BY:	REVIEWED BY:									APPROVED BY:		СНІЕІ
<u>D</u> A	TE: 03/01/25	WHITE MARSH, MARYLAND 21162 (P) 410-344-1460	CHKD BY:	DATE REVIEWED:									DATE:		

BALTIMORE COUNTY OFFICE OF BUDGET AND FINANCE, PROPERTY MANAGEMENT

FULLERTON FIRE STATION #8 - RENOVATION & ADDITION

REFERENCE PLAN

SUBDIVISION: FULLERTON

4401 FITCH AVENUE, NOTTINGHAM, MARYLAND, 21236

A100
WORE CO
* * * *
MARYLAND

25034 PF0 RE-BID

JOB ORDER NUMBER

241-220-0054-0012

SHEET 15 of 58


DRAWING NUMBER

2022-2334

FILE NO.: 8

SHEET DESIGNATION | CONTRACT NUMBER

VENUE, NOTTINGHAM, MARYLAND, 21236 ELECTION DIST. NO.: 14C5

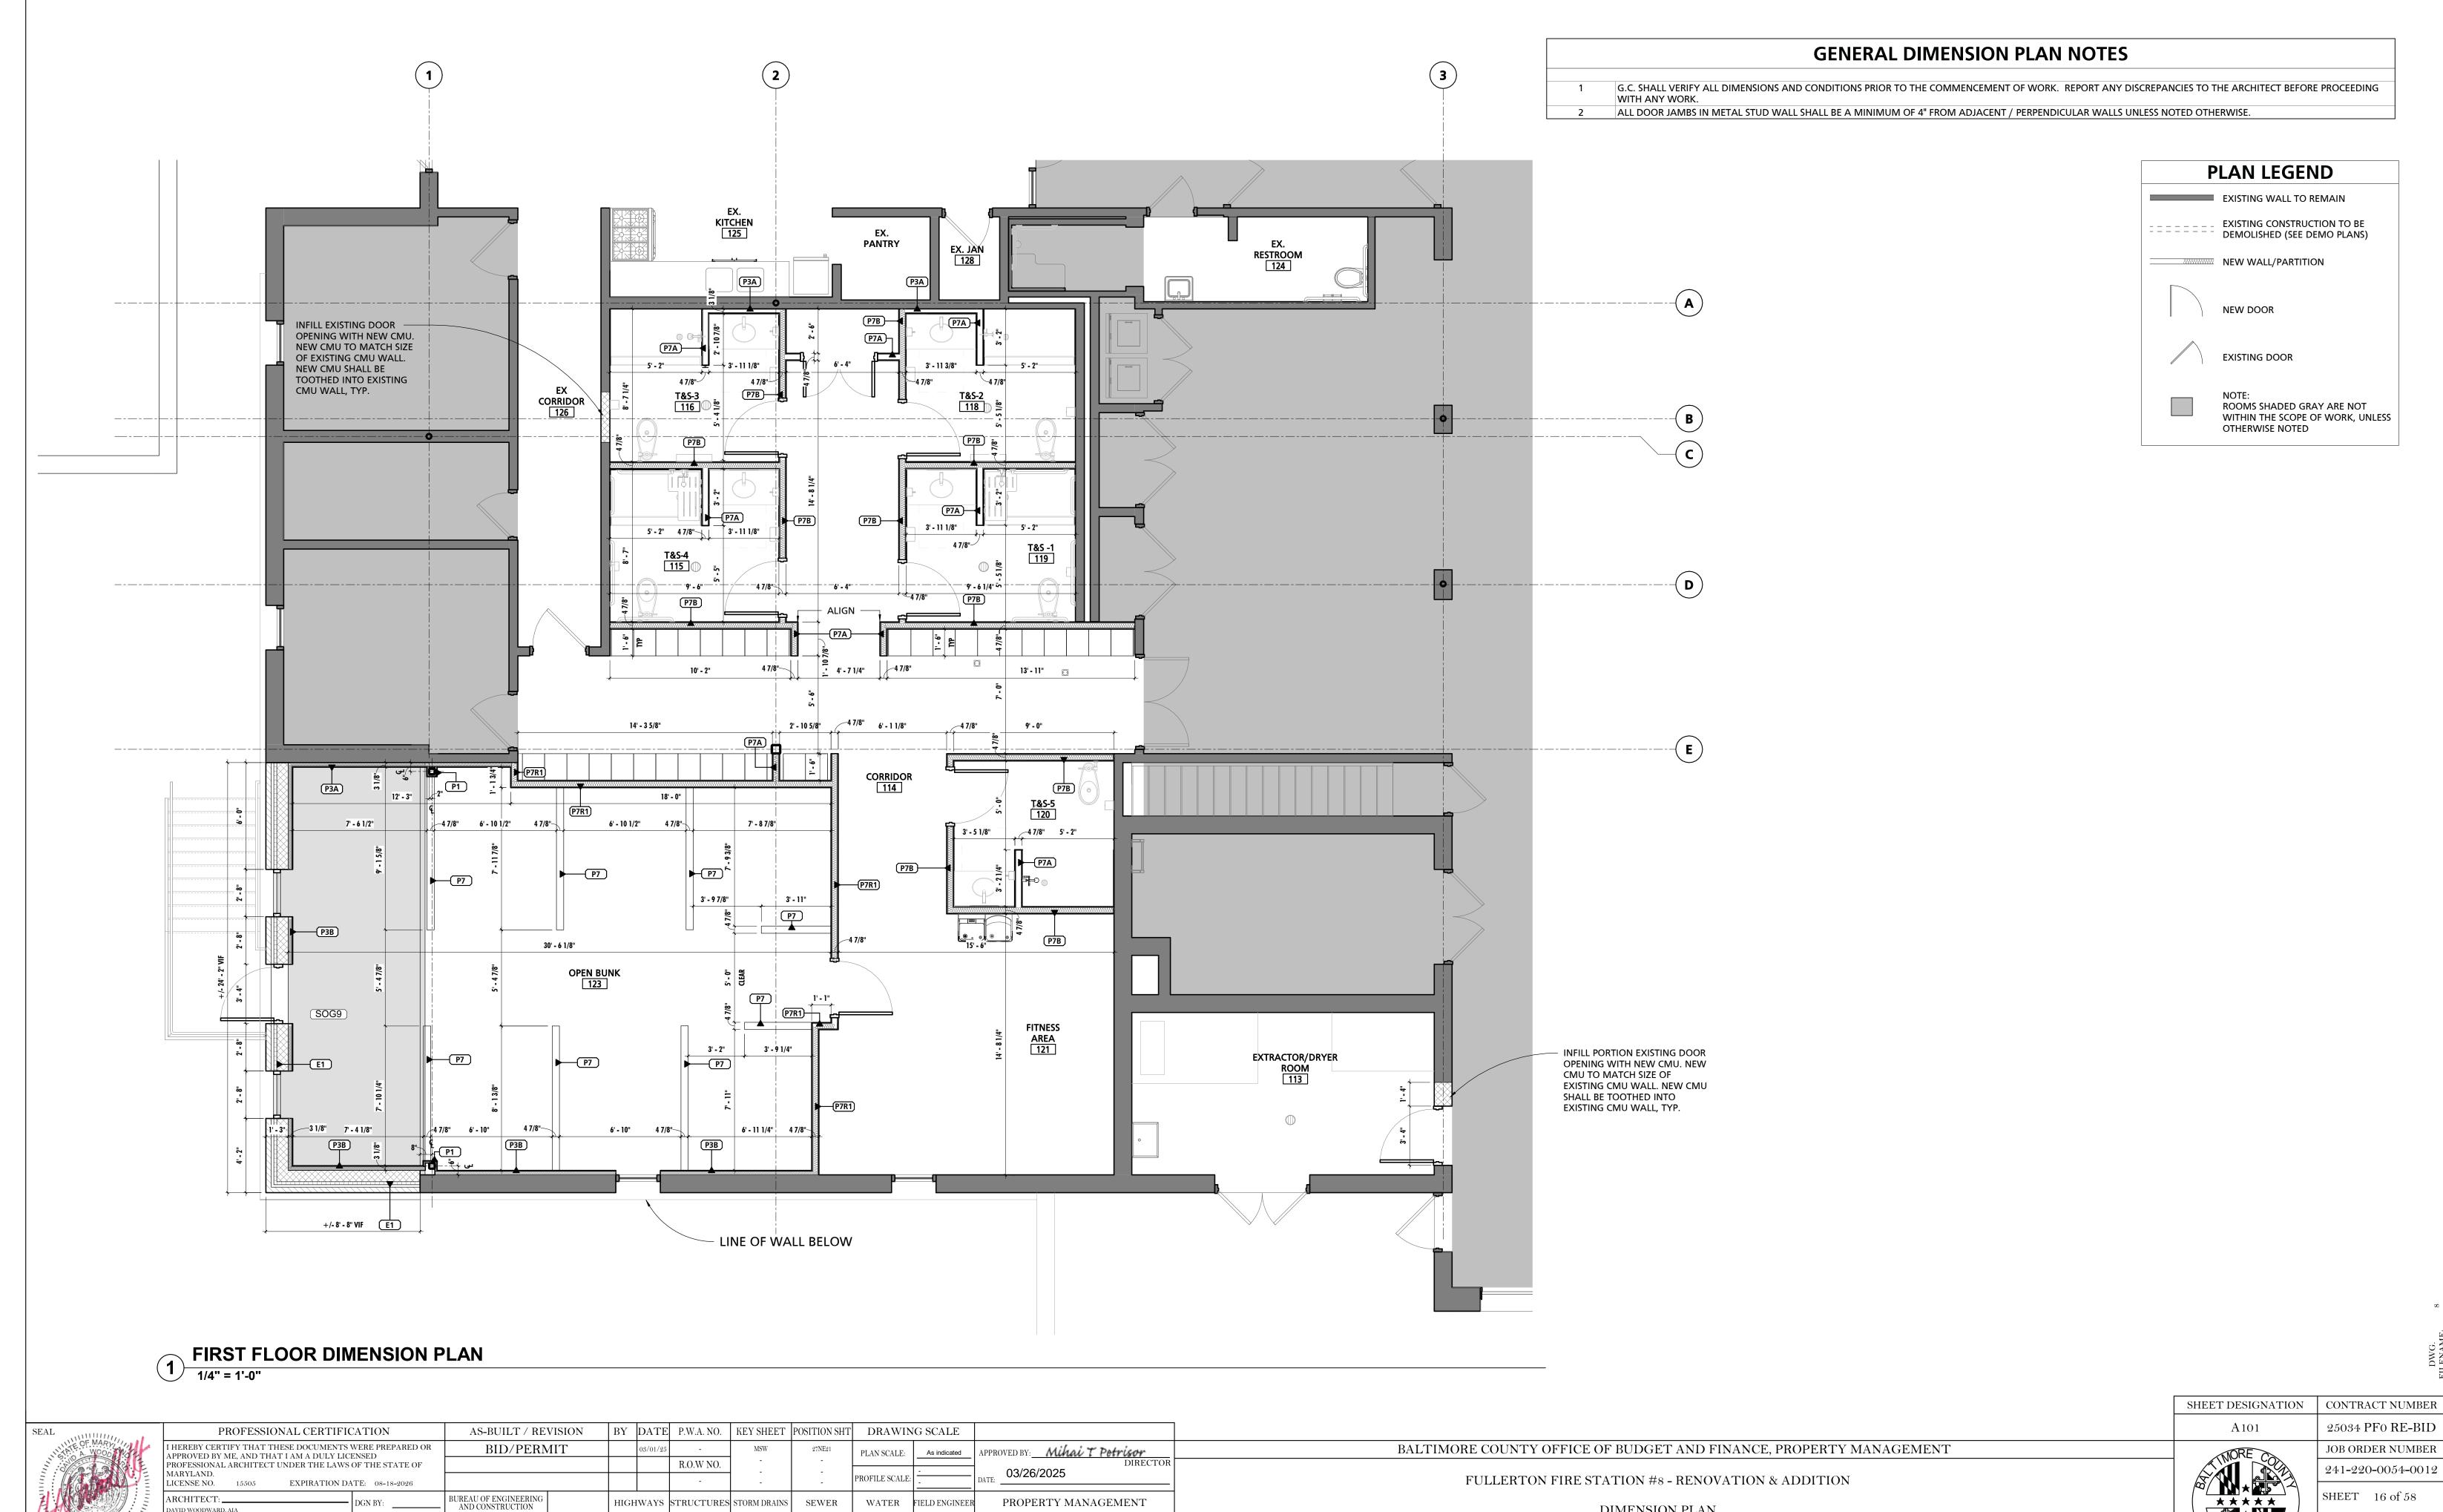

SUBDIVISION: FULLERTON

REVIEWED BY:

DATE REVIEWED:

MANNS WOODWARD STUDIOS 10839-D PHILADELPHIA ROAD WHITE MARSH, MARYLAND 21162

DRAWING NUMBER 2022-2335

FILE NO.: 8

DIMENSION PLAN

4401 FITCH AVENUE, NOTTINGHAM, MARYLAND, 21236

#### **GENERAL PARTITION NOTES**

- OPEN BUNK 123, FITNESS AREA 121, AND CORRIDOR 114 TO RECEIVE IMPACT RESISTANT GYPSUM WALL BOARD, U.N.O.
- PROVIDE FIBERGLASS REINFORCED MOISTURE RESISTANT GYPSUM WALL BOARD IN ALL EQUIPMENT ROOMS, JANITOR'S CLOSETS, RESTROOMS, KITCHENS AND OTHER WET AREAS. PROVIDE FIBERGLASS REINFORCED MOISTURE RESISTANT WALL BOARD IN ALL OTHER AREAS WITHIN 8'-0" OF WATER SOURCE.
- CONTRACTOR SHALL PROVIDE BLOCKING AND NAILERS AS REQUIRED TO SUPPORT ALL NEW WORK, INCLUDING ITEMS TO BE PROVIDED AND/OR INSTALLED BY OWNER. ALL CORRIDOR AND FIRE-RATED PARTITIONS SHALL BE EXTENDED TO THE UNDERSIDE OF THE DECK ABOVE, U.N.O. THE PERIMETER WALLS OF ANY SPACE NOT PROVIDED
- WITH A CEILING SHALL EXTEND TO THE UNDERSIDE OF DECK ABOVE. PROVIDE DEFLECTION TRACKS AT TOP OF ALL NON-LOAD BEARING STUD WALLS EXTENDING TO THE UNDERSIDE OF STRUCTURE ABOVE, U.N.O.
  - ALL FIRE WALLS SHALL BE PLACARDED OR STENCILED ON BOTH SIDES WITH THE PHRASE "FIRE WALL" PER IBC SECTION 703.7.1. THE LETTERS SHALL BE RED IN COLOR, 6" INCHES HIGH AND A MIN. OF 3/4" WIDE. THE PHRASE SHALL BE WRITTEN ONCE FOR EACH 15 FEET OF HORIZONTAL WALL LENGTH. THIS SIGNAGE MAY BE LOCATED IN THE CONCEALED SPACE ABOVE A CEILING.
- MOISTURE RESISTANT GYPSUM WALL BOARD SHALL BE UTILIZED IN ALL AREAS WHERE GYPSUM WALL BOARD IS TO BE DIRECTLY ADHERED TO CONCRETE OR MASONRY SURFACES IN INTERIOR APPLICATIONS. SUBSTRATE SHALL BE CLEANED AS REQUIRED AND FREE OF DUST, DEBRIS, AND MOISTURE PRIOR TO ADHESION AND FINISHING.
- CONSTRUCTION OF RATED WALL ASSEMBLIES SHALL BE STRICTLY ADHERED TO IN ACCORDANCE WITH UL AND/OR GYPSUM ASSEMBLY SPECIFICATIONS. REFER TO CODE
- PLANS FOR ADDITIONAL INFORMATION.
- 9 PROVIDE A BULLNOSE CMU AT ALL OUTSIDE CORNERS OF INTERIOR MASONRY WALLS & SILLS.

#### **SCHEDULE - INTERIOR PARTITION & WALL TYPE**

			FIRE I	RATING
MARK	WIDTH	DESCRIPTION	RATING	ASSEMBLY REF
P1	1 1/2"	7/8" METAL FURRING W/ 5/8" GWB		
P3A	3 1/8"	2 1/2" METAL STUD W/ 5/8" GWB ONE SIDE TO TO EXTEND 6" MIN ABOVE FINISH CEILING		
P3B	3 1/8"	2 1/2" METAL STUD W/ 5/8" GWB ONE SIDE TO EXTEND TO UNDERSIDE OF METAL DECK.		
P7	4 7/8"	3-5/8" METAL STUD W/ 5/8" GYPSUM WALL BOARD EACH SIDE TO EXTEND 48" ABOVE FINISH FLOOR		
P7A	4 7/8"	3-5/8" METAL STUD W/ 5/8" GYPSUM WALL BOARD EACH SIDE TO EXTEND 6" MIN ABOVE FINISH CEILING		
P7B	4 7/8"	3-5/8" METAL STUD W/ 5/8" GYPSUM WALL BOARD EACH SIDE TO EXTEND TO UNDERSIDE OF ROOF DECK		
P7R1	4 7/8"	3-5/8" METAL STUD W/ 5/8" TYPE X GWB EACH SIDE TO EXTEND TO UNDERSIDE OF ROOF DECK - 1 HR RATED	1	UL 419


## **SCHEDULE - EXTERIOR PARTITION & WALL TYPE**


- 1						
				FIRE	RATING	
	MARK	WIDTH	DESCRIPTION	RATING	ASSEMBLY REF	STC RATING
	E1	15"	7 5/8" CMU WITH LIQUID APPLIED AIR BARRIER, 2" RIGID INSULATION, 1 3/4" AIR SPACE AND 3 5/8" BRICK VENEER			


	SCHEDULE - ROOFING TYPE	:S
MARK	DESCRIPTION	COMMENTS
RA1	(2) PLY SBS MODIFIED MEMBRANE OVER 1/2 COVER BOARD, MIN 5 1/2" SLOPED RIGID INSULATION AND 1 1/2" METAL DECK	
RA2	(2) PLY SBS MODIFIED MEMBRANE OVER 1/2 COVER BOARD, SLOPED RIGID INSULATION AND EXISTING ROOF TILE	MATCH EXISTING ROOF SLOPE AND THICKNESS


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	SCHEDULE - FLOOR ASSEMBLY 1	TYPES
MARK	DESCRIPTION	COMMENTS
SOG9	9" CONCRETE SLAB ON GRADE OVER VAPOR BARRIER, 2" RIGID INSULATION AND 8" POROUS FILL	



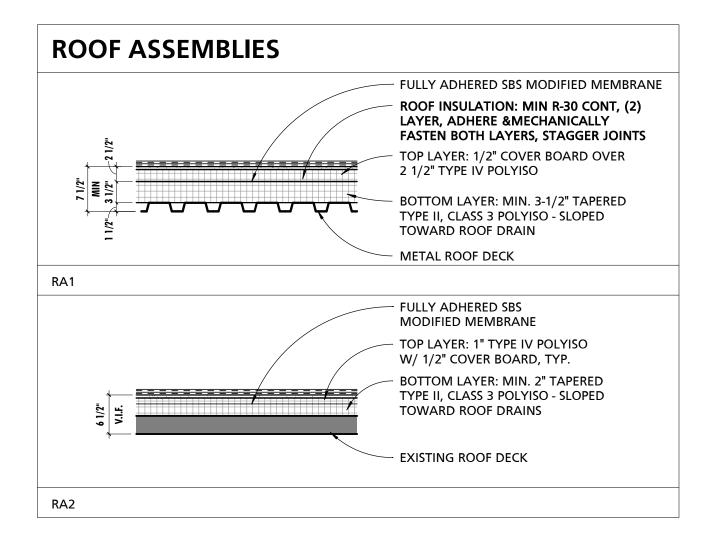


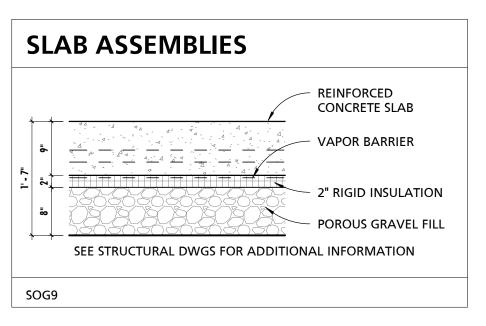


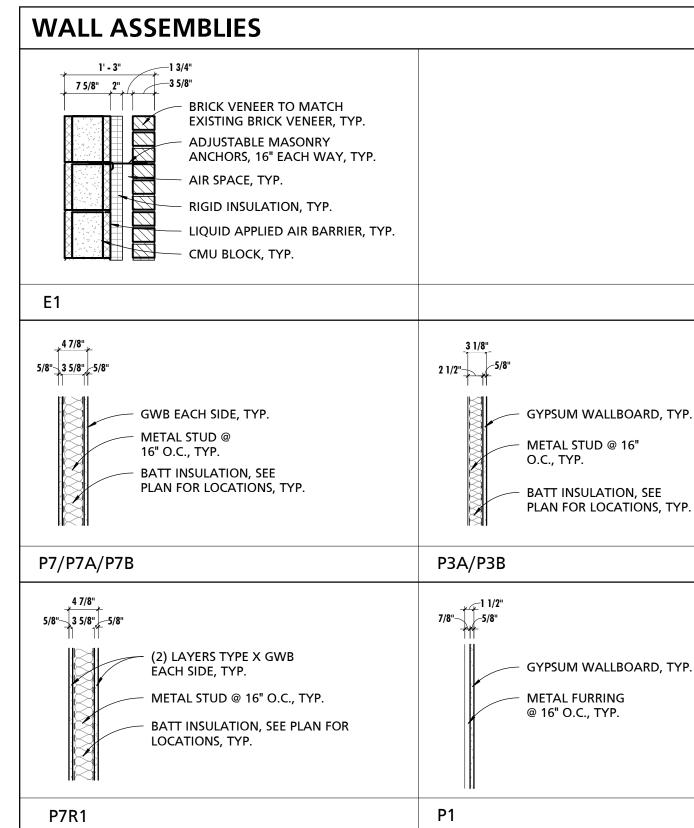

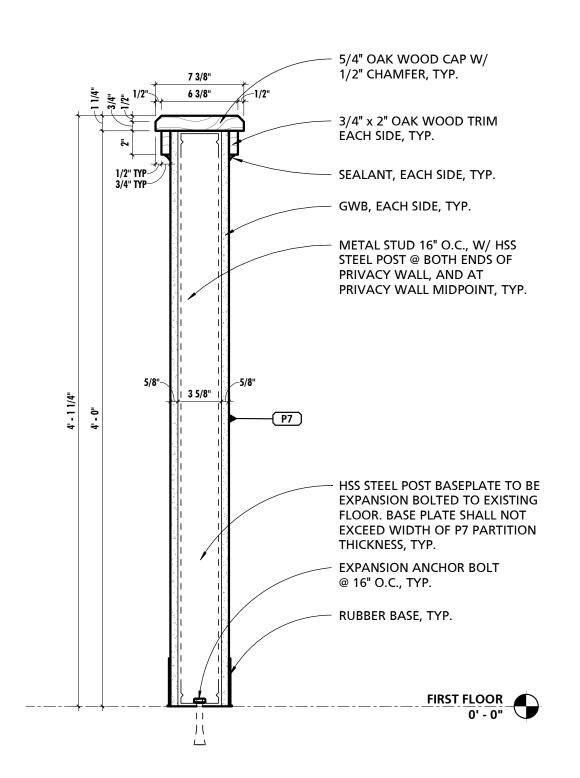
SUBDIVISION: FULLERTON



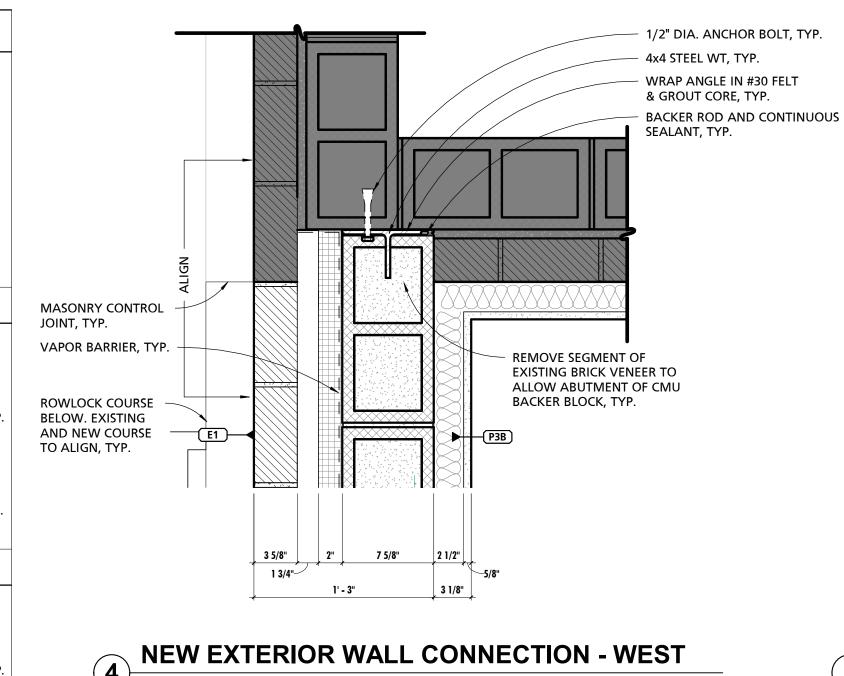


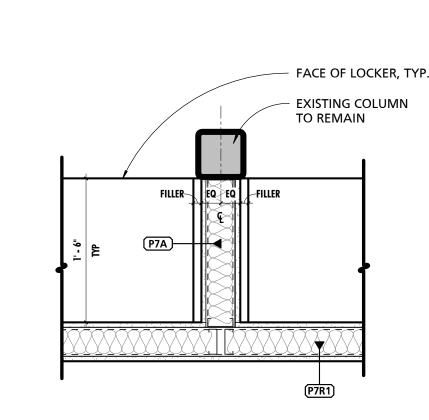




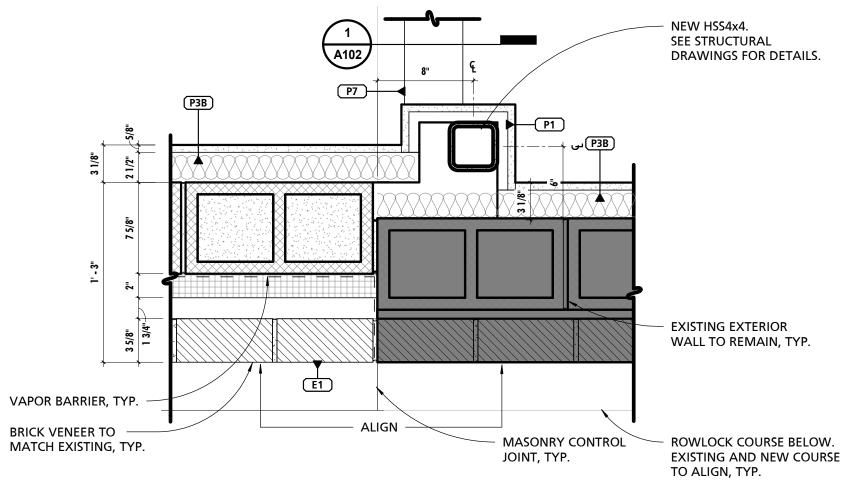

**NEW EXTERIOR WALL CONNECTION - SOUTH** 

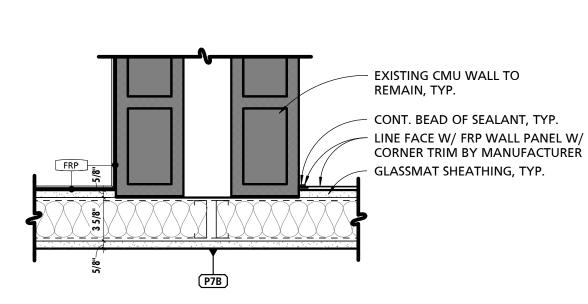

**EXISTING & NEW WALL CONNECTION DETAIL** 

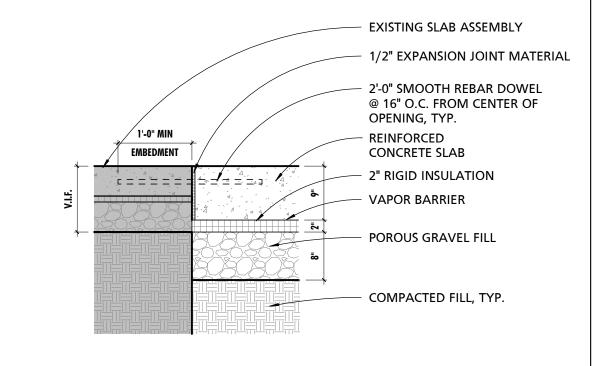

6 TYPICAL TIE-IN DETAIL @ SAW CUT

<u>DATE</u>: 03/01/25

,-	PROFESSIONAL CERTIFIC	AS-BUILT / REVISION	BY	DATE	P.W.A. NO.	KEY SHEET	POSITION SHT	DRAWIN	G SCALE			
£	I HEREBY CERTIFY THAT THESE DOCUMENTS APPROVED BY ME. AND THAT I AM A DULY LIC		BID/PERMIT		03/01/25 - R.O.W NO.		MSW	27NE21	PLAN SCALE: As indicated		APPROVED BY: Mihai T Petrisor	
	PROFESSIONAL ARCHITECT UNDER THE LAWS						-	-			DIRECT	
-	MARYLAND. LICENSE NO. 15505 EXPIRATION DA				-	-	-	PROFILE SCALE:	-	- DATE: 03/26/2025		
		I										
	ARCHITECT: DAVID WOODWARD, AIA	DGN BY:	BUREAU OF ENGINEERING AND CONSTRUCTION	HIGI	HWAYS	STRUCTURES	STORM DRAINS	SEWER	WATER	FIELD ENGINEER	PROPERTY MANAGEMENT	
PRINCIPAL ARCHITECT  MANNS WOODWARD STUDIO	PRINCIPAL ARCHITECT  MANNS WOODWARD STUDIOS	DWN BY:	REVIEWED BY:								APPROVED BY:	
	10839-D PHILADELPHIA ROAD										CHIE	
WHITE MARSH, MARYLAND 21162		CHKD BY:	DATE REVIEWED:								DATE:	

BALTIMORE COUNTY OFFICE OF BUDGET AND FINANCE, PROPERTY MANAGEMENT

FULLERTON FIRE STATION #8 - RENOVATION & ADDITION


BUILDING ASSEMBLY TYPES & DETAILS


4401 FITCH AVENUE, NOTTINGHAM, MARYLAND, 21236

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SHEET DESIGNATION	CONTRACT NUMBER
A102	25034 PF0 RE-BID
MORE CO	JOB ORDER NUMBER
	241-220-0054-0012
* * * * * *	SHEET 17 of 58
	DRAWING NUMBER
	2022-2336

FILE NO.: 8



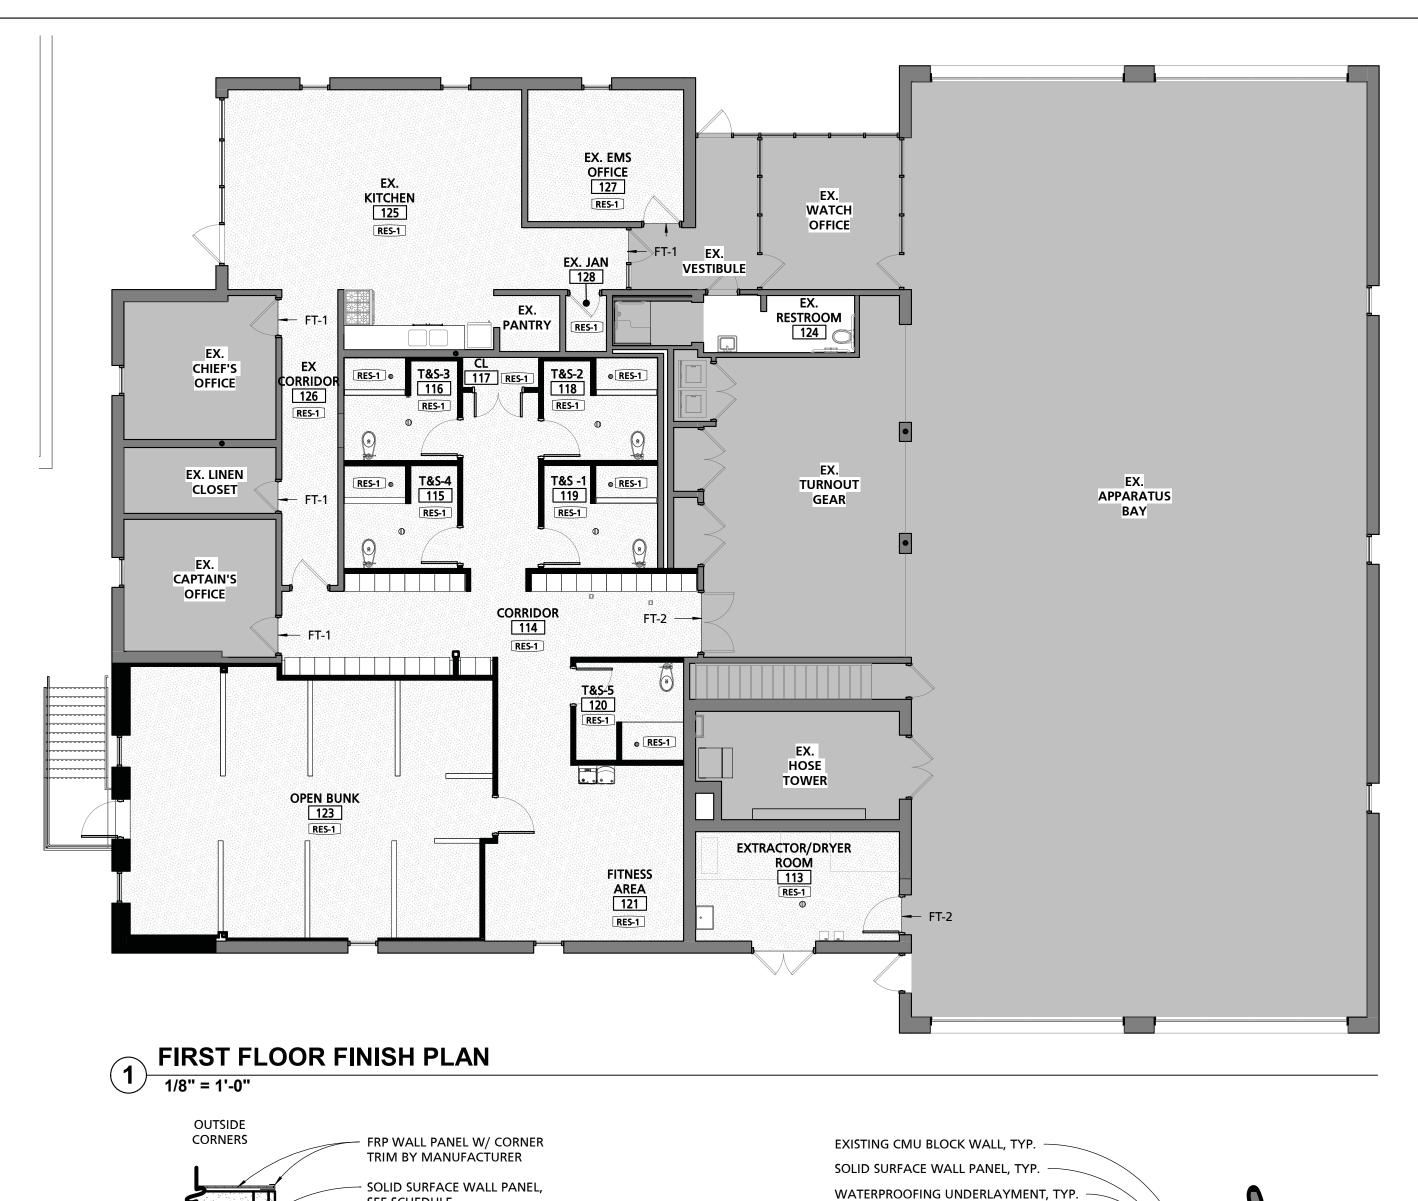


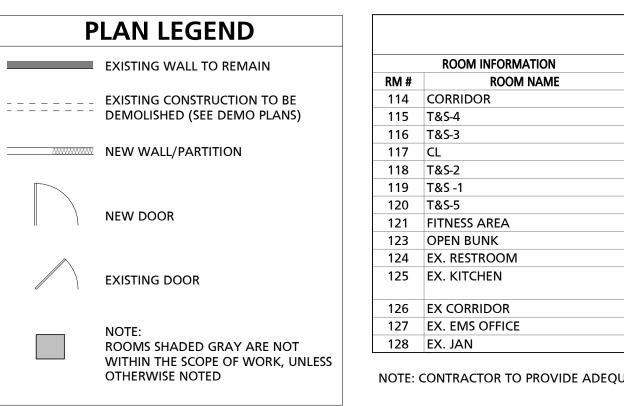	SCHEDULE - FINISHES											
	ROOM INFORMATION	FLOOR		WALL FINISH								
RM#	ROOM NAME	FINISH	BASE	NORTH	SOUTH	EAST	WEST	<b>CEILING FINISH</b>	REMARKS			
114	CORRIDOR	RES-1	B-1	PT-1	PT-1	PT-1	PT-1	CLG-3				
115	T&S-4	RES-1	B-1	FRP	FRP	FRP	FRP	CLG-2/CLG-1	SHOWER STALL WALLS SHALL BE SSWP W/ B-1 COVE BASE. CLG-1 TO RECEIVE PT-2			
116	T&S-3	RES-1	B-1	FRP	FRP	FRP	FRP	CLG-2/CLG-1	SHOWER STALL WALLS SHALL BE SSWP W/ B-1 COVE BASE. CLG-1 TO RECEIVE PT-2			
117	CL	RES-1	B-1	PT-1	PT-1	PT-1	PT-1	CLG-1				
118	T&S-2	RES-1	B-1	FRP	FRP	FRP	FRP	CLG-2/CLG-1	SHOWER STALL WALLS SHALL BE SSWP W/ B-1 COVE BASE. CLG-1 TO RECEIVE PT-2			
119	T&S -1	RES-1	B-1	FRP	FRP	FRP	FRP	CLG-2/CLG-1	SHOWER STALL WALLS SHALL BE SSWP W/ B-1 COVE BASE. CLG-1 TO RECEIVE PT-2			
120	T&S-5	RES-1	B-1	FRP	FRP	FRP	FRP	CLG-2/CLG-1	SHOWER STALL WALLS SHALL BE SSWP W/ B-1 COVE BASE. CLG-1 TO RECEIVE PT-2			
121	FITNESS AREA	RES-1	B-1	PT-1	PT-1	PT-1	PT-1	CLG-3				
123	OPEN BUNK	RES-1	B-1	PT-1	PT-1	PT-1	PT-1	CLG-3				
124	EX. RESTROOM	RES-1	B-1	PT-1	PT-1	PT-1	PT-1	EXISTING				
125	EX. KITCHEN	RES-1	B-1	PT-1	PT-1	PT-1	PT-1	CLG-3	TEMPORARILY REMOVE APPLIANCES AS NEEDED TO INSTALL FLOOR. PROVIDE NEW TOE KICK AT KITCHEN BASE CABINETS AFTER RESINOUS FLOOR HAS BEEN INSTALLED			
126	EX CORRIDOR	RES-1	B-1	PT-1	PT-1	PT-1	PT-1	CLG-3				
127	EX. EMS OFFICE	RES-1	B-1	PT-1	PT-1	PT-1	PT-1	EXISTING				
128	EX. JAN	RES-1	B-1	PT-1	PT-1	PT-1	PT-1	EXISTING				

NOTE: CONTRACTOR TO PROVIDE ADEQUATE FLOOR COVERINGS TO PROTECT EXISTING FLOOR FINISHES IN ROOMS WHERE EXISTING FLOOR FINISHES ARE TO REMAIN.

	SCHEDULE - MATERIAL FINISH KEY									
FINISH MARK	DESCRIPTION	BOD MANUFACTURER	BOD PRODUCT LINE/COLOR	COMMENTS						
		KEY RESIN CO.								
B-1	4" RESINOUS COVE BASE		KEY MMA CHIP 900							
FRP	FIBERGLASS REINFORCED PLASTIC WALL PANELING	CRANE COMPOSITES								
PT-1		SHERWIN WILLIAMS								
PT-2	WALL PAINT	SHERWIN WILLIAMS	#6224 SEMI-GLOSS							
RES-1	RESINOUS COVERING	KEY RESIN CO.	KEY MMA CHIP 900							
SS-1	SOLID SURFACE COUNTERTOP	FORMICA	EVERFORM SOLID SURFACE: COLOR TBD							
SSWP	36X62X84 SOLID SURFACE WALL KIT	SWANSTONE	WALL KIT: MODERN SUBWAY TILE, COLOR TBD	BOTTOM OF KIT @ 4 A.F.F., PROVIDE WITH SOAP SHELVES						


		SCH	HEDULE - CEILING	G TYPES
MARK	DESCRIPTION	BOD MANUFACTURER	BOD MODEL	COMMENTS
CLG 1	5/8" GWB ON 1 1/2" DRYWALL GRID	ARMSTRONG	DRYWALL GRID SYSTEM	
CLG 2	2x2 WASHABLE CEILING TILE	ARMSTRONG	ULTIMA HEALTH ZONE	
CLG 3	2x4 ACOUSTICAL CEILING TILE	ARMSTRONG	FISSURED 895	

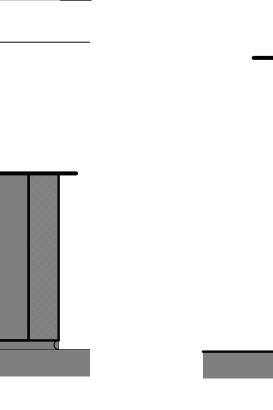


3 5/8" 5/8" /15/64"

4 EPOXY COVE BASE @ SHOWER

SUBDIVISION: FULLERTON

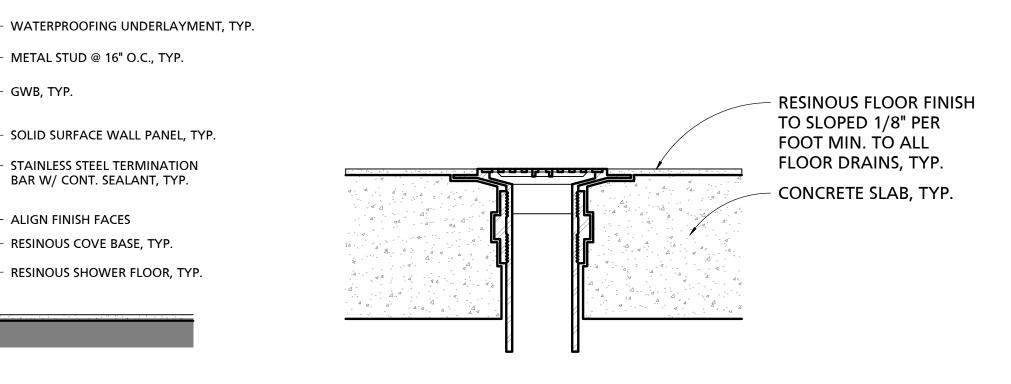

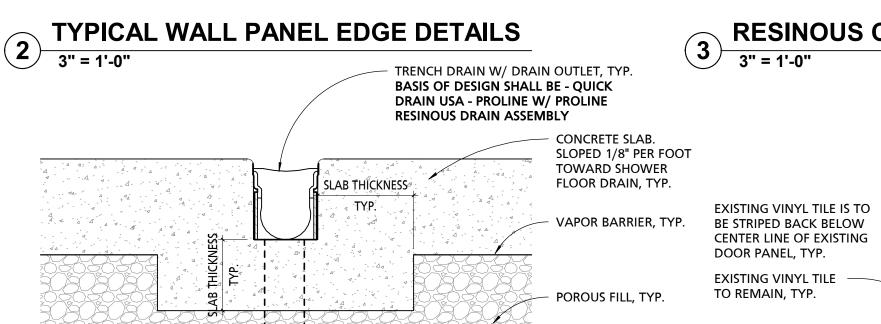

DATE REVIEWED:

CONT. BEAD OF SEALANT

FRP WALL PANEL W/ CORNER

TRIM BY MANUFACTURER

RESINOUS COVE BASE @ MASONRY

3" = 1'-0"

LINE OF EXISTING WALL - EXISTING DOOR PANEL & FRAME, TYP. **RESINOUS COVE** BASE, TYP. DOOR PANEL, TYP. ALUMINUM TRANSITION STRIP, TYP. BASIS OF DESIGN SHALL BE SCHULTER-SCHIENE RESINOUS FLOORING, TYP. RESINOUS FLOORING, TYP. - RESINOUS PRIMER, TYP. RESINOUS PRIMER, TYP. - EXISTING CONCRETE SLAB, TYP.

	DOOR FRAME BEYOND, TYP.
	SAW CUT CONCRETE SLAB, TYP.
	EXISING CONCRETE SLAB, TYP.

5 FLOOR DRAIN
3" = 1'-0"

FT-2
RESINOUS FLOORING (RES-1) TO EXISTING CONCRETE SLAB

– METAL STUD @ 16" O.C., TYP.

- SOLID SURFACE WALL PANEL, TYP.

- STAINLESS STEEL TERMINATION

BAR W/ CONT. SEALANT, TYP.

RESINOUS COVE BASE, TYP.

RESINOUS SHOWER FLOOR, TYP.

- ALIGN FINISH FACES

- GWB, TYP.

TYPICAL SHOWER TRENCH DRAIN DETAIL

SEE SCHEDULE

- SUBSTRATE

**WALL PANEL** 

TRANSITION

FLOOR COVE & INSIDE

WALL CORNER

<u>DATE</u>: 03/01/25

FT-1
RESINOUS FLOORING (RES-1) TO EXISTING VINYL TILE **TRANSITION DETAIL** 7 3" = 1'-0"

ERTIFICATION		AS-BUILT / REVISION		BY	DATE	P.W.A. NO.	KEY SHEET	POSITION SHT	DRAWING SCALE						
UMENTS WERE PREPARED OR DULY LICENSED HE LAWS OF THE STATE OF		BID/PERMIT			03/01/25	-	MSW	27NE21	PLAN SCALE: As indicated		APPROVE	ED BY: M	lihai Ti	Petrisor	
						R.O.W NO.	-	-			DII DATE:			DIRE	CTOR
ATION DATE: 08-18-2026						-	-	-	PROFILE SCALE:	-					
	DGN BY:	BUREAU OF ENGINEERING AND CONSTRUCTION		HIGH	IWAYS	STRUCTURES	STORM DRAINS	SEWER	WATER	FIELD ENGINEER	P	ROPERT	Y MANA	GEMENT	
	DWN DV.	REVIEWED BY:									A DDD OVI	ZD DV			

ALIGN FINISH FACES —

STAINLESS STEEL TERMINATION

RESINOUS SHOWER FLOOR, TYP.

EXISTING CONCRETE SLAB, TYP.

BAR W/ CONT. SEALANT, TYP.

RESINOUS COVE BASE, TYP. -

BALTIMORE COUNTY OFFICE OF BUDGET AND FINANCE, PROPERTY MANAGEMENT

FULLERTON FIRE STATION #8 - RENOVATION & ADDITION

FINISH PLAN, SCHEDULE & DETAILS


4401 FITCH AVENUE, NOTTINGHAM, MARYLAND, 21236

A103
MORE CO
* * * * *

SHEET DESIGNATION	CONTRACT NUMBER	
A103	25034 PFo RE-BID	
MORE	JOB ORDER NUMBER	į
	241-220-0054-0012	
<u> </u>	SHEET 18 of 58	
	DRAWING NUMBER	
	2022-2337	٠

FILE NO.: 8

PROFESSIONAL CER' I HEREBY CERTIFY THAT THESE DOCUM APPROVED BY ME, AND THAT I AM A DU PROFESSIONAL ARCHITECT UNDER THE MARYLAND. LICENSE NO. 15505 ARCHITECT: \_\_\_\_ AVID WOODWARD, AIA MANNS WOODWARD STUDIOS MANNS WOODWARD 31 UDIOS 10839-D PHILADELPHIA ROAD WHITE MARSH, MARYLAND 21162

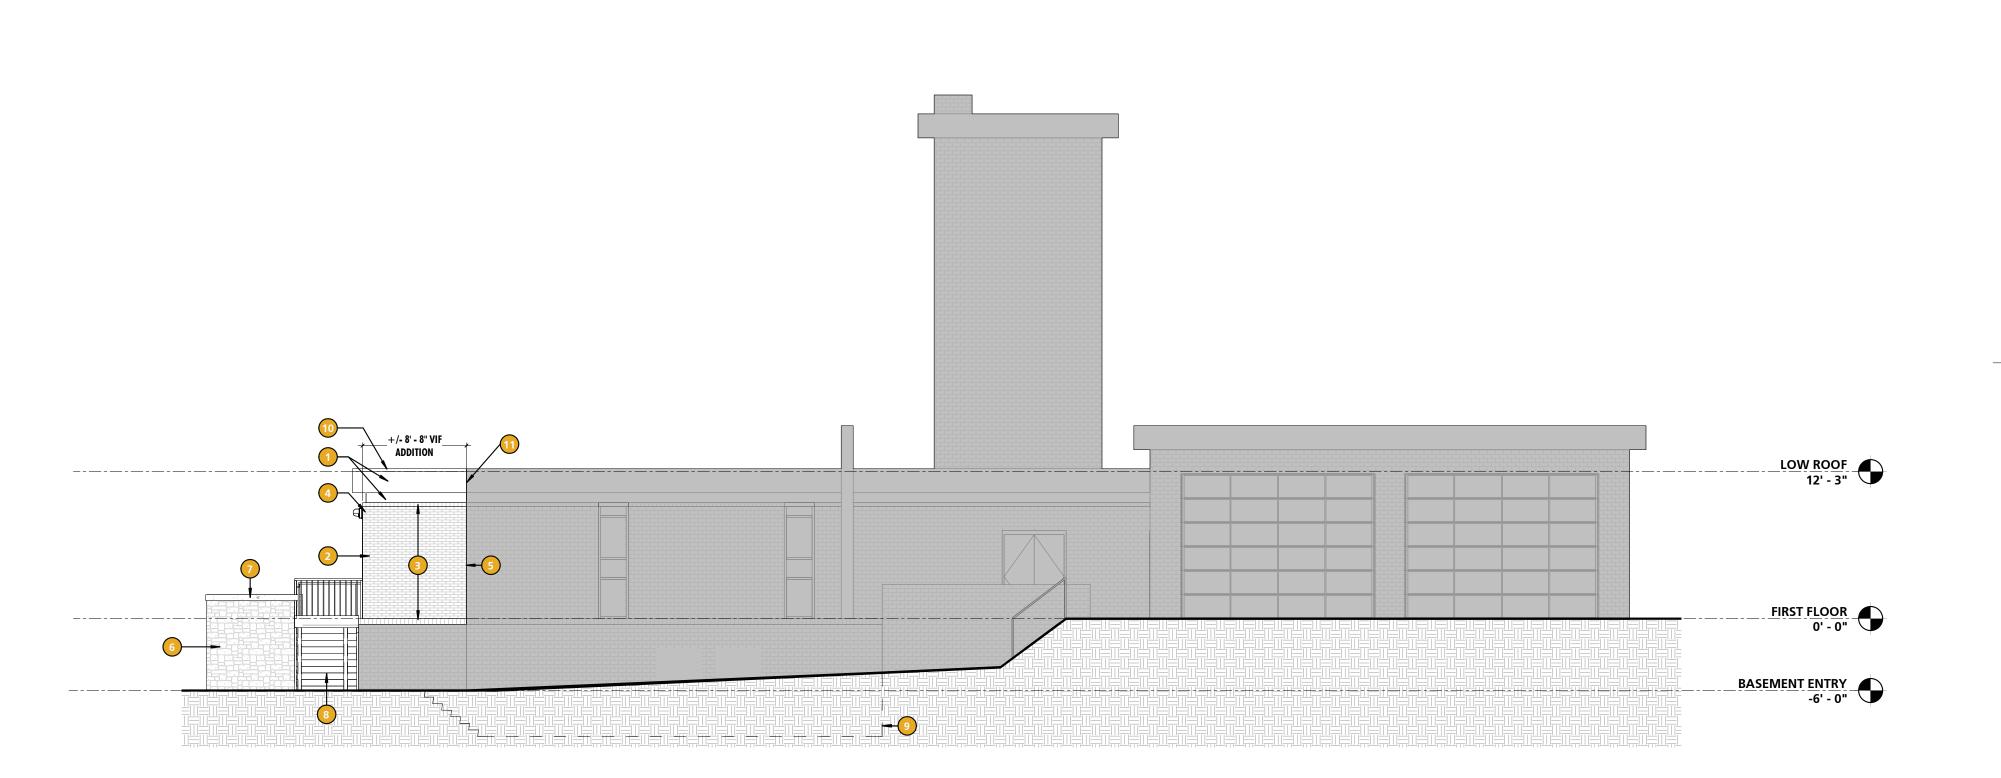

3 EXTERIOR HANDRAIL ELEVATION
1/2" = 1'-0"

**REFERENCED NOTES - ELEVATIONS ELEVATION LEGEND** WALLS SHADED GRAY ARE NOT WITHIN THE SCOPE OF WORK, UPPER & LOWER STUCCO FASCIA. COLOR TO MATCH EXISTING GLASWELD FASCIA UNLESS OTHERWISE NOTED NEW BRICK VENEER TO MATCH EXISTING BRICK VENEER IN SIZE, SHAPE AND COLOR MIX. BRICK MORTAR TO MATCH EXISTING MORTAR. NEW BRICK ROWLOCK COURSE TO MATCH EXISTING. ELEVATION OF ROWLOCK BANDING TO ALIGN WITH EXISTING ROWLOCK BANDING. 4 RELOCATED EXISTING WALL PACK. COORDINATE WITH ELECTRICAL. BRICK CONTROL JOINT. NEW CAST-IN-PLACE STAINED CONCRETE RETAINING WALL. RETAINING WALL FORMLINER MODEL # 1606 ROYALITE STONE. BOD - CUSTOM ROCK. STAIN TO PROVIDE BLEND OF MULTIPLE COLORS FOR ROCK PATTERNS AND SECONDARY COLOR FOR MORTAR JOINT PATTERNS. NEW CAST-IN-PLACE STAINED CONCRETE WALL CAP EXTERIOR BASEMENT ACCESS OUTLINE PREFINISHED METAL FASCIA. COLOR TO MATCH EXISTING METAL FASCIA. UPPER & LOWER STUCCO FASCIA CONTROL JOINT LOW ROOF 12' - 3" FIRST FLOOR
0' - 0" +/- 24' - 2" VIF **WEST ELEVATION** 

BY DATE P.W.A. NO. KEY SHEET POSITION SHT DRAWING SCALE AS-BUILT / REVISION PROFESSIONAL CERTIFICATION APPROVED BY: Mihai T Petrisor I HEREBY CERTIFY THAT THESE DOCUMENTS WERE PREPARED OR APPROVED BY ME, AND THAT I AM A DULY LICENSED PROFESSIONAL ARCHITECT UNDER THE LAWS OF THE STATE OF BID/PERMIT PLAN SCALE: As indicated R.O.W NO. 03/26/2025 MARYLAND. LICENSE NO. 15505 EXPIRATION DATE: 08-18-2026 BUREAU OF ENGINEERING AND CONSTRUCTION PROPERTY MANAGEMENT HIGHWAYS STRUCTURES STORM DRAINS SEWER WATER FIELD ENGINEER REVIEWED BY: APPROVED BY: MANNS WOODWARD STUDIOS 10839-D PHILADELPHIA ROAD WHITE MARSH, MARYLAND 21162 DATE REVIEWED:

SOUTH ELEVATION

1/8" = 1'-0"

BALTIMORE COUNTY OFFICE OF BUDGET AND FINANCE, PROPERTY MANAGEMENT FULLERTON FIRE STATION #8 - RENOVATION & ADDITION BUILDING ELEVATIONS 4401 FITCH AVENUE, NOTTINGHAM, MARYLAND, 21236 ELECTION DIST. NO.: 14C5


SUBDIVISION: FULLERTON

SHEET DESIGNATION | CONTRACT NUMBER 25034 PF0 RE-BID JOB ORDER NUMBER 241-220-0054-0012 SHEET 19 of 58 DRAWING NUMBER 2022-2338 FILE NO.: 8


FIRST FLOOR
0' - 0"

\_\_1-1/2" O.D. CONTINUOUS GALVANIZED STEEL \_HANDRAIL @ 3'-0" ABOVE TREAD NOSING W/

BRACKETS @ 36" O.C. MAX, TYP.

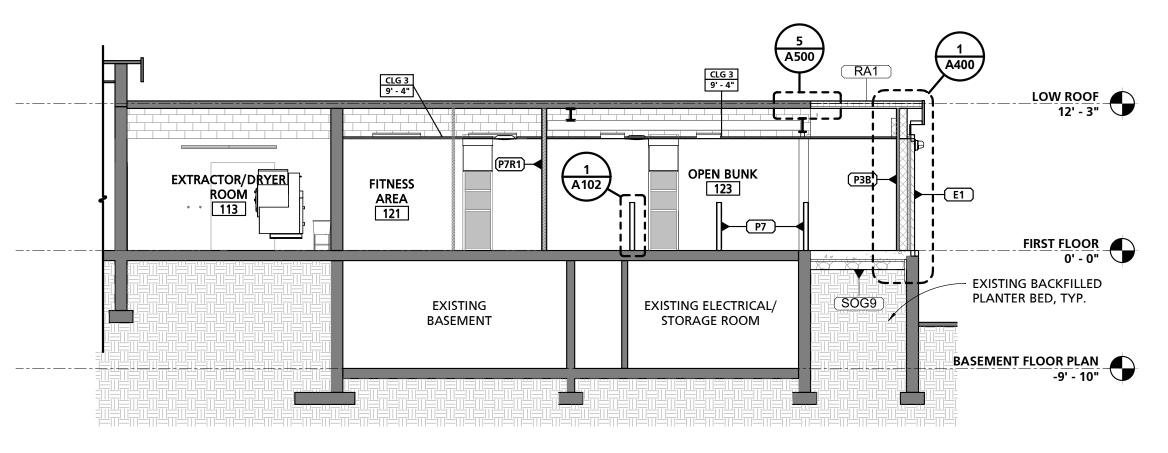

# PARTIAL LONGITUDINAL BUILDING SECTION THROUGH OPEN BUNK 1/8" = 1'-0"

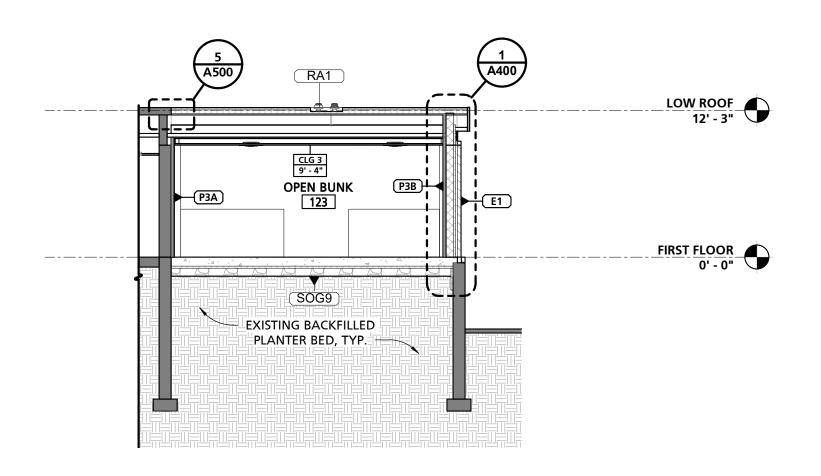

PARTIAL TRANSVERSE BUILDING SECTION THROUGH BUNK ROOM

SEAL	PROFESSIONAL CERTIFIC	CATION	AS-BUILT / REVISION	BY	DATE	P.W.A. NO.	KEY SHEET	POSITION SHT	DRAWIN	G SCALE	
OF MARY	I HEREBY CERTIFY THAT THESE DOCUMENTS APPROVED BY ME, AND THAT I AM A DULY LIC		BID/PERMIT		03/01/25	-	MSW	27NE21	PLAN SCALE:	1/8" = 1'-0"	APPRO
	PROFESSIONAL ARCHITECT UNDER THE LAWS					R.O.W NO.	-	-			1
	MARYLAND. LICENSE NO. 15505 EXPIRATION DA	ATE: 08-18-2026				-	] :	-	PROFILE SCALE:	-	DATE:
	ARCHITECT:	DGN BY:	BUREAU OF ENGINEERING AND CONSTRUCTION	HIG	HWAYS	STRUCTURES	STORM DRAINS	SEWER	WATER	FIELD ENGINEER	
A CHITECHINA	PRINCIPAL ARCHITECT  MANNS WOODWARD STUDIOS 10839-D PHILADELPHIA ROAD	DWN BY:	REVIEWED BY:								APPR
DATE: 03/01/25	WHITE MARSH, MARYLAND 21162 (P) 410-344-1460	СНКО ВҮ:	DATE REVIEWED:								DATE:
			·								

SUBDIVISION: FULLERTON

PROPERTY MANAGEMENT

4401 FITCH AVENUE, NOTTINGHAM, MARYLAND, 21236

ELECTION DIST. NO.: 14C5

20 of 58 VING NUMBER

SHEET DESIGNATION | CONTRACT NUMBER 25034 PF0 RE-BID A300 JOB ORDER NUMBER 20-0054-0012

FULLERTON FIRE STATION #8 - RENOVATION & ADDITION


BALTIMORE COUNTY OFFICE OF BUDGET AND FINANCE, PROPERTY MANAGEMENT

**GENERAL BUILDING SECTION NOTES** 


BUILDING SECTIONS ARE INTENDED TO SHOW OVERALL RELATIONSHIPS OF SPACES, OVERALL ASSEMBLIES, AND THE GEOMETRY OF THE BUILDING. SEE REFERENCED WALL SECTIONS AND DETAILS FOR ADDITIONAL INFORMATION.

BUILDING SECTIONS

MORE	JOB ORDER NUMB
	241-220-0054-00
	SHEET 20 of 58
	DRAWING NUMB
ARY AND	2022-2339
1111	FILE NO · 8

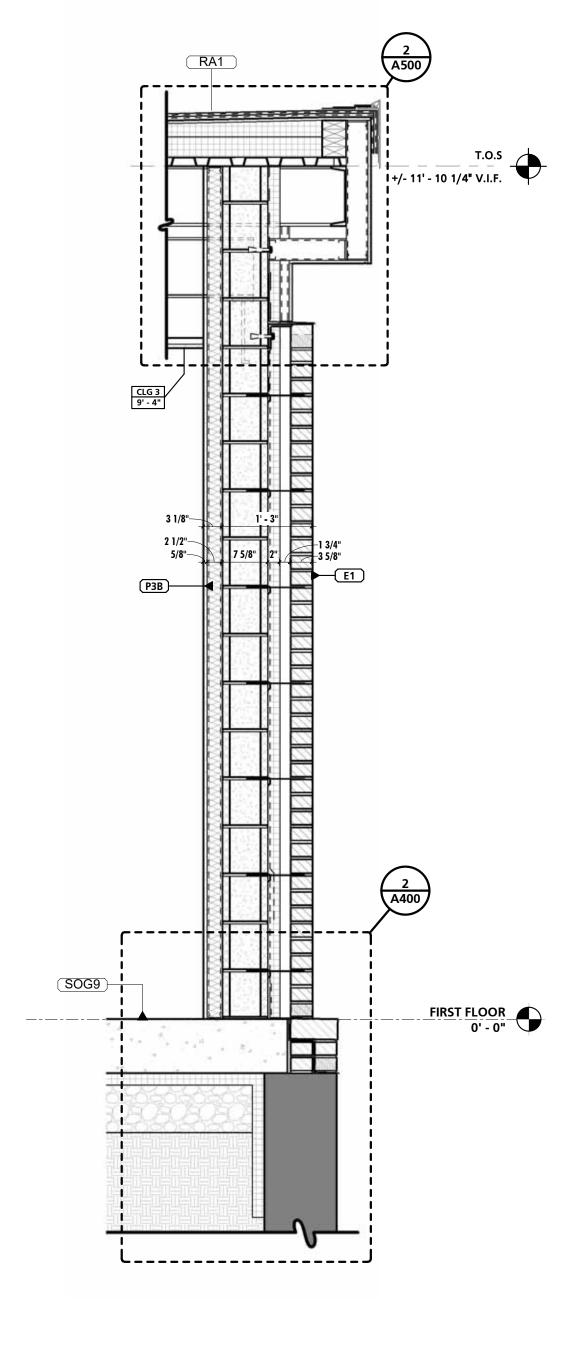

1 TYPICAL ADDITION WALL SECTION
3/4" = 1'-0"

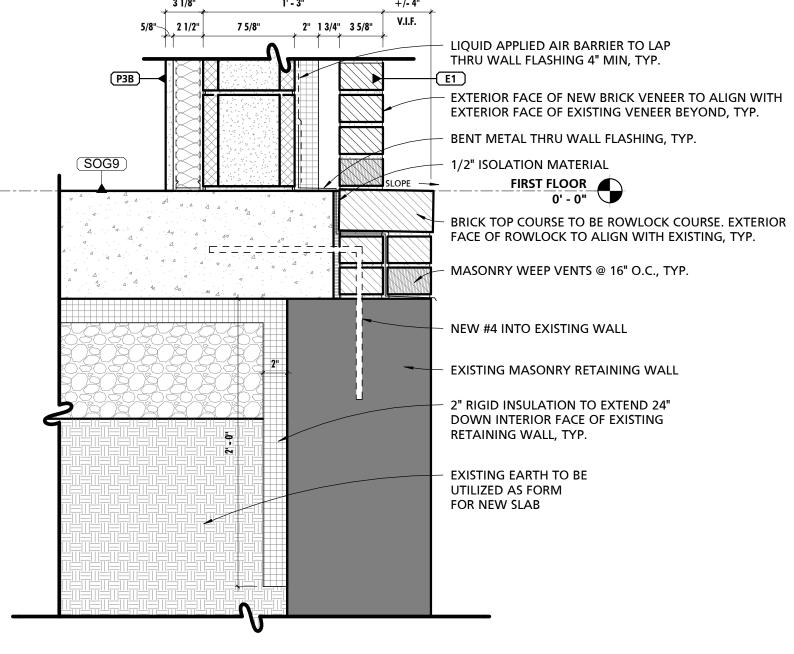

SUBDIVISION: FULLERTON

TYPICAL ADDITION FOUNDATION DETAIL


SEAL	PROFESSIONAL CERTIFIC	CATION	AS-BUILT / RE	VISION	BY	DATE	P.W.A. NO.	KEY SHEET	POSITION SHT	DRAWIN	G SCALE		
TATE OF MARY	I HEREBY CERTIFY THAT THESE DOCUMENTS WERE PREPARED OR APPROVED BY ME, AND THAT I AM A DULY LICENSED PROFESSIONAL ARCHITECT UNDER THE LAWS OF THE STATE OF MARYLAND.  LICENSE NO. 15505 EXPIRATION DATE: 08-18-2026		BID/PERN	ЛІТ		03/01/25	-	MSW	27NE21	PLAN SCALE:	As indicated	APPROVED BY: Mihai T Petrisor	
							R.O.W NO.	-	-			DIRE	CTO
							-	- -	-	PROFILE SCALE:	-	03/26/2025	
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	ARCHITECT:	DGN BY:	BUREAU OF ENGINEERING AND CONSTRUCTION		HIGH	IWAYS	STRUCTURES	STORM DRAINS	SEWER	WATER	FIELD ENGINEER	PROPERTY MANAGEMENT	
STATE CHITECHINE	PRINCIPAL ARCHITECT  MANNS WOODWARD STUDIOS	DWN BY:	REVIEWED BY:									APPROVED BY:	CHIE
DATE: 03/01/25	10839-D PHILADELPHIA ROAD WHITE MARSH, MARYLAND 21162 (P) 410-344-1460	CHKD BY:	DATE REVIEWED:									DATE:	CHIE


BALTIMORE COUNTY OFFICE OF BUDGET AND FINANCE, PROPERTY MANAGEMENT FULLERTON FIRE STATION #8 - RENOVATION & ADDITION WALL SECTIONS 4401 FITCH AVENUE, NOTTINGHAM, MARYLAND, 21236 ELECTION DIST. NO.: 14C5


SHEET DESIGNATION CONTRACT NUMBER A400


25034 PF0 RE-BID JOB ORDER NUMBER 241-220-0054-0012 SHEET 21 of 58 DRAWING NUMBER 2022-2340

FILE NO.: 8

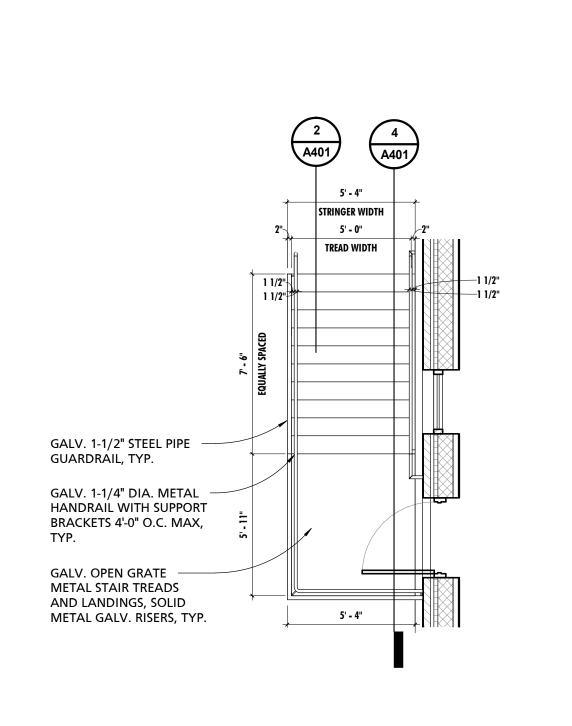

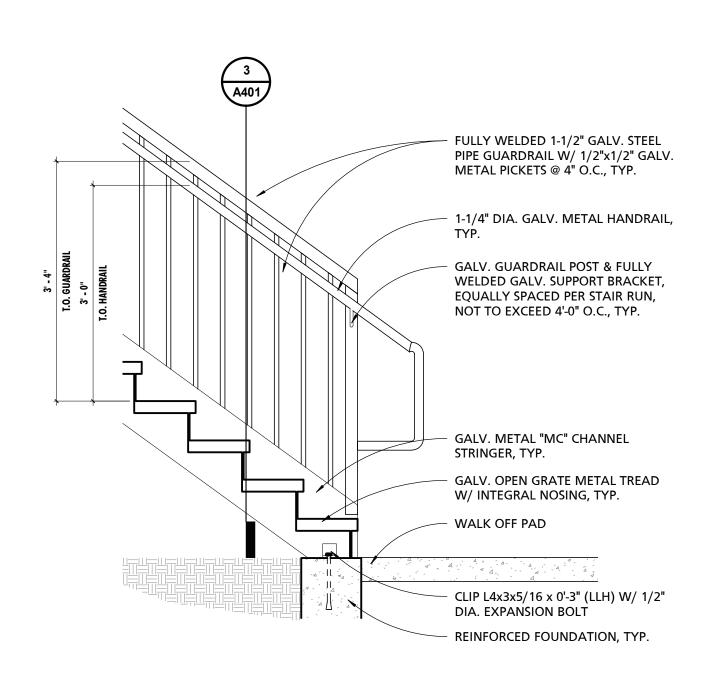

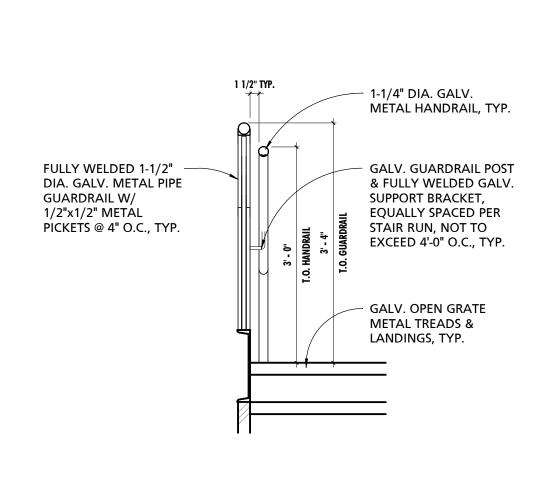

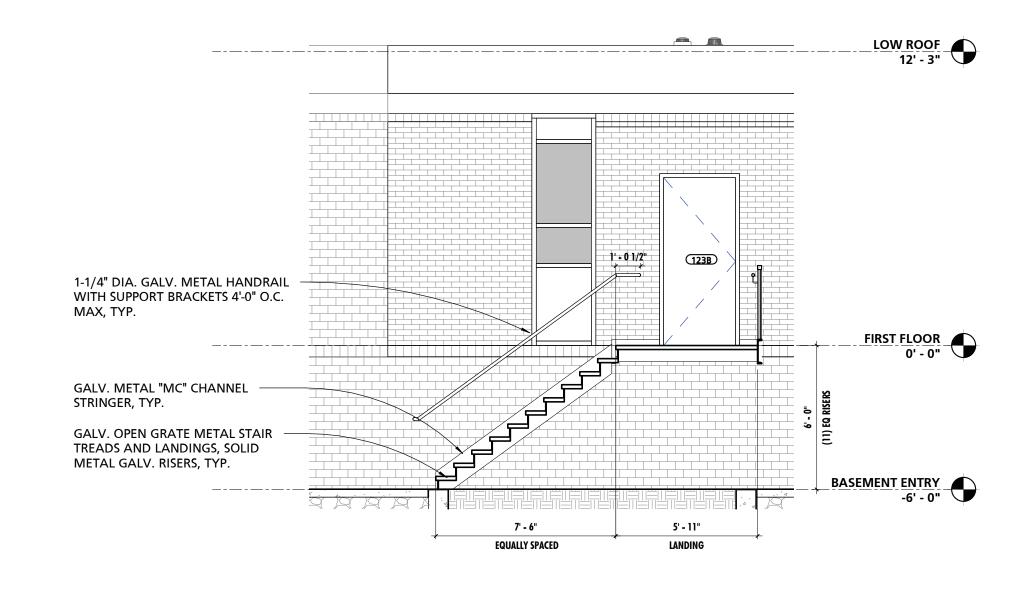

**EXTERIOR STAIR - FIRST FLOOR LANDING** 

**EXTERIOR STAIR DETAIL** 

TYPICAL EXTERIOR RAILING

SUBDIVISION: FULLERTON

**EXTERIOR STAIR SECTION** 

SEAL	PROFESSIONAL CERTIFIC	CATION	AS-BUILT / RE	VISION	BY	DATE	P.W.A. NO.	KEY SHEET	POSITION SHT	DRAWIN	G SCALE		
WO WO WW	I HEREBY CERTIFY THAT THESE DOCUMENTS WERE PREPARED OR APPROVED BY ME, AND THAT I AM A DULY LICENSED		BID/PERN	ЛІТ		03/01/25	-	MSW	27NE21	PLAN SCALE:	As indicated	APPROVED BY: Mihai T Petrisor	
	PROFESSIONAL ARCHITECT UNDER THE LAWS MARYLAND.						R.O.W NO.	-	-		-	03/26/2025	RECT
		ATE: 08-18-2026					-	-	-	PROFILE SCALE:	-	DATE:	
	ARCHITECT:	DGN BY:	BUREAU OF ENGINEERING AND CONSTRUCTION		HIGHV	WAYS	STRUCTURES	STORM DRAINS	SEWER	WATER	FIELD ENGINEER	PROPERTY MANAGEMEN	Т
DATE: 03/01/25	PRINCIPAL ARCHITECT  MANNS WOODWARD STUDIOS 10839-D PHILADELPHIA ROAD	DWN BY:	REVIEWED BY:									APPROVED BY:	CH
	WHITE MARSH, MARYLAND 21162 (P) 410-344-1460	CHKD BY:	DATE REVIEWED:									DATE:	


BALTIMORE COUNTY OFFICE OF BUDGET AND FINANCE, PROPERTY MANAGEMENT FULLERTON FIRE STATION #8 - RENOVATION & ADDITION

STAIR DETAILS


4401 FITCH AVENUE, NOTTINGHAM, MARYLAND, 21236


ELECTION DIST. NO.:	14C5	* * * * * * * * * * * * * * * * * * * *

SHEET DESIGNATION	CONTRACT NUMBER
A401	25034 PF0 RE-BID
MORE C	JOB ORDER NUMBER
	241-220-0054-0012
<u> </u>	SHEET 22 of 58
	DRAWING NUMBER
A NOTE OF THE PARTY OF THE PART	
	FILE NO.: 8 REV. 10/13

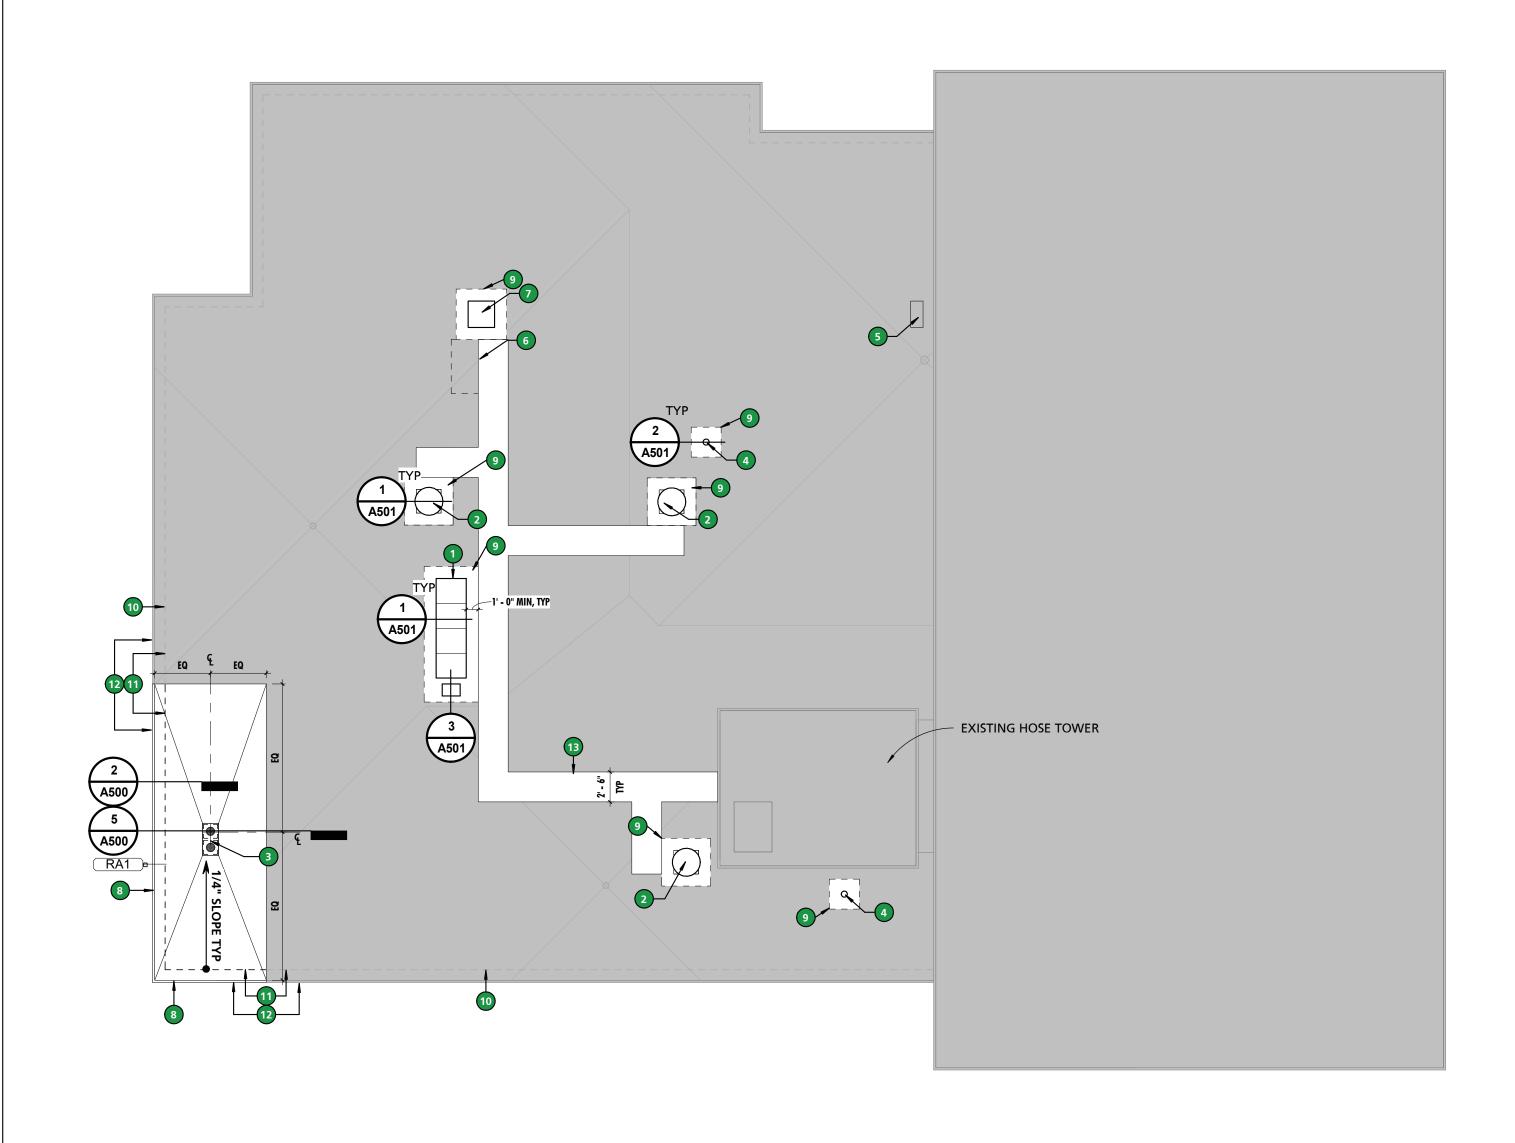

# 1 ROOF PLAN

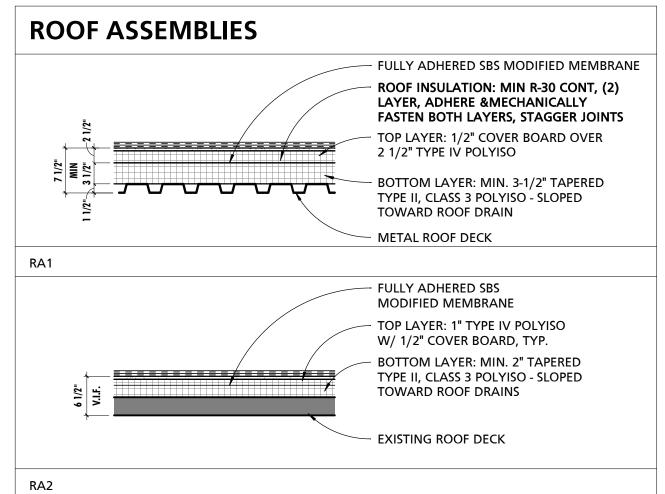

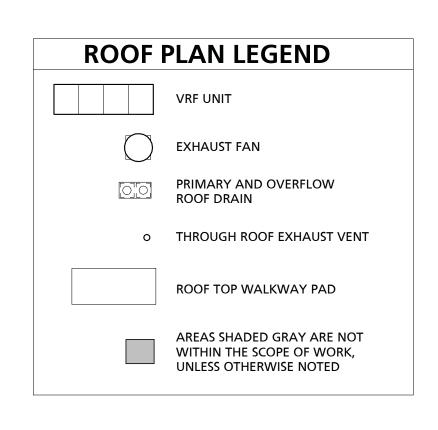

SEAL	PROFESSIONAL CERTIFI	CATION	AS-BUILT / REV	VISION	BY	DATE	P.W.A. NO.	KEY SHEET	POSITION SHT	DRAWIN	NG SCALE		
A WOOD W	I HEREBY CERTIFY THAT THESE DOCUMENTS WERE PREPARED OR APPROVED BY ME, AND THAT I AM A DULY LICENSED		BID/PERM	1IT		03/01/25	-	MSW	27NE21	PLAN SCALE:	As indicated	APPROVED BY: Mihai T Petrisor	
	PROFESSIONAL ARCHITECT UNDER THE LAWS						R.O.W NO.	-	-		-	DIREC . 03/26/2025	ТОІ
		OATE: 08-18-2026					-	-	-	PROFILE SCALE:	-	DATE:	
	ARCHITECT:	DGN BY:	BUREAU OF ENGINEERING AND CONSTRUCTION		HIGH	HWAYS	STRUCTURES	STORM DRAINS	SEWER	WATER	FIELD ENGINEER	PROPERTY MANAGEMENT	
15505 CHITECHINE	PRINCIPAL ARCHITECT  MANNS WOODWARD STUDIOS 10839-D PHILADELPHIA ROAD	DWN BY:	REVIEWED BY:									APPROVED BY:	HIEI
DATE : 03/01/25	WHITE MARSH, MARYLAND 21162 (P) 410-344-1460	CHKD BY:	DATE REVIEWED:			·						DATE:	HEI

NOTE #	NOTE
1	BLOCKING/MISCELLANEOUS FRAMING INDICATED WITHIN THE DOCUMENTS IS SHOWN FOR THE PURPOSES OF DESIGN INTENT. IT SHALL BE THE CONTRACTORS RESPONSIBILITY, WHETHER SHOWN OR NOT SHOWN, TO PROVIDE BLOCKING/MISCELLANEOUS FRAMING AS REQUIRED TO PROPERLY SUPPORT ALL SUBSTRATES, FLASHINGS, COPINGS, BRAKE METAL, SOFFITS, INSULATIONS, CLIPS, STOPS, MISCELLANEOUS ITEMS, ROOFING MEMBRANES OR SYSTEMS AND SIMILAR ITEMS REQUIRED TO COMPLETE THE WORK. WHERE ADDITIONAL BLOCKING/MISCELLANEOUS FRAMING, INCLUDING BUT NOT LIMITED TO THE REPLACEMENT OF INDICATED SHEATHING/DECKING, IS RECOMMENDED BY ONE OF THE ASSEMBLY COMPONENTS MANUFACTURER, THE CONTRACTOR SHALL PROVIDE AND INSTALL SUCH BLOCKING/MISCELLANEOUS FRAMING TO COMPLY WITH THE MANUFACTURER'S RECOMMENDATIONS
2	CONTRACTOR SHALL BE RESPONSIBLE FOR COORDINATING FINAL ROOFING SUBSTRATE REQUIREMENTS TO ENSURE SUCCESSFUL INSTALLATION OF ROOFING MATERIALS IN A MANNER THAT MAINTAINS THE FULL PRODUCT WARRANTY AND COMPLIES WITH ALL APPLICABLE BUILDING CODES OF THE AHJ.
3	PENETRATION DETAILS ARE FOR REFERENCE ONLY. CONTRACTOR TO REVIEW FULL EXTENT OF PENETRATIONS AND ASSOCIATED LOCATIONS WITH ALL OTHER DRAWINGS WITHIN THE DOCUMENT SET.
4	AT ALL AREAS TO RECEIVE ROOF PATCHING, INFILLING AND NEW EQUIPMENT CURB WORK, CONTRACTOR TO ENSURE ADEQUATE SLOPE TO EXISTING ROOF DRAINAGE IS MAINTAINED.


(2) PLY SBS MODIFIED MEMBRANE OVER 1/2 COVER BOARD, SLOPED RIGID MATCH EXISTING ROOF SLOPE AND INSULATION AND EXISTING ROOF TILE THICKNESS

DESCRIPTION

(2) PLY SBS MODIFIED MEMBRANE OVER 1/2 COVER BOARD, MIN 5 1/2"


SLOPED RIGID INSULATION AND 1 1/2" METAL DECK

0	REFERENCED NOTES - ROOF PLANS
NO.	NOTE
1	CURB MOUNTED VRF UNIT.
2	CURB MOUNTED EXHAUST FAN.
3	PRIMARY & OVERFLOW ROOF DRAIN W/ CAST IRON BODY & POLYETHLENE STRAINER.
4	THRU ROOF EXHAUST VENT.
5	EXISTING SPLIT SYSTEM UNIT TO REMAIN.
6	CONTRACTOR TO DISSCONNECT AND REMOVE ROOF TOP UNIT AND ALL ASSOCIATED APPURTENANCES IN THEIR ENTIRETY. PREPARE OPENING TO RECEIVE NEW DECKING, RIGID INSULATION, AND ROOF MEMBRANE TO MATCH EXISTING ROOF ASSEMBLY.
7	CURB MOUNTED INTAKE LOUVER.
8	PREFINISHED ALUMINUM FASCIA COPING TO MATCH EXISTING COPING IN PROFILE, THICKNESS, AND COLOR.
9	ROOF ASSEMBLY (RA2) TO MATCH EXISTING SLOPE AND THICKNESS.
10	DASHED LINE INDICATES EXTERIOR FACE OF LOWER STUCCO FASCIA.
11	EXTERIOR FACE OF LOWER STUCCO FASCIA TO ALIGN WITH EXTERIOR FACE OF EXISTING LOWER STUCCO FASCIA.
12	EXTERIOR FACE OF UPPER STUCCO FASCIA TO ALIGN WITH EXTERIOR FACE OF EXISTING UPPER STUCCO FASCIA.
13	ROOF TOP WALKWAY PAD.

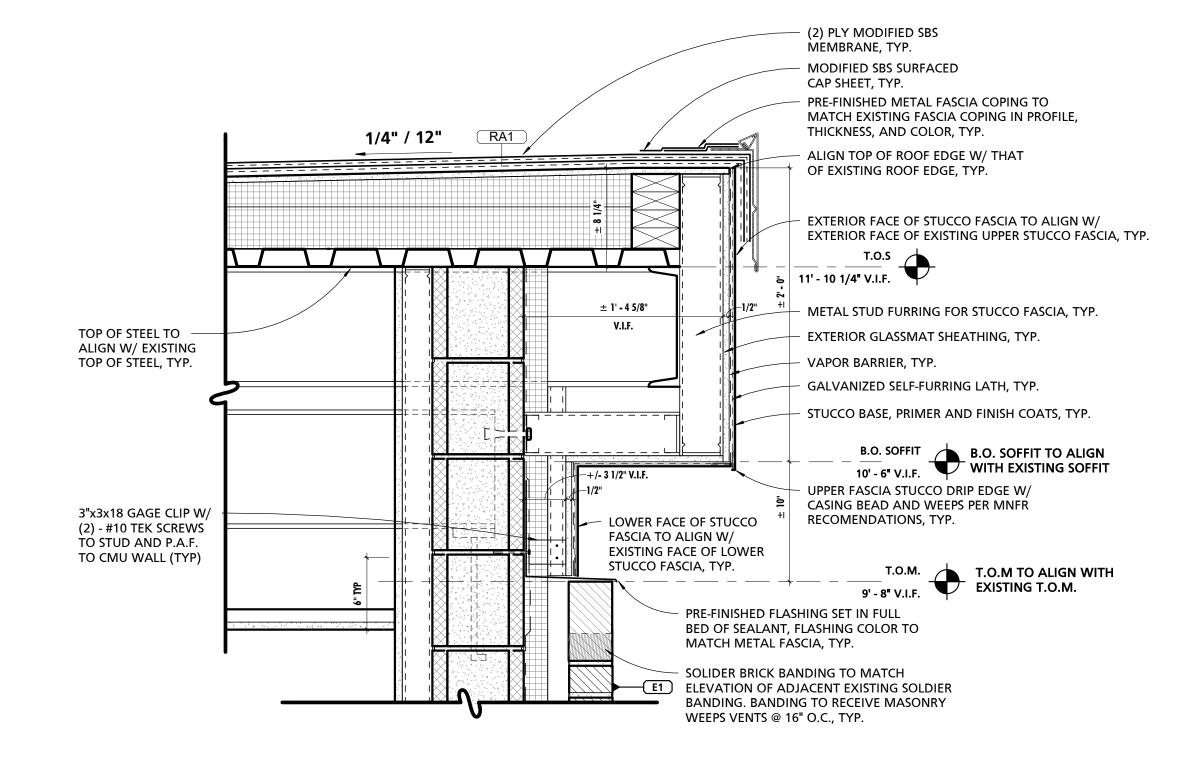

COMMENTS

## TYPICAL UPPER & LOWER ROOF EDGE FASCIA DETAIL

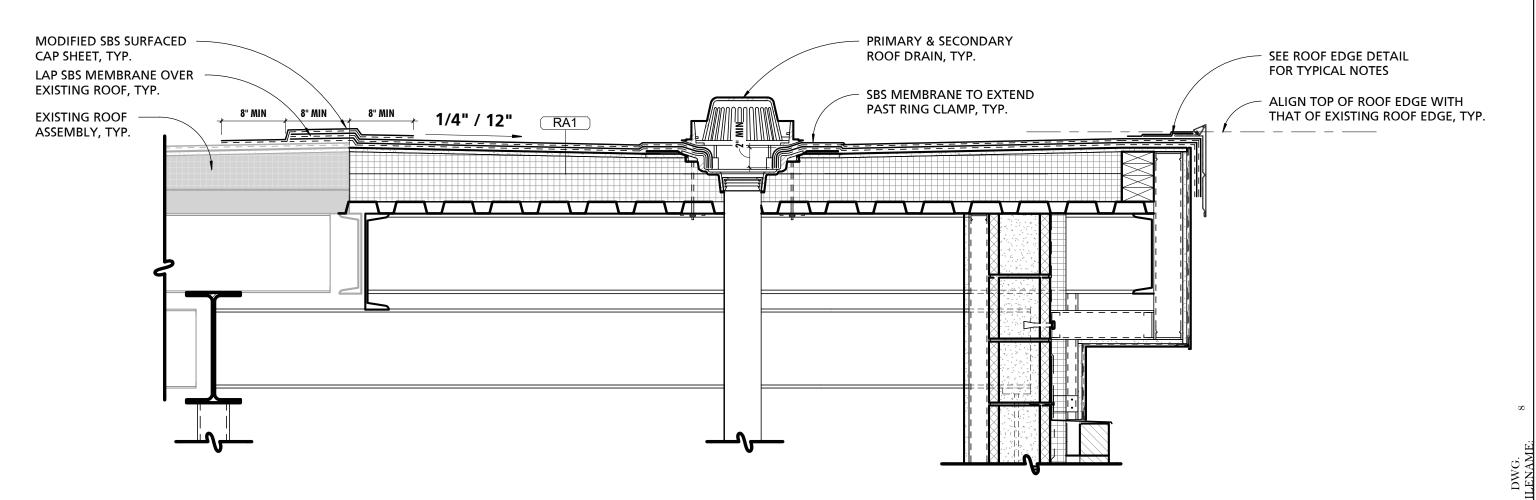

**EXISTING TO NEW ROOF TRANSITION** 

SUBDIVISION: FULLERTON

BALTIMORE COUNTY OFFICE OF BUDGET AND FINANCE, PROPERTY MANAGEMENT

FULLERTON FIRE STATION #8 - RENOVATION & ADDITION

ROOF PLAN

4401 FITCH AVENUE, NOTTINGHAM, MARYLAND, 21236

A A A A A

A500

25034 PF0 RE-BID

JOB ORDER NUMBER

241-220-0054-0012


SHEET 23 of 58

DRAWING NUMBER

2022-2341


FILE NO.: 8

SHEET DESIGNATION | CONTRACT NUMBER

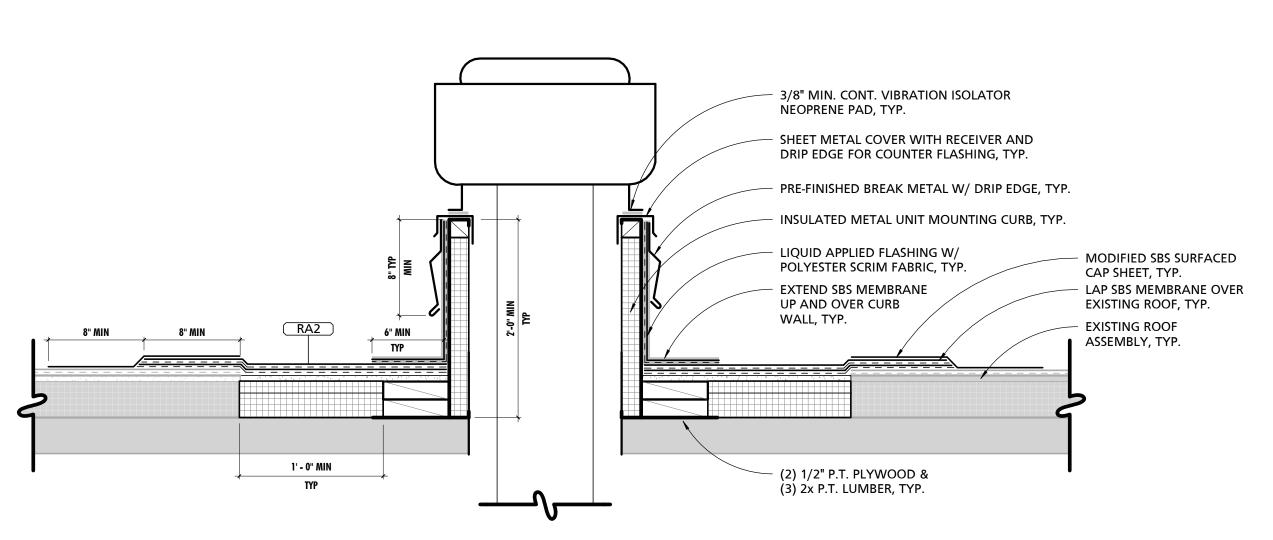

1 1/2" = 1'-0"

TYPICAL EXHAUST FAN PENETRATION DETAIL

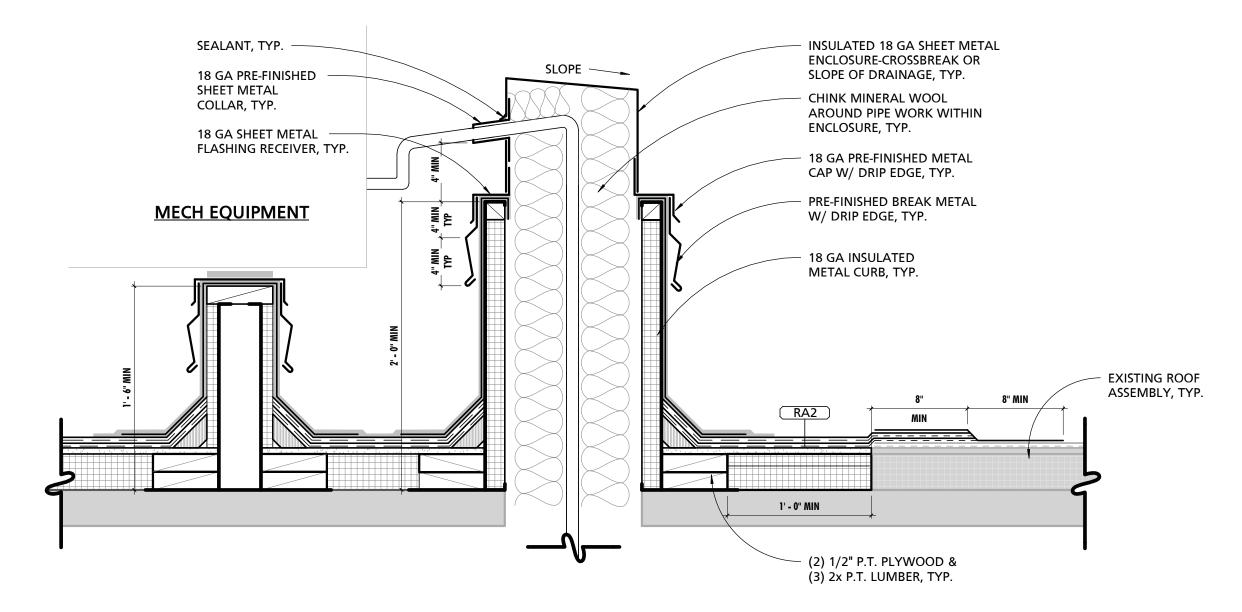

TYPICAL PIPE PORTAL & RAIL SUPPORT DETAIL

1 1/2" = 1'-0"

BY DATE P.W.A. NO. KEY SHEET POSITION SHT DRAWING SCALE AS-BUILT / REVISION PROFESSIONAL CERTIFICATION APPROVED BY: Mihai T Petrisor I HEREBY CERTIFY THAT THESE DOCUMENTS WERE PREPARED OR APPROVED BY ME, AND THAT I AM A DULY LICENSED PROFESSIONAL ARCHITECT UNDER THE LAWS OF THE STATE OF BID/PERMIT PLAN SCALE: R.O.W NO. 03/26/2025 MARYLAND. LICENSE NO. 15505 EXPIRATION DATE: 08-18-2026 BUREAU OF ENGINEERING AND CONSTRUCTION PROPERTY MANAGEMENT HIGHWAYS STRUCTURES STORM DRAINS SEWER WATER FIELD ENGINEER REVIEWED BY: MANNS WOODWARD STUDIOS 10839-D PHILADELPHIA ROAD WHITE MARSH, MARYLAND 21162 DATE REVIEWED:

BALTIMORE COUNTY OFFICE OF BUDGET AND FINANCE, PROPERTY MANAGEMENT

ROOF DETAILS

4401 FITCH AVENUE, NOTTINGHAM, MARYLAND, 21236

A501
* * * * * *
-(10)

JOB ORDER NUMBER 241-220-0054-0012 SHEET 24 of 58 DRAWING NUMBER 2022-2342

FILE NO.: 8

ELECTION DIST. NO.: 14C5

SHEET DESIGNATION | CONTRACT NUMBER 25034 PF0 RE-BID

FULLERTON FIRE STATION #8 - RENOVATION & ADDITION

LIQUID APPLIED FLASHING W/ POLYESTER SCRIM FABRIC, TYP.

RA2

2' - 0" MIN

2 TYPICAL VENT PIPE PENETRATION DETAIL
1 1/2" = 1'-0"

SUBDIVISION: FULLERTON

- LAP SBS MEMBRANE OVER EXISTING

ROOF, TYP.


SHEET, TYP.

MODIFIED SBS

SURFACED CAP

- EXISTING ROOF

ASSEMBLY, TYP.

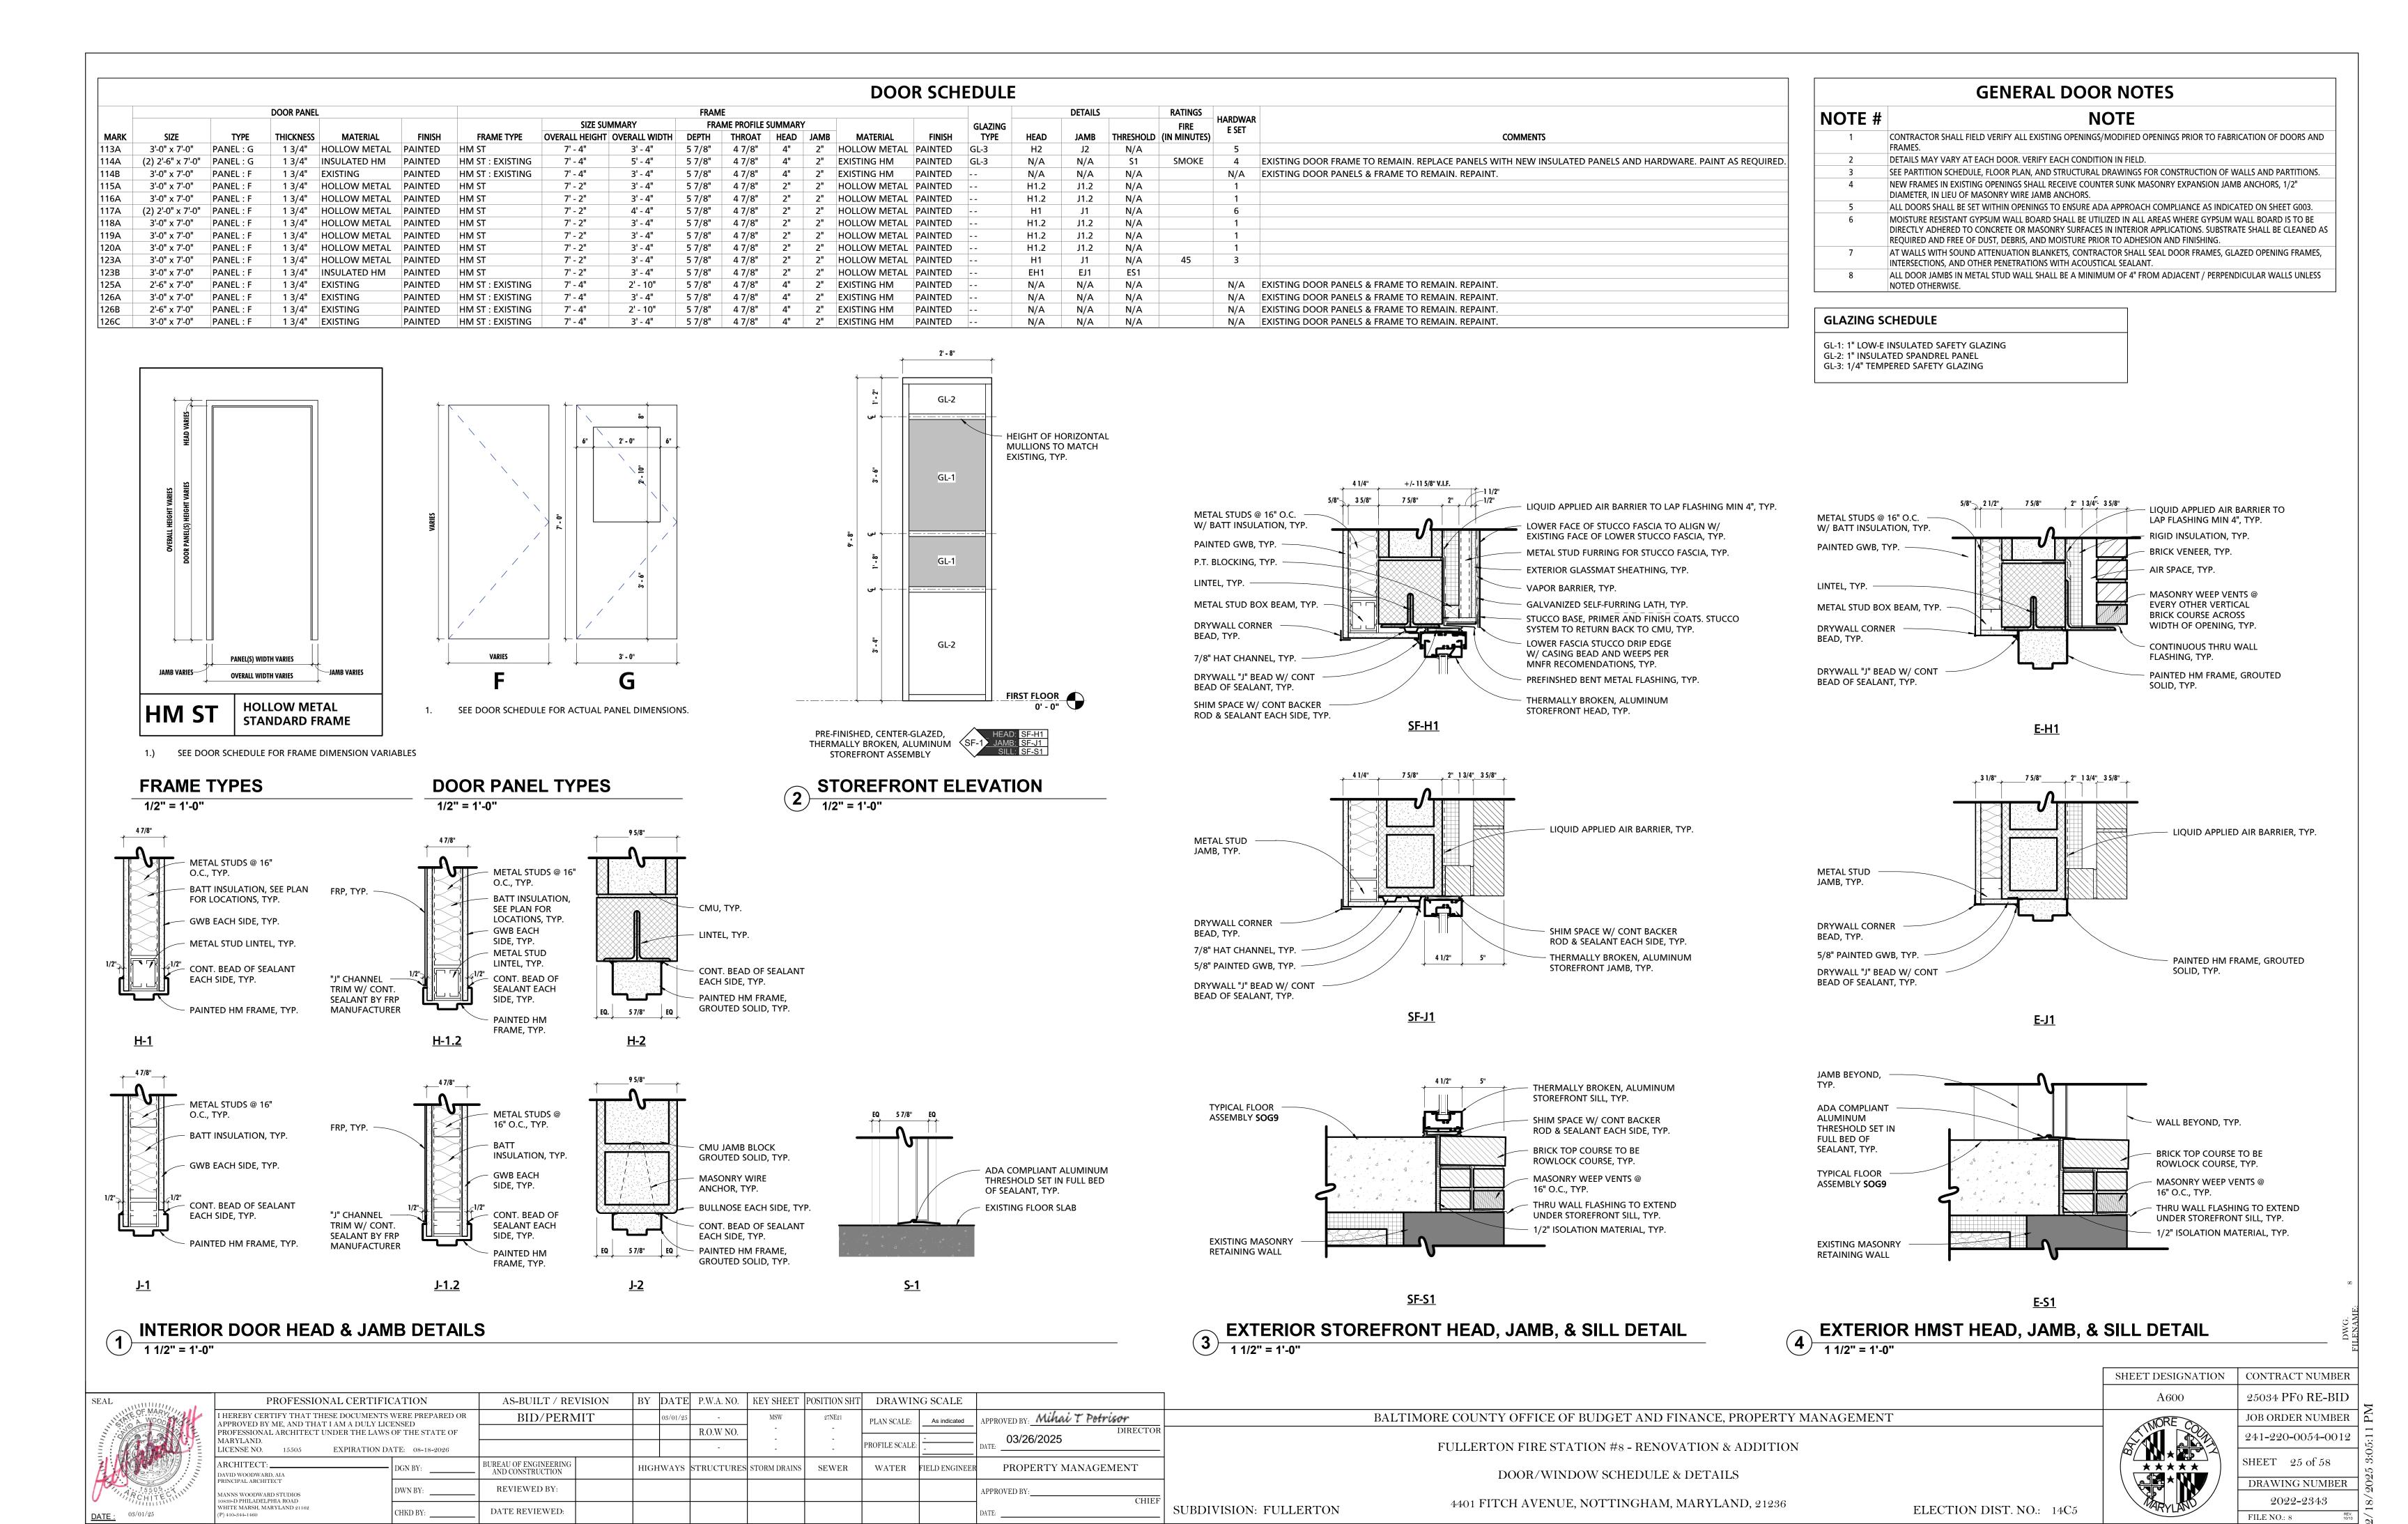

#### AS-BUILT / REVISION BY DATE P.W.A. NO. KEY SHEET POSITION SHT DRAWING SCALE PROFESSIONAL CERTIFICATION I HEREBY CERTIFY THAT THESE DOCUMENTS WERE PREPARED OR BID/PERMIT APPROVED BY: Mihai T Petrisor PLAN SCALE: APPROVED BY ME, AND THAT I AM A DULY LICENSED PROFESSIONAL ARCHITECT UNDER THE LAWS OF THE STATE OF R.O.W NO. MARYLAND. 03/26/2025 PROFILE SCALE: EXPIRATION DATE: 08-18-2026 LICENSE NO. 15505 BUREAU OF ENGINEERING AND CONSTRUCTION PROPERTY MANAGEMENT HIGHWAYS STRUCTURES STORM DRAINS SEWER WATER FIELD ENGINEER DAVID WOODWARD, AIA PRINCIPAL ARCHITECT DWN BY: REVIEWED BY: APPROVED BY: MANNS WOODWARD STUDIOS 10839-D PHILADELPHIA ROAD WHITE MARSH, MARYLAND 21162 DATE REVIEWED:

BALTIMORE COUNTY OFFICE OF BUDGET AND FINANCE, PROPERTY MANAGEMENT

FULLERTON FIRE STATION #8 - RENOVATION & ADDITION

DOOR/WINDOW SCHEDULE & DETAILS

4401 FITCH AVENUE, NOTTINGHAM, MARYLAND, 21236

SUBDIVISION: FULLERTON

A601

25034 PF0 RE-BID FILE NO.: 8

SHEET DESIGNATION | CONTRACT NUMBER

JOB ORDER NUMBER 241-220-0054-0012

SHEET 26 of 58 DRAWING NUMBER

ELECTION DIST. NO.: 14C5

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**DOOR HARDWARE SETS** 

Typical Single Occupant Toilet Room Door, (116A, 118A, 115A, 119A, 120A)

(1) Mortise Lockset, F02 Privacy function, with Occupancy Indicator

Bunk Single Door, W/ Panic Hardware & 45-Min. Fire Rated (123A)

Typical Interior Free Passage Single Door W/ Panic Hardware (113A)

Typical Interior Closet Double Door W/ Panic Hardware (117A)

(1) Mortise Lockset, F07 Passage Function, on active leaf (2) Lever Door Holder (2) Silencers

(1) Mortise Exit Device, F01 Passage Function, exposed vertical rod less bottom rod, on

(1) Kick Plate, 1 1/2" LDW, on push side of door

(1) Mortise Lockset, F30 Storeroom Function

(3) Butt Hinges (1) Mortise Exit Device, F01 Passage Function

Interior Double Door, W/ Panic Hardware (114A)

(3) Butt Hinges (1) Mortise Exit Device, F01 Passage Function

(6) Butt Hinges (1) Manual Flush Bolts on inactive leaf (1) Dust-Proof Strike

(1) Automatic Flush Bolt, inactive leaf

HARDWARE SET 1

(3) Butt Hinges

(1) Door Sweep (1) Coat Hook

HARDWARE SET 2

(3) Butt Hinges

(1) Surface Closer (1) Wall-Mounted Stop (1) Perimeter Gasketing

HARDWARE SET 3

(2) Kick Plate, 1 1/2" LDW (1) Wall-Mounted Stop (1) Perimeter Gasketing

(2) Surface Closer (4) Kick Plate, 1-1/2" LDW (2) Wall-Mounted Stop (1) Perimeter Gasketing (1) Meeting Stile Gasketing

HARDWARE SET 4

(6) Butt Hinges

HARDWARE SET 5

(1) Wall-Mounted Stop (1) Lever Door Holder (2) Kick Plate, 1 1/2" LDW

(3) Silencers

HARDWARE SET 6

active leaf


(1) Coat Hook


(1) Closer

(1) Surface Closer


(1) Wall-Mounted Stop (1) Perimeter Gasketing

Office Single Door (122A)

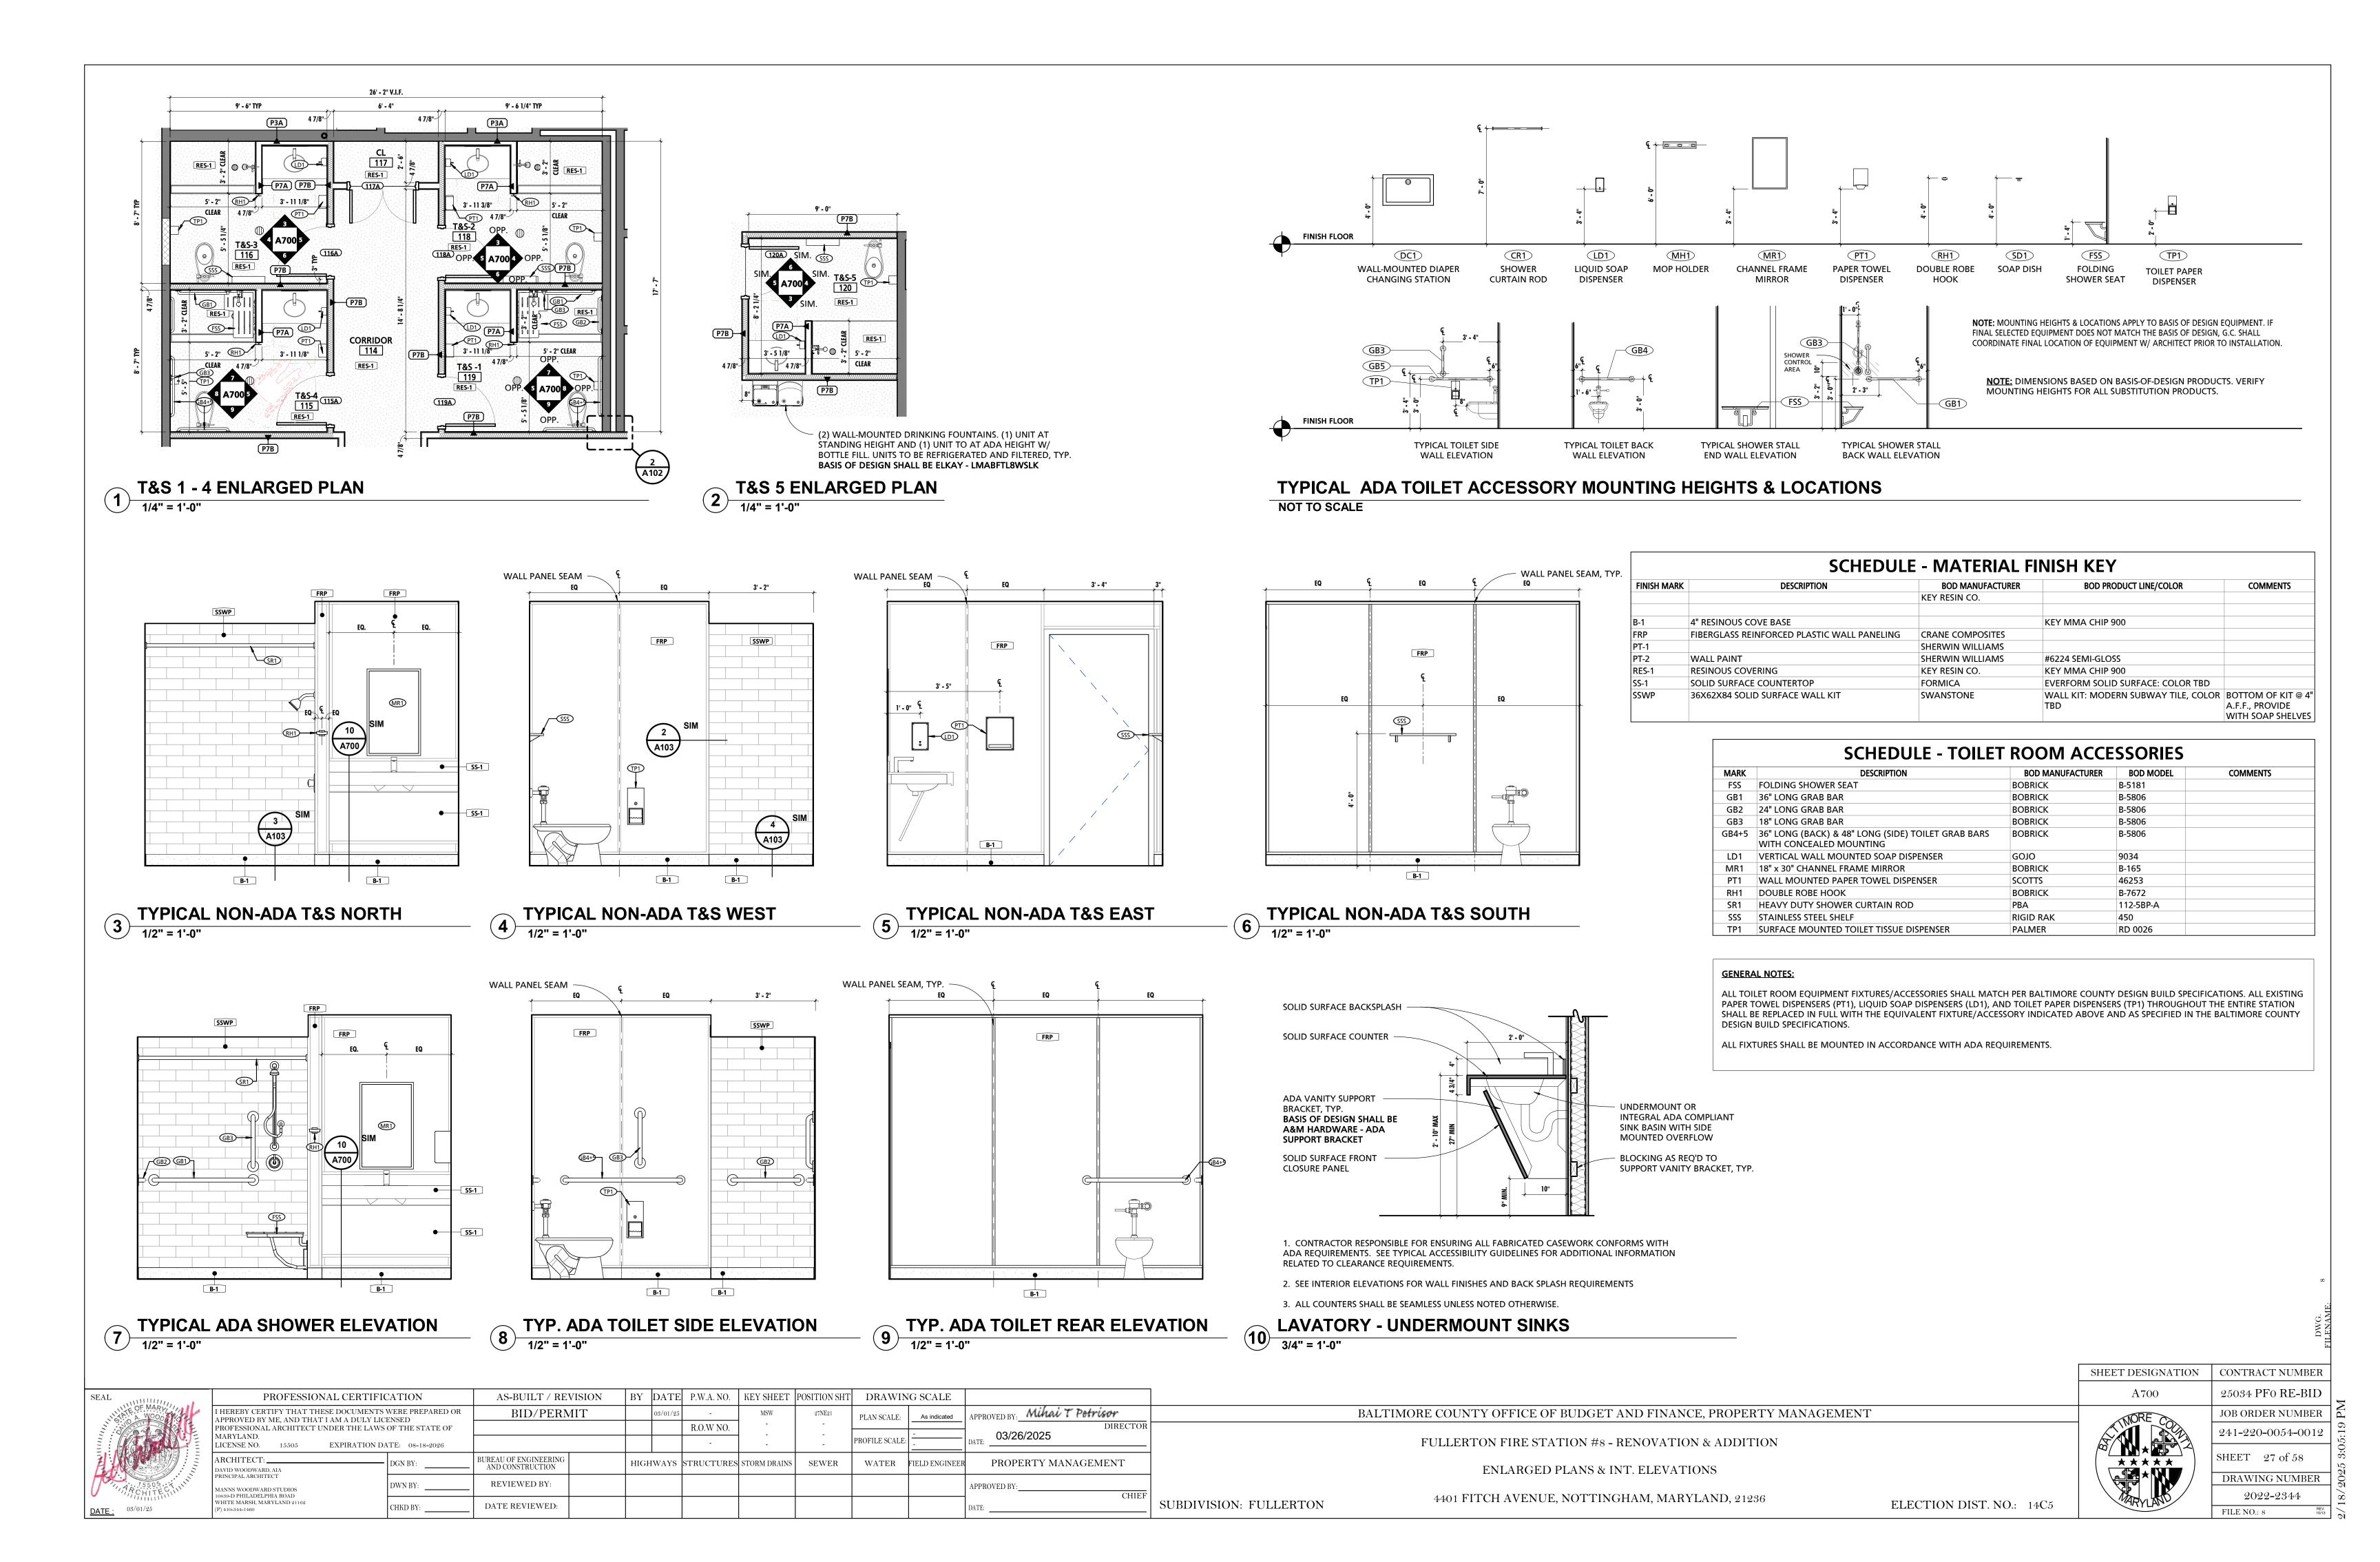

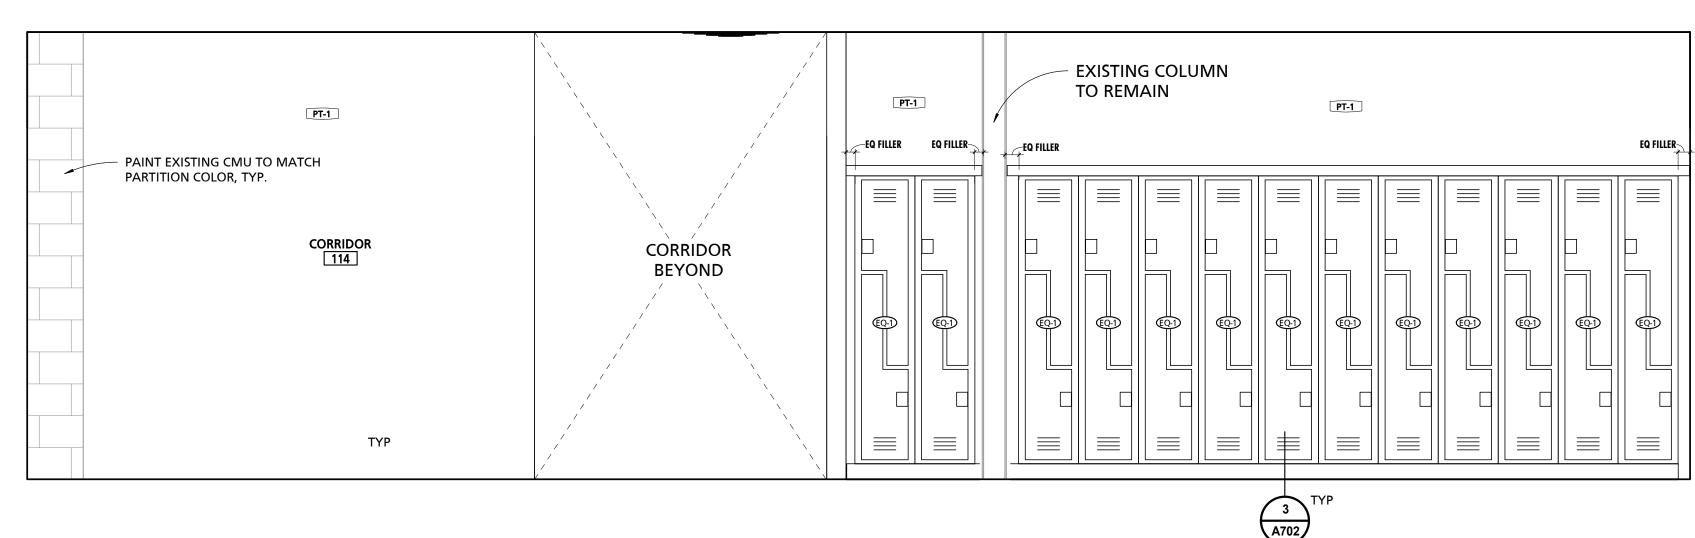

1 CORRIDOR SOUTH

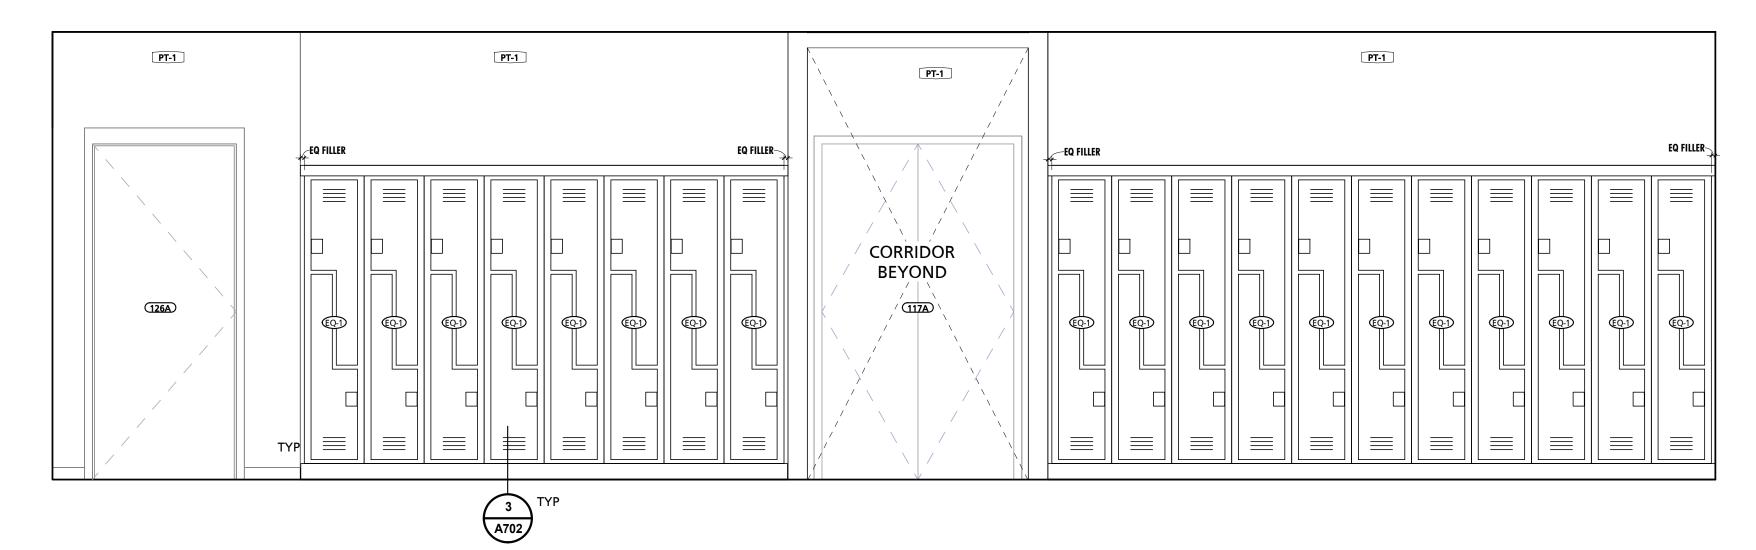

2 CORRIDOR NORTH
1/2" = 1'-0"

BY DATE P.W.A. NO. KEY SHEET POSITION SHT DRAWING SCALE AS-BUILT / REVISION PROFESSIONAL CERTIFICATION APPROVED BY: Mihai T Petrisor I HEREBY CERTIFY THAT THESE DOCUMENTS WERE PREPARED OR BID/PERMIT PLAN SCALE: APPROVED BY ME, AND THAT I AM A DULY LICENSED
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EQ-2 MANUAL ROLLER SHADE HUNTER DOUGLAS **RB-500 ROLLER SHADES** PROVIDE BLACK-OUT BLINDS

**BOD MODEL** 


**SCHEDULE - EQUIPMENT** 

**BOD MANUFACTURER** 

	SCHEDULE - MATERIAL FINISH KEY								
FINISH MARK	DESCRIPTION	BOD MANUFACTURER	BOD PRODUCT LINE/COLOR	COMMENTS					
B-1	4" RESINOUS COVE BASE		KEY MMA CHIP 900						
FRP	FIBERGLASS REINFORCED PLASTIC WALL PANELING	CRANE COMPOSITES							
PT-1		SHERWIN WILLIAMS							
PT-2	WALL PAINT	SHERWIN WILLIAMS	#6224 SEMI-GLOSS						
RES-1	RESINOUS COVERING	KEY RESIN CO.	KEY MMA CHIP 900						
SS-1	SOLID SURFACE COUNTERTOP	FORMICA	EVERFORM SOLID SURFACE: COLOR TBD						
SSWP	36X62X84 SOLID SURFACE WALL KIT	SWANSTONE	WALL KIT: MODERN SUBWAY TILE, COLOR TBD	BOTTOM OF KIT @ 4 <sup>1</sup> A.F.F., PROVIDE WITH SOAP SHELVES					

O.P.O.I. O.P.C.I.


PROVIDED WITH SLOPED TOP

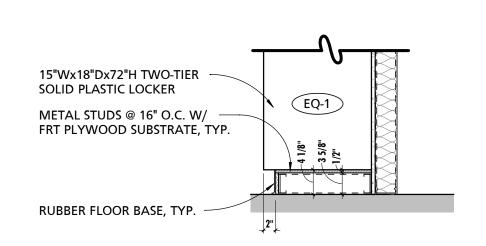


DESCRIPTION

EQ-1 | 15"W x 18"D x 72"H TWO-TIER SOLID PLASTIC LOCKER | BRADLEY CORPORATION | LENOX "Z" LOCKER

TYPICAL LOCKER BASE DETAIL

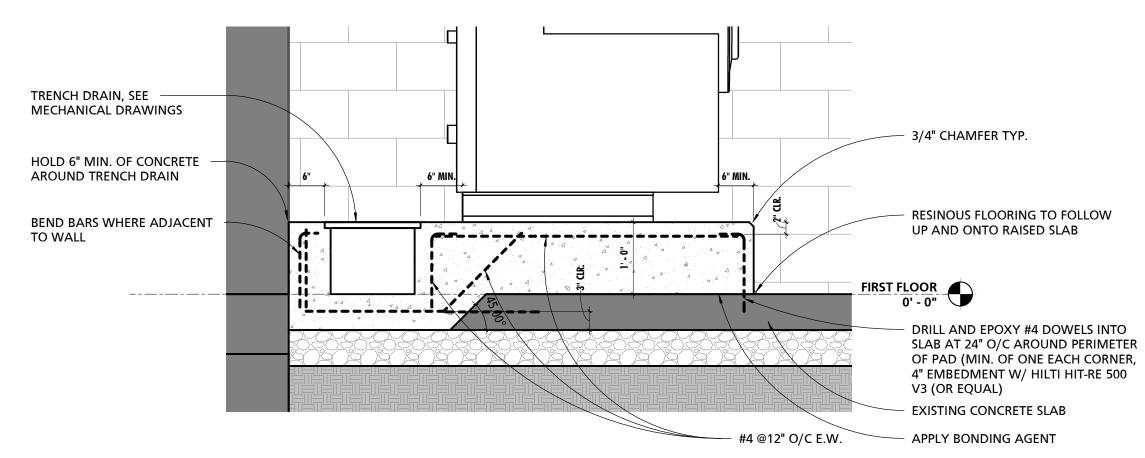

**EXTRACTOR CONCRETE PAD WITH TRENCH DRAIN**3/4" = 1'-0"

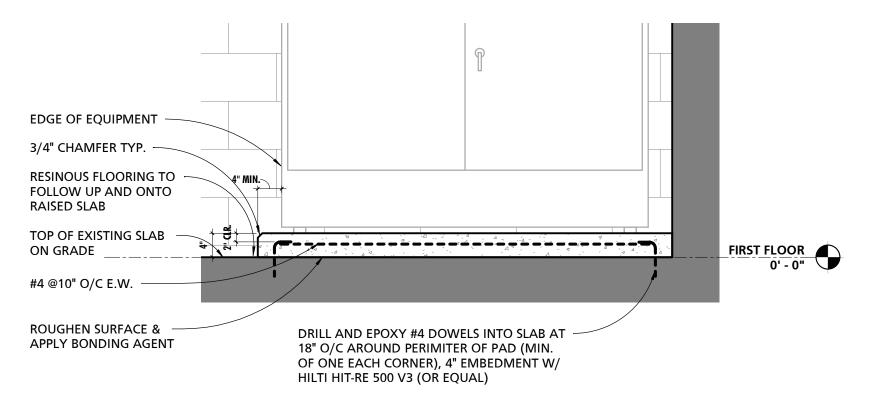


5 DRYING CABINET CONCRETE PAD
3/4" = 1'-0"


SUBDIVISION: FULLERTON

3/4 - 1 -0		SHEET
BALTIMORE COUNTY OFFICE OF BUDGET AND FINANCE, PROPERTY MANAGEMENT		
FULLERTON FIRE STATION #8 - RENOVATION & ADDITION		
INTERIOR ELEVATIONS		*
4401 FITCH AVENUE, NOTTINGHAM, MARYLAND, 21236	ELECTION DIST. NO.: 14C5	N.
		1

SHEET DESIGNATION | CONTRACT NUMBER 25034 PF0 RE-BID JOB ORDER NUMBER  $241 \hbox{-} 220 \hbox{-} 0054 \hbox{-} 0012$ SHEET 28 of 58 DRAWING NUMBER 2022-2345 FILE NO.: 8

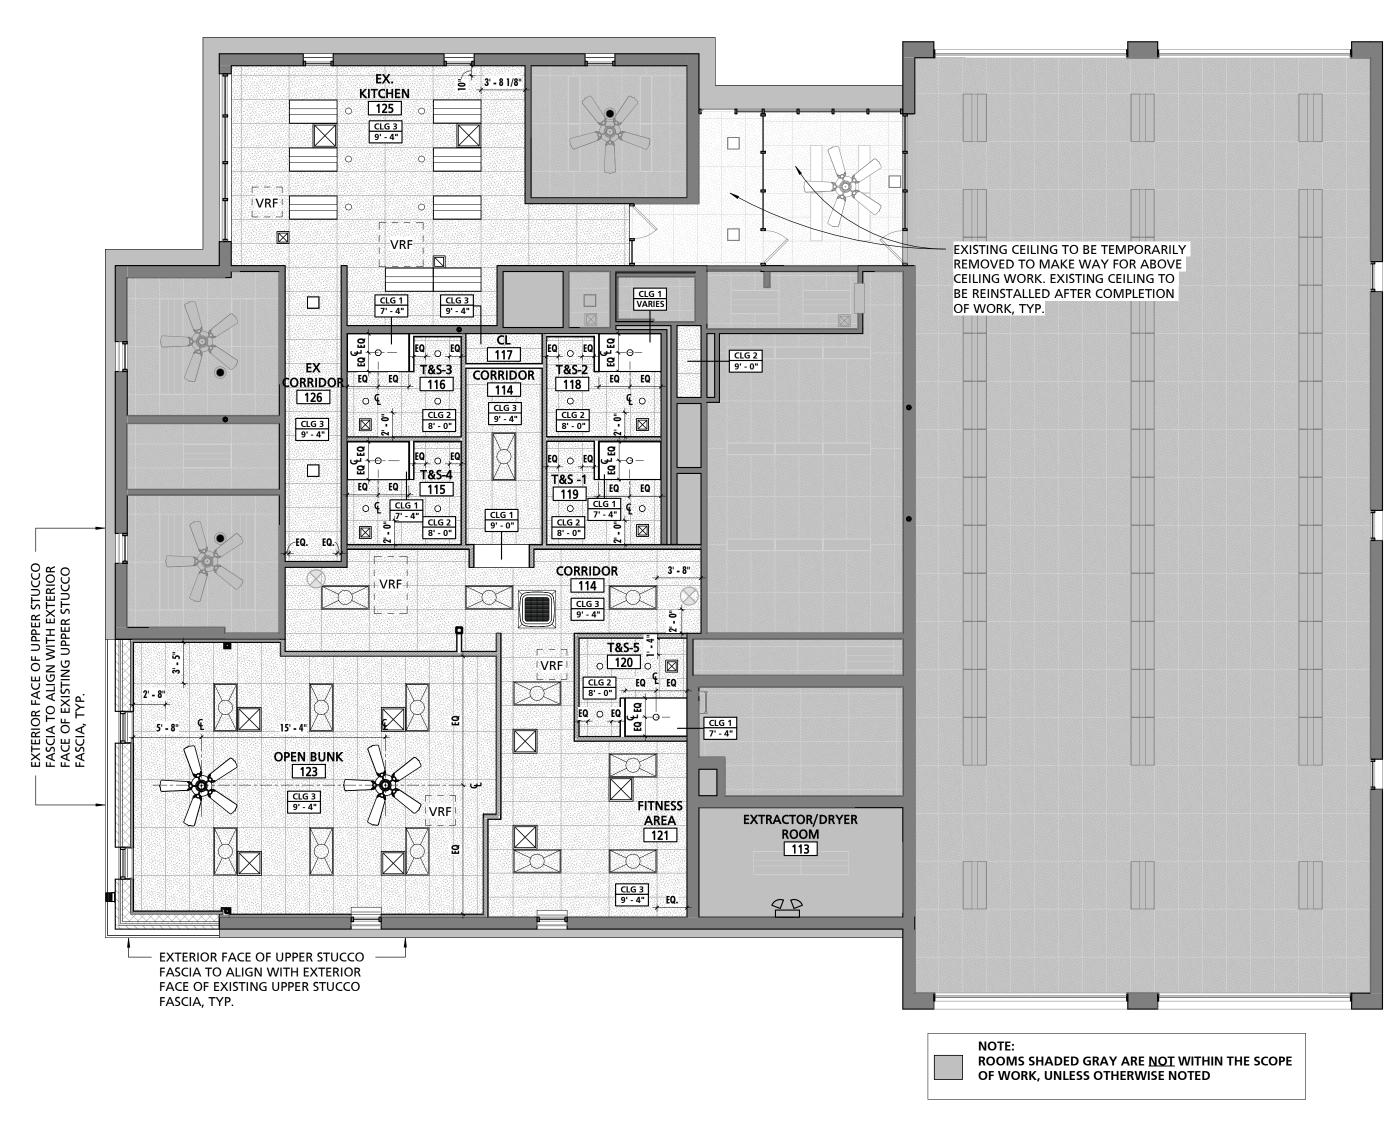

## REFLECTED CEILING PLAN

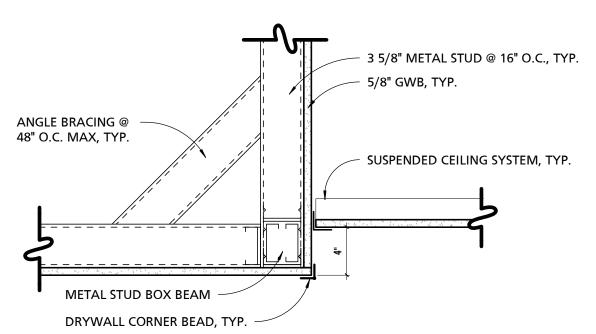

**TYPICAL BULKHEAD DETAIL** 

SEAL	PROFESSIONAL CERTIFI	CATION	AS-BUILT / REVISION	BY	DATE	P.W.A. NO.	KEY SHEET	POSITION SHT	DRAWIN	G SCALE		
OF MARY	I HEREBY CERTIFY THAT THESE DOCUMENTS APPROVED BY ME, AND THAT I AM A DULY LIG		BID/PERMIT		03/01/25	-	MSW	27NE21	PLAN SCALE:	As indicated	APPROVED BY: Mihai T Petrisor	
<b>S S S S S S S S S S</b>	PROFESSIONAL ARCHITECT UNDER THE LAWS					R.O.W NO.	-	-			DIRE	ECTO
	MARYLAND. LICENSE NO. 15505 EXPIRATION D	DATE: 08-18-2026				-	<u> </u>	-	PROFILE SCALE:	-	O3/26/2025	
	EIGENGE IVO. 10000 EIN HEITTON B	711 E. 00 10 2020										
	ARCHITECT:	- DGN BY:	BUREAU OF ENGINEERING AND CONSTRUCTION	ніс	GHWAYS	STRUCTURES	STORM DRAINS	SEWER	WATER	FIELD ENGINEER	PROPERTY MANAGEMENT	
A POLITE CAME	PRINCIPAL ARCHITECT  MANNS WOODWARD STUDIOS	DWN BY:	REVIEWED BY:								APPROVED BY:	
DATE: 03/01/25	10839-D PHILADELPHIA ROAD WHITE MARSH, MARYLAND 21162 (P) 410-344-1460	CHKD BY:	DATE REVIEWED:								DATE:	СНІЕ
<del></del>							l					

**GENERAL CEILING NOTES** 

CONTRACTOR SHALL COORDINATE FINAL FIELD LOCATION OF ALL EXIT SIGNS AND EMERGENCY LIGHTING WITH ARCHITECT PRIOR TO ROUGH-IN, TYP.

BALTIMORE COUNTY OFFICE OF BUDGET AND FINANCE, PROPERTY MANAGEMENT

FULLERTON FIRE STATION #8 - RENOVATION & ADDITION

REFLECTED CEILING PLAN

4401 FITCH AVENUE, NOTTINGHAM, MARYLAND, 21236

ON ACT CEILINGS IN FIRE-RATED AREAS INSTALL HOLD DOWN CLIPS ON ACOUSTIC PANELS WEIGHING LESS THAN 1 LB. PER SQ. FT. PER SPEC. ALL MECHANICAL, ELECTRICAL AND PLUMBING WORK TO OCCUR IN AREAS WHERE THE STRUCTURE IS EXPOSED SHALL BE EXECUTED IN A COORDINATED, NEAT AND WORKMANLIKE MANNER. AT A MINIMUM ALL WIRING SHALL BE RUN THOUGH CONDUITS, PIPE AND DUCT INSULATION SHALL BE NEATLY INSTALLED AND PAINTABLE. ALL PIPES AND DUCTS SHALL BE RUN EITHER PERPENDICULAR OR PARALLEL TO WALL CONSTRUCTION AND SHALL BE INSTALLED AT THE SAME NOMINAL ELEVATION OR SLOPE. ALL MATERIALS AND INSTALLATION METHODS SHALL COMPLY WITH APPLICABLE CODES AND STANDARDS. WHERE MECHANICAL, ELECTRICAL, AND PLUMBING DRAWINGS INDICATE OTHER REQUIREMENTS THE GREATER QUALITY SHALL PREVAIL.

4 CONTRACTOR SHALL COORDINATE THE COLOR AND FINISH OF ALL CEILING MOUNTED EQUIPMENT SUCH AS DIFFUSERS, RETURNS, SPEAKERS, ETC. WITH THE ARCHITECT TO ENSURE THERE ARE NO STARK CONTRASTING COLORS.

WHERE ACT GRID LAYOUT AT EDGE CONDITIONS FOR 2X2 TILES REQUIRE TILES TO BE CUT TO LESS THAN 3", UTILIZE A 2X4 TILE IN LIEU OF THE 2X2 TILE. OMIT CEILING GRID CROSS MEMBERS AS REQUIRED. NO TILE SHALL EXCEED 27" OR BE LESS THAN 3" AT PERIMETER CONDITIONS. IT IS THE CONTRACTORS RESPONSIBILITY TO COORDINATE GRID MAINS AS REQUIRED TO ACHIEVE THIS


	SCHEDULE - CEILING TYPES						
MARK	DESCRIPTION	BOD MANUFACTURER	BOD MODEL	COMMENTS			
CLG 1	5/8" GWB ON 1 1/2" DRYWALL GRID	ARMSTRONG	DRYWALL GRID SYSTEM				
CLG 2	2x2 WASHABLE CEILING TILE	ARMSTRONG	ULTIMA HEALTH ZONE				
CLG 3	2x4 ACOUSTICAL CEILING TILE	ARMSTRONG	FISSURED 895				

SHEET DESIGNATION | CONTRACT NUMBER A800 25034 PF0 RE-BID JOB ORDER NUMBER 241-220-0054-0012

ELECTION DIST. NO.: 14C5

SHEET 29 of 58 DRAWING NUMBER 2022-2346 FILE NO.: 8

SUBDIVISION: FULLERTON

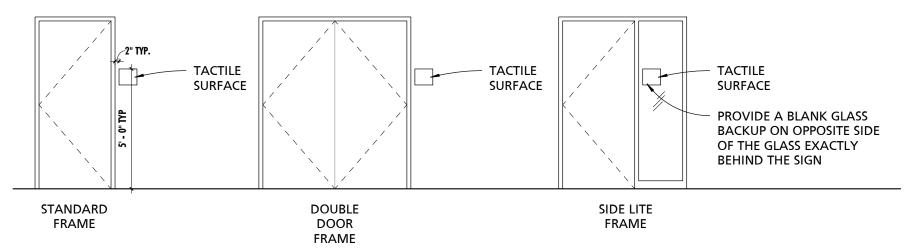


#### **PROVIDE SIGNAGE AT ALL OF THE FOLLOWING LOCATIONS:**

- 1. ADA COMPLIANT IDENTIFICATION ROOM SIGNAGE WITH REMOVABLE INSERT AT ALL ROOMS OTHER THAN MECHANICAL ROOMS AND TOILET ROOMS. SIGNS SHALL INDICATE ROOM NUMBER AND PROVIDE REMOVABLE INSERT FOR ROOM NAMES.
- ADA COMPLIANT IDENTIFICATION ROOM SIGNAGE AT MECHANICAL ROOMS AND TOILET ROOMS. SINGLE OCCUPANT TOILET ROOMS SHALL BE IDENTIFIED AS UNI-SEX.
- ADA COMPLIANT IDENTIFICATION EXIT SIGNAGE AT ALL DOORS LEADING TO RATED EXITS.
- 4. ADA COMPLIANT IDENTIFICATION FLOOR LEVEL SIGNAGE AT ALL FLOOR LANDINGS OF STAIRS AND RAMPS.

## **ADA SIGNAGE MOUNTING LOCATIONS**

(1) 1/4" = 1'-0"

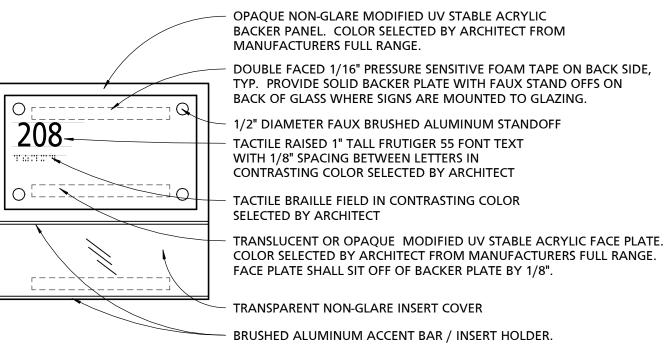

#### TYPICAL ROOM IDENTIFICATION SIGNAGE



1/2" DIAMETER FAUX BRUSHED ALUMINUM STANDOFF DOUBLE FACED 1/16" PRESSURE SENSITIVE FOAM TAPE ON BACK SIDE, TYP. PROVIDE SOLID BACKER PLATE WITH FAUX STAND OFFS ON BACK OF GLASS WHERE SIGNS ARE MOUNTED TO GLAZING.

OPAQUE NON-GLARE MODIFIED UV STABLE ACRYLIC BACKER PANEL. COLOR SELECTED BY ARCHITECT FROM MANUFACTURERS FULL RANGE.


TACTILE RAISED PICTOGRAM AS APPROPRIATE FOR

SIGNAGE LOCATION. TRANSLUCENT OR OPAQUE MODIFIED UV STABLE ACRYLIC FACE PLATE. COLOR SELECTED BY ARCHITECT FROM MANUFACTURERS FULL RANGE.

SELECTED BY ARCHITECT

FACE PLATE SHALL SIT OFF OF BACKER PLATE BY 1/8". TACTILE RAISED 1" TALL FRUTIGER 55 FONT TEXT WITH 1/8" SPACING BETWEEN LETTERS IN CONTRASTING COLOR SELECTED BY ARCHITECT TACTILE BRAILLE FIELD IN CONTRASTING COLOR

TYPICAL RESTROOM SIGN

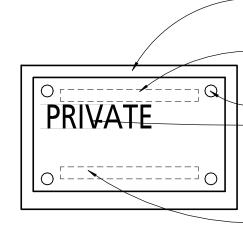


OPAQUE NON-GLARE MODIFIED UV STABLE ACRYLIC BACKER PANEL. COLOR SELECTED BY ARCHITECT FROM MANUFACTURERS FULL RANGE.

DOUBLE FACED 1/16" PRESSURE SENSITIVE FOAM TAPE ON BACK SIDE, TYP. PROVIDE SOLID BACKER PLATE WITH FAUX STAND OFFS ON BACK OF GLASS WHERE SIGNS ARE MOUNTED TO GLAZING.

1/2" DIAMETER FAUX BRUSHED ALUMINUM STANDOFF TACTILE RAISED 1" TALL FRUTIGER 55 FONT TEXT WITH 1/8" SPACING BETWEEN LETTERS IN CONTRASTING COLOR SELECTED BY ARCHITECT

TRANSLUCENT OR OPAQUE MODIFIED UV STABLE ACRYLIC FACE PLATE. COLOR SELECTED BY ARCHITECT FROM MANUFACTURERS FULL RANGE. FACE PLATE SHALL SIT OFF OF BACKER PLATE BY 1/8".

#### TYPICAL INFORMATIONAL SIGNAGE

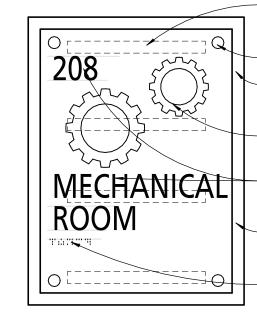

DOUBLE FACED 1/16" PRESSURE SENSITIVE FOAM TAPE ON BACK SIDE, TYP. PROVIDE SOLID BACKER PLATE WITH FAUX STAND OFFS ON BACK OF GLASS WHERE SIGNS ARE MOUNTED TO GLAZING. 1/2" DIAMETER FAUX BRUSHED ALUMINUM STANDOFF

OPAQUE NON-GLARE MODIFIED UV STABLE ACRYLIC BACKER PANEL. COLOR SELECTED BY ARCHITECT FROM MANUFACTURERS FULL RANGE.

TACTILE RAISED PICTOGRAM AS APPROPRIATE FOR SIGNAGE LOCATION.

MECHANICAL TACTILE RAISED 1" TALL FRUTIGER 55 FONT TEXT WITH 1/8" SPACING BETWEEN LETTERS IN CONTRASTING COLOR SELECTED BY ARCHITECT

TRANSLUCENT OR OPAQUE MODIFIED UV STABLE ACRYLIC FACE PLATE. COLOR SELECTED BY ARCHITECT FROM MANUFACTURERS FULL RANGE. FACE PLATE SHALL SIT OFF OF BACKER PLATE BY 1/8".

SUBDIVISION: FULLERTON

TACTILE BRAILLE FIELD IN CONTRASTING COLOR SELECTED BY ARCHITECT

TYPICAL UTILITY ROOM / STAIRWAY SIGN

# 2 TYPICAL SIGNAGE DETAILS 3" = 1'-0"

	PROFESSIONAL CERTIFICATION		AS-BUILT / REVISION		BY	DATE	P.W.A. NO.	KEY SHEET	POSITION SHT	DRAWIN	G SCALE	
111	I HEREBY CERTIFY THAT THESE DOCUMENTS APPROVED BY ME, AND THAT I AM A DULY LIC	BID/PERM	ΙΤ		03/01/25	-	MSW	27NE21	PLAN SCALE:	As indicated	APPROVED BY: Mihai T Petrisor	
W	PROFESSIONAL ARCHITECT UNDER THE LAWS					R.O.W NO.	-	-			DIRECTOR 03/26/2025	
	MARYLAND. LICENSE NO. 15505 EXPIRATION DATE: 08-18-2026						-	-	-	PROFILE SCALE:	-	DATE: 03/20/2023
	ARCHITECT:	DGN BY:	BUREAU OF ENGINEERING AND CONSTRUCTION		HIGH	HWAYS	STRUCTURES	STORM DRAINS	SEWER	WATER	FIELD ENGINEER	PROPERTY MANAGEMENT
lil.	PRINCIPAL ARCHITECT  MANNS WOODWARD STUDIOS  0839-D PHILADELPHIA ROAD	DWN BY:	REVIEWED BY:									APPROVED BY:CHIE.
	WHITE MARSH, MARYLAND 21162 (P) 410-344-1460	CHKD BY:	DATE REVIEWED:									DATE:

BALTIMORE COUNTY OFFICE OF BUDGET AND FINANCE, PROPERTY MANAGEMENT

FULLERTON FIRE STATION #8 - RENOVATION & ADDITION

TYPICAL ADA SIGNAGE DETAILS

4401 FITCH AVENUE, NOTTINGHAM, MARYLAND, 21236

A900


SHEET DESIGNATION | CONTRACT NUMBER 25034 PF0 RE-BID SHEET 30 of 58


ELECTION DIST. NO.: 14C5

JOB ORDER NUMBER 241-220-0054-0012 DRAWING NUMBER

FILE NO.: 8

2022-2347

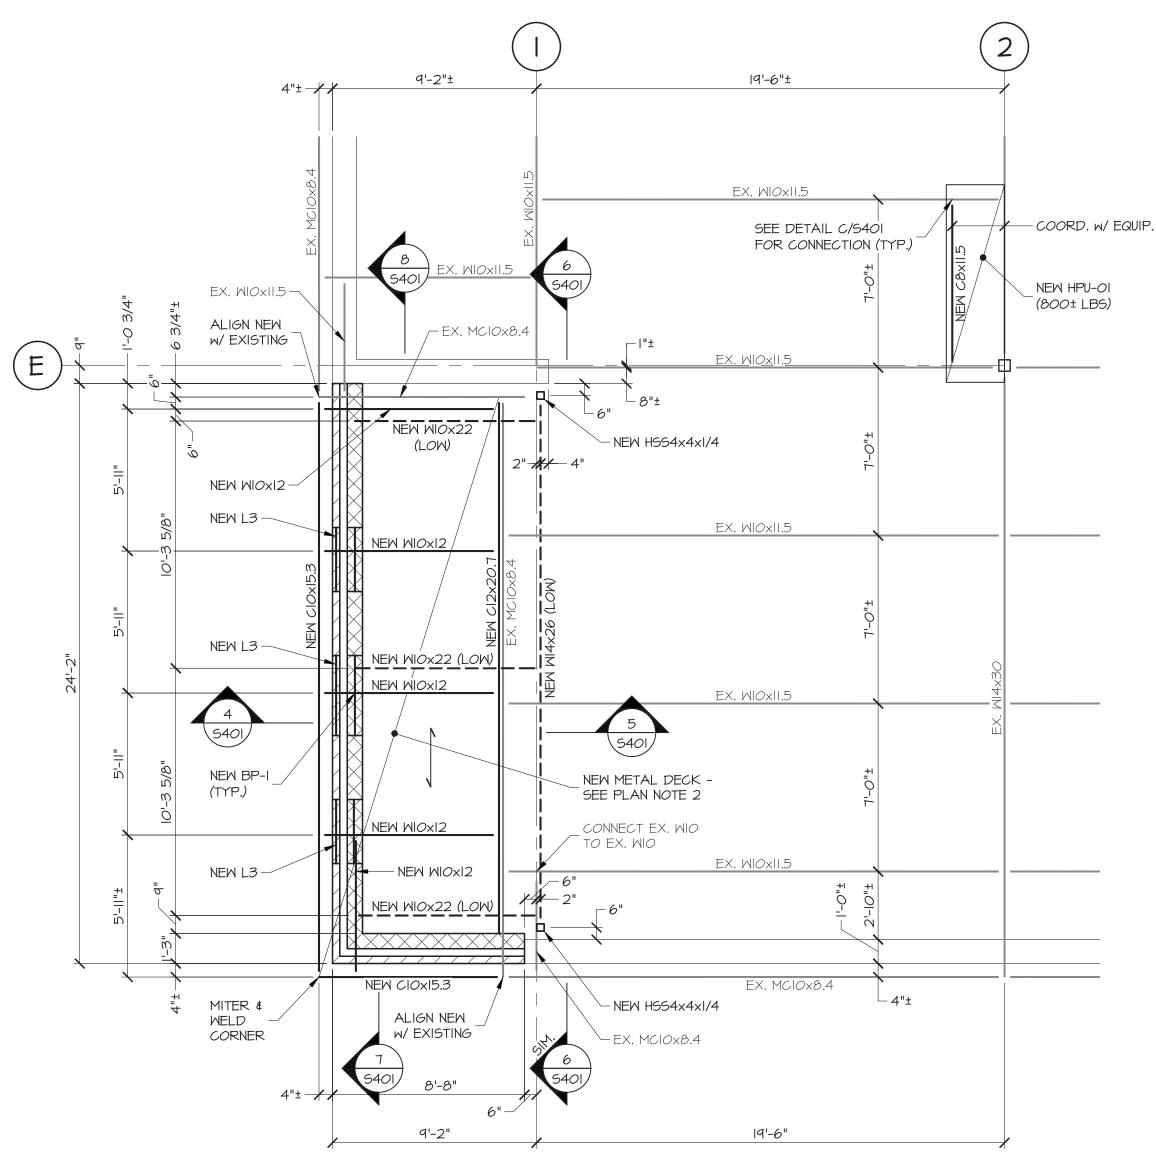

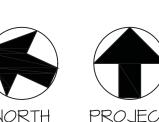


NORTH



1/4"=1'-0"

- . ALL CONSTRUCTION IS EXISTING UNLESS OTHERWISE NOTED. 2. NEW ROOF DECK TO BE I I/2", 20ga. GALVANIZED TYPE B METAL DECK AS MANUFACTURED
- BY VULCRAFT OR APPROVED EQUIVALENT.

  3. TOP OF NEW STEEL TO MATCH TOP OF EXISTING STEEL AT +12'-0"±.

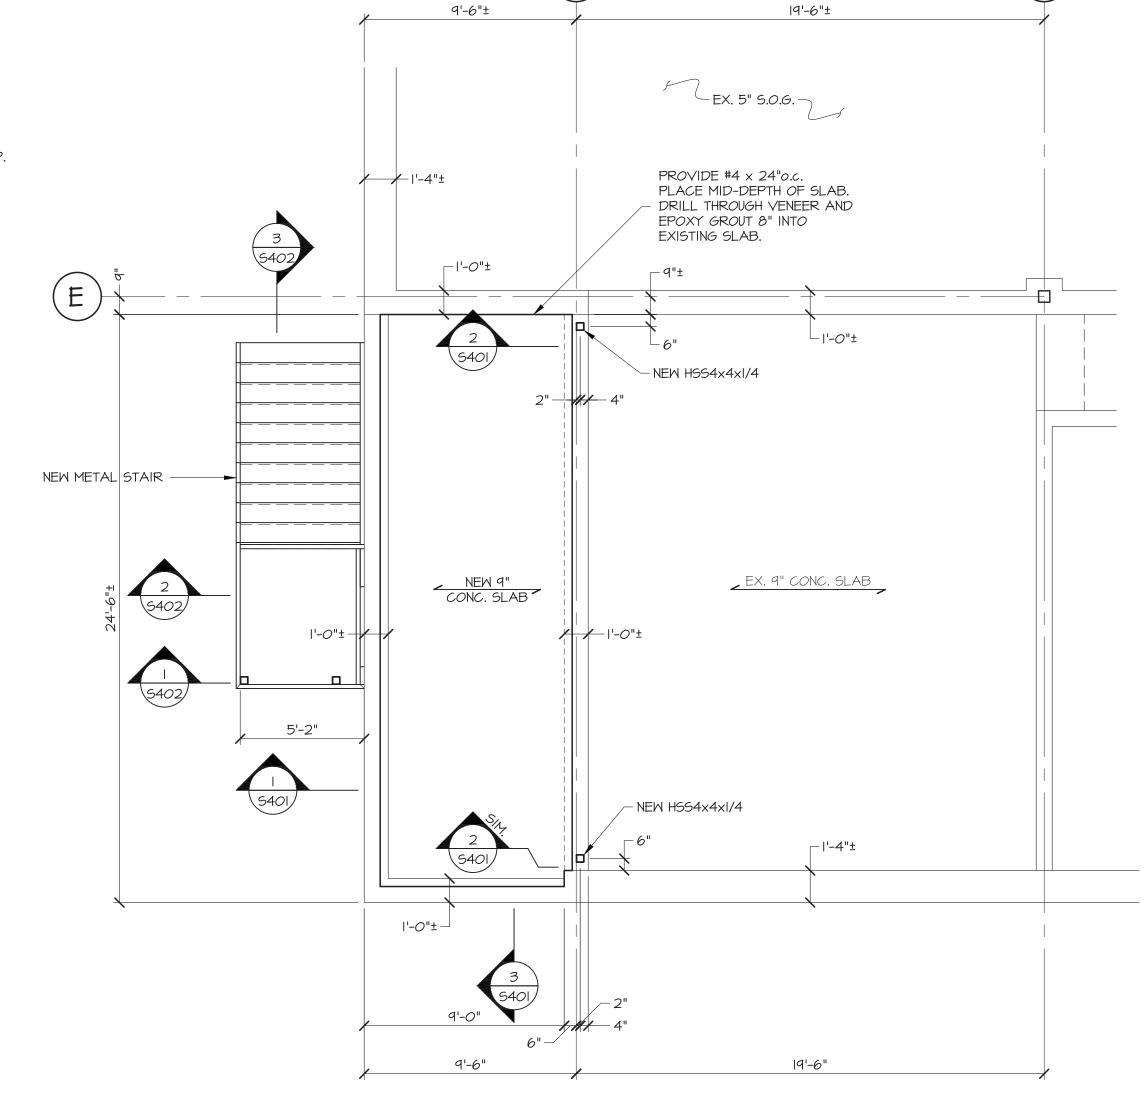






SUBDIVISION: FULLERTON

# PARTIAL FIRST FLOOR FRAMING PLAN 1/4"=1'-0"

ALL CONSTRUCTION IS EXISTING UNLESS OTHERWISE NOTED. NEW SLAB TO BE 9" MINIMUM THICK. SEE SECTIONS 1 \$2/5401 FOR SLAB REINFORCEMENT.

TOP OF NEW SLAB ELEVATION TO MATCH TOP OF EXISTING FLOOR SLAB ELEVATION AT REFERENCE ELEVATION O'-O".

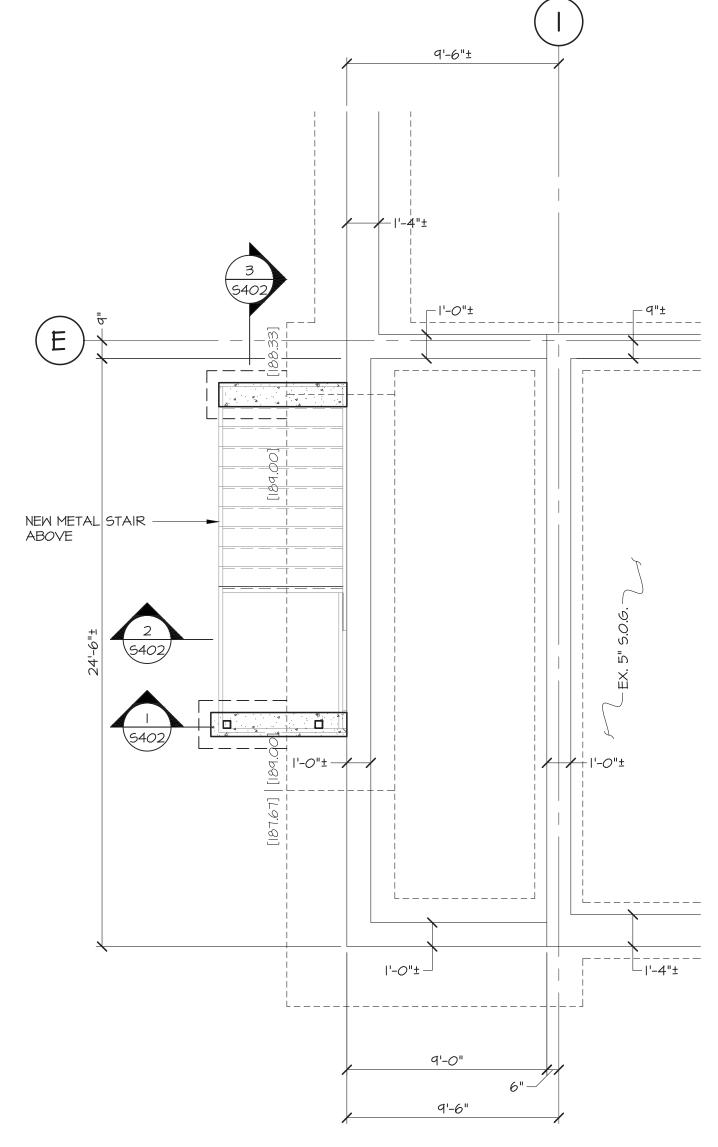





ELECTION DIST. NO.: 8C5

PARTIAL FOUNDATION PLAN 1/4"=1'-0"

I. ALL CONSTRUCTION IS EXISTING UNLESS OTHERWISE NOTED.

S	EAL	PROFESSIONAL CERTIFIC	CATION	AS-BUILT / RE	VISION	BY	DATE	P.W.A. NO.	KEY SHEET	POSITION SHT	DRAWIN	IG SCALE	
		I HEREBY CERTIFY THAT THESE DOCUMENTS W APPROVED BY ME, AND THAT I AM A DULY LICEN		BID/PERN	/IIT		03/01/25		-	-	PLAN SCALE:	AS INDICATED	APPROVED BY: Mihai T Petrisor
		ENGINEER UNDER THE LAWS OF THE STATE OF				_	Ш	R.O.W NO.	-	-	DDOELLE COALE	<u> </u>	DIRECTOR 03/26/2025
	1) (Mary 1913)	LICENSE NO. 17403 EXPIRATION DA	TE: 06-28-2025					-	-	-	PROFILE SCALE:	-	DATE:
	3 TOTAL TOTAL	F NGINEER	DGN BY:	BUREAU OF ENGINEERING AND CONSTRUCTION		HIGH	IWAYS	STRUCTURES	STORM DRAINS	SEWER	WATER	FIELD ENGINEER	PROPERTY MANAGEMENT
		PFINCIPAL ENGINEER  M NCIN PATEL MILANO, INC.	DWN BY:	REVIEWED BY:									APPROVED BY: CHIE
		6511 HARFORD ROAD BALTIMORE, MARYLAND 21214 (P) 410-254-7500	CHKD BY:	DATE REVIEWED:									DATE:

BALTIMORE COUNTY OFFICE OF BUDGET AND FINANCE, PROPERTY MANAGEMENT

FULLERTON FIRE STATION #8 - RENOVATION & ADDITION

STRUCTURAL PLANS

4401 FITCH AVENUE, NOTTINGHAM, MARYLAND 21236

STRUCTURAL

SHEET DESIGNATION

25034 PF0 RE-BID JOB ORDER NUMBER 241-220-0054-0012 SHEET 31 of 58

CONTRACT NUMBER

DRAWING NUMBER S101 FILE NO.: 20-120 MPM #21137

### STRUCTURAL GENERAL NOTES

#### **EXISTING CONDITIONS**

INFORMATION INDICATED ON THESE DRAWINGS PERTAINING TO EXISTING CONDITIONS HAS BEEN OBTAINED FROM EXISTING BUILDING DRAWINGS AND IS BELIEVED TO BE REASONABLY ACCURATE. HOWEVER, PRIOR TO PERFORMING ANY WORK OR FABRICATION, BASED UPON THIS INFORMATION, THE CONTRACTOR SHALL FIELD VERIFY THE ACTUAL EXISTING DIMENSIONS/CONDITIONS. SHOULD CONDITIONS BE DISCOVERED THAT PREVENT EXECUTION OF THE WORK AS INDICATED, THE CONTRACTOR SHALL NOTIFY THE ENGINEER PRIOR TO PROCEEDING WITH CONSTRUCTION. THE CONTRACTOR SHALL REMOVE ALL EXISTING CONSTRUCTION AS REQUIRED TO INSTALL NEW CONSTRUCTION. THE CONTRACTOR SHALL BE RESPONSIBLE FOR PROTECTING ALL EXISTING WORK AND SHALL REPAIR AND/OR REPLACE TO IT'S PRESENT CONDITION ANY DAMAGE OR INJURY CAUSED DURING DEMOLITION OR NEW CONSTRUCTION. ALL TEMPORARY SHORING, NEEDLING, ETC. SHALL BE AS REQUIRED TO SUPPORT THE EXISTING STRUCTURE DURING DEMOLITION AND NEW WORK. THE CONTRACTOR SHALL EXAMINE THE EXISTING STRUCTURE TO DETERMINE THE EXTENT OF NECESSARY SHORING AND NEEDLING. THE CAPACITY AND METHOD USED FOR SHORING AND NEEDLING SHALL BE THE RESPONSIBILITY OF THE CONTRACTOR. INSTALLATION OF TEMPORARY SHORING, NEEDLING, ETC. SHALL BE COORDINATED WITH THE CONTRACTOR'S SEQUENCE FOR THE INSTALLATION OF THE NEW WORK AND THE DEMOLITION OF EXISTING CONSTRUCTION.

#### <u>DIMENSIONS</u>

THE CONTRACTOR SHALL FIELD CHECK AND VERIFY ALL PERTINENT DIMENSIONS AND CONDITIONS INDICATED ON THESE DRAWINGS AND SHALL NOTIFY THE ENGINEER OF ANY DISCREPANCIES OR POTENTIAL CONFLICTS PRIOR TO PROCEEDING WITH CONSTRUCTION. DIMENSIONS IDENTIFIED WITH A ± REPRESENT DIMENSIONS, EITHER EXISTING OR NEW, THAT REQUIRE VERIFICATION IN THE FIELD BY THE CONTRACTOR PRIOR TO FABRICATION OR INSTALLATION OF ANY COMPONENTS.

THE NEW ADDITION HAS BEEN DESIGNED TO BE SELF-SUPPORTING AND STABLE AFTER FULLY COMPLETED. CONSTRUCTION MEANS AND METHODS ARE SOLELY THE CONTRACTOR'S RESPONSIBILITY. THE CONTRACTOR MUST DETERMINE ERECTION PROCEDURE AND SEQUENCE, WHICH WILL ENSURE THE STABILITY OF ALL COMPONENTS DURING ERECTION, INCLUDING THE ADDITION OF ANY GUYS, BRACING, ETC. THAT MAY BE NECESSARY. SUCH MATERIAL AND METHODS ARE NOT SHOWN IN THE CONTRACT DRAWINGS OR SPECIFICATIONS AND IS SOLELY THE RESPONSIBILITY OF THE CONTRACTOR. THE ENGINEER HAS NO EXPERTISE IN, AND TAKES NO RESPONSIBILITY FOR, THE CONSTRUCTION MEANS AND METHODS OR JOB SITE SAFETY DURING CONSTRUCTION. PROCESSING OR APPROVING SUBMITTALS MADE BY THE CONTRACTOR WHICH MAY CONTAIN INFORMATION RELATED TO CONSTRUCTION METHODS OR SAFETY ISSUES, OR PARTICIPATION IN MEETINGS WHERE SUCH ISSUES MIGHT BE DISCUSSED, SHALL NOT BE CONSTRUED AS VOLUNTARY ASSUMPTION BY THE ENGINEER OF ANY RESPONSIBILITY FOR CONSTRUCTION METHODS AND/OR SAFETY PROCEDURES, IT IS SOLELY THE RESPONSIBILITY OF EACH CONTRACTOR TO FOLLOW ALL APPLICABLE SAFETY PROCEDURES AND APPLICABLE SAFETY CODES AND REGULATIONS DURING ALL PHASES OF CONSTRUCTION. THE STRUCTURAL ENGINEER DOES NOT ENGAGE IN, AND DOES NOT SUPERVISE CONSTRUCTION.

#### SPECIAL CONDITIONS

THE CONTRACTOR SHALL BE RESPONSIBLE TO INSURE THAT PROPER STORAGE OF MATERIAL IS MAINTAINED SO AS NOT TO CAUSE OVERLOADING OF THE EXISTING STRUCTURE DURING PERFORMANCE OF THIS WORK. ALL WORK IS TO BE COORDINATED WITH THE OWNER'S REPRESENTATIVE TO MINIMIZE ANY DISTURBANCES TO THE USE OF THE BUILDING, CONTRACTOR SHOULD TAKE ALL NECESSARY PRECAUTION TO AVOID FIRE DAMAGE TO ANY MEMBER OR OBJECT. CONTRACTOR SHALL SEPARATE THE WORK AREA FROM SURROUNDING AREA BY ERECTING FIRE SEPARATION BARRIERS AS NECESSARY.

#### CAST IN PLACE CONCRETE AND REINFORCING

ALL CONCRETE SHALL CONFORM TO ACI 301, ACI 318, ACI 315. ALL CONCRETE SHALL BE NORMAL WEIGHT CONCRETE WITH THE FOLLOWING 28 DAY COMPRESSIVE STRENGTH (f'c): 4,000psi

CEMENTITIOUS MATERIAL SHALL BE A MINIMUM OF 75% PORTLAND CEMENT TYPE I

REINFORCING - ASTM A 615, GRADE 60.

WELDED WIRE FABRIC - ASTM A 185, LAP ENDS 6" MINIMUM.

SPLICE LAPS FOR ALL REINFORCING SHALL BE CLASS "B" SPLICE, UNLESS OTHERWISE NOTED. ALL CONCRETE SHALL CONTAIN A WATER-REDUCING ADMIXTURE PER MANUFACTURER'S RECOMMENDATIONS.

PROVIDE ACCESSORIES AND BAR SUPPORTS FOR ALL REINFORCING IN ACCORDANCE WITH ACI 315 (LATEST EDITION).

MAXIMUM SLUMP TO BE 4". SUBMIT CONCRETE MIX DESIGN FOR EACH TYPE OF CONCRETE TO BE USED AT LEAST 15 DAYS PRIOR TO INTENDED USE.

MASONRY WORK SHALL COMPLY WITH ACI530.I/ASCE 6 "SPECIFICATIONS FOR MASONRY STRUCTURES." CONCRETE MASONRY UNITS SHALL CONFORM TO ASTM C 90.

CONCRETE MASONRY UNITS SHALL HAVE A MINIMUM COMPRESSIVE STRENGTH OF 1,900psi AND A MINIMUM PRISM STRENGTH

MORTAR SHALL CONFORM TO ASTM C 270, TYPE S FOR ALL CMU WALLS AND TYPE N FOR ALL VENEERS. GROUT FOR ALL MASONRY WALLS TO EITHER BE 3,000psi PEA GRAVEL CONCRETE OR COMPLY WITH ASTM C476 - GROUT.

BY DATE P.W.A. NO. KEY SHEET POSITION SH

HIGHWAYS STRUCTURES STORM DRAINS SEWER

R.O.W NO.

DRAWING SCALE

PLAN SCALE:

WATER

APPROVED BY: Mihai T Petrisor

PROPERTY MANAGEMENT

03/26/2025

PPROVED BY:

AS-BUILT / REVISION

BID/PERMIT

BUREAU OF ENGINEERING AND CONSTRUCTION

REVIEWED BY:

DATE REVIEWED:

ALL OPENINGS IN MASONRY WALLS AND PARTITIONS ARE TO BE PROVIDED WITH LINTELS. LINTELS SHALL BE STRUCTURAL STEEL OR PRECAST CONCRETE AS INDICATED IN THE LINTEL SCHEDULE. ALL LINTELS SHALL HAVE 8" MINIMUM BEARING AND SHALL BE SET IN A FULL BED OF MORTAR, SHORE LINTELS AS REQUIRED TO PREVENT ROTATION DURING CONSTRUCTION. NOTE THAT ALL WALL OPENINGS ARE NOT SHOWN ON THE STRUCTURAL DRAWINGS. CONTRACTOR SHALL COORDINATE SIZE, TYPE AND LOCATION OF ALL LINTELS REQUIRED WITH ARCHITECTURAL AND MECHANICAL DRAWINGS.

MASONRY WALL LINTEL SCHEDULE								
MARK	TYPE	CONFIGURATION	REMARKS					
Þ	4" WIDE x 8" HIGH PRECAST MASONRY LINTEL w/ (I)-#5 TOP & BOTTOM FOR EACH 4" OF WALL THICKNESS.		WHERE INDICATED AND/ OR FOR OPENINGS IN NON-BEARING INTERIOR PARTITIONS UP TO 5'-O" WIDE. UNLESS OTHERWISE NOTED, PROVIDE 8" MIN. BEARING EACH END.					
P6	6" WIDE x 8" HIGH PRECAST MASONRY LINTEL w/ (I)-#5 TOP & BOTTOM FOR EACH 6" OF WALL THICKNESS.	•	WHERE INDICATED AND/ OR FOR OPENINGS IN NON-BEARING 6" CMU INTERIOR PARTITIONS UP TO 5'-O" WIDE. PROVIDE 8" MIN. BEARING EA. END.					
LI	L4x3 1/2x5/16 LLV FOR EACH 4" OF WALL THICKNESS.		WHERE INDICATED AND/ OR FOR OPENINGS IN WALLS UP TO 6'-O" WIDE. PROVIDE 8" MIN. BEARING EACH END, UNLESS OTHERWISE NOTED.					
L2	L6x3 1/2x5/16 LLV FOR EACH 4" OF WALL THICKNESS.		WHERE INDICATED AND/ OR FOR OPENINGS IN WALLS BETWEEN 6'-O" TO IO'-O" WIDE. PROVIDE 8" MIN. BEARING EACH END.					
L3	(2)-L4x3 1/2x5/16 LLV w/ L4x3 1/2x5/16 + L3x3x1/4 AT VENEER	-3"	WHERE INDICATED. PROVIDE 8" MIN. SOLID BEARING EACH END.					

STRUCTURAL STEEL

FABRICATION & ERECTION OF STRUCTURAL STEEL SHALL CONFORM TO AISC SPECIFICATIONS \$ AWS DI.I.

NEW STRUCTURAL STEEL: WIDE FLANGE SHAPES: ASTM A992 GRADE 50

MISC. CHANNELS, ANGLES, PLATES: ASTM A36, UNLESS OTHERWISE NOTED

WELDING ELECTRODES: ETOXX HIGH STRENGTH BOLTS: ASTM A 325-N.

SHOP PREP OTHER STEEL PER SSPC SP3. PROVIDE TWO COATS OF FABRICATOR'S STANDARD RUST INHIBITING PRIMER.

ALL WELDING SHALL CONFORM TO AWS STANDARDS AND SHALL BE PERFORMED BY CERTIFIED WELDERS. ALL WELDING TO ANY EXISTING MEMBERS SHALL BE PREFORMED WITH EXTREME CARE TO AVOID EXCESSIVE DAMAGE TO THE BASE METAL.

#### METAL DECK

FABRICATION AND ERECTION OF STEEL DECK SHALL CONFORM TO STEEL DECK INSTITUTE SPECIFICATIONS.

STEEL DECK - ASTM A 653 (SQ), GRADE 33 GALVANIZING - ASTM A 924, G90 GALVANIZED COATING.

FASTEN DECK WITH 5/8" PUDDLE WELD AT 12"o.c. MAX NO LOADS SHALL BE SUSPENDED FROM METAL DECK WHETHER DECK IS NEW OR EXISTING

ALL ANCHORS INDICATED TO BE MANUFACTURED BY HILTI OR APPROVED EQUIVALENT.

INSTALLATION OF ALL ANCHORS SHALL ADHERE TO HILTI SPECIFICATIONS. INSTALLERS OF ANCHORS SHALL BE TRAINED BY HILTI IN THE PROPER INSTALLATION METHODS PRIOR TO INSTALLATION

#### OF ANCHORS IN THE FIELD. **SUBMITTALS**

ORIGINAL SUBMITTALS SHALL BE SUBMITTED FOR ARCHITECT/ENGINEER'S REVIEW FOR THE FOLLOWING ITEMS:

CONCRETE MIX DESIGNS

CONCRETE AND MASONRY REINFORCING STEEL SHOP DRAWINGS

SHOP DRAWINGS FOR STRUCTURAL AND METAL DECK IF A CONTRACTOR FAILS TO SUBMIT THE SHOP DRAWINGS, THE FIRM, MINCIN PATEL MILANO, INC. WILL NOT BE RESPONSIBLE FOR THE CONTRACTORS INTERPRETATION OF THE INTENT OF THE STRUCTURAL DRAWINGS. THE GENERAL CONTRACTOR SHALL REVIEW ALL SHOP DRAWINGS PRIOR TO SUBMISSION TO THE A/E AND SHALL MAKE ALL CORRECTIONS AS HE DEEMS NECESSARY. THE

## AN INDEPENDENT INSPECTION AGENCY, PAID FOR BY THE CONTRACTOR AND APPROVED BY THE ARCHITECT/ENGINEER.

GENERAL CONTRACTOR SHALL STATE IN WRITING ANY DEVIATION OR OMISSIONS FROM THE CONTRACT DOCUMENTS.

SHALL INSPECT/MONITOR/TEST THE FOLLOWING ITEMS:

NEW CAST IN PLACE CONCRETE AND REINFORCING STEEL

NEW STRUCTURAL STEEL AND METAL DECK COPIES OF THE INSPECTORS FINAL REPORTS CERTIFYING THAT THE ITEMS INSPECTED HAVE BEEN INSTALLED IN ACCORDANCE WITH THE REQUIREMENTS OF THE CONTRACT DOCUMENTS SHALL BE SUBMITTED TO THE ARCHITECT/ENGINEER.

THESE BUILDING MODIFICATIONS HAVE BEEN DESIGNED FOR THE FOLLOWING LIVE LOAD CRITERIA FROM THE APPLICABLE CODES LISTED BELOW:

IBC 2015 IEBC 2015 ASCE 7-10

BUILDING RISK CATEGORY: NEW ROOF LIVE LOAD: 30psf 100psf

NEW FLOOR LIVE LOAD: SNOW LOADS: GROUND SNOW (Pa) 30psf FLAT ROOF SNOW 28psf SNOW IMPORTANCE FACTOR (Is) 1.2

SNOW THERMAL FACTOR (Ct) SNOW EXPOSURE FACTOR (Ce) WIND LOADS:

BASIC WIND SPEED: V = 130mph WIND EXPOSURE:

SEISMIC: SEISMIC FORCES RESULTING FROM NEW ADDITION DOES NOT

1.0

SIGNIFICANTLY IMPACT THE SEISMIC FORCES ON THE EXISTING STRUCTURE.

ALL OPENINGS IN MASONRY WALLS AND IN PARTITIONS ARE TO BE PROVIDED WITH LINTELS. LINTELS SHALL BE STRUCTURAL STEEL OR PRECAST CONCRETE AS INDICTED, UNLESS OTHERWISE NOTED. ALL LINTELS SHALL HAVE 8" MINIMUM BEARING AND SHALL BE SET IN A FULL BED OF MORTAR. SHORE LINTELS AS REQUIRED TO PREVENT ROTATION DURING CONSTRUCTION. NOTE THAT ALL WALL OPENINGS ARE NOT SHOWN ON THE STRUCTURAL DRAWINGS. CONTRACTOR SHALL COORDINATE SIZE TYPE, AND LOCATION OF ALL LINTELS REQUIRED WITH ARCHITECTURAL AND MECHANICAL DRAWINGS.

SUBDIVISION: FULLERTON

BALTIMORE COUNTY OFFICE OF BUDGET AND FINANCE, PROPERTY MANAGEMENT

SHEET DESIGNATION CONTRACT NUMBER 25034 PF0 RE-BID STRUCTURAL JOB ORDER NUMBER

241-220-0054-0012 SHEET 32 of 58 DRAWING NUMBER

PROFESSIONAL CERTIFICATION

HEREBY CERTIFY THAT THESE DOCUMENTS WERE PREPARED OR

INGINEER UNDER THE LAWS OF THE STATE OF MARYLAND.

CENSE NO. 17403

LTIMORE, MARYLAND 21214 j 410-254-7500

LUI MILANO PE INCIPAL ENGINEER

NPPROVED BY ME, AND THAT I AM A DULY LICENSED PROFESSIONAL

EXPIRATION DATE: 06-28-2025

WN BY


STRUCTURAL GENERAL NOTES & SCHEDULES

4401 FITCH AVENUE, NOTTINGHAM, MARYLAND 21236


FULLERTON FIRE STATION #8 - RENOVATION & ADDITION

ELECTION DIST. NO.: 8C5

FILE NO.: 20-120 MPM #21137

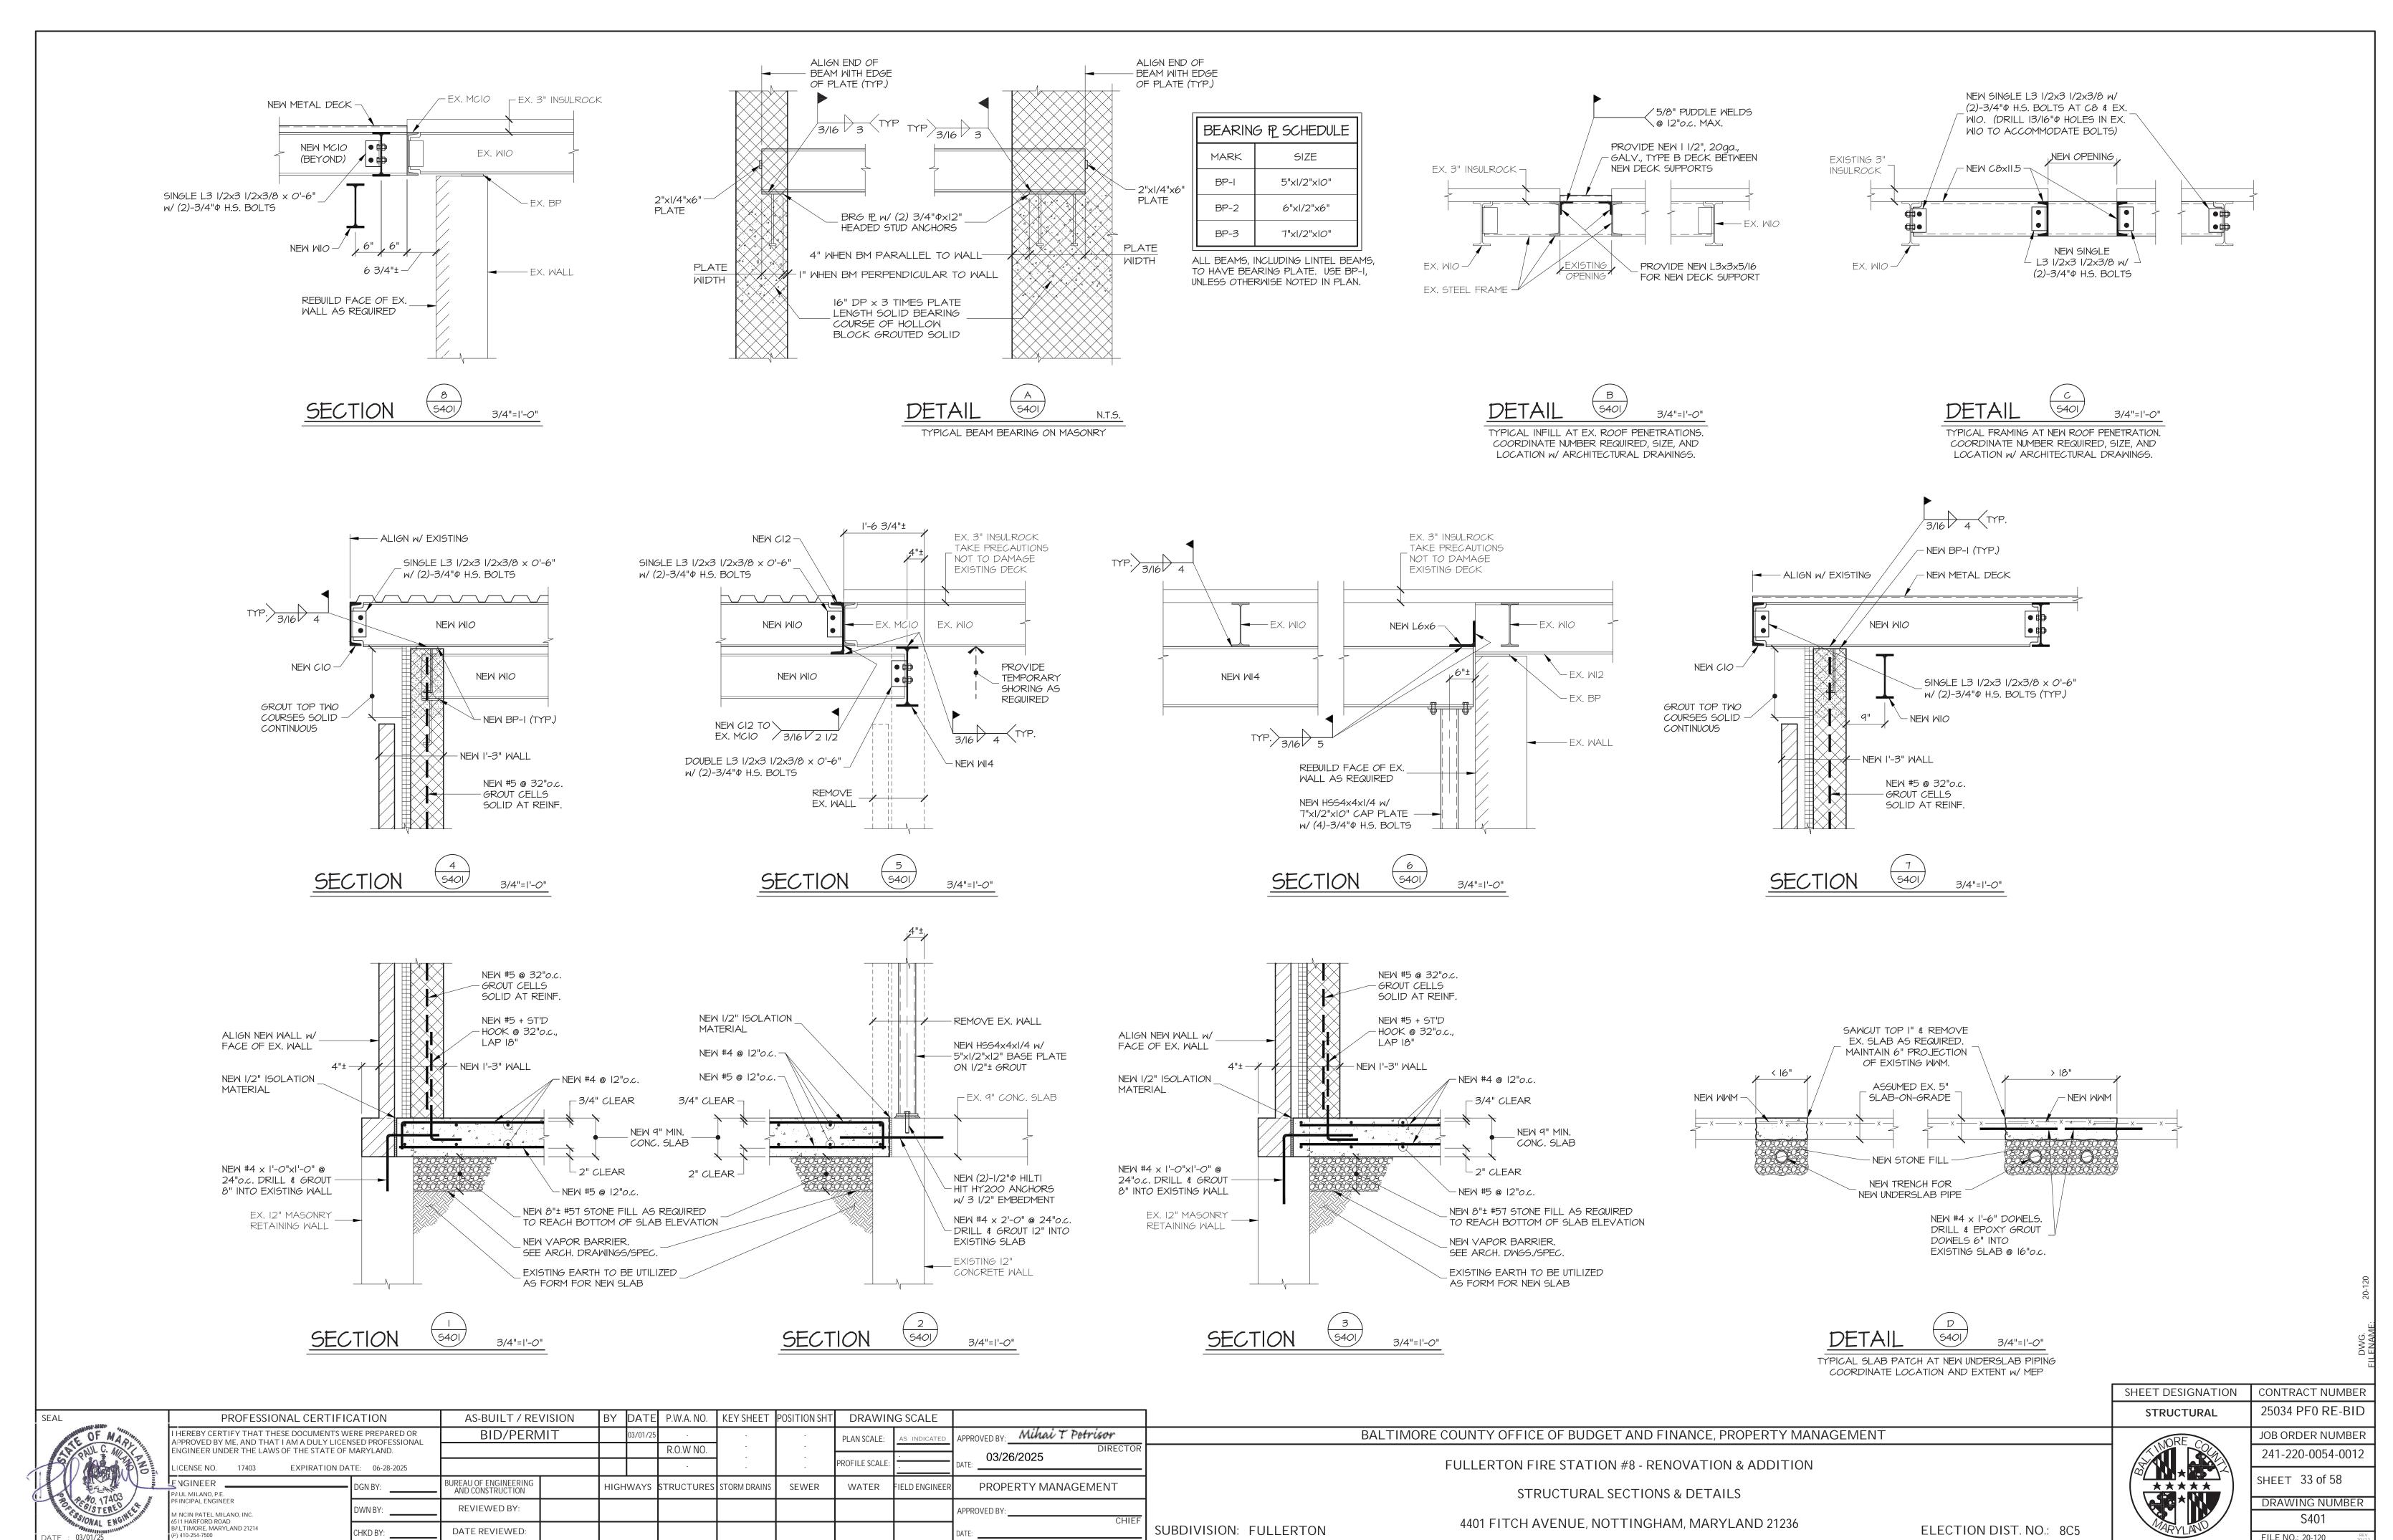


FILE NO.: 20-120 MPM #21137

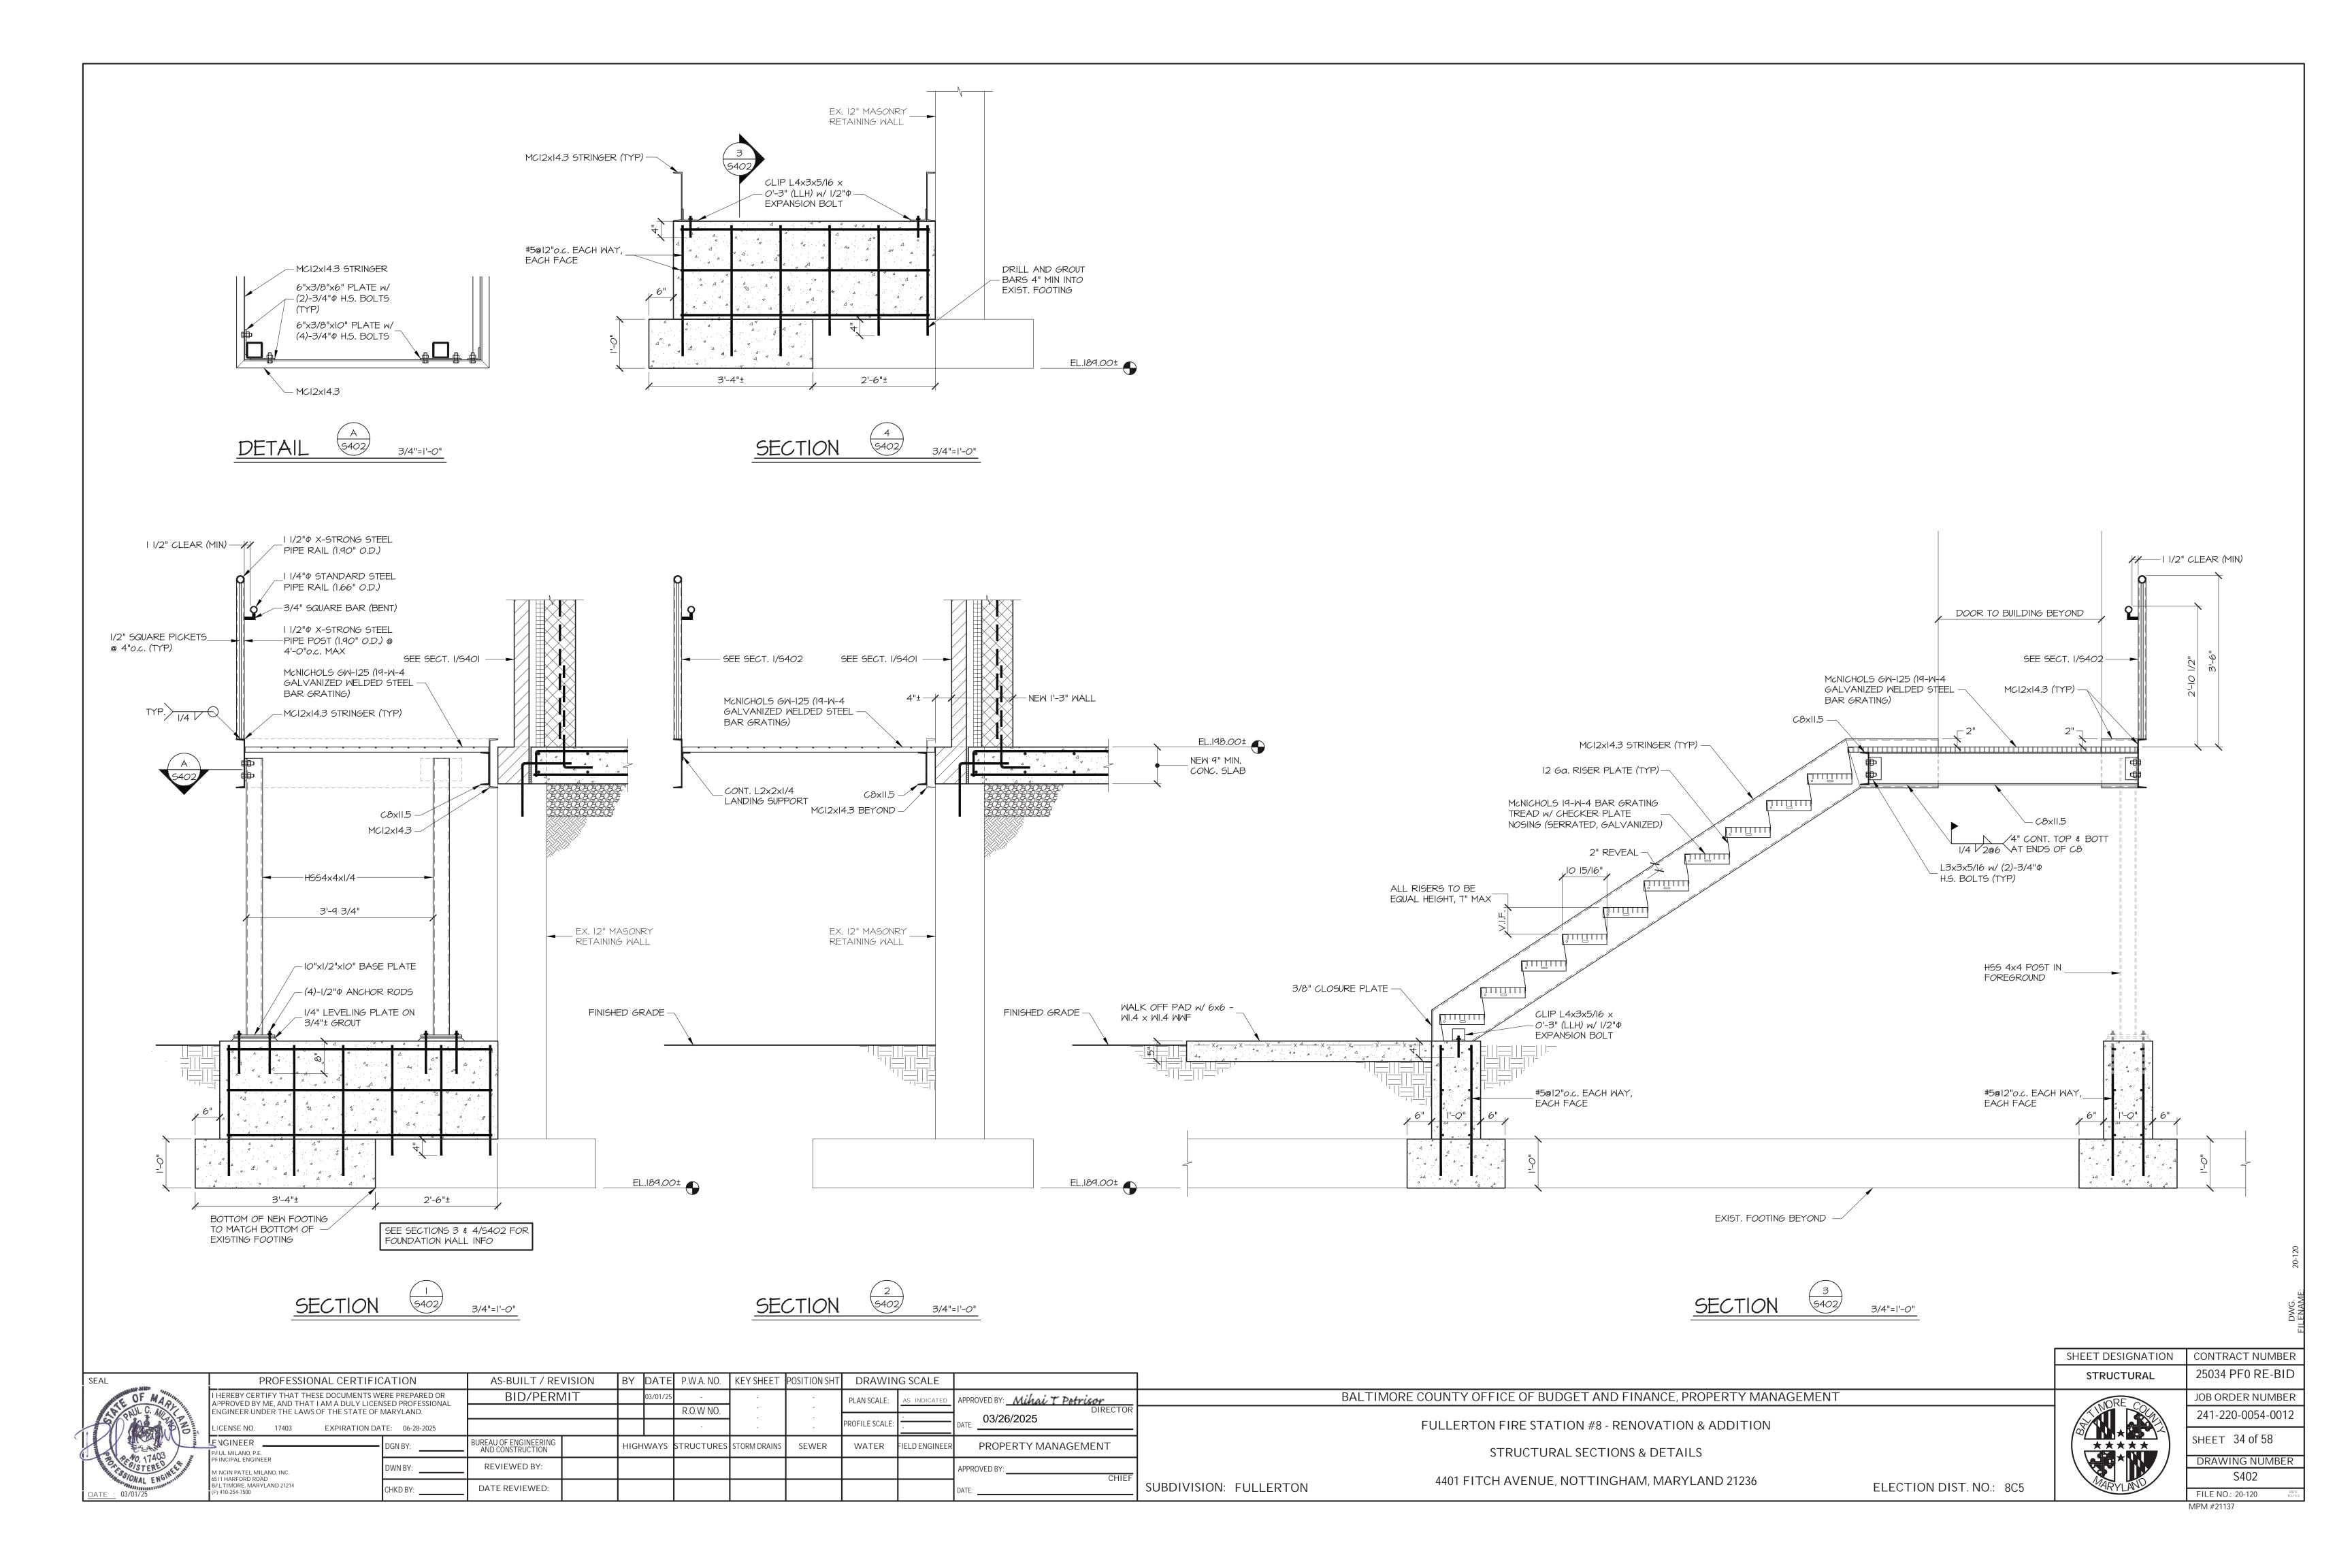



1D-Ø-0x0-000(QTY)

# LINEAR/SLOT DIFFUSER KEY

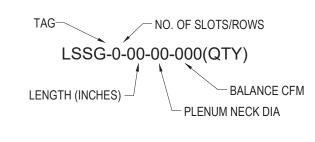

## DRUM DIFFUSER KEY

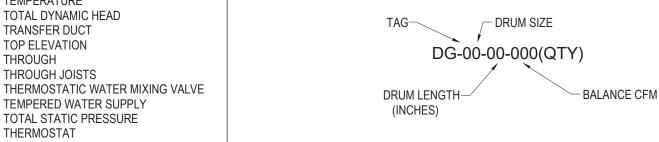


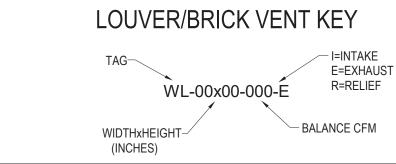

# **DUCT ACCESS DOORS**






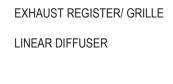







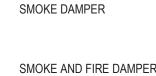

# SMOKE AND FIRE DAMPER RADIATION DAMPER

BDD



# MOTOR OPERATED DAMPER

SMOKE DETECTOR (DUCT MOUNTED)

#### HOT WATER TEMPER VALVE GAS COCK/GAS STOP VALVE STATIC PRESSURE SENSOR COMPRESSED AIR SHUT-OFF VALVE

PRESSURE/ TEMPERATURE TEST FITTING ALIGNMENT GUIDE

FLEXIBLE CONNECTOR **EXPANSION COMPENSATOR** 

**EXPANSION LOOP** 

STRAINER WITH HOSE END BLOW OFF VALVE STRAINER PUMP

BALANCING VALVE BALL VALVE BUTTERFLY VALVE

NEEDLE VALVE

— SAFETY RELIEF VALVE

SHUT OFF VALVE

SOLENOID VALVE

THROTTLE VALVE

────────── TRIPLE-DUTY VALVE

DOUBLE CHECK VALVE

STOP CHECK VALVE

PRESSURE REDUCING VALVE

PRESSURE REGULATOR VALVE

PRESSURE RELIEF VALVE

THERMOMETER (DIAL TYPE)

THERMOMETER (STEM TYPE)

FLOW METER

PRESSURE GAUGE WITH NEEDLE VALVE

GLOBE VALVE

→ PLUG VALVE

ABOVE LEGEND IS STANDARD. ALL SYMBOLS DO NOT NECESSARILY APPEAR ON THE DRAWINGS. ———

CHECK VALVE DRAIN VALVE GATE VALVE

## HVAC GENERAL NOTES

GENERAL NOTES ON THIS DRAWING ARE APPLICABLE TO EACH MECHANICAL DRAWING OF THIS SET. SEE EACH DRAWING FOR SPECIFIC NOTES APPLICABLE TO THAT DRAWING.

ALL DIMENSIONS, AND PIPE SIZES ARE IN INCHES UNLESS NOTED OTHERWISE. VALVES AND SPECIALTIES SHALL BE LINE SIZE, EXCEPT FOR CONTROL & BALANCING VALVES OR UNLESS NOTED OTHERWISE. NO PIPING SHALL BE SMALLER THAN 3/4" UNLESS OTHERWISE NOTED. FOR PIPE SIZES NOT INDICATED ON PLANS SEE EQUIPMENT CONNECTION DETAILS, FLOW DIAGRAMS, RISER DIAGRAMS AND SCHEDULES.

COORDINATE WALL, ROOF, FLOOR, AND CEILING OPENINGS FOR NEW PIPE AND DUCT RISERS, AND CONDUIT PENETRATIONS. PROVIDE SLEEVES AROUND EXISTING PIPES AND DUCTS THRU NEW WALL/PARTITIONS.

EXISTING EQUIPMENT, APPLIANCES, ETC.; STRUCTURAL JOISTS, BEAMS, ETC.; AND LIGHTING FIXTURES, ELECTRICAL EQUIPMENT; ETC. WHERE SHOWN ARE FOR REFERENCE ONLY. VERIFY IN FIELD. REFER TO RESPECTIVE DRAWINGS AND EXISTING RECORD DRAWINGS

ALL EQUIPMENT, PIPING, AND DUCTWORK SHALL BE SUPPORTED FROM JOIST TOP CHORD, UNLESS OTHERWISE NOTED. DO NOT SUPPORT ANYTHING FROM ROOF DECK.

ALL PIPING IN AREAS WITH CEILING SHALL BE RUN CONCEALED ABOVE ACOUSTICAL OR PLASTER CEILINGS UNLESS OTHERWISE NOTED. OVERHEAD PIPING IN SPACES WITHOUT HUNG CEILINGS SHALL BE RUN AS CLOSE TO FLOOR/ROOF DECK AS PRACTICABLE, AS CLOSE TO PARALLEL JOISTS AS POSSIBLE AND ABOVE LIGHTING FIXTURES TO CONCEAL PIPING.

ALL OPENINGS IN PIPES OR FITTINGS SHALL BE KEPT PLUGGED OR CAPPED UNTIL

INSTALL SUFFICIENT NUMBER OF UNIONS/FLANGES IN ALL PIPE LINES TO ALLOW REMOVAL OF PIPES WITHOUT BREAKING FITTINGS. PROVIDE UNION OR FLANGED CONNECTIONS AT EACH PIECE OF EQUIPMENT AND ON BOTH SIDES ON CONTROL VALVES AND PRESSURE REGULATING VALVES. PROVIDE SHUT-OFF VALVES ON BOTH SIDES OF AUTOMATIC VALVES

RUNOUTS TO EQUIPMENT SHALL BE RUN IN SIZES INDICATED AND INCREASED OR REDUCED AT POINT OF FINAL CONNECTION TO EQUIPMENT. COORDINATE LOCATION AND INSTALLATION OF EQUIPMENT WITH OTHER TRADES. RUNOUTS SHALL PITCH DOWN IN DIRECTION OF FLOW A MINIMUM OF 1/8" PER FOOT.

CONTRACTOR SHALL VERIFY ANY REFRIGERANT PIPE SIZES WITH EQUIPMENT

THE DRAWINGS ARE DIAGRAMMATIC AND INDICATE THE APPROXIMATE ARRANGEMENT OF THE EXISTING SYSTEMS. THE CONTRACTOR SHALL FIELD VERIFY EXACT INFORMATION. DIMENSIONS, LOCATIONS, ETC. AS NECESSARY AND COORDINATE WORK ACCORDINGLY. NOT ALL INFORMATION IS SHOWN. DRAWINGS DO NOT SHOW ALL OFFSETS, BENDS, ELBOWS, OR OTHER SPECIFIC ELEMENTS THAT MAY BE REQUIRED FOR THE PROPER INSTALLATION OF

INFORMATION WHERE SHOWN ON THE DRAWINGS WAS OBTAINED FROM EXISTING DRAWINGS AND FIELD OBSERVATION. THE CONTRACTOR SHALL VERIFY CORRECTNESS AND COMPLETENESS OF SUCH INFORMATION TO HIS/HER OWN SATISFACTION.

REMOVE ALL MECHANICAL SYSTEMS IN THEIR ENTIRETY, CUT. PATCH, AND FINISH WHERE DEMOLITION WORK OCCURS.

COORDINATE DEMOLITION WORK WITH THE OWNER SCHEDULE. EXISTING HVAC SYSTEM & OTHER SYSTEMS IN OTHER PHASES/AREAS ARE REQUIRED TO BE IN OPERATION DURING THE PROJECT CONSTRUCTION

REFER TO ALL CONTRACT DOCUMENTS FOR ADDITIONAL REQUIREMENTS AND COORDINATE WORK ACCORDINGLY.

ALL FLOOR MOUNTED EQUIPMENT, AND APPURTENANCES SHALL HAVE MINIMUM 6" THICK CONCRETE HOUSEKEEPING PAD AND 6" LARGER THAN FOOT PRINT DIMENSIONS WHETHER SHOWN OR NOT. LOCATE AND SIZE CONCRETE PADS FOR MECHANICAL EQUIPMENT IN ACCORDANCE WITH ACTUAL EQUIPMENT PURCHASED.

INCLUDE ALL INCIDENTAL WORK REQUIRED FOR THE WORK INCLUDING TEMPORARY DISCONNECTION, RELOCATION, AND REINSTALLATION OF THE EXISTING OBSTRUCTIONS SUCH AS PIPING, CONDUITS, DUCTWORK, DOORS, BEAMS, JOISTS, SPRINKLERS, ETC. WHETHER SHOWN OR NOT. COORDINATE TEMPORARY SHUTDOWNS WITH OWNER'S

REPRESENTATIVE AS SPECIFIED. DO NOT INSTALL PIPING, DUCTWORK OR EQUIPMENT OVER ELECTRICAL EQUIPMENT.

PROVIDE REQUIRED CLEARANCES FOR ALL ELECTRICAL EQUIPMENT PER NEC. COORDINATE LOCATIONS OF DUCTWORK, PIPING, AND EQUIPMENT ABOVE CEILINGS WITH CABLE TRAYS.

PIPING SHALL BE SUPPORTED IN ACCORDANCE WITH THE SPECIFICATIONS. ADDITIONAL SUPPORTS OR HANGERS SHALL BE ADJACENT TO ELBOWS. TO PREVENT WEIGHT OF PIPING BEING PLACED ON THE EQUIPMENT.

PENETRATIONS IN FIRE RESISTANT RATED ASSEMBLIES SHALL BE IN COMPLIANCE WITH NFPA STANDARDS AND UL LISTED AS A THROUGH-PENETRATION. FIRE STOP ANNULAR SPACE BETWEEN PIPING AND SLEEVE WITH UL LISTED FIRE RATED MATERIAL. WITH A RATING EQUAL TO THE ASSEMBLY BEING PENETRATED. PENETRATIONS AND FIRE STOPPING SHALL BE APPROVED BY THE AHJ AND IN COMPLIANCE WITH THE LATEST EDITION OF THE UL DIRECTORY OF FIRE RESISTANCE.

MAINTAIN THE INTEGRITY OF ALL FIRE AND SMOKE RATED ASSEMBLIES WITHIN THE BUILDING AFFECTED BY WORK UNDER THIS CONTRACT. PATCH AND/OR REPAIR ALL FIRE AND SMOKE RATED ASSEMBLIES AS REQUIRED TO MAINTAIN EXISTING OR NEW RATING.

PROVIDE PRE-CONSTRUCTION TEST AND BALANCE OF EXISTING HVAC SYSTEMS AFFECTED BY PROJECT WORK TO IDENTIFY SYSTEM DEFICIENCIES, AND ESTABLISH EXISTING CONDITIONS. SUBMIT REPORT WITHIN 7 DAYS TO OWNER AND ARCHITECT/ENGINEER FOR ANY FIELD ADJUSTMENTS AND DIRECTIONS PRIOR TO PROCEED WITH NEW CONSTRUCTION.

WORK OUTSIDE THE PROJECT WORK AREA:

THE CONTRACTOR SHALL BE RESPONSIBLE TO COORDINATE WITH THE BUILDING MANAGER AND THE OWNER FOR NOISY WORK, WORK IMPACTING AREAS OUTSIDE OF WORK AREA, AND WORK OUTSIDE OF PROJECT AREA. SUCH WORK SHALL BE PERFORMED ON THE WEEKENDS (WHEN TENANT'S OFFICES ARE UNOCCUPIED OR AFTER THE OFFICE WORKING HOURS. THIS WORK SHALL BE SCHEDULED WITH BUILDING MANAGER BY PROVIDING FOURTEEN DAYS ADVANCE NOTICE AND ONE DAY REMINDER NOTICE. ALL SUCH COSTS OF WORKING OVERTIME ON THE WEEKENDS OR IN THE NIGHTS SHALL BE INCLUDED IN THE BASE BID.

WHEN WORKING IN OTHER AREAS, AFTER EACH DAY OF WORK, REMOVE ALL THE DEBRIS AND MATERIAL FROM THE AREAS. CEILINGS SHALL BE CLOSED AND FLOOR SHALL BE FULLY CLEANED TO THE SATISFACTION OF THE BUILDING MANAGER. CONTRACTOR SHALL BE RESPONSIBLE TO REPLACE ANY AND ALL DAMAGED ITEMS WHEN WORKING IN OTHER AREAS. NEW CEILING TILES SHALL MATCH WITH THE EXISTING CEILING TILES. COORDINATE WITH BUILDING MANAGER AND ARCHITECT.

SHEET DESIGNATION	CONTRACT NUMBE
M001	25034 PF0 RE-BI

FULLERTON FIRE STATION #8 - RENOVATION & ADDITION

BALTIMORE COUNTY OFFICE OF BUDGET AND FINANCE, PROPERTY MANAGEMENT

LEGEND, ABBREVIATIONS AND NOTES

4401 FITCH AVENUE, NOTTINGHAM, MARYLAND, 21236

CONDENSATE RETURN

— G — NATURAL GAS, LOW PRESSURE

— SSx — EXISTING SANITARY SEWER

— Vx — EXISTING SANITARY VENT

——— — DOMESTIC COLD WATER SUPPLY

—— — DOMESTIC HOT WATER SUPPLY

———— DOMESTIC HOT WATER RETURN

— TWS — DOMESTIC TEMPERED WATER SUPPLY

*TWSx* — EXISTING DOMESTIC TEMPERED WATER SUPPLY

--- GV --- GAS VENT

— SS — SANITARY SEWER

— V — SANITARY VENT

 $\star\star\star\star\star$ 

JOB ORDER NUMBER 241**-**220**-**0054**-**0012

SHEET 35 of 58 DRAWING NUMBER 2022**-**2351 FILE NO.: 20-120

AS-BUILT / REVISION BY DATE P.W.A. NO. KEY SHEET POSITION SH PROFESSIONAL CERTIFICATION BID/PERMIT PPROVED BY: Mihai T Petrisor HEREBY CERTIFY THAT THESE DOCUMENTS WERE PREPARED OR PLAN SCALE: APPROVED BY ME. AND THAT I AM A DULY LICENSED R.O.W NO. PROFESSIONAL ENGINEER UNDER THE LAWS OF THE STATE OF 03/26/2025 MARYLAND. LICENSE NO. 22942 EXPIRATION DATE: 12-24-2026 NGINEER: \_\_\_\_\_ PROPERTY MANAGEMENT HIGHWAYS STRUCTURES STORM DRAINS SEWER WATER FIELD ENGINER Y PATEL, PE. LEED BD+C REVIEWED BY DWN BY: CCJM APPROVED BY: LTIMORE, MARYLAND 21202 DATE REVIEWED:

EDB

ELEC

**EMER** 

**ENCL** 

EQUIP

ERU

ESP

ETR

**EWB** 

**EWT** 

EXH

**EXIST** 

EXP

FLA

FLEX

FPM

FT HD

FUT

GAL

GALV

GEN

**GENR** 

GPH

GPM

GR

GRD

HDAG

HGB

HORZ

HPC

HSTAT

HTG

HWR

HWS

IN OR

IWG

IWH

H OR HGT

ENTERING DRY BULB TEMPERATURE

EXHAUST FAN

ELECTRICAL

**EMERGENCY** 

**ENCLOSURE** 

**EQUIPMENT** 

FXISTING

FXPOSED

FLEXIBLE

FUTURE

**FAHRENHEIT** 

FLOOR DRAIN

FULL LOAD AMPERES

FEET PER MINUTE

FOOT OR FEET

FEET OF HEAD

GALVANIZED

GENERAL

GENERATOR

GENERAL CONTRACTOR

GALLONS PER HOUR

GALLONS PER MINUTE

GROUND OR GRADE

HOT GAS BYPASS

HORIZONTAL

HUMIDISTAT

HOUR

HEATING

HORSE POWER

HEATING (HVAC) CONTRACTOR

HIGH PRESSURE CONDENSATE

HIGH PRESSURE STEAM

HOT WATER RETURN

HOT WATER SUPPLY

HEAT EXCHANGER

INSIDE DIAMETER

INCH WATER GAUGE

INTERNAL STATIC PRESSURE

INSTANTANEOUS WATER HEATER

FREQUENCY

INTERIOR

INVFRT

HEAVY DUTY ARCHITECTURAL GRILLE

GAUGE OR GAGE

**ENERGY RECOVERY UNIT** 

**EXISTING TO REMAIN** 

EXTERNAL STATIC PRESSURE

EXHAUST OR EXHAUSTER

ENTERING WET BULB TEMPERATURE

ENTERING WATER TEMPERATURE

EXHAUST GRILLE

RELIEF VALVE

SUPPLY/RETURN

SUPPLY GRILLE

STATIC PRESSURE

SANITARY SEWER

THROUGH BEAM

TRANSFER DUCT

THROUGH JOISTS

UNDER ELECTRICAL

UNDER PLUMBING

UNIT VENTILATOR

VENT PIPING EXISITNG

VARIABLE AIR VOLUME

VIBRATION ISOLATOR

VENT THROUGH ROOF

VENT RISER

WATT

WITH

WITHOUT

WET BULB

WATER GAUGE

WEATHER LOUVER

WATER PRESS DROP

WATER TEMPERATURE DROP

WATER TEMPERATURE RISE

WEATHERPROOF

TRANSFORMER

**VOLUME DAMPER (MANUAL)** 

VARIABLE FREQUENCY DRIVE

UNIT HEATER, UNDER HVAC

UNLESS NOTED OTHERWISE

UNDER GENERAL

TOP ELEVATION

THERMOSTAT

TYPICAL

THROUGH

TEMPERATURE

SPECIFICATIONS

SECURITY EXHAUST GRILLE

SANITARY SEWER EXISTING

SUSPEND OR SUSPENDED

TOTAL DYNAMIC HEAD

STUB & CAP

SANITARY

SQUARE

STANDARD

STEEL

STORAGE

STOR

SUSP

TEMP

TWMV


TSP

**TSTAT** 

XFMR

REMOVE EXISTING

SUBDIVISION: FULLERTON

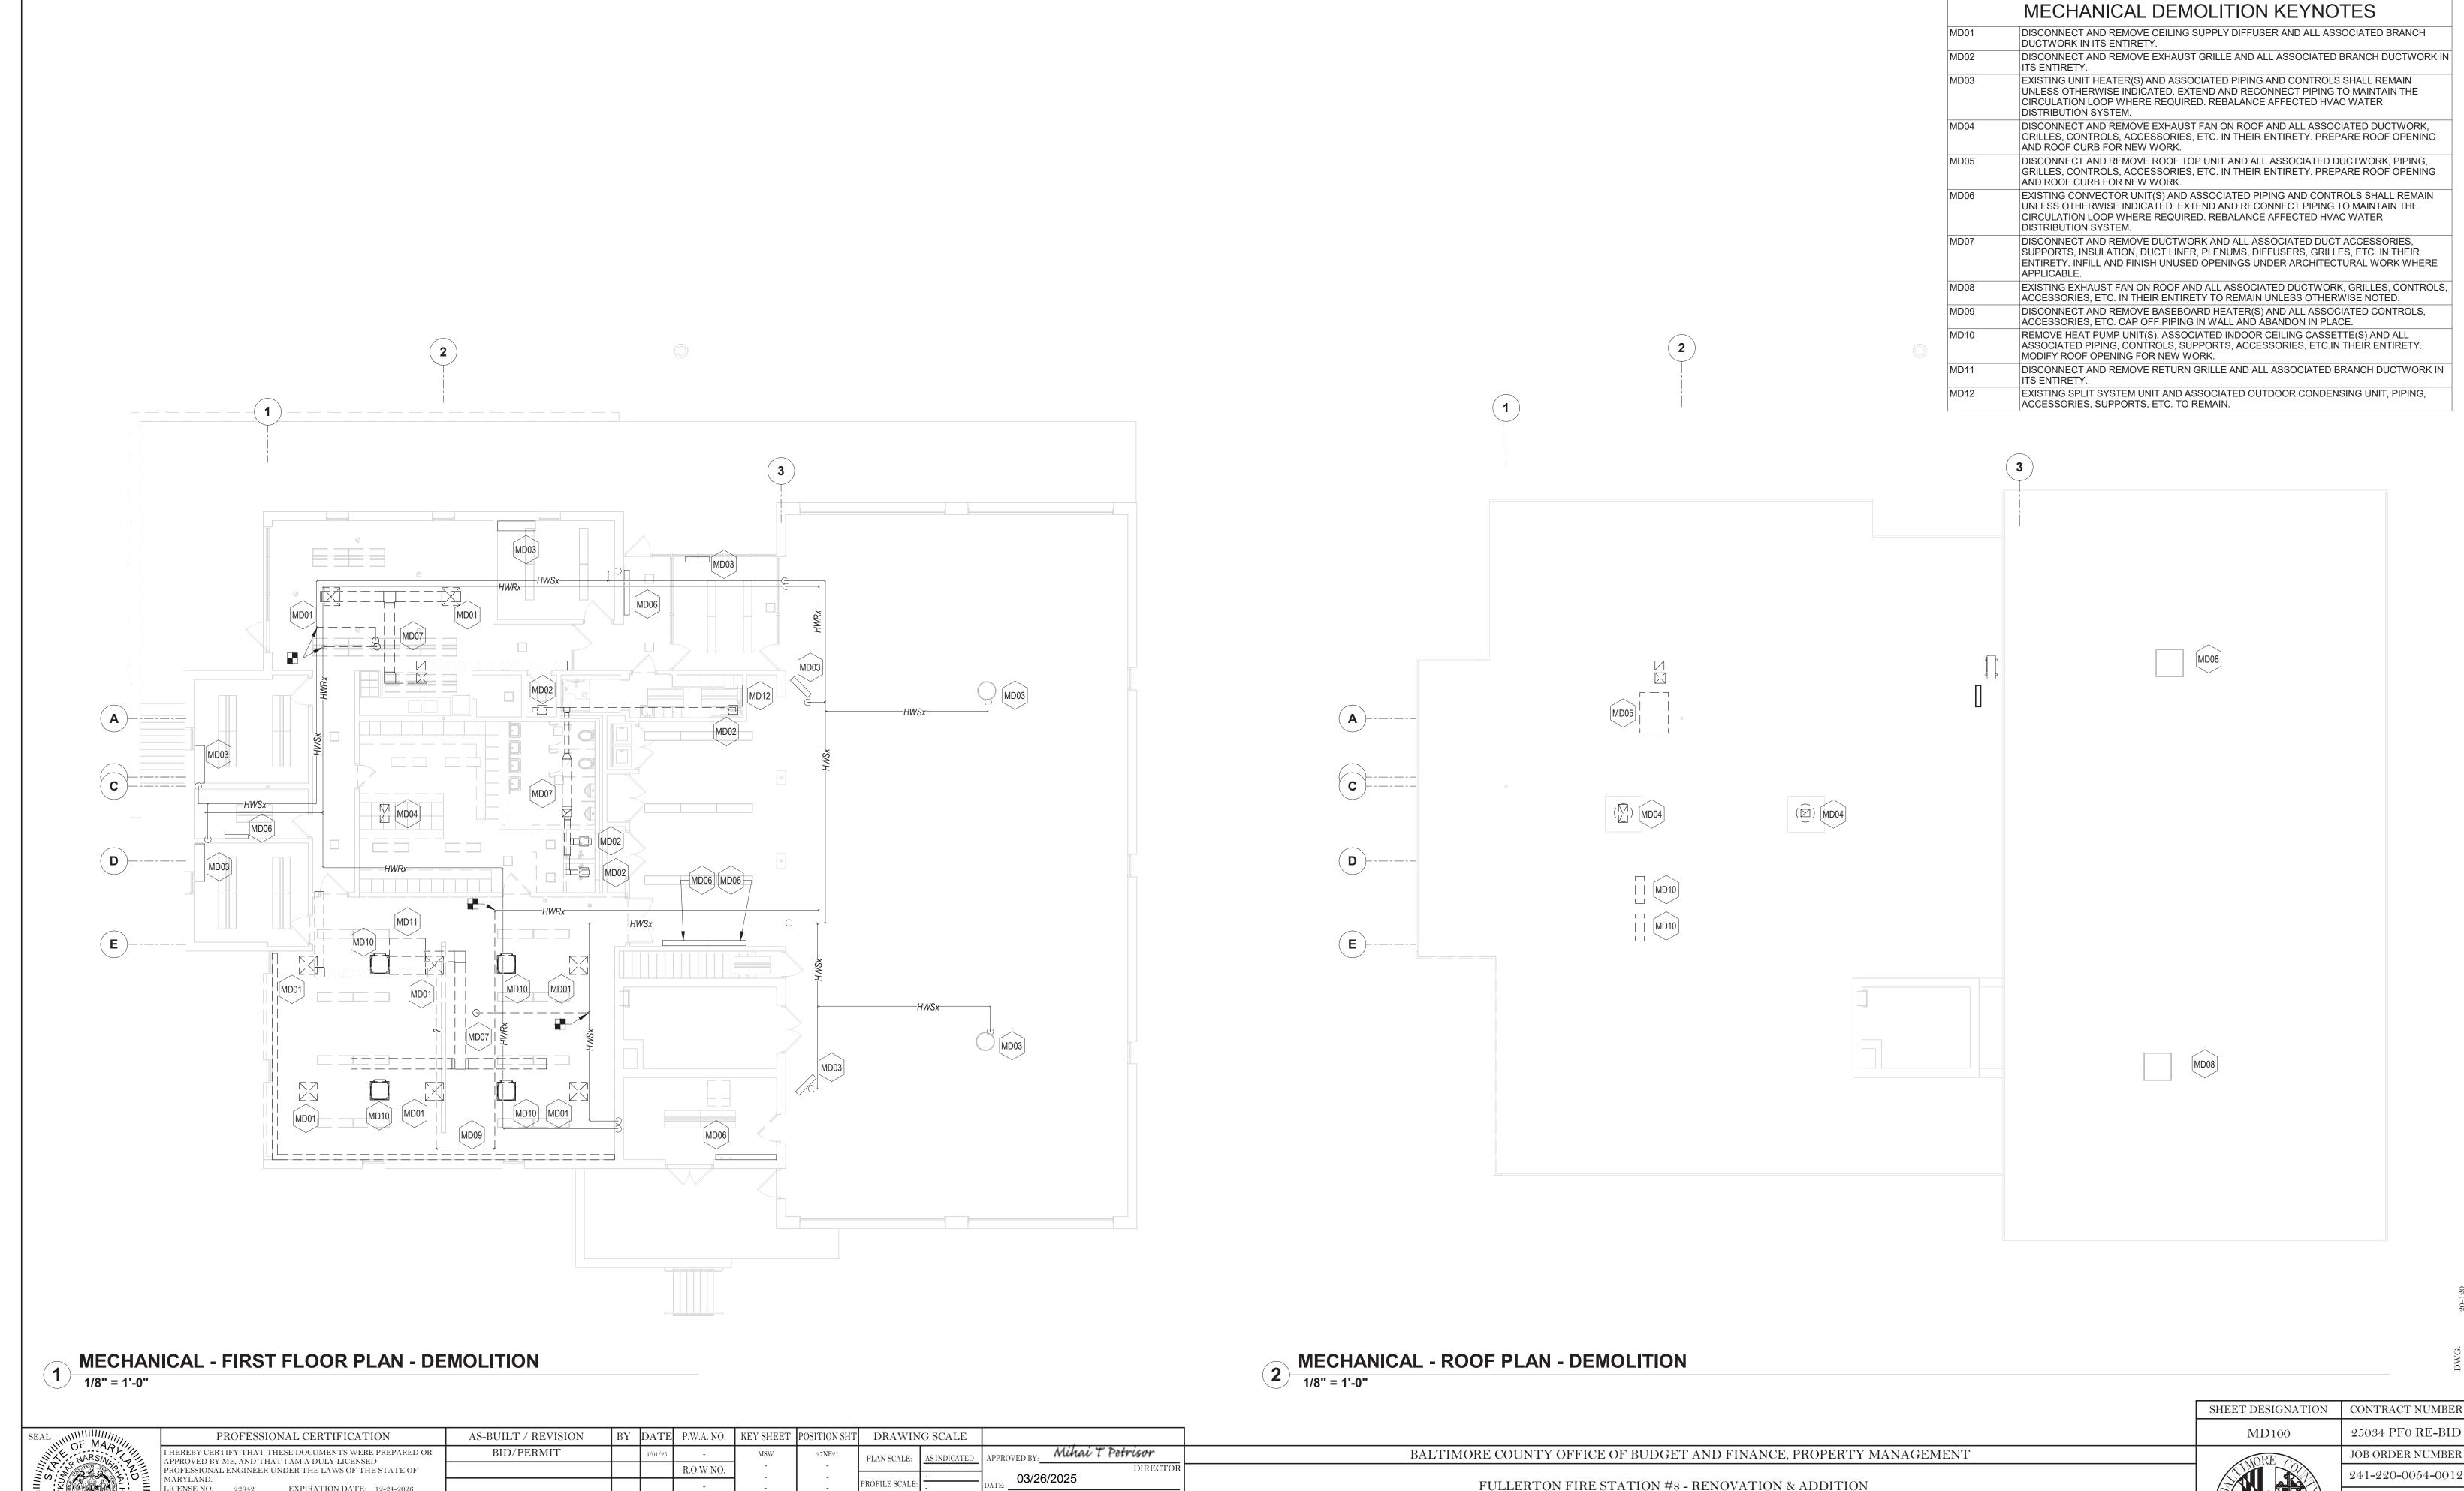

PROPERTY MANAGEMENT

SUBDIVISION: FULLERTON

FIRST FLOOR AND ROOF PLAN - DEMOLITION

4401 FITCH AVENUE, NOTTINGHAM, MARYLAND, 21236

HIGHWAYS STRUCTURES STORM DRAINS SEWER

REVIEWED BY:

DATE REVIEWED:

LTIMORE, MARYLAND 21202

WATER

JOB ORDER NUMBER

241-220-0054-0012


SHEET 36 of 58


DRAWING NUMBER

2022-2352

FILE NO.: 20-120


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MECHANICAL SECTION - DRYER EXHAUST

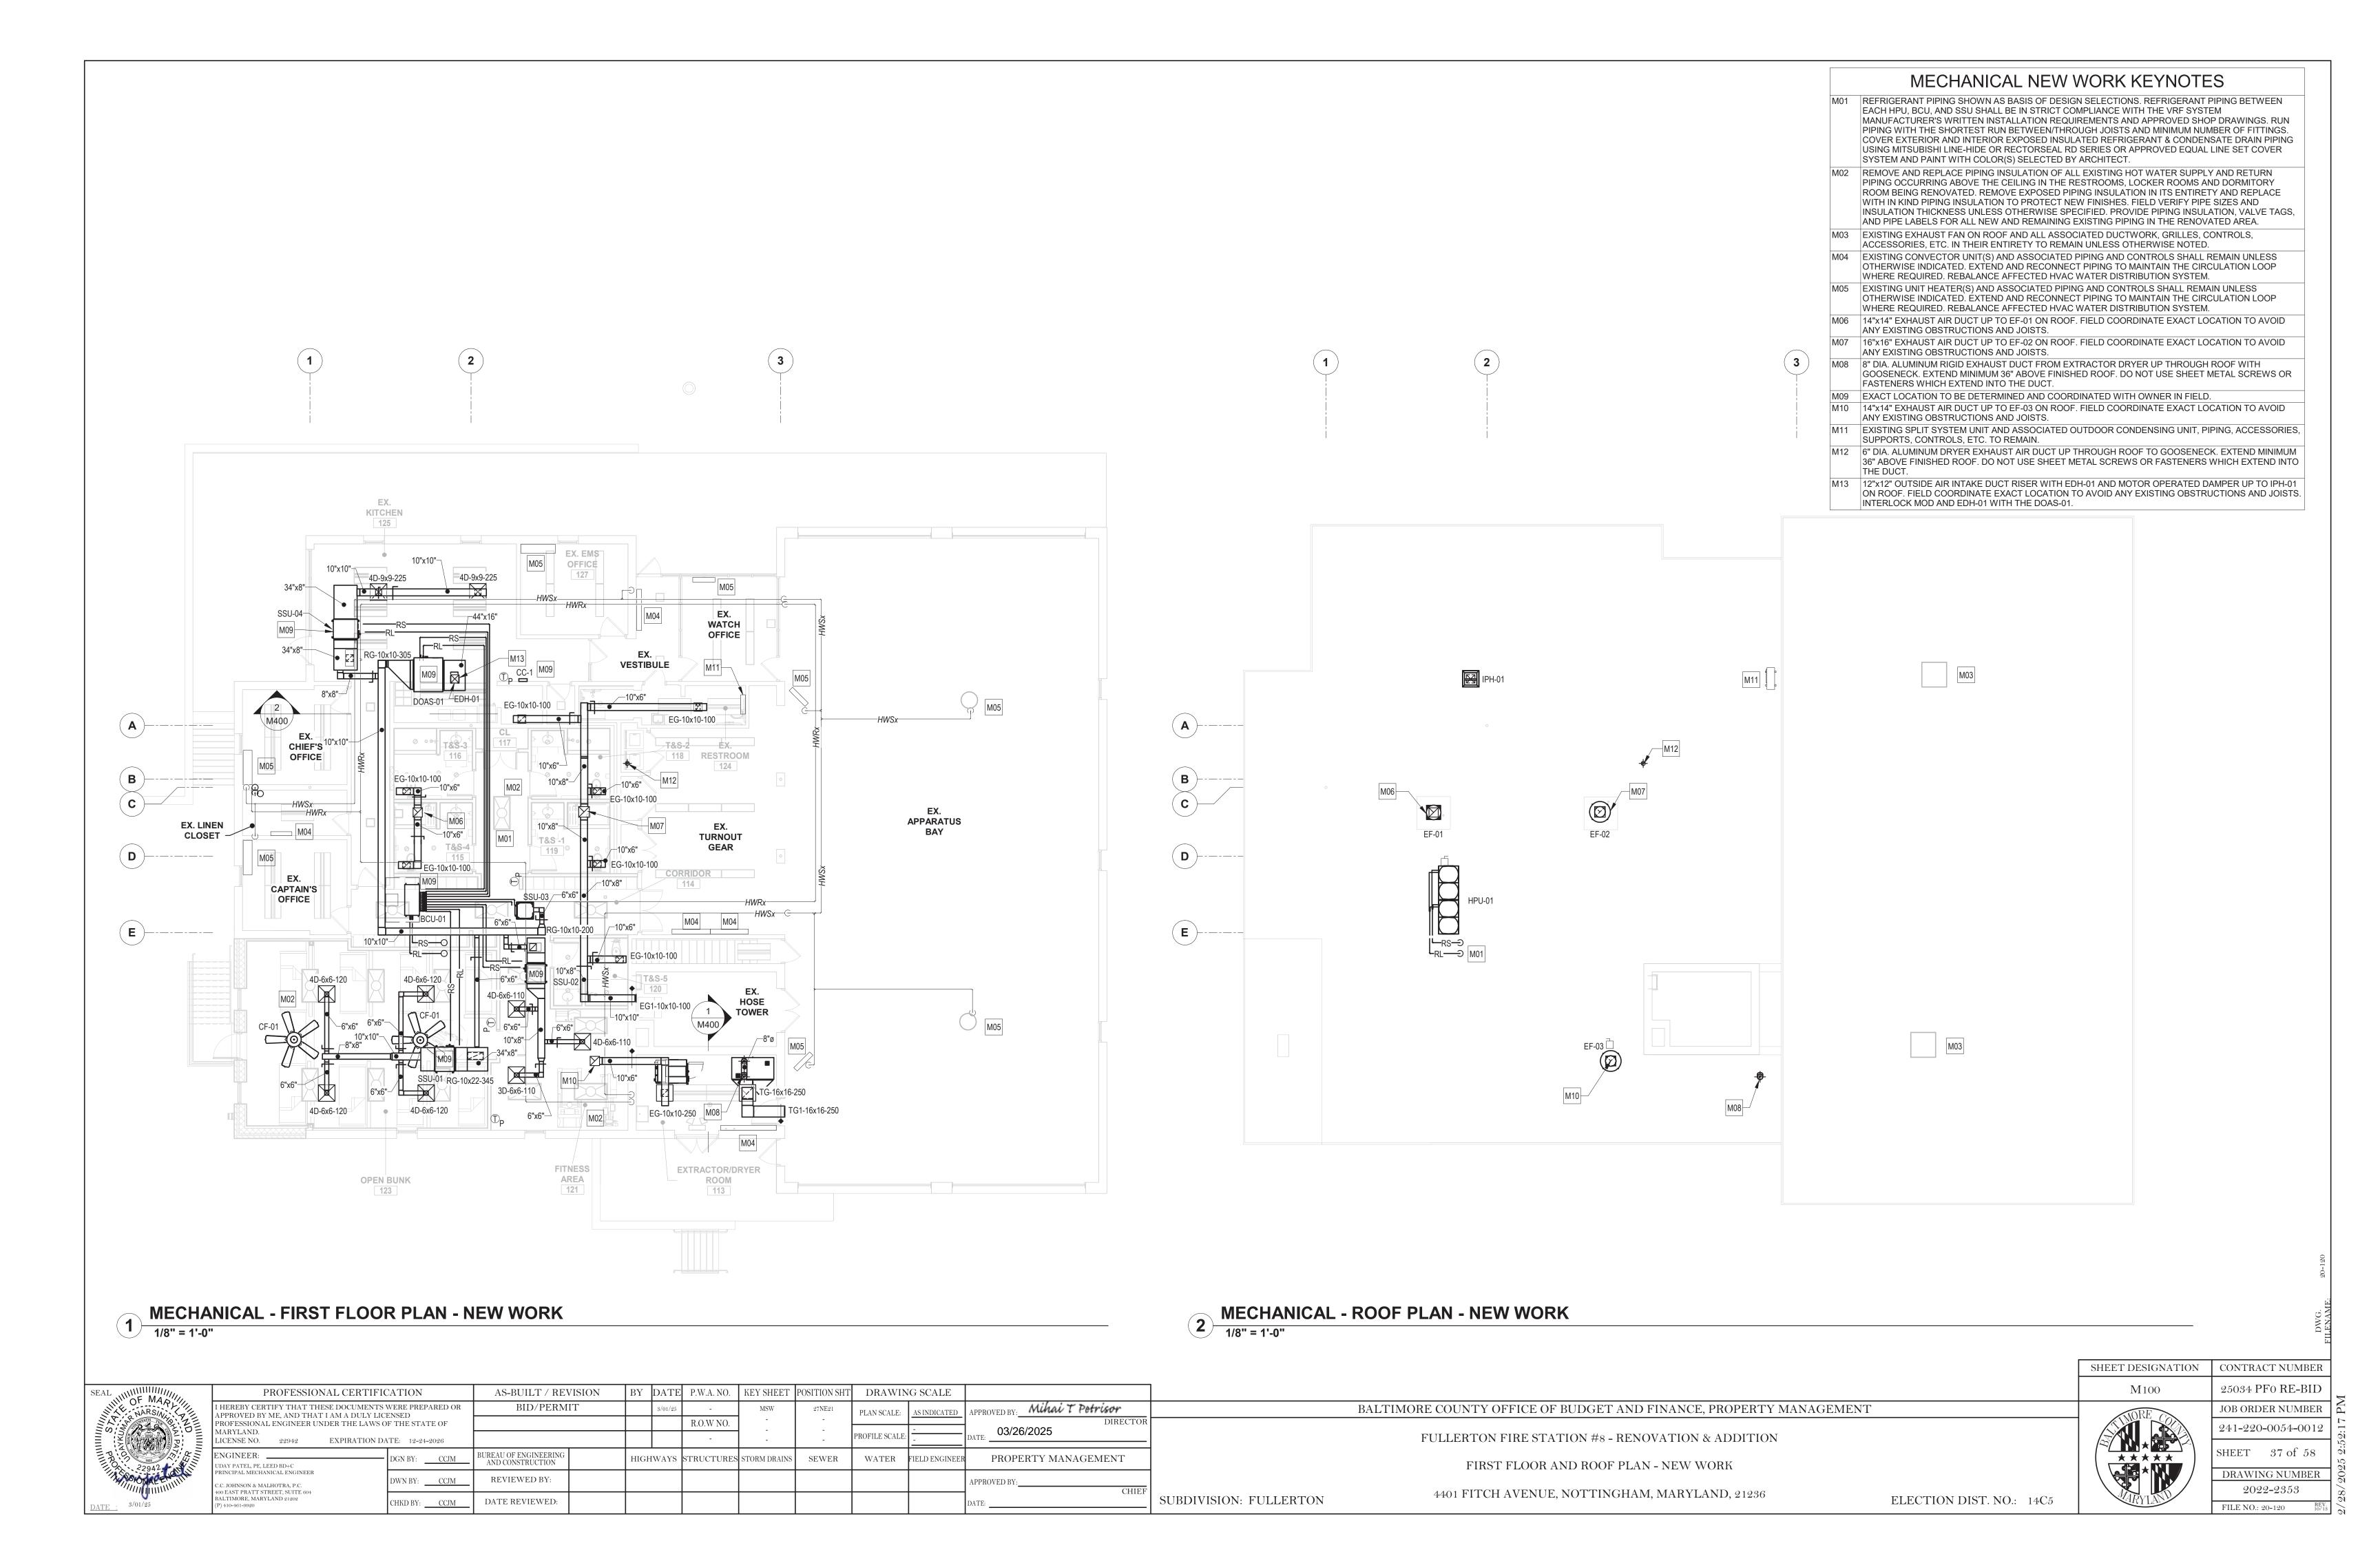1/4" = 1'-0"

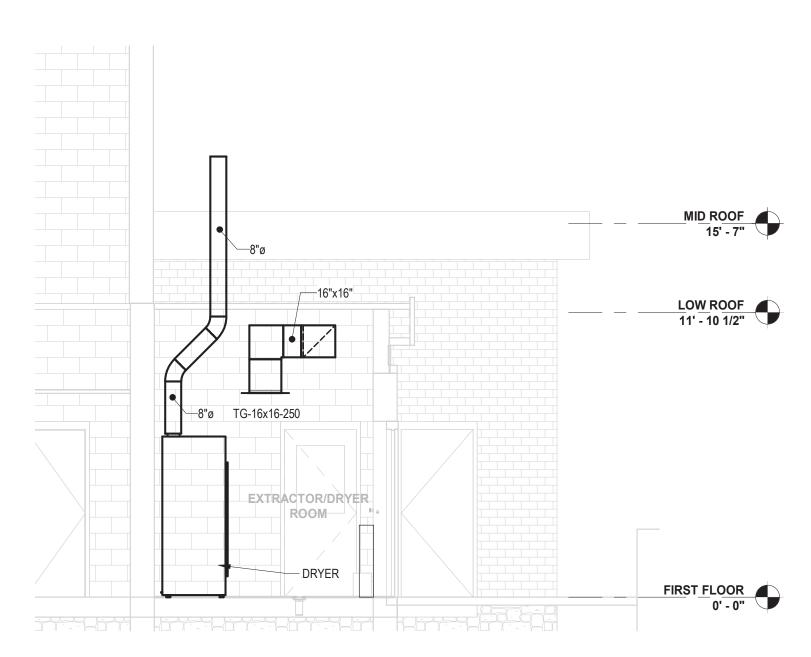

MECHANICAL SECTION - DOAS UNIT

1/4" = 1'-0"

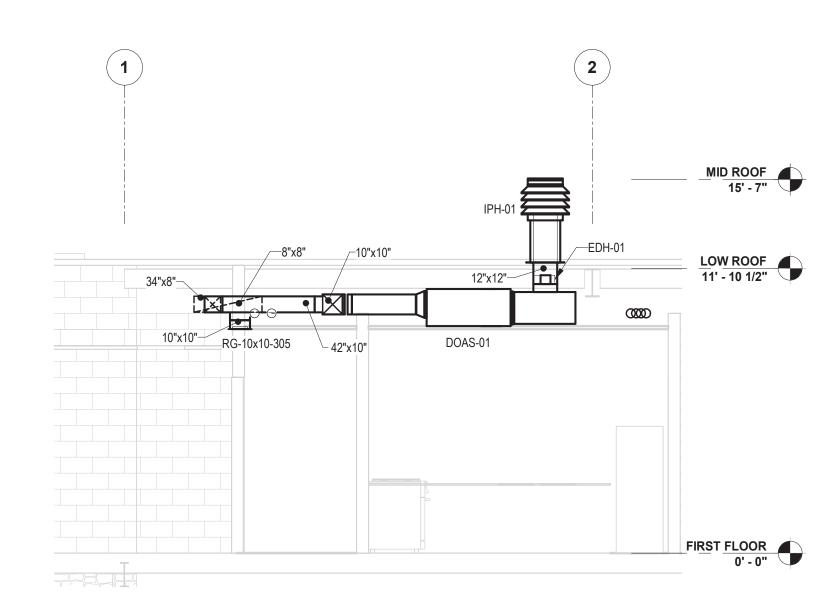SEAL WILLIAM OF MADILL	PROFESSIONAL CERTIFIC	CATION	AS-BUILT / REV	ISION	BY	DATE	P.W.A. NO.	KEY SHEET	POSITION SHT	DRAWIN	IG SCALE			
MARSIN: NARSIN:	I HEREBY CERTIFY THAT THESE DOCUMENTS APPROVED BY ME, AND THAT I AM A DULY LIC		BID/PERM	ΙΤ		3/01/25	-	MSW	27NE21	PLAN SCALE:	NONE	APPROVED BY:_	Mihai Ti	Petrisor
	PROFESSIONAL ENGINEER UNDER THE LAWS ( MARYLAND.						R.O.W NO.		-		-	03/26	6/2025	DIRECTOR
I PA		ATE: 12-24-2026					-	-	-	PROFILE SCALE:	-	DATE:		
	ENGINEER:	DGN BY: CCJM	BUREAU OF ENGINEERING AND CONSTRUCTION		HIGH	WAYS	STRUCTURES	STORM DRAINS	SEWER	WATER	FIELD ENGINEER	PROPE	ERTY MANAC	JEMENT
W SON PENGLIN	PRINCIPAL MECHANICAL ENGINEER  C.C. JOHNSON & MALHOTRA, P.C. 400 EAST PRATT STREET, SUITE 604	DWN BY: CCJM	REVIEWED BY:									APPROVED BY:		CHIEF
DATE 3/01/25	400 EAST FRATT STREET, SUITE 604 BALTIMORE, MARYLAND 21202 (P) 410-461-9920	CHKD BY: CCJM	DATE REVIEWED:									DATE:		CHE

BALTIMORE COUNTY OFFICE OF BUDGET AND FINANCE, PROPERTY MANAGEMENT FULLERTON FIRE STATION #8 - RENOVATION & ADDITION SECTIONS


4401 FITCH AVENUE, NOTTINGHAM, MARYLAND, 21236

ELECTION DIST. NO.: 14C5


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	241-220-008
* * *	SHEET 38
*	DRAWING N
IND	2022-23
. 1112	FILE NO.: 20-120

SHEET DESIGNATION CONTRACT NUMBER RE-BID R NUMBER

SUBDIVISION: FULLERTON

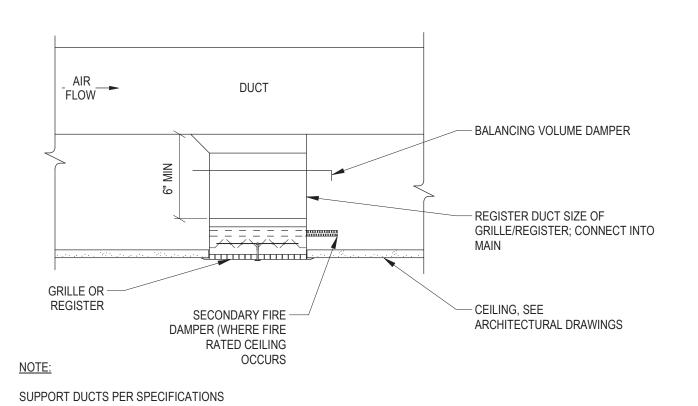


# 1 HVAC DETAIL - GRILLE/REGISTER CONNECTION - TYPICAL NOT TO SCALE

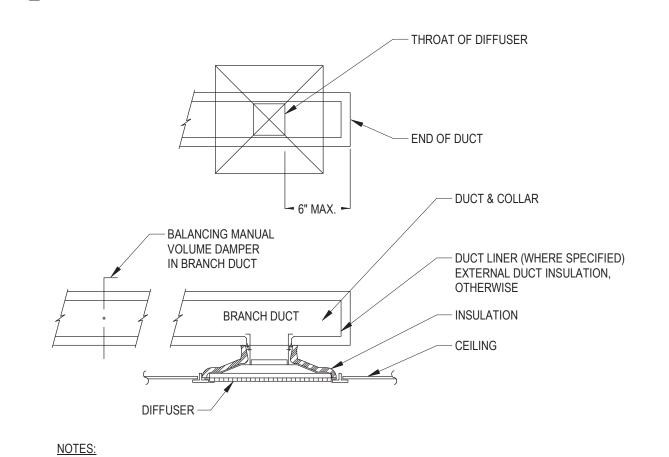


### **CEILING DIFFUSER - TYPICAL**

MANUAL VOLUME DAMPER IN DIFFUSER NECK IS NOT ACCEPTABLE.


FLEXIBLE DUCT IS NOT ACCEPTABLE.

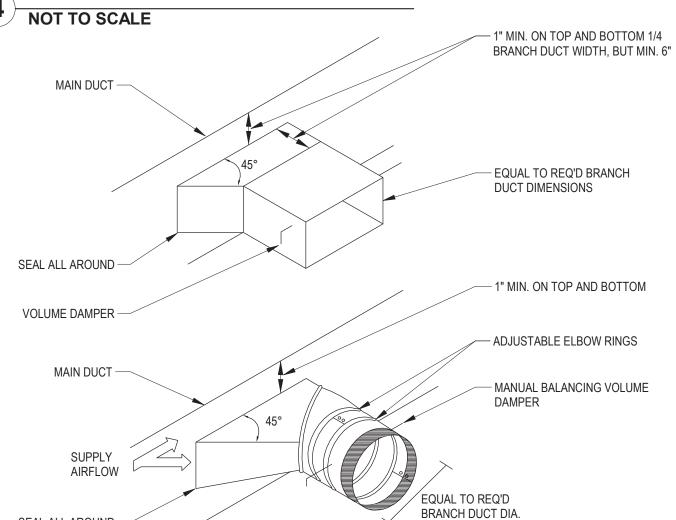

# 5 BRANCH DUCT TAKE-OFF FITTING - TYPICAL NOT TO SCALE

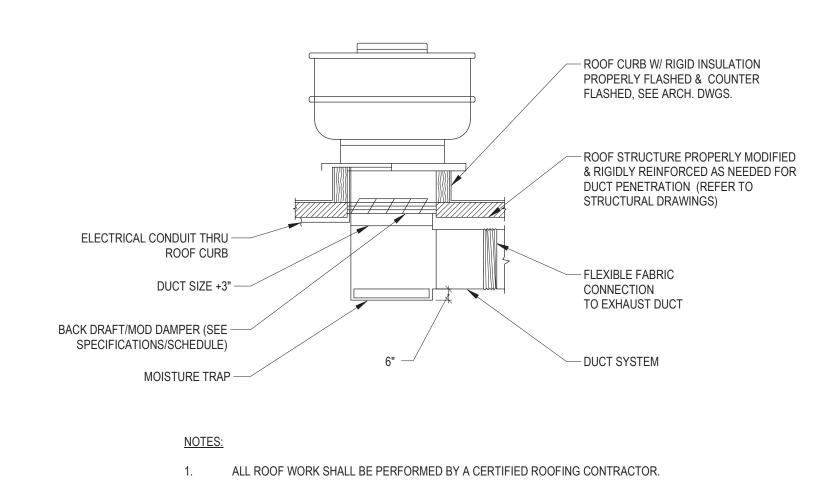

# 2 HVAC DETAIL - ROOF TOP EXHAUST FAN - TYPICAL NOT TO SCALE

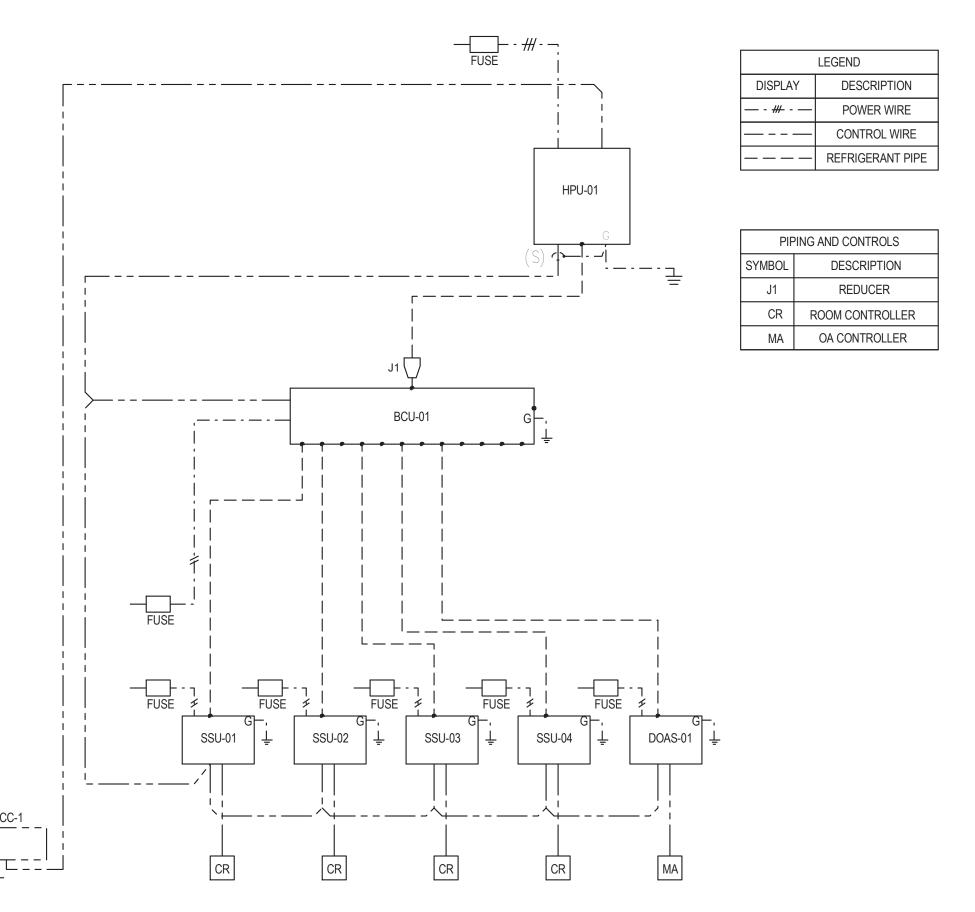

SUBDIVISION: FULLERTON

# 6 NOT TO SCALE

PROFESSIONAL CERTIFICATION AS-BUILT / REVISION BY DATE P.W.A. NO. KEY SHEET POSITION SH DRAWING SCALE HEREBY CERTIFY THAT THESE DOCUMENTS WERE PREPARED OF BID/PERMIT PPROVED BY: Mihai T Petrisor PLAN SCALE: APPROVED BY ME, AND THAT I AM A DULY LICENSED PROFESSIONAL ENGINEER UNDER THE LAWS OF THE STATE OF R.O.W NO. 03/26/2025 MARYLAND. LICENSE NO. 22942 EXPIRATION DATE: 12-24-2026 PROPERTY MANAGEMENT HIGHWAYS STRUCTURES STORM DRAINS SEWER WATER AY PATEL, PE, LEED BD+C REVIEWED BY: EAST PRATT STREET, SUITE 604 LTIMORE, MARYLAND 21202 DATE REVIEWED:

BALTIMORE COUNTY OFFICE OF BUDGET AND FINANCE, PROPERTY MANAGEMENT

FULLERTON FIRE STATION #8 - RENOVATION & ADDITION


DETAILS I

4401 FITCH AVENUE, NOTTINGHAM, MARYLAND, 21236

INSULATED HINGED TOP -AUTOMATIC PERIMETER ATC RELIEF DAMPER (FOR RELIEF ONLY) FILTERS (FOR O.A. INTAKE ONLY) ALL WEATHER SHIELD, OUTSIDE CURB MOUNTING -FLASHING, SEE ARCH. DWGS. LOW-LEAKAGE CONTROL DAMPER — INSULATED ROOF CURB WOOD BLOCKING, SEE ARCH. DWG. -- NO INSULATION FOR RELIEF OR EXHAUST ROOF DECK SEE ARCH. DWG. 2" RIGID INSULATION FOR OUTSIDE DUCT PLENUM AIR INTAKE-TYP. - SAFETY GRATE (FOR OPENINGS GREATER DUCT COLLAR (WHERE OCCURS) THAN 8"x8") GRILLE OR REGISTER (WHERE OCCURS)-TYP. - FLANGE & FASTENER-TYP. - FOLDED SEAM ALUMINUM DRAIN PAN BOTTOM OF DUCT, PROVIDE -- 1" RIGID BOARD INSULATION FOR RELIEF OR WELDED DRAIN NIPPLE AND EXHAUST AIR DUCT AT DRAIN PAN ONLY EXTEND 3/4" DRAIN PIPING TO NEAREST FLOOR DRAIN WITHOUT TRIPPING HAZARD

### RELIEF/OAI PENTHOUSE - TYPICAL

NOT TO SCALE

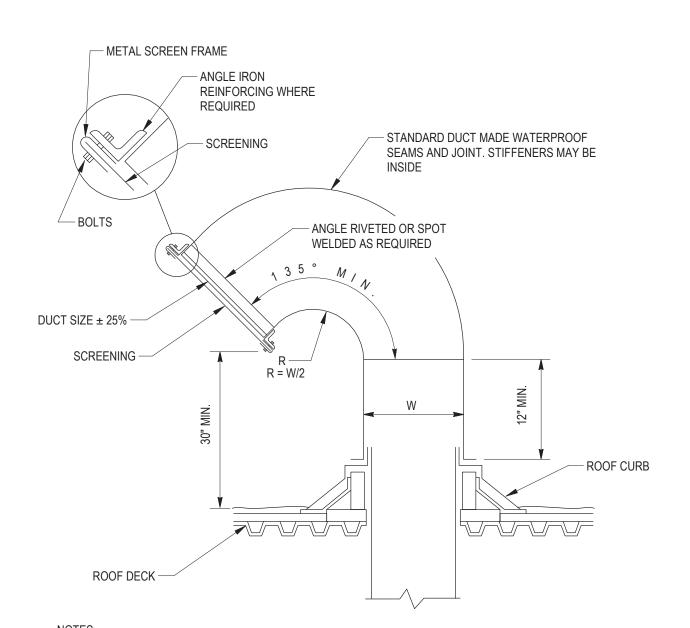


### 1. SEE ARCHITECTURAL DRAWINGS FOR ROOF PENETRATION DETAILS, WHERE OCCURS.

- GOOSENECK SHALL BE MIN. 0.034 INCH THK. ASTM A653, G90 GALVANIZED STEEL OR 0.032 INCH THK, ASTM B209 ALLOY 3003, H14 TEMPER ALUMINUM. FINISH AND COLOR AS SELECTED BY ARCHITECT.
- 3. INSECT SCREENING, INTAKE AIR: ALUMINUM, 18-BY-16 MESH, 0.012-INCH WIRE OR STAINLESS STEEL, 18-BY-18 MESH, 0.009 INCH WIRE.
- INCH WIRE.


  4. BIRD SCREENING, EXHAUST AIR: ALUMINUM, 1/2-INCH SQUARE MESH, 0.063-INCH WIRE OR STAINLESS-STEEL, 1/2-INCH SQUARE MESH, 0.047-INCH WIRE.

### 7 HVAC DETAIL - RECTANGULAR GOOSENECK - TYPICAL

SHEET DESIGNATION	CONTRACT NUMI
M500	25034 PF0 RE-E
NORE C	JOB ORDER NUMI
	241-220-0054-0
	SHEET 39 of 8
\ \ <b>&amp;#&lt;/b&gt;\$*\\\\&lt;/th&gt;&lt;th&gt;DRAWING NUME&lt;/th&gt;&lt;/tr&gt;&lt;tr&gt;&lt;td&gt;ARYLAND&lt;/td&gt;&lt;td&gt;2022-2355&lt;/td&gt;&lt;/tr&gt;&lt;tr&gt;&lt;td&gt;V11111&lt;/td&gt;&lt;td&gt;EILE NO. 20, 120&lt;/td&gt;&lt;/tr&gt;&lt;/tbody&gt;&lt;/table&gt;</b>	

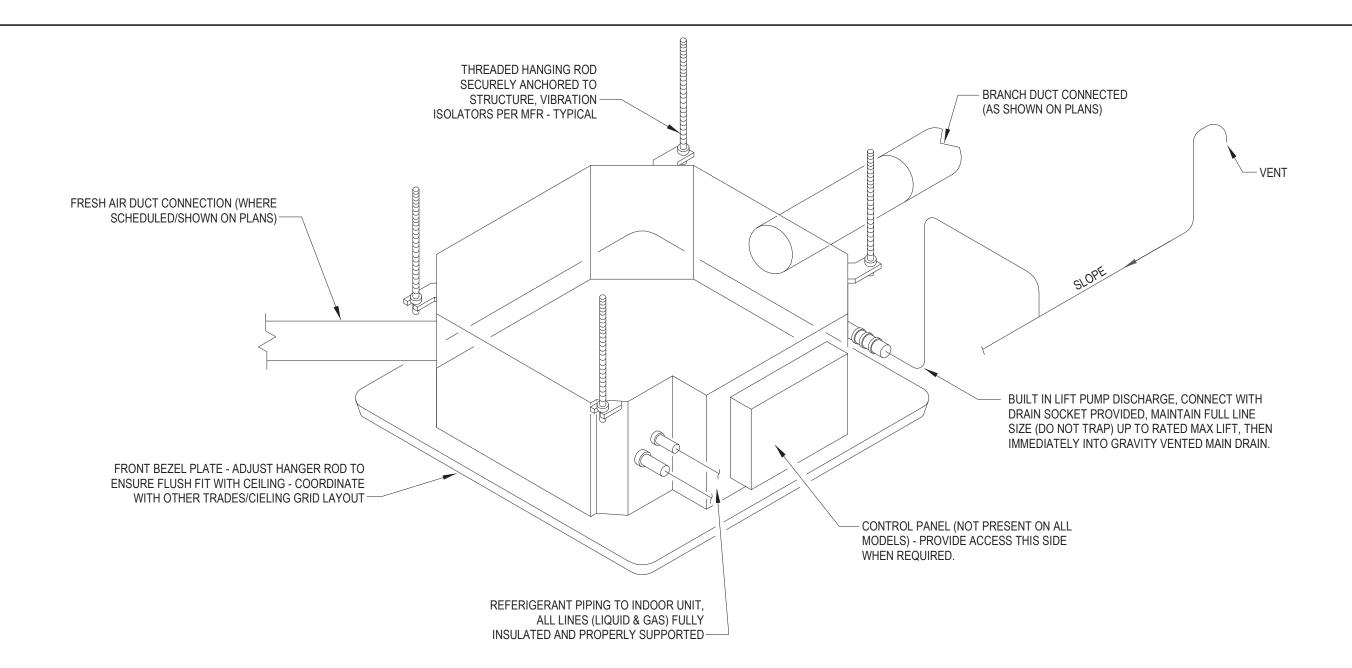


### **VRF CASSETTE INDOOR UNIT DETAIL - TYPICAL**

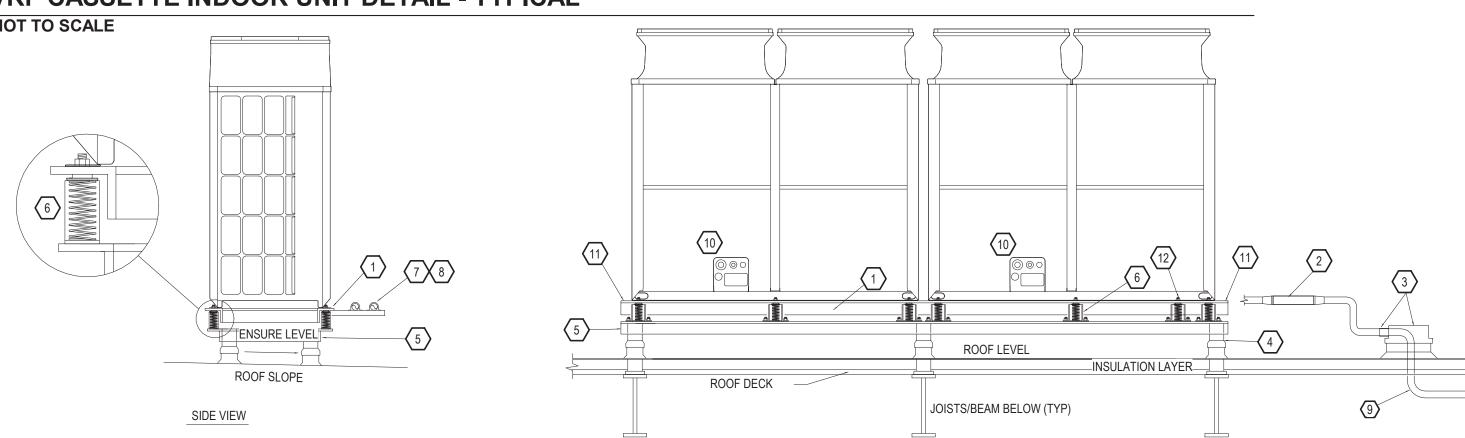


### # CODED NOTES:

- PROVIDE STRUCTURAL INTERSTITIAL ANGLE IRON MOUNTING MEMBER OR SIMILAR ATTACHED DIRECTLY TO BOTTOM OF UNIT MOUNTING FLANGE AND PROVIDE CROSS BRACING FOR RIGIDITY. ENSURE IT CARRIES FULL MOUNTING FOOT WIDTH ON UNIT. FINAL SPECIFICATION OF MEMBER BY DELEGATED DESIGN STRUCTURAL ENGINEER.
- PROVIDE BRAIDED COPPER FLEXIBLE CONNECTOR, R410A RATED, 650PSI MAX WORKING PRESSURE, PACKLESS INDUSTRIES OR EQUAL ON ALL MAIN PIPING DOWNSTREAM OF TWINNING KITS/CONVERGING FITTINGS PRIOR TO PENETRATION THROUGH ROOF.
- PIPE PORTAL SYSTEM WITH ROOF CURB, FLASHED AND SEALED WATER TIGHT, PROVIDE FLEXIBLE WATER TIGHT COLLAR TO ALLOW FOR MOVEMENT WHERE PIPE ENTERS CURB. DO NOT ENTER PIPE CURB FROM VERTICAL DIRECTION. SEE DETAIL 2/M501.
- TYPICAL BASE SUPPORT POSTS, SECURELY ANCHORED TO BUILDING STRUCTURE BELOW, QUANTITY, SIZE, AND CARRYING CAPACITY DETERMINED BY DELEGATED DESIGN STRUCTURAL ENGINEER.
- STRUCTURAL ANGLE IRON BASE MOUNTING FRAME WITH CROSS MEMBERS FOR RIGIDITY FINAL SIZING BY DELEGATED DESIGN STRUCTURAL ENGINEER.
- VIBRATION SPRING SLR TYPE ISOLATORS (MASON INDUSTRIES OR EQUIV.) WITH RUBBER BASE PADS, SECURELY FASTENED TO STRUCTURAL BASE AND TO VRF UNIT INTERSTITIAL SUPPORT STEEL. SPRING ISOLATOR TO PROVIDE MINIMUM 1" DEFLECTION OR 10 TIMES THE STATIC DEFLECTION OF THE ROOF DECK FROM EQUIPMENT WEIGHT - DETERMINED BY STRUCTURAL ENGINEER OF RECORD. AT A MINIMUM, PROVIDE SPRING ISOLATORS AT EACH EQUIPMENT BASE MOUNTING HOLE LOCATION.
- 7. IF REQUIRED, ONLY SUPPORT LATERAL PIPE EMANATING FROM VRF UNIT CONNECTIONS BY CROSS MEMBER SUPPORT THAT IS ATTACHED DIRECTLY TO VRF UNIT MOUNTING ANGLE IRON FRAME ABOVE SPRING ISOLATORS. DO NOT ATTACH ANY PIPING TO LOWER FIXED SUPPORT BASE.
- 8. USE NEOPRENE ISOLATION COLLARS ON PIPE CLAMS WHEN FASTENING PIPING TO SUPPORTS.
- USE LONG RADIUS SWEEPING COPPER ACR TUBE PIPE BENDS WHERE PIPE ENTERS BUILDING AT FIRST ELBOW INTO CEILING SPACE TO MINIMIZE REFRIGERANT FLOW NOISE AND VIBRATION.
- 10. ALL ELECTRICAL CONNECTIONS TO UNITS TO BE VIA FLEXIBLE CONDUIT, PROVIDE SUFFICIENT SLACK TO ALLOW FOR UNIT MOVEMENT ON SPRING ISOLATORS.
- ENSURE CROSS MEMBERS OF INTERSTITIAL FRAME AND BOTTOM SUPPORT FRAME ARE NOT DIRECTLY BELOW ENDS OF MODULES IN ALL LOCATIONS AND DO NOT BLOCK DRAINAGE WEEP HOLES IN BOTTOM OF UNIT CASING, FAILURE TO DO THIS MAY RESULT IN ICE DAMMING/BUILDUP BENEATH UNIT AND SUBSEQUENT BUILDUP OF ICE IN BOTTOM OF UNIT CASING BELOW COIL AND POTENTIAL DAMAGE TO BOTTOM OF COIL.
- 12. WHEN SELECTING SPRING ISOLATORS ALWAYS CONSIDER WEIGHT DISTRIBUTION BY REFERENCING EQUIPMENT WEIGHT AND CENTER OF GRAVITY. NEAR RIGHT ENDS OF UNITS (VIEWED FROM FRONT PANEL) SPRING WEIGHT CAPACITY MAY BE LARGER. IF HIGHER SPRING WEIGHT CAPACITY IS REQUIRED VS OTHER SPRING LOCATIONS, CONSIDER AN ADDITIONAL SPRING OF EQUAL "K" VALUE (LBS/IN) NEAR RIGHT END OF LAST MODULE. IN GENERAL, SELECT ALL MOUNTING SPRINGS OF EQUIVALENT "K" VALUE (LBS/IN).


FRONT VIEW

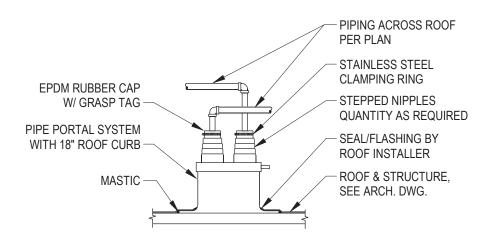

### **PIPE PORTAL - TYPICAL**

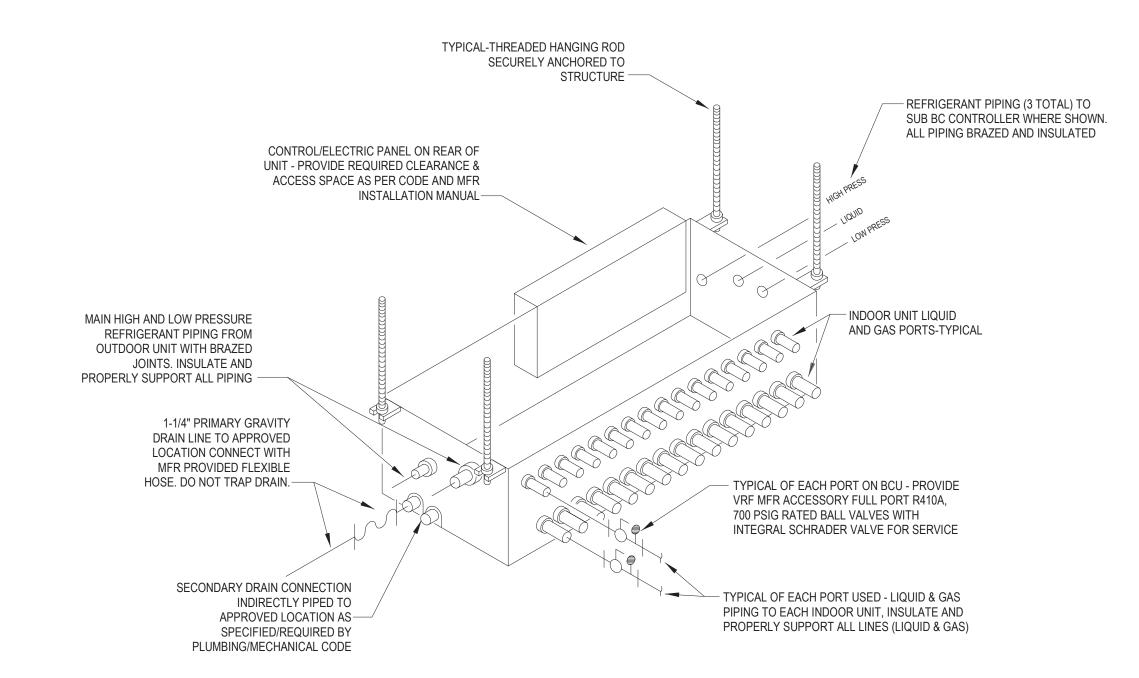

### VRF HEAT RECOVERY BRANCH CIRCUIT CONTROLLER UNIT (BCU) DETAIL - TYPICAL NOT TO SCALE

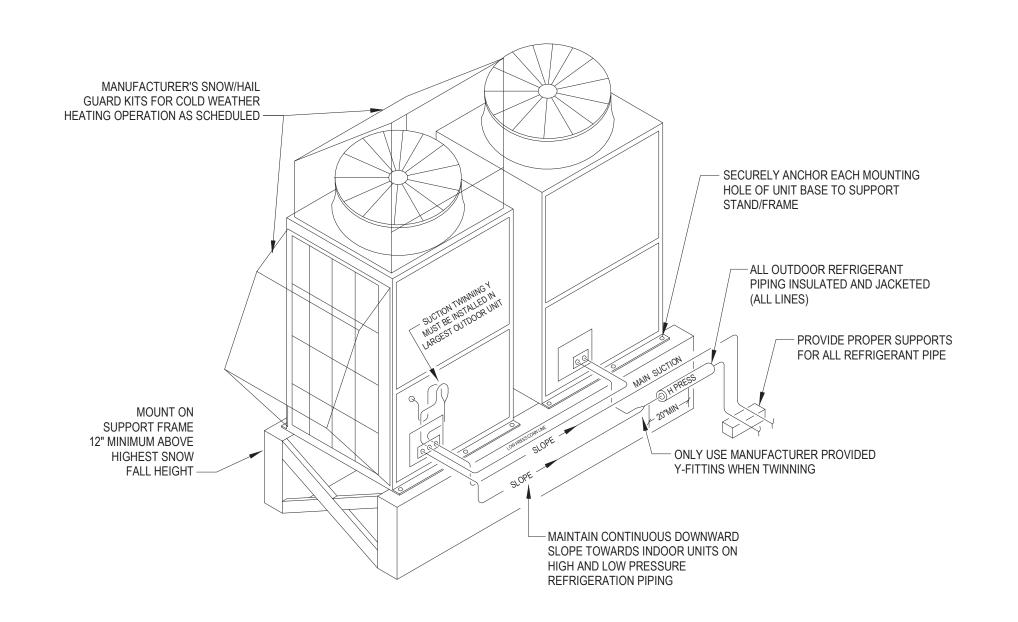

### VRF OUTDOOR HEAT RECOVERY HEAT PUMP UNIT (HPU) DETAIL - TYPICAL

BALTIMORE COUNTY OFFICE OF BUDGET AND FINANCE, PROPERTY MANAGEMENT FULLERTON FIRE STATION #8 - RENOVATION & ADDITION DETAILS II

4401 FITCH AVENUE, NOTTINGHAM, MARYLAND, 21236

M501

SHEET DESIGNATION | CONTRACT NUMBER 25034 PF0 RE-BID JOB ORDER NUMBER 241-220-0054-0012

SHEET 40 of 58 DRAWING NUMBER 2022**-**2356 FILE NO.: 20-120

### VRF OUTDOOR EQUIPMENT SUPPORT DETAIL

SEAL WINNING MARKET	PROFESSIONAL CERTIFI	CATION	AS-BUILT / REVI	SION B	BY DATE	P.W.A. NO.	KEY SHEET	POSITION SHT	DRAWIN	G SCALE		
NARSIN	I HEREBY CERTIFY THAT THESE DOCUMENTS APPROVED BY ME, AND THAT I AM A DULY LIG		BID/PERMIT	Γ	3/01/25	-	MSW	27NE21	PLAN SCALE:	NONE	APPROVED BY: Mihai T Petrisor	
SO STATE OF THE ST	PROFESSIONAL ENGINEER UNDER THE LAWS (MARYLAND.					R.O.W NO.	- - -	- - -	PROFILE SCALE:	-	DIRECTOR DIRECTOR	R
Pacca and a second seco	ENGINEER:  UDAY PATEL, PE, LEED BD+C	DGN BY: CCJM	BUREAU OF ENGINEERING AND CONSTRUCTION	H	HIGHWAYS	STRUCTURES	STORM DRAINS	SEWER	WATER	FIELD ENGINEER	PROPERTY MANAGEMENT	1
ALE SOON ALE WILLIAM	PRINCIPAL MECHANICAL ENGINEER  C.C. JOHNSON & MALHOTRA, P.C.	DWN BY: CCJM	REVIEWED BY:								APPROVED BY: CHIEJ	<u>-</u>
DATE : 3/01/25	400 EAST PRATT STREET, SUITE 604 BALTIMORE, MARYLAND 21202 (P) 410-461-9920	CHKD BY: CCJM	DATE REVIEWED:								DATE:	

SUBDIVISION: FULLERTON

VRF SPLIT SYSTEM INDOOR UNIT ACCESSORIES:	REFER TO SPECIFICATIONS FOR ADDITIONAL VRF SPLIT SYSTEM INDOOR
---	--

TAG

SSU-01

SSU-02

SSU-03

SSU-04

DOAS-01

CC-1

1. 3D I-SEE SENSOR WITH MOUNT/PANEL (PAC-SH91MK-E OR PAC-SA1ME OR PAC-SF1ME-E AS APPLICABLE).

PROVIDE AC-SC51KUA POWER SUPPLY UNIT, MINIMUM OF TWO PAC-YG63MCA AI CONTROLLERS & FOUR PAC-YG66DCA DIDO CONTROLLERS IN NEMA 1 ENCLOSED CONTROL PANEL ABOVE CEILING: PAC-YG10HA-ER EXTERNAL INPUT/OUTPUT ADAPTER AND PAC-YG84UTB MOUNTING BRACKET & PAC-YG86TK-J KIT FOR BUILDING CONTROLS. PROVIDE DDC CONTROLLERS AND BMS EQUIPMENT IN MECHANICAL ROOM (008). 1. 1"-MERV 8 PLEATED FILTER KIT (PAC-SH89KF-E) 5. 1"-MERV 8 PLEATED FILTER KIT (PAC-SH90KF-E) COORDINATE CONTROLS INTERFACE WORK WITH OWNER, PROVIDE A POWER OUTLET AND A DATA OUTLET NEAR EACH CONTROLLER AND CONNECT TO LAN PORT. PROVIDE SW-BACNET AND SW-PWEB SOFTWARE AND ASSOCIATED LICENSE AGREEMENT. COORDINATE WITH OWNER TO INTEGRATE THESE SOFTWARE ON OWNER'S CENTRAL BMS OPERATOR WORKSTATION. 6. 1"-MERV 10 PLEATED FILTER KIT (PAC-SH59KF-E) 10. 48X48 CEILING INSTALLATION/TRIM PANELS (PMFY-ITP1 / PLFY-ITP1 / PLFY-ITP2).

. DELUXE WIRED MA REMOTE CONTROLLER (PAR-40MAAU). THREE POLE DISCONNECT SWITCH (TAZ-MS303). FILTER BOX WITH REAR OR BOTTOM RETURN AIR INLETS AS REQUIRED TO SUIT INSTALLATION AND WITH 2" MERV-13 PLEATED FILTERS IN 7. BUILT-IN CONDENSATE LIFT MECHANISM. DRAIN PAN LEVEL SENSOR. INTEGRAL CONDENSATE PUMP KIT (PAC-SH84DM-E) OR DRAIN WATER LIFT-UP KIT (X87-721). DRAIN PAN LEVEL SENSOR. ANGLED CONFIGURATION (FBM OR FBH SERIES) FILTER BOX INSULATED PLENUM WITH 2" MERV-13 PLEATED FILTERS IN VERTICAL CONFIGURATION (FBHO2-3), MA REMOTE CONTROLLER (PAR-30MAOA), CN24 RELAY KIT( CN24RELAY-KIT-CM3), THREE POLE DISCONNECT SWITCH (TAZ-MS303).

8. M-NET ADAPTER (PAC-SF81MA)

						VARIAI	BLE REFF	RIGERA	NT F	LOW (\	/RF) S	PLIT S	SYSTI	EM OL	JTDOOR	UNIT SC	HEDUL	.E							
		MANUEAGTURER	RATED COOLING	RATED HEATING	DESIGN COOLING	DESIGN HEATING		ALIDI					FΔ	.NS	SOUND dBA	SIZE LxWxH	APPROX.	DETAIL				ELI	ECTRICAL (6	60 HZ)	
TAG	DESCRIPTION	MANUFACTURER (MITSUBISHI) MODEL	CAPACITY	CAPACITY	CAPACITY	CAPACITY	REFRIGERANT	AHRI IEER/COP	SCHE	DB/WB	DB/WB	NO. OF CKTS.	17		OCCIVE GENT	OIZE EXVXIII	WEIGHT	DE I7 (IE	ACCESSORIES	REMARKS	MCA	MOCP	VOLTS/	EMER.	DISC.
			MBH	MBH	MBH	MBH				°F	°F		NO.	HP (EA)	@ 5 FEET	INCHES	LBS	#/DWG#			(M1/M2)	/ ((((1/1/1/12)	PHASE	POWER	R SWITCH
HPU-01	AIR COOLED OUTDOOR VRF HEAT PUMP WITH HEAT RECOVERY SYSTEM	PURY-EP168TNU-A	168	188	168.6	127.2	R-410A	25.7 / 3.55	24.7	95 / 75	10 / 8	1	2	-	65	70X30X72	800	6/M500, 3/M501, 5/M501	1, 5	FOR SSU-01 TO SSU-04 AND DOAS-01	57 / 53	90 / 80	208 / 3	NO	EC
BCU-01	HEAT RECOVERY CONTROL UNITS - MAIN BRANCH CONTROLLER	CMB-P1012NU-JA1	N/A	N/A	N/A	N/A	R-410A	N/A	N/A	N/A	N/A	N/A	N/A	N/A	N/A	44x21x10	200	6/M500, 4/M501	4	CONNECT TO HPU-01, MAX. 16 BRANCHES	1.57	15	208 / 1	NO	EC
VRF SPLIT SY	YSTEM OUTDOOR UNIT ACCESSORIE	<u> </u>			RATED HEATING	CAPACITIES AR	RE BASED ON INDC	OR COIL EAT	OF 70/60 °	°F (DB/WB), O	UTDOOR OF	43 °F (WB)	)			RATED COOL	ING CAPACITI	ES ARE BASED (	ON INDOOR COIL E	EAT OF 80/67 °F (DB/WB), OUTDOOR OF 95/	75 °F (DB/W	/B).			

VRF SPLIT SY	YSTEM OUTDOOR UNIT ACCESSORIES:	RATED HEATING CAPACITIES ARE BASED ON INDOOR COIL EAT OF 70/60 °F (DB/WB), OUTDO	OR OF 43 °F (WB)	RATED COOLING CAPACITIES ARE BASED ON INDOOR COIL E	AT OF 80/67 °F (DB/WB), OUTDOOR OF 95/75 °F (DB/WB).
PORT ADAPTORS, DRAIN SOCKET, AIRFLOW GUIDE. CMY-R100XLCBK TWINNING KIT FOR MULTIPLE MODULES. PAC-SPRFCS-118/138/158RCW REFRIGERANT FILTER / CLEANING SYSTEM. SGN SERIES SIDE, FRONT AND REAR SNOW/HAIL GUARDS AND SHK SNOW HOOD FOR SNOW/HAIL PROTECTION. PAC-PH03EHYU-E1 20W, 208 V / 1 PH PANEL HEATERS.			4 INCLUDE JOINT ADAPTORS; BRANCH JOINT; X87-721 [MBC] / SI30 PRESSURE, FULL PORT, 410A RATED BALL VALVES.	0-230 [SBC] CONDENSATE PUMP; DIAMONDBACK BV-SERIES, 700 PSIG WORKING	
2.	CMY-Y102LS-G2 T-BRANCH JOINT (73-144 MBH), CMY-Y108C-G HEADER FOR 8 BRANCHES, LOW AMBIENT KIT.		5 MINIMUM 24" HIGH EQUIPMENT SUPPORT RAILS OR BIG FOOT R APPROVED EQUAL BY INSTALLER.	ROOF MOUNTED SUPPORT SYSTEM BY THE RECTORSEAL CORPORATION OR	
3.	LOW AMBIENT HOOD KIT WITH ASSOCIATED WIND BAFFLES (WB-PA2) FOR 100% LOW AMBIENT COOLING DOWN TO MINUS	10 °F, AIR OUTLET GUIDE (PAC-SG59SG).	6 FRONT AND SIDE ADVANCED WIND BAFFLES (WB-PA4 & WB-SD4	FOR 100% LOW AMBIENT COOLING DOWN TO MINUS 20 °F TO 115 °F.	

					Al	RH	ANDL	ING EQL	JIPMENT	/ POWER	R VENT	LATOF	RS SC	HEDULE									
					CAPACI	TY		ROOF/WALL	MECHANICAL	FAN	SIZE	APPROX.	DETAIL					FAN DATA	1		ELECTRICA	L (60 HZ)	
TAG	AREA SERVED	DESCRIPTION	MANUFACTURER - MODEL	DRIVE	AIRFLOW	ESP	SOUND NC	OPENING	EFFICIENCY	EFFICIENCY GRADE	LxWxH OR DIA. x H	WEIGHT	DETAIL	ACCESSORIES	CONTROLS	REMARKS	FAN SPEED	MOTOR SPEED	FAN MOTOR	FAN MOTOR	VOLTS/	EMER.	DISC.
				51.112	CFM	IWG	dBA	INCHES	%		INCHES	LBS	#/SHT#				RPM	RPM	BHP	HP/WATTS	PHASE	POWER	SWITCH
EF-01	T&S-3, T&S-4	ROOF MOUNTED UPBLAST CENTRIFUGAL FAN	LOREN COOK - ACRUD - VF - 100R17DL (VF)	DIRECT	200	0.50	55	14 x 14	32	-	22 x 17	90	2/M500	1,3,4,5	DDC TIME SCHEDULE W/ AUTO-ON-OFF SWITCH	-	1360	1725	0.05	0.25 / -	208 / 1	NO	MFR
EF-02	T&S-1, T&S-2, T&S-5, EX. WOMEN'S LOCKER ROOM,	ROOF MOUNTED UPBLAST CENTRIFUGAL FAN	LOREN COOK - ACRUD - VF - 120R28D OR91VF	DIRECT	600	0.75	63	16 x 16	39	-	31 x 29	125	2/M500	1,3,4,5	DDC TIME SCHEDULE W/ AUTO-ON-OFF SWITCH	-	1395	2800	0.18	0.75 / -	208 / 1	NO	MFR
EF-03	EXTRACTOR/DRYER ROOM	ROOF MOUNTED UPBLAST CENTRIFUGAL FAN	LOREN COOK - ACRUD - VF - 120R17D OR81VF	DIRECT	250	0.5	57	16 x 16	28	-	31 x 29	120	2/M500	1,3,4,5	DDC TIME SCHEDULE W/ AUTO-ON-OFF SWITCH	-	1125	1725	0.07	0.33 / -	120 / 1	NO	MFR
CF	DORMITORY	CEILING FAN	HUNTER - DEMPSEY 59247	DIRECT	-	-	-	-	-	-	52	-	-	10	ON/OFF WALL SWITCH WITH SPEED CONTROL	LOW PROFILE, BLACK OAK BLADES AND BRUSHED NICKEL FINISH	-	-	-	-	120 / 1	NO	EC
AHE SCHEDULE	NOTES: [APPLY TO ALL NEW FANS]					•	•	AHE SCHEDUL	E OPTIONS/ACCE	SSORIES: (AS SC	HEDULED)		•					•	•		•		
1. INSTALL FIXED SHE	AVES AFTER FINAL BALANCING FOR EACH B	BELT DRIVEN FAN.							AND WIRED FAN SPEED ARI-FLOW ELECTRONIC				WITH VFRSC REI	MOTE SPEED CONTROLL	ER AND UL VFABK AIR BALANCE	8. INTEGRAL ALUMINUM GRAVITY BACKDRAFT ISOLATORS SET, MODEL RC-75 (4), CEILING MC FILTER.	DAMPER, AN DUNTED PASS	NODIZED ALUMI SIVE INFRARED	NUM CEILING ( ) MOTION SENS	GRILLE, MINIMUM SOR, GRILLE MOUI	1" DEFLECTION NTED WASHAB	RUBBER-IN-SI LE ALUMINUM	IEAR MESH UNIT
2. SOUND PERFORMA	NCE DOES NOT INCLUDE ADJUSTMENTS FO	R SOUND CURB.						2. WALL MOUNTED	AND WIRED SOLID STA	TE FAN SPEED CONTR	ROLLER FURNISHEI	BY FAN MFR AN	ID INSTALLED B	Y HVAC CONTRACTOR.		9. LIFE SAFETY BELTS, UL APPROVED & LISTEI	D FOR SMOK	(E CONTROL AF	PPLICATION.				
3. BELT DRIVE FAN IN BELT-TENSIONR-ROTA	CLUDES MEDIUM DRIVE LOSS (15-20%). PRO' ARY™ ACCESSORY.	VIDE REINFORCED WHEEL, STAINLESS	STEEL HARDWARE & SHAFT, EXTENDED LUBE LINES, S	PARE BELT SE	T AND LOREN CO	OK'S		3. 24" HIGH ALUMIN LOCKING HASP-TO		LUMINUM ROOF CAP	, STAINLESS STEEL	HARDWARE, HIN	IGED SUB-BASE	E, ALUMINUM BIRD SCREE	N, TIE-DOWN EYELETS,	10. PROVIDE (4) SPEED, WITH ON/OFF, CONTR	OL WALL SW	/ITCH. COORDIN	NATE MOUNTIN	G LOCATIONS WIT	ΓΗ ELECTRICAL	DRAWINGS.	
4. 1725-1750 RPM, TEF	C MOTORS WITH THERMAL OVERLOAD PRO	TECTION UNLESS OTHERWISE NOTED.						4. CLASS 1A LOW L	EAKAGE, DDC, ALUMINU	JM MOTOR OPERATE	D DAMPER IN ROOI	CURB WITH DAI	MPER TRAY.										
5. USE ADDITIONAL SI	ET OF CONTACTS IN OCCUPANCY SENSOR P	ROVIDED UNDER DIVISION 26.						5. NEMA 1 (INDOOR	R FAN) / NEMA 3R (OUTD	OOR FAN) DISCONNE	CT SWITCH PRE-WI	RED WITH FLEXII	BLE CONDUIT BY	Y FAN MFR.									
6. LOOSE ACCESSORI	ES SHALL BE FIELD INSTALLED BY INSTALLE	6. NEMA 4 DISCONNECT PRE-WIRED WITH FLEXIBLE CONDUIT, ANODIZED ALUMINUM CEILING GRILLE, INTEGRAL ALUMINUM GRAVITY BACKDRAFT DAMPER, MINII DEFLECTION RUBBER-IN-SHEAR ISOLATORS SET MODEL RC-75 (4), 62.2 FAN/LIGHT CONTROL, INSULATED HOUSING										KDRAFT DAMPER, MINIMUM 1"											
	7. INTEGRAL ALUMINUM GRAVITY BACKDRAFT DAMPER, MINIMUM 1" DEFLECTION RUBBER-IN-SHEAR ISOLATORS SET, FILTER BOX WITH CARBON FILTERS, MODEL RC-75 (4).											RBON FILTERS, MODEL RC-75											

SUBDIVISION: FULLERTON

MIIIIIIIIIIIIIIIIIIIIIIIIIIIIIIIIIIIII	PROFESSIONAL CERTIFIC	CATION	AS-BUILT / REV	ISION	BY	DATE	P.W.A. NO.	KEY SHEET	POSITION SHT	DRAWIN	IG SCALE	
	I HEREBY CERTIFY THAT THESE DOCUMENTS APPROVED BY ME, AND THAT I AM A DULY LIC		BID/PERMI	Т		3/01/25	-	MSW	27NE21	PLAN SCALE:	NONE	APPROVED BY: Mihai T Petrisor
E PLOS	PROFESSIONAL ENGINEER UNDER THE LAWS C MARYLAND.	F THE STATE OF					R.O.W NO.	-	-	PROFILE SCALE:	-	DIRECTOR DATE:
$P_{i} = 1$		ATE: 12-24-2026	DUDE ALLOE ENGINEEDING				-	-	-		-	
1632	ENGINEER:UDAY PATEL, PE, LEED BD+C	DGN BY: CCJM	BUREAU OF ENGINEERING AND CONSTRUCTION		HIGH	WAYS	STRUCTURES	STORM DRAINS	SEWER	WATER	FIELD ENGINEER	PROPERTY MANAGEMENT
MAPENIII	PRINCIPAL MECHANICAL ENGINEER C.C. JOHNSON & MALHOTRA, P.C.	DWN BY: CCJM	REVIEWED BY:									APPROVED BY:
. /	400 EAST PRATT STREET, SUITE 604 BALTIMORE, MARYLAND 21202 (P) 410-461-9920	CHKD BY: CCJM	DATE REVIEWED:									DATE:

BALTIMORE COUNTY OFFICE OF BUDGET AND FINANCE, PROPERTY MANAGEMENT


FULLERTON FIRE STATION #8 - RENOVATION & ADDITION

SCHEDULES II

4401 FITCH AVENUE, NOTTINGHAM, MARYLAND, 21236

ELECTION DIST. NO.: 14C5

SHEET DESIGNATION | CONTRACT NUMBER 25034 PF0 RE-BID JOB ORDER NUMBER 241-220-0054-0012 SHEET 41 of 58 DRAWING NUMBER 2022-2357 FILE NO.: 20-120

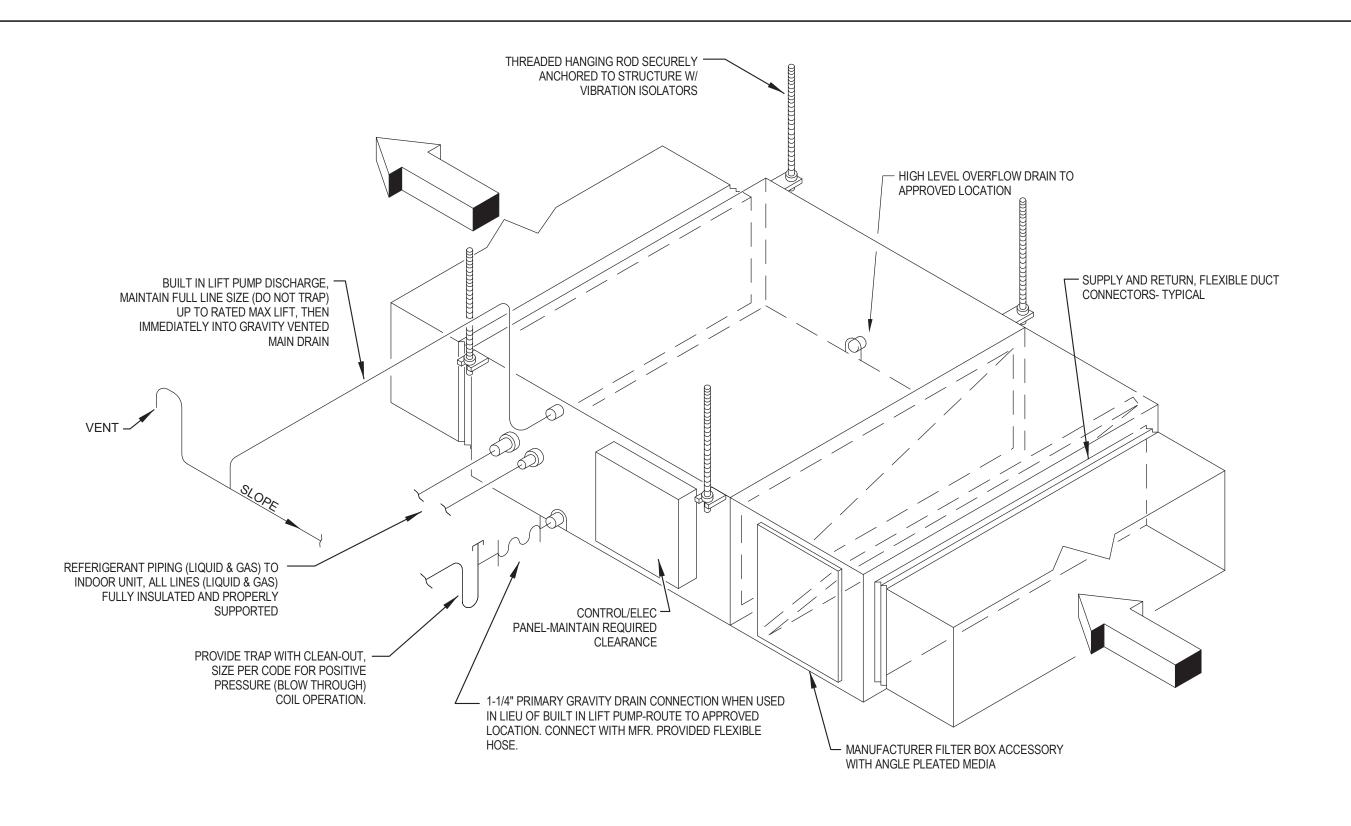

VRF DUCTED SSU/DOAS - TYPICAL SCALE: NONE

(NOTE 2) 24X24 / 24X12 / 24X48 LAY-IN T-BAR PANEL MODULE, SRR ADAPTER WHERE ROUND NECK OCCURS, NOTE 1D, 2D, 3D, 4D LAY-IN CEILING DIFFUSER **TUTTLE & BAILEY** ARCL ALUMINUM / WHITE VISUAL PRIVACY EGGCRATE TYPE, HEAVY GAUGE EXTRUDED ALUMINUM, 0.015-INCH THICK, 45 DEGREE DEFLECTION & 1/2 BY 1/2 BY 1/2 INCH GRID CORE WITH SQUARE OR RECTANGULAR HOUSING EXTENDED EG/RG EXHAUST GRILLE / RETURN GRILLE **TUTTLE & BAILEY** VPER ALUMINUM / WHITE TO FORM PANEL TO FIT IN CEILING SYSTEM MODULE, REMOVABLE OR HINGED FACE PANEL, LAY-IN T-BAR OR SURFACE MOUNT FRAME TO SUIT CEILING TYPES EG1 EXHAUST GRILLE HORIZONTAL DEFLECTED BARS AT 3/4" SPACING **TUTTLE & BAILEY** A70D ALUMINUM / WHITE 24x24 MODULE (UNO) W/ LT FRAME FOR LAY-IN & SF FRAME FOR SURFACE MOUNT, 24x12 OR 48x24 TRANSFER GRILLE **TUTTLE & BAILEY** CRE510 ALUMINUM / WHITE MODULE WHERE SHÓWN TG1 TRANSFER GRILLE **TUTTLE & BAILEY** GAV STEEL/MATCH PAINT V-CORE WITH U-FRAME THE GRD SCHEDULE IS A STANDARD SCHEDULE. ALL GRILLE, REGISTER, AND GRD SCHEDULE NOTES: DIFFUSER DO NOT NECESSARILY APPEAR ON DRAWINGS FOR THIS PROJECT. 1. FOR DIRECTION OF AIRFLOW, SEE DIFFUSER ON ASSOCIATED FLOOR PLAN. 1D= 1-WAY, 2D=2-WAY, 3D=3-WAY, 4D=4-WAY. 2. BAKED ENAMEL WHITE AT CEILING; CLEAR SATIN ANODIZED AT WINDOW SILL OR ON FLOOR OR DUCT. OR WALL MATCH PAINT TO ADJACENT SURFACES WHERE INDICATED OR SPECIFIED. FINAL FINISH AND COLOR SHALL BE AS SELECTED BY OWNER/ARCHITECT. 3. SEE DETAILS 1 / M500 AND 4 / M500.

GRILLE, REGISTER AND DIFFUSER SCHEDULE

MODEL

MATERIAL / FINISH

		GRA'	VITY V	ENTILA	TOR / F	PENTH	OUSE	SCHE	DULE		
				CAPACITY		THROAT/	SIZE				
TAG	DESCRIPTION	MANUFACTURER MODEL	AIRFLOW	PRESSURE DROP	FACE VELOCITY	ROOF OPENING L x W	LxWxH OR ∅x H	APPROX. WEIGHT	DETAIL	ACCESSORIES	REMARKS
			CFM	IWG	FPM	INCHES	INCHES	LBS	#/DWG#		
IPH-01	FRESH AIR INTAKE LOUVERED PENTHOUSE	LOREN COOK 12x12x4 TRE	420	0.03	100	12x12	24x24x16	150	3 / M500	1,2,3	DUCTED, 4.5 SQ. FT FREE AREA
GV/PH SCHE	EDULE NOTES:					GV/PH SCH	EDULE OPTION	ONS/ACCES	SORIES:		
1. LOOSE ACCES	SSORIES SHALL BE FIELD INSTALLED E	BY INSTALLER.				IMINUM ROOF CL OOF, WHERE OC		ER TRAY, HING	ED SUBBASE, TIE-DOWN	EYELETS, STAINLESS STEEL HARDWARE. SUITABLE	
						2. LOW LEAKAG	GE DDC CLASS 1A	A ALUMINUM MO	TOR OPERATED	DAMPER IN PLENUM/DU	JCT.
						3. 1" WASHABLE	E FILTERS, ALUM	INUM INSECT S	CREEN, TOPCAF	INSULATION.	

								TER	MIN	IAL U	JNITS	(HE	EATIN	IG ON	NLY) (	SCHE	DULE						
			AIRFLO	W (CFM)						HEATING	3			0.75	40000					ELEC	CTRICAL (60	HZ)	
TAG	DESCRIPTION	MANUFACTURER MODEL	OA MIN	SA	FAN ESP/TSP	FAN SPEED	TYPE	EDB	UNIT LDB	TOTAL	WATER FLOW	LWT	WPD	SIZE LxWxH	APPROX. WEIGHT	DETAIL	ACCESSORIES / OPTIONS	REMARKS	ELEC. HEAT	MOTOR	VOLTS/ PHASE	EMER. POWER	DISC. SWITCH
			IVIIIN		IWG			°F	°F	MBH	GPM	°F	FT. WG	INCHES	LBS	#/SHT#			KW	HP	THASE	FOVER	SWITCH
EDH-01	ELECTRIC DUCT HEATER	INDEECO QUA	-	450	-	-	ELECTRIC	10	52	20.5	-		-	12 X 12	75	-	A	PREHEAT USE ONLY, INTERLOCK WITH DOAS-01, REMOTE CONTROL PANEL.	6.0	-	208 / 3	NO	MFR
TERMINAL UI	NIT SCHEDULE NOTES:				TERMINA	L UNIT SO	CHEDULE A	CCESS	ORIES:									1					
1.	AMBIENT 95 °F DB/75 °F WB SUMMER, 10 °F DB WINTER.	A	REFER TO ACCESSIB	) THE SPECIFIC BILITY.	CATIONS. F	PROVIDE F	REMOTE CO	ONTROL PANEL	_ AT SUIT	TABLE LOCAT	TION ABOVE C	EILING TO PRO	OVIDE ADEQUA	TE CLEARANCES AND									
2.																							

TAG

DESCRIPTION

MANUFACTURER

DESIGN CONDITIONS													
	HE	ATING	CC	OOLING									
AREA/SPACE	DB	WB / RH	DB	WB / DP*	MAXIMUM NC	REMARKS							
	°F	°F/%	°F	°F/°F									
BALTIMORE, MD - AMBIENT [ASHRAE 90.1-2016, CLIMATE ZONE 4A]	11	-	91	74	-	-							
OFFICES, CONFERENCE, DORMITORY, LOCKER ROOMS, FITNESS - OCCUPIED	68	-	78	67	35	-							
STORAGE, TOILETS -OCCUPIED/UNOCCUPIED	60	-	-	-	-	-							
OFFICES, CONFERENCE, DORMITORY, LOCKER ROOMS, FITNESS - UNOCCUPIED	55	-	85	61	-	-							

SUBDIVISION: FULLERTON

	SCHEDULE GENERAL NOTES
1	MANUFACTURERS AND MODEL NUMBERS ARE NOTED TO ESTABLISH DESIGN QUALITY AND PERFORMANCE CRITERIA ONLY, OTHER MANUFACTURERS MAY BE ACCEPTABLE.
2	EQUIPMENT / FIXTURES / SPECIALTIES MANUFACTURER AVAILABLE FOR CONSTRUCTION OF THIS PROJECT MAY DIFFER WITH RESPECT TO PHYSICAL SIZE, CONNECTION LOCATIONS AND SIZES. THE CONTRACTOR SHALL BE RESPONSIBLE TO COORDINATE THE PURCHASED EQUIPMENT/FIXTURES/SPECIALTIES WITH THE CONDITIONS DEPICTED HEREIN AND MAKE ALL NECESSARY ADJUSTMENTS WITHOUT ANY ADDITIONAL COSTS.
3	ALL FIXTURES/EQUIPMENT/SPECIALTIES INDICATED HERE MAY NOT APPEAR ON THE CONTRACT DRAWINGS.

REMARKS

SEAL MINIMININI OF MARSINI AND PARTIES OF MAR
V

	PROFESSIONAL CERTIFIC	AS-BUILT / REVISION	ON	BY	DATE	P.W.A. NO.	KEY SHEET	POSITION SHT	DRAWIN	G SCALE			
_	I HEREBY CERTIFY THAT THESE DOCUMENTS V APPROVED BY ME, AND THAT I AM A DULY LICE		BID/PERMIT	BID/PERMIT		3/01/25	-	MSW	27NE21	PLAN SCALE:	NONE	APPROVED BY: Mihai T Petrisor	
	PROFESSIONAL ENGINEER UNDER THE LAWS O MARYLAND.						R.O.W NO.	-	-	DDODU E COALE	<u>-</u>	DIRECTOR 03/26/2025	
$\equiv$	LICENSE NO. 22942 EXPIRATION DA	TE: 12-24-2026					-	-	-	PROFILE SCALE:		DATE:	
11//:	ENGINEER:UDAY PATEL, PE, LEED BD+C	DGN BY: CCJM	BUREAU OF ENGINEERING AND CONSTRUCTION		HIGH	WAYS	STRUCTURES	STORM DRAINS	SEWER	WATER	FIELD ENGINEER	PROPERTY MANAGEMENT	
PRINCIPAL MECHANICAL ENGINEER  C.C. JOHNSON & MALHOTRA, P.C.		DWN BY: CCJM	REVIEWED BY:									APPROVED BY: CHIEF	
	400 EAST PRATT STREET, SUITE 604 BALTIMORE, MARYLAND 21202 (P) 410-461-9920	CHKD BY: CCJM	DATE REVIEWED:									DATE:	

BALTIMORE COUNTY OFFICE OF BUDGET AND FINANCE, PROPERTY MANAGEMENT

FULLERTON FIRE STATION #8 - RENOVATION & ADDITION

SCHEDULES II

4401 FITCH AVENUE, NOTTINGHAM, MARYLAND, 21236

1	25034 PF0 RE-BID
	JOB ORDER NUMBER
	241-220-0054-0012
* *	SHEET 42 of 58
	DRAWING NUMBER
	2022-2358
	DES

SHEET DESIGNATION | CONTRACT NUMBER

OB ORDER NUMBER 1-220-0054-0012 IEET 42 of 58 RAWING NUMBER 2022-2358 FILE NO.: 20-120


LEGENDS ARE GENERAL. NOT ALL SYMBOLS. ABBREVIATIONS. AND/OR DESIGNATIONS MAY APPEAR ON THE DRAWINGS.

## PLUMBING

#### **ABBREVIATIONS** PIPING SPECIALTIES ABOVE FINISHED FLOOR KILOWATT PIPE ANCHOR ABOVE FINISHED GRADE KWH KILOWATT HOUR EMD CAP AFLR ABOVE FLOOR LEVEL RIM AIR HANDLING UNIT LAVATORY AHU LAV C PIPE DROP **APPROX APPROXIMATE** LINEAR FEET (FOOT) ARCH **ARCHITECTURAL** LBS OR # POUNDS ———— PIPE RISER ACID VENT ———— PIPE TEE OFF BOTTOM AVR **ACID VENT RISER** MAXIMUM AW ACID WASTE MBH THOUSAND BTU PER HOUR CONCENTRIC/ECCENTRIC REDUCER MECHANICAL CONTRACTOR BLW BELOW MECH MECHANICAL BFF BELOW FINISHED FLOOR MFR MANUFACTURER ——————————————UNION (FLANGED) BFG MANHOLE BELOW FINISHED GRADE MIN MINIMUM BFP **BACKFLOW PREVENTER** PRESSURE/ TEMPERATURE TEST FITTING BETWEEN JOISTS MSB MOP SERVICE BASIN ALIGNMENT GUIDE BLDG MSB (E) MOP SERVICE BASIN (EXISTING) BUILDING BOTTOM MTD MOUNTED EXPANSION JOINT W/ ALIGNMENT GUIDES BTU BRITISH THERMAL UNIT MTG MOUNTING FLEXIBLE CONNECTOR CB CATCH BASIN NOT APPLICABLE EXPANSION COMPENSATOR **CAST IRON BOOT** NORMAL/EMERGENCY POWER CIB EXPANSION LOOP CIP CAST IRON PIPE NORMALLY CLOSED CLG CEILING NORMALLY OPEN STRAINER WITH HOSE END BLOW OFF VALVE CO **CLEANOUT** NOT IN CONTRACT CONC CONCRETE NUMBER STRAINER CONN NTS NOT TO SCALE CONNECT OR CONNECTION CONSTR CONSTRUCT/CONSTRUCTION CONT CONTINUED/CONTINUATION ON CENTER COORD OFD COORDINATE OVERFLOW DRAIN CHKV CHECK VALVE OPNG OPENING BALANCING VALVE CW COLD WATER PLUMBING BALL VALVE DEG OR ' DEGREE PLUMBING CONTRACTOR BUTTERFLY VALVE DRINKING FOUNTAIN PRESSURE DROP OR DIFFERENCE DHW DOMESTIC HOT WATER PHASE ——— CHECK VALVE PRE-INSULATED PIPE DIA OR Ø DIAMETER DRAIN VALVE PUMPED RETURN DISC DISCONNECT **PRESS** PRESSURE DOWN GATE VALVE PRV PRESSURE REDUCING VALVE OR PRESSURE RELIEF VALVE GLOBE VALVE DWG DRAWING PSI POUNDS PER SQUARE INCH → NEEDLE VALVE (E) /EXST **EXISTING ROOF DRAIN** ELECTRICAL CONTRACTOR → PLUG VALVE ROUGH-IN ECO **EXTERIOR CLEANOUT** RPM REVOLUTIONS/MINUTE PRESSURE REDUCING VALVE ELEC ELECTRICAL RPZ REDUCED PRESSURE ZONE ELEVATION PRESSURE REGULATOR VALVE RELIEF VALVE ERD EXISTING ROOF DRAIN RWL RAIN WATER LEADER **EWS** EYE WASH STATION PRESSURE RELIEF VALVE EWC ELECTRIC WATER COOLER SAFETY RELIEF VALVE ETR EXISTING TO REMAIN STUB & CAP **EXIST EXISTING** SHUT OFF VALVE S&W SOIL AND WASTE EXP **EXPOSED** SAN SANITARY SOLENOID VALVE SHT SHEET **FAHRENHEIT** STOP CHECK VALVE SUMP PUMP FCO FLOOR CLEANOUT SPEC SPECIFICATION FLOOR DRAIN THROTTLE VALVE SQUARE FF EL FINISH FLOOR ELEVATION TRIPLE-DUTY VALVE SERVICE SINK FIN GR FINISH GRADE SUBSOIL DRAIN FLR FLOOR DOUBLE CHECK VALVE ST W STORM WATER FLA **FULL LOAD AMPERES** STANDARD HOT WATER TEMPER VALVE FLR SK FLOOR SINK FOOT OR FEET SUSPENDED GAS COCK/GAS STOP VALVE FT HD FEET OF HEAD SW SWITCH FUT FUTURE — (A)——— COMPRESSED AIR SHUT-OFF VALVE FLUSH VALVE TEMP FV XFMR FLUSH VALVE TRANSFORMER TEMPERATURE TDH TOTAL DYNAMIC HEAD THRU THROUGH GAUGE OR GAGE THROUGH JOISTS GAL GALLON THERMOMETER (DIAL TYPE) TEMPERED WATER GENERAL CONTRACTOR TWMV THERMOSTATIC WATER MIXING VAVLE GEN **GENERAL** TYP GPH GALLONS PER HOUR THERMOMETER (STEM TYPE) GPM GALLONS PER MINUTE UNDER ELECTRICAL GROUND OR GRADE UNDER GENERAL GTV GATE VALVE PRESSURE GAUGE WITH NEEDLE VALVE UNIT HEATER, UNDER HVAC UNDER PLUMBING FLOW METER UNO UNLESS NOTED OTHERWISE HEATING (HVAC) CONTRACTOR UR URINAL ROOF DRAIN (RD) HCP HANDICAPPED (ACCESSIBLE) HORSE POWER HP OVERFLOW ROOF DRAIN (ORD) VACUUM HR VENT HOT WATER RECIRCULATION HWR VARIABLE FREQUENCY DRIVE Hz HERTZ (FREQUENCY) VERIFY IN FIELD FLOOR SINK (FS) INSIDE DIAMETER VENT RISER FLOOR DRAIN (FD) IN OR " VENT STACK INCH VTR VENT THROUGH ROOF INT INTERIOR OPEN SITE DRAIN INVERT WATER HAMMER ARRESTER WASTE WITH FLOOR CLEANOUT WITHOUT WATER CLOSET WALL CLEANOUT WCO WALL CLEANOUT -C OVERHEAD PIPE CLEANOUT WATER GAGE WG WHA WATER HAMMER ARRESTOR → HOSE BIBB (HB) WM WATER METER WEATHERPROOF → WALL HYDRANT (WH) WPD WATER PRESS DROP WFIGHT WTR WATER TEMPERATURE RISE XFMR TRANSFORMER YARD CLEANOUT

- SSX SANITARY SEWER PIPING (EXISTING) - CD CONDENSATE DRAIN - ST STORM SEWER PIPING (ABOVE FLOOR) - EST EMERGENCY STORM SEWER PIPING (ABOVE FLOOR) - ST - STORM SEWER PIPING (BELOW FLOOR) - EST - EMERGENCY STORM SEWER PIPING (BELOW FLOOR) - STX- STORM SEWER PIPING (EXISTING) - PSAN- PUMPED SANITARY PIPING - V - VENT PIPING - MPG NATURAL GAS (LOW PRESSURE) PIPING - MPG NATURAL GAS (HIGH PRESSURE) PIPING - HPG NATURAL GAS (HIGH PRESSURE) PIPING - GV NATURAL GAS VENT - A COMPRESSED AIR - DE DEIONIZED WATER PIPING - FOD FUEL OIL DISCHARGE - FOS FUEL OIL SUPPLY - FOR FUEL OIL SUPPLY - FOR FUEL OIL SUPPLY - FOR FUEL OIL VENT - WO WASTE OIL - ACID WASTE - AV ACID VENT - DE DEIONIZED WATER
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SUBDIVISION: FULLERTON

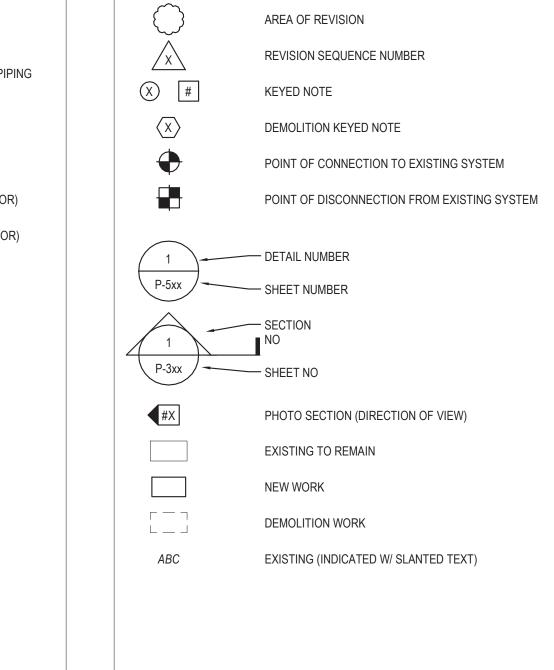

**ANNOTATIONS** 

### **GENERAL NOTES**

- THE DRAWINGS ARE DIAGRAMMATIC AND INDICATE THE APPROXIMATE ARRANGEMENT OF THE EXISTING SYSTEMS. THE CONTRACTOR SHALL FIELD VERIFY EXACT INFORMATION, DIMENSIONS, LOCATIONS, ETC. AS NECESSARY AND PERFORM WORK ACCORDINGLY. NOT ALL INFORMATION IS SHOWN.
- INFORMATION WHERE SHOWN ON THE DRAWINGS WAS OBTAINED FROM EXISTING DRAWINGS AND FIELD OBSERVATION. THE CONTRACTOR SHALL VERIFY CORRECTNESS AND COMPLETENESS OF SUCH INFORMATION TO HIS/HER OWN SATISFACTION.
- REMOVE SELECTED PLUMBING SYSTEMS IN THEIR ENTIRETY. CUT, PATCH, AND FINISH WHERE DEMOLITION WORK OCCURS. REMOVE ALL ABANDONED PIPING, EQUIPMENT, FIXTURES, AND APPURTENANCES IN THEIR ENTIRETY.
- COORDINATE DEMOLITION WORK WITH THE OWNER SCHEDULE. EXISTING PLUMBING SYSTEM & OTHER SYSTEMS IN OTHER PHASES/AREAS ARE REQUIRED TO BE IN OPERATION DURING THE PROJECT
- REFER TO ALL CONTRACT DOCUMENTS FOR ADDITIONAL REQUIREMENTS AND COORDINATE WORK ACCORDINGLY
- REFER TO STRUCTURAL DRAWINGS FOR REQUIREMENTS FOR OPENING REINFORCEMENT, EQUIPMENT SUPPORTS, LINTELS, AND CONCRETE PADS UNLESS OTHERWISE INDICATED.
- ALL FLOOR MOUNTED EQUIPMENT. AND APPURTENANCES SHALL HAVE MINIMUM 6" THICK CONCRETE PAD WITH CHAMFERED EDGES. WHETHER SHOWN OR NOT.
- INCLUDE ALL INCIDENTAL WORK REQUIRED FOR THE WORK INCLUDING TEMPORARY DISCONNECTION. RELOCATION, AND REINSTALLATION OF THE EXISTING OBSTRUCTIONS SUCH AS PIPING, CONDUITS. DUCTWORK, DOORS, BEAMS, JOISTS, SPRINKLERS, ETC. WHETHER SHOWN OR NOT. COORDINATE TEMPORARY SHUTDOWNS WITH OWNER'S REPRESENTATIVE AS SPECIFIED.
- ROUGH-IN AND CONNECT STORM WATER, HW, CW, VENT, SANITARY, AND WASTE LINES TO FIXTURES AND EQUIPMENT IN ACCORDANCE WITH SIZES INDICATED ON FIXTURE & EQUIPMENT SCHEDULES, DETAILS, RISER DIAGRAMS, FLOW DIAGRAMS, AND IN ACCORDANCE WITH THE PLUMBING CODE WHICH EVER IS THE MOST STRINGENT. NO PIPING SHALL BE SMALLER THAN 3/4" UNLESS OTHERWISE NOTED.
- ALL DIMENSIONS, AND PIPE SIZES ARE IN INCHES UNLESS NOTED OTHERWISE.
- PROVIDE 2" MINIMUM SIZE SANITARY, WASTE, AND VENT PIPING BELOW GROUND/FLOOR INSIDE BUILDING REGARDLESS OF SIZE INDICATED ON PLUMBING FIXTURE SCHEDULE. PROVIDE MINIMUM 1/4" PER FEET SLOPE FOR ALL DWV AND SANITARY PIPING UNLESS OTHERWISE DIRECTED BY ENGINEER.
- PROVIDE ALL PIPING WITHIN BUILDING THERMAL ENVELOPE, ABOVE FINISHED CEILINGS UNDER BUILDING ROOF INSULATION AND ON THE CONDITIONED SPACE SIDE OF THE BUILDING INSULATION, UNLESS NOTED OTHERWISE. UNLESS OTHERWISE NOTED, PIPING SHALL BE RUN AS HIGH AS POSSIBLE, CONCEALED ABOVE CEILINGS, IN WALLS AND PARTITIONS, AND IN PIPE CHASES.
- PROVIDE ACCESS PANELS, FIRE-RATED WHERE REQUIRED FOR ACCESS TO ALL CONCEALED VALVES, TRAPS, COMPONENTS OR OTHER EQUIPMENT FURNISHED UNDER THIS CONTRACT WHERE NO OTHER MEANS IS PROVIDED. PROVIDE BEADED EDGE IN GYPSUM BOARD WALLS AND CEILING.
- COORDINATE WALL, ROOF, FLOOR, AND CEILING OPENINGS FOR NEW PIPE RISERS, AND CONDUIT PENETRATIONS. PROVIDE SLEEVES AROUND EXISTING PIPES THROUGH NEW WALLS/PARTITIONS.
- FIELD VERIFY AND COORDINATE PIPING AND PROVIDE OFFSETS TO ACCOMMODATE PIPING THROUGH/BETWEEN JOISTS, BETWEEN BEAMS AND EXISTING BUILDING STRUCTURE, WALL STUDS, ETC. AT NO ADDITIONAL COST.
- EXISTING EQUIPMENT, APPLIANCES, ETC.; STRUCTURAL JOISTS, BEAMS, ETC.; AND LIGHTING FIXTURES, ELECTRICAL EQUIPMENT; ETC. WHERE SHOWN ARE FOR REFERENCE ONLY. VERIFY IN FIELD. REFER TO RESPECTIVE DRAWINGS AND EXISTING RECORD DRAWINGS WHERE AVAILABLE.
- ALL EQUIPMENT, AND PIPING SHALL BE SUPPORTED FROM JOIST TOP CHORD, UNLESS OTHERWISE NOTED. DO NOT SUPPORT ANYTHING FROM ROOF DECK.
- 18. ALL OPENINGS IN PIPES OR FITTINGS SHALL BE KEPT PLUGGED OR CAPPED UNTIL CONNECTED.
- PROVIDE SUFFICIENT NUMBER OF UNIONS/FLANGES IN ALL PIPE LINES TO ALLOW REMOVAL OF PIPES WITHOUT BREAKING FITTINGS AND AT ALL EQUIPMENT CONNECTIONS.
- RUNOUTS TO EQUIPMENT AND FIXTURES SHALL BE RUN IN SIZES INDICATED AND INCREASED OR REDUCED AT POINT OF FINAL CONNECTION TO EQUIPMENT AND FIXTURES.
- CONNECT AND EXTEND CONDENSATE DRAIN PIPING FROM EACH AHU, RTU, AC UNITS, CRACU, DSSU, SSU, BCU, ETC. TO NEAREST ROOF DRAIN OR FLOOR DRAIN OR EXTEND AT LEAST 25 FEET IN THE DIRECTION OF ROOF SLOPE WHERE ROOF DRAIN DOES NOT EXIST UNLESS OTHERWISE INDICATED. ROUTING SHALL NOT INTERFERE WITH PASSAGEWAYS AND MAINTENANCE. PROVIDE CONDENSATE TRAPS FOR ALL CONDENSATE DRAIN CONNECTS, SEE TYPICAL DETAIL FOR INSTALLATION. SLOPE SUSPENDED DRAIN PIPING.
- DO NOT INSTALL PIPING, EQUIPMENT, AND APPURTENANCES OVER ELECTRICAL EQUIPMENT. PROVIDE REQUIRED CLEARANCES FOR ALL ELECTRICAL EQUIPMENT PER ELECTRICAL CODE (NEC). COORDINATE LOCATIONS OF PIPING, AND EQUIPMENT ABOVE CEILINGS WITH CABLE TRAYS.
- COORDINATE MOUNTING HEIGHTS OF ALL EQUIPMENT, FIXTURES AND CONSTRUCTION BEFORE ROUGH-IN. FOR HANDICAPPED/ACCESSIBLE PLUMBING FIXTURES, CONFIRM EXACT MOUNTING HEIGHT WITH AUTHORITY HAVING JURISDICTION AND ADJUST WORK AS REQUIRED BEFORE INSTALLATION.
- PROVIDE WATER HAMMER ARRESTORS ON DOMESTIC HW AND CW PIPING AT EVERY FIXTURE GROUP WHETHER SHOWN OR NOT, LOCATE IN ACCESSIBLE POSITION FOR SERVICING.
- LOCATE ALL VENTS A MINIMUM OF 10 FEET AWAY FROM HVAC OUTSIDE AIR INTAKES AND BUILDING OPENINGS. ALL VENTS THRU ROOF SHALL TERMINATE A MINIMUM OF 24" ABOVE ROOF. ALL PLUMBING VENT RISERS IN EXTERIOR WALLS SHALL BE OFF-SET A MINIMUM OF 4'-0" AT ROOF BEFORE ROOF
- FURNISH OPERATIONAL, MAINTENANCE AND EMERGENCY INSTRUCTIONS TO THE OWNER'S REPRESENTATIVES BEFORE ANY PART OF THE SYSTEM IS TURNED OVER TO THE OWNER, AND SUBMIT WRITTEN CONFIRMATION TO THE ARCHITECT/ENGINEER AND GOVERNMENT.
- TEST INSTALLATION IN ACCORDANCE WITH THE APPROPRIATE CODE REQUIREMENTS AND SPECIFICATIONS IN PRESENCE OF OWNER'S REPRESENTATIVES. NOTIFY THE OWNER AND ENGINEER PRIOR TO TESTING SYSTEM. SUBMIT TESTING REPORTS IN OPERATION AND MAINTENANCE MANUALS.
- SHOULD ANY CHANGES OCCUR DUE TO COORDINATION WITH OTHER BUILDING TRADES AND CONFLICT WITH THE CONTRACT DOCUMENTS, THE CONTRACTOR SHALL SUBMIT FOR THE ARCHITECT/ENGINEER'S APPROVAL AN ALTERNATIVE METHOD OF COMPLETING THE WORK ACCORDING TO THE INTENT OF THE CONTRACT DOCUMENTS.
- REFER TO ARCHITECTURAL DRAWINGS FOR TEMPORARY LIVING FACILITY TRAILERS. PROVIDE TRAILERS WITH TEMPORARY WATER, SANITARY, ELECTRIC, AND OTHER UTILITIES THROUGHOUT THE DURATION OF

P001
MORE

SHEET DESIGNATION | CONTRACT NUMBER 25034 PF0 RE-BID

> 241-220-0054-0012  $\star\star\star\star\star$

SHEET 43 of 58 DRAWING NUMBER 2022-2359 FILE NO.: 20-120

JOB ORDER NUMBER


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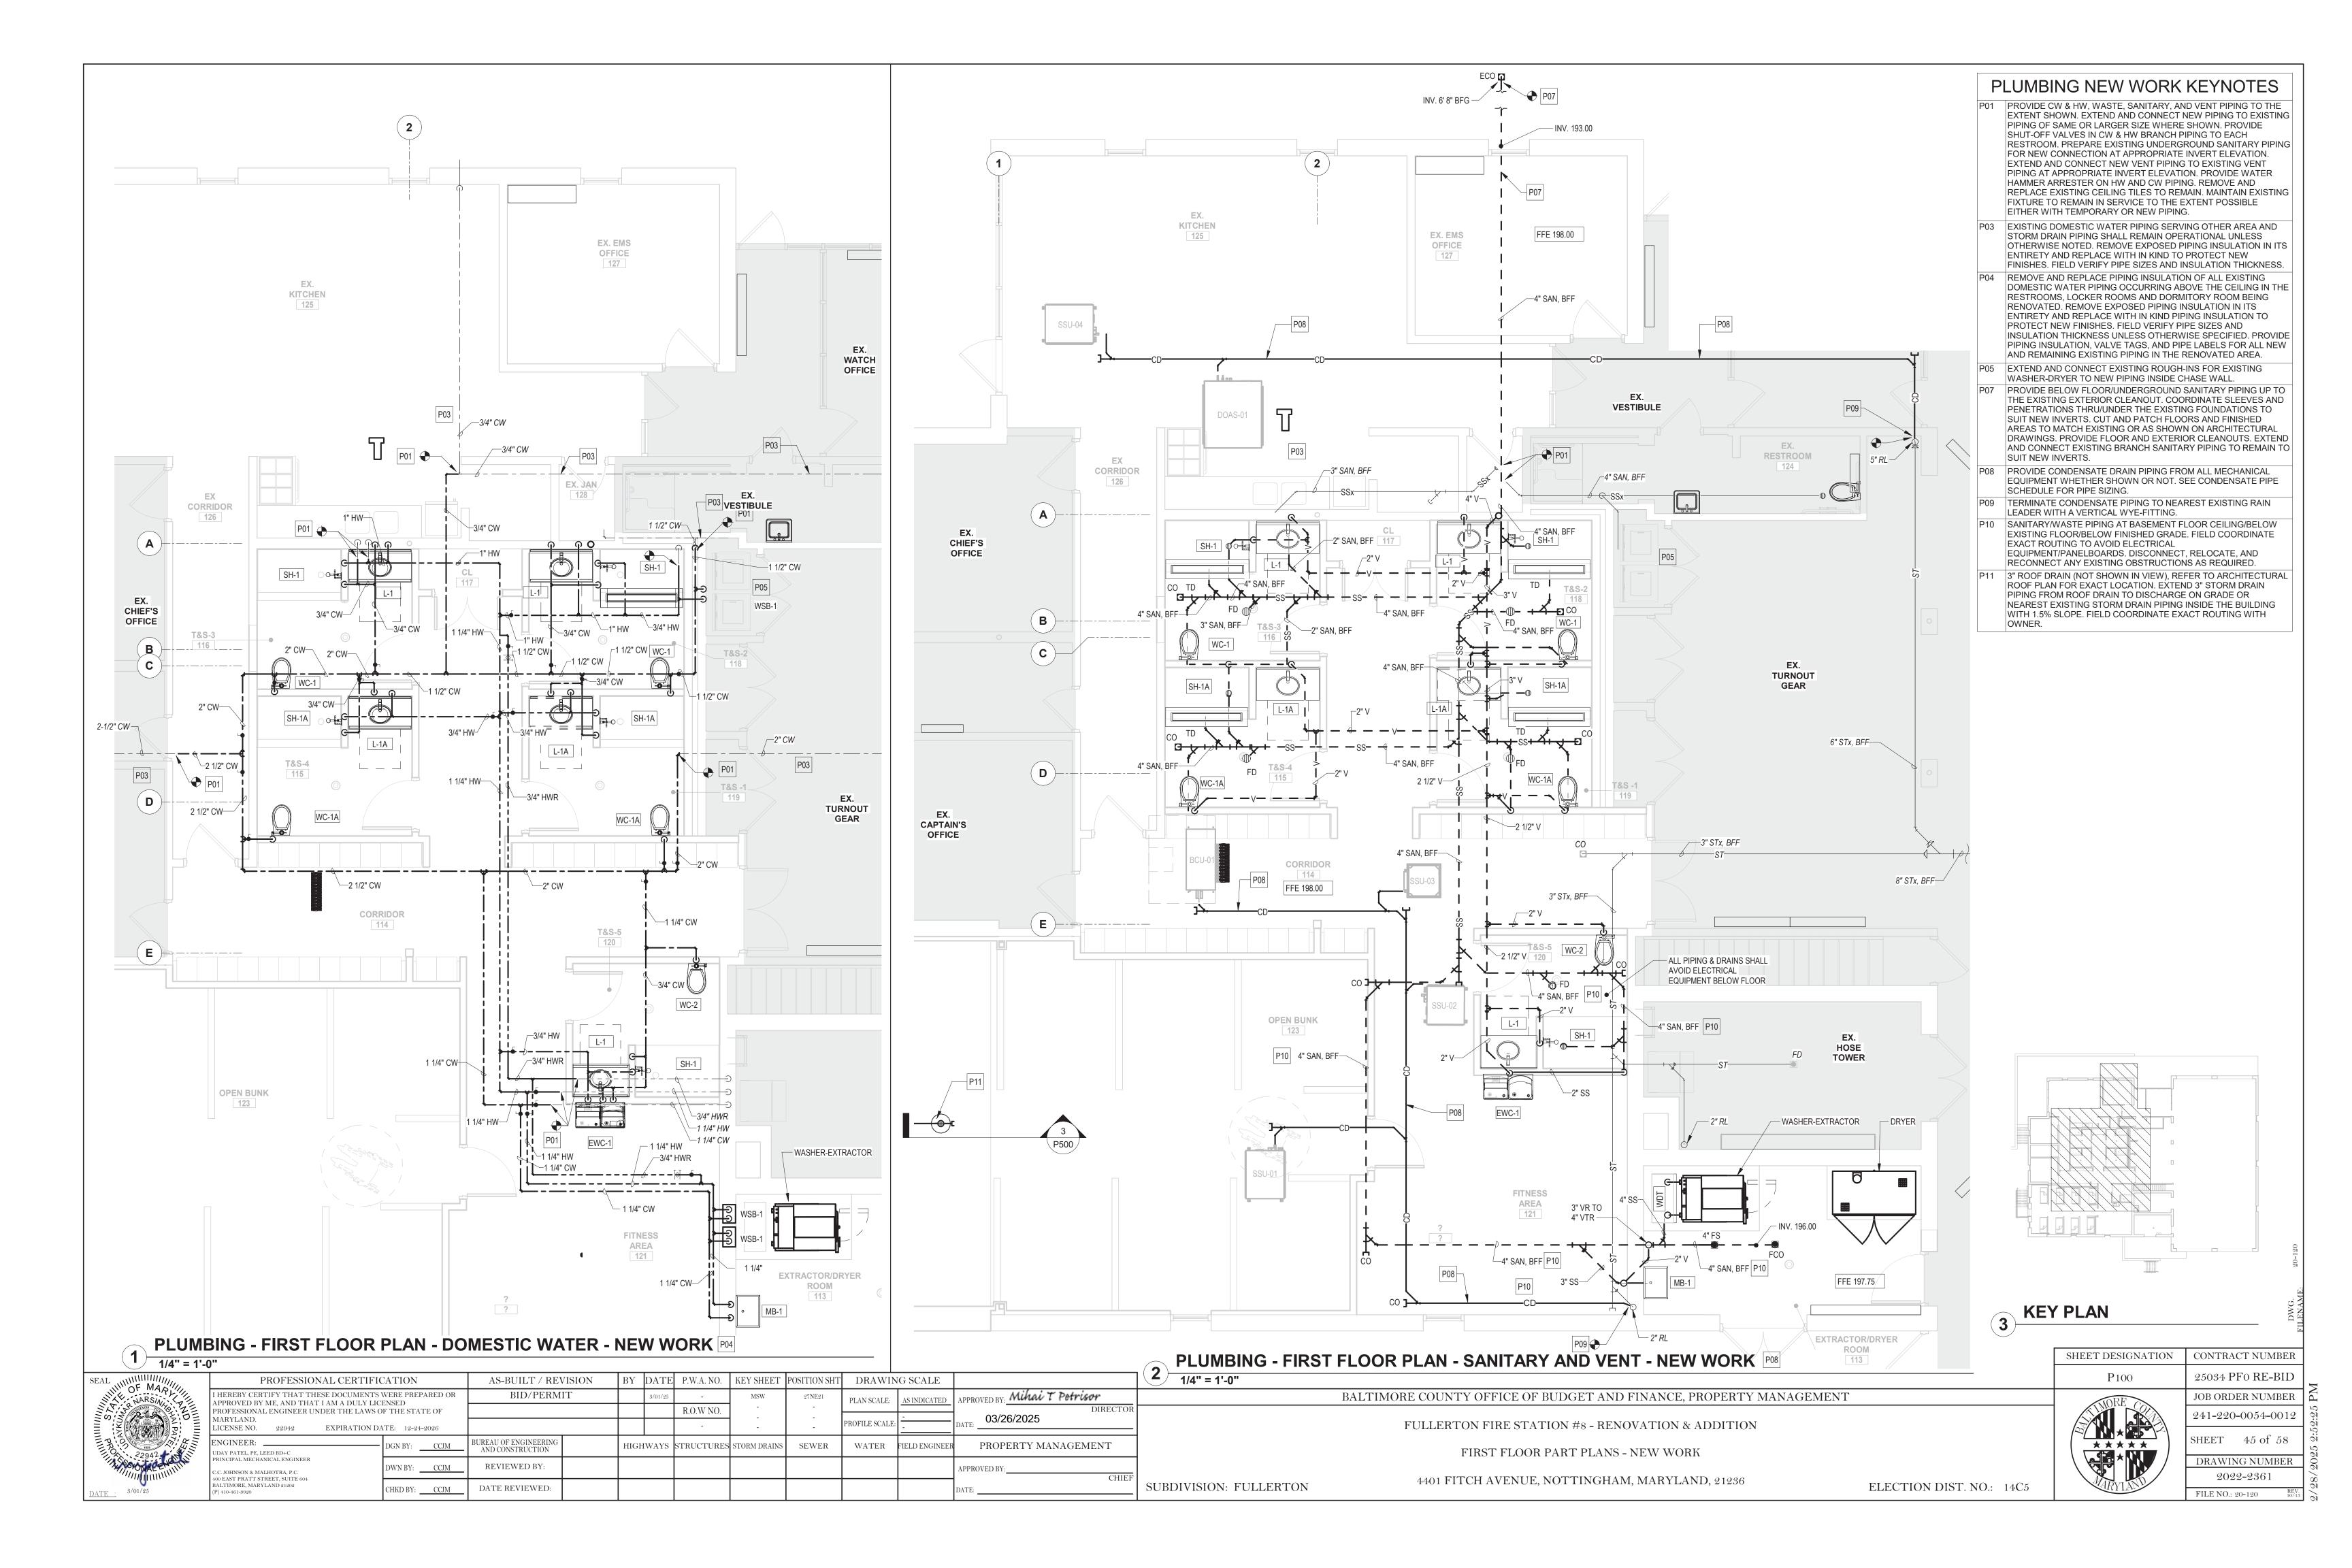
BALTIMORE COUNTY OFFICE OF BUDGET AND FINANCE, PROPERTY MANAGEMENT

FULLERTON FIRE STATION #8 - RENOVATION & ADDITION

LEGEND, ABBREVIATIONS AND NOTES


4401 FITCH AVENUE, NOTTINGHAM, MARYLAND, 21236



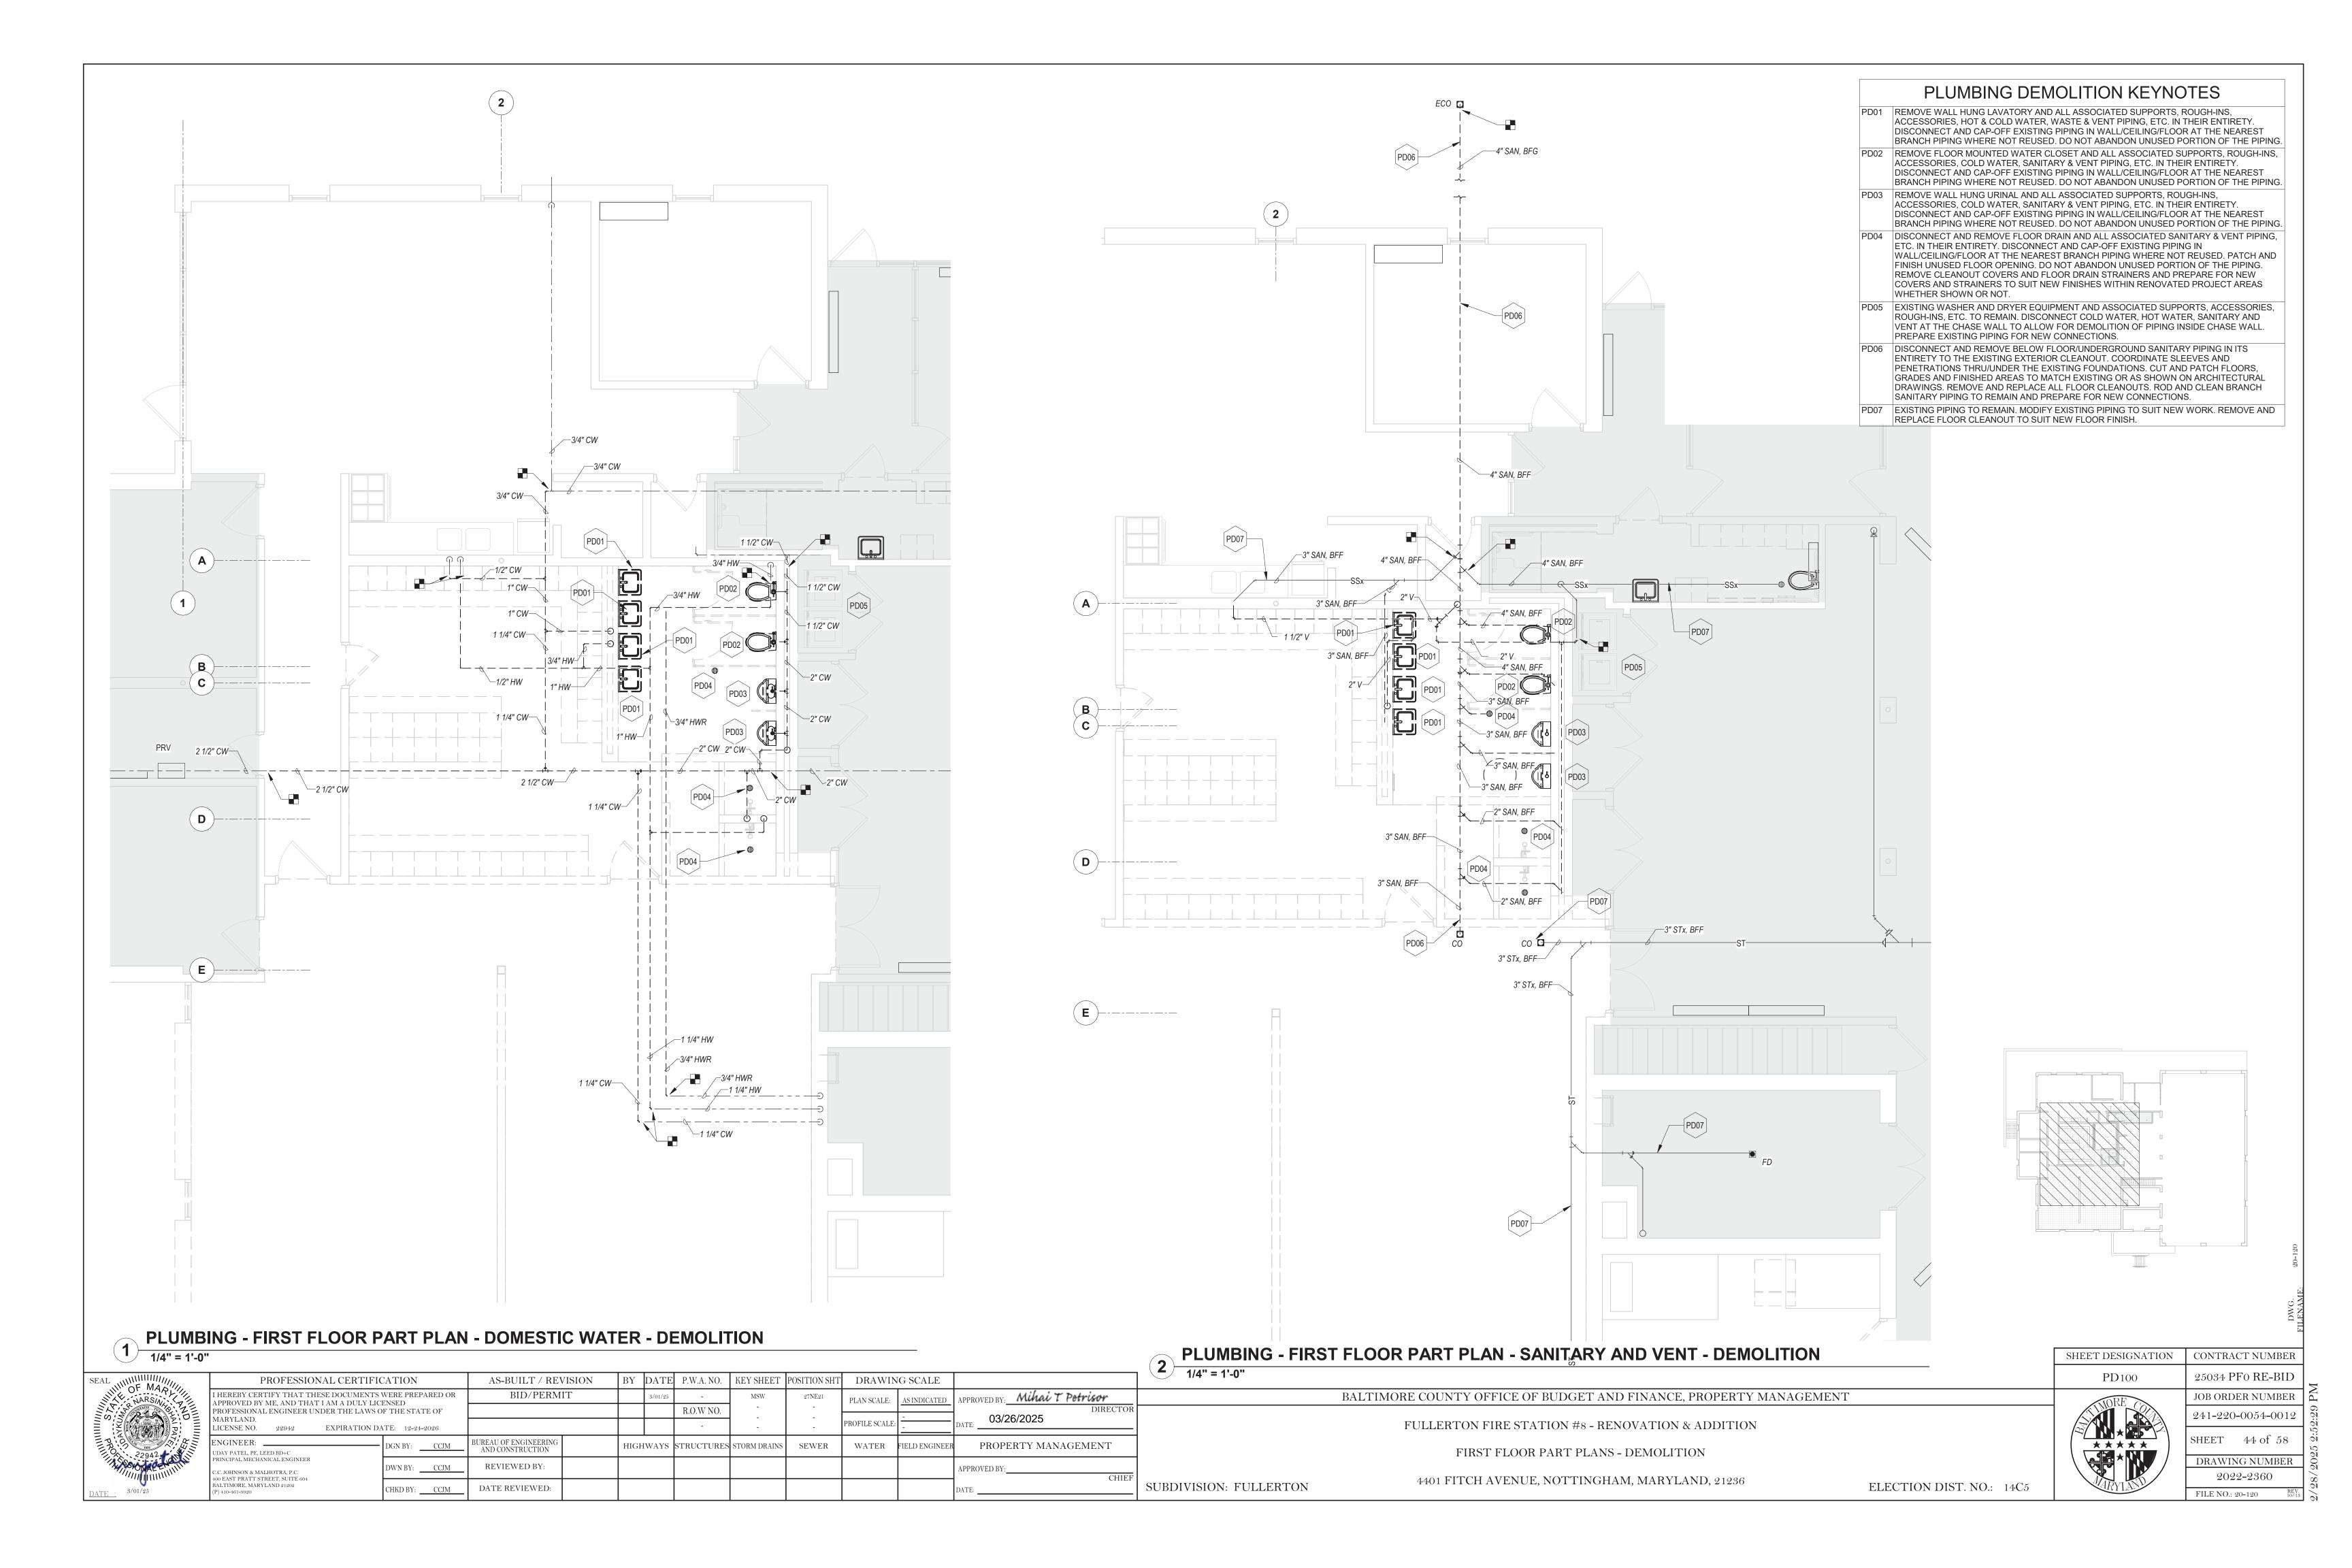

### PLUMBING NEW WORK KEYNOTES

- P07 PROVIDE BELOW FLOOR/UNDERGROUND SANITARY PIPING UP TO THE EXISTING EXTERIOR CLEANOUT. COORDINATE SLEEVES AND PENETRATIONS THRU/UNDER THE EXISTING FOUNDATIONS TO SUIT NEW INVERTS. CUT AND PATCH FLOORS AND FINISHED AREAS TO MATCH EXISTING OR AS SHOWN ON ARCHITECTURAL DRAWINGS. PROVIDE FLOOR AND EXTERIOR CLEANOUTS. EXTEND AND CONNECT EXISTING BRANCH SANITARY PIPING TO REMAIN TO SUIT NEW INVERTS.
- P10 SANITARY/WASTE PIPING AT BASEMENT FLOOR CEILING/BELOW EXISTING FLOOR/BELOW FINISHED GRADE. FIELD COORDINATE EXACT ROUTING TO AVOID ELECTRICAL EQUIPMENT/PANELBOARDS. DISCONNECT, RELOCATE, AND RECONNECT ANY EXISTING OBSTRUCTIONS AS REQUIRED.
- P11 3" ROOF DRAIN (NOT SHOWN IN VIEW), REFER TO ARCHITECTURAL ROOF PLAN FOR EXACT LOCATION. EXTEND 3" STORM DRAIN PIPING FROM ROOF DRAIN TO DISCHARGE ON GRADE OR NEAREST EXISTING STORM DRAIN PIPING INSIDE THE BUILDING WITH 1.5% SLOPE. FIELD COORDINATE EXACT ROUTING WITH OWNER.

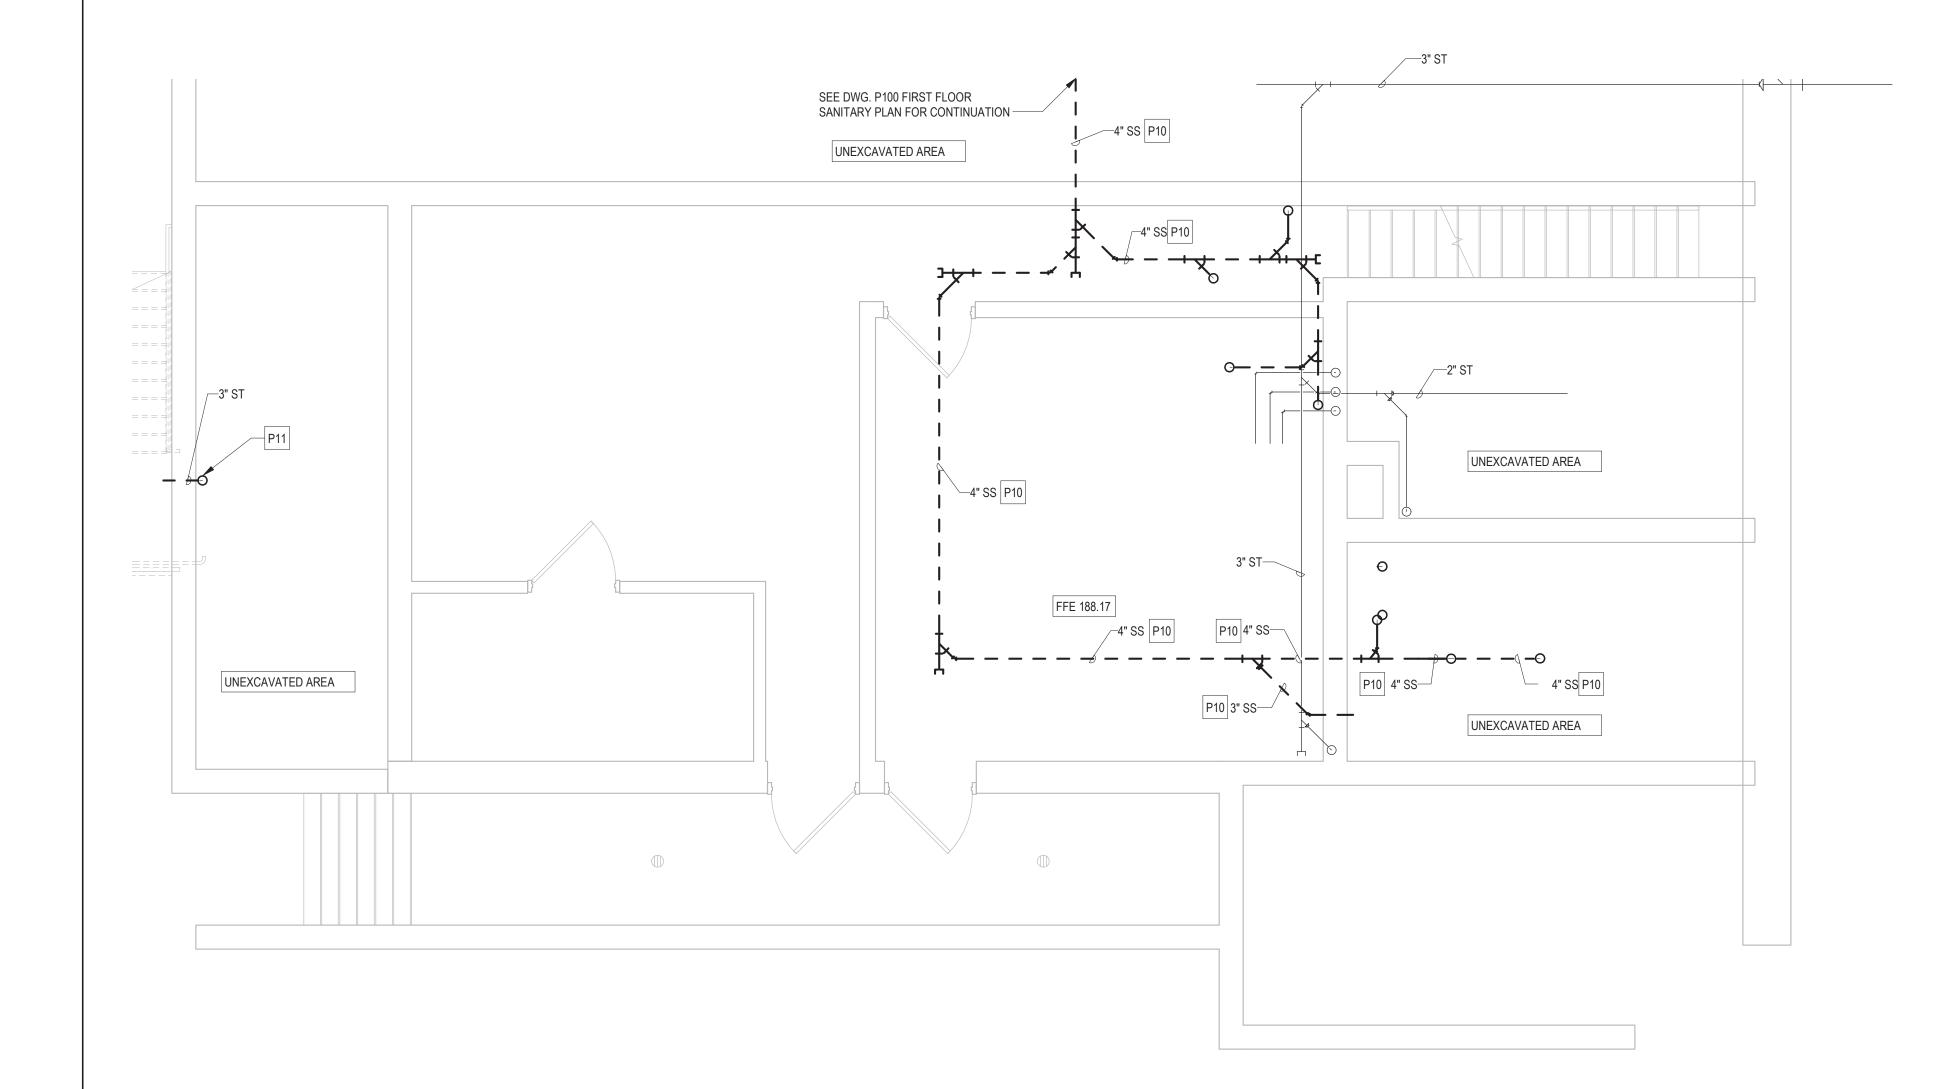

6" SAN, BFG — EX. 24" CCP EX. 24" CCP STATION SIGN 24" TREE GROUND TRENCH DRAIN CONCRETE PAD — 6" SAN, BFG EX. WALL FOUNDATION 4" SAN, BFG CONCRETE WALK EX. 4"D SEE DWG. P100 FOR CONTINUATION

PLUMBING - BASEMENT FLOOR PLAN - NEW WORK

1/4" = 1'-0"

**PLUMBING - PARTIAL SITE PLAN - SANITARY** 

SEAL	WINITE MANNE	PROFESSIONAL CERTIFIC	CATION	AS-BUILT / REVIS	SION	BY D	DATE	P.W.A. NO.	KEY SHEET	POSITION SHT	DRAWIN	G SCALE		
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		PROFESSIONAL ENGINEER UNDER THE LAWS C MARYLAND.						R.O.W NO.	-	-		-	DIRE 03/26/2025	СТ
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	22942	ENGINEER: UDAY PATEL, PE, LEED BD+C	DGN BY: CCJM	BUREAU OF ENGINEERING AND CONSTRUCTION		HIGHV	VAYS S	STRUCTURES	STORM DRAINS	SEWER	WATER	FIELD ENGINEER	R PROPERTY MANAGEMENT	1
%	NACENTIA	PRINCIPAL MECHANICAL ENGINEER  C.C. JOHNSON & MALHOTRA, P.C.	DWN BY: CCJM	REVIEWED BY:									APPROVED BY:	СНІ
DATE	3/01/25	400 EAST PRATT STREET, SUITE 604 BALTIMORE, MARYLAND 21202 (P) 410-461-9920	СНКО ВҮ: ССЈМ	DATE REVIEWED:									DATE:	J111

BALTIMORE COUNTY OFFICE OF BUDGET AND FINANCE, PROPERTY MANAGEMENT

FULLERTON FIRE STATION #8 - RENOVATION & ADDITION BASEMENT FLOOR PLAN AND SITE PLAN

SUBDIVISION: FULLERTON


4401 FITCH AVENUE, NOTTINGHAM, MARYLAND, 21236

ELECTION DIST. NO.: 14C5

MORE CO	
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SHEET DESIGNATION	CONTRACT NUMBER
P101	25034 PF0 RE-BID
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	241-220-0054-0012
* * * * *	SHEET 46 of 58
\ \ <b>\_</b>	DRAWING NUMBER
	2022-2362


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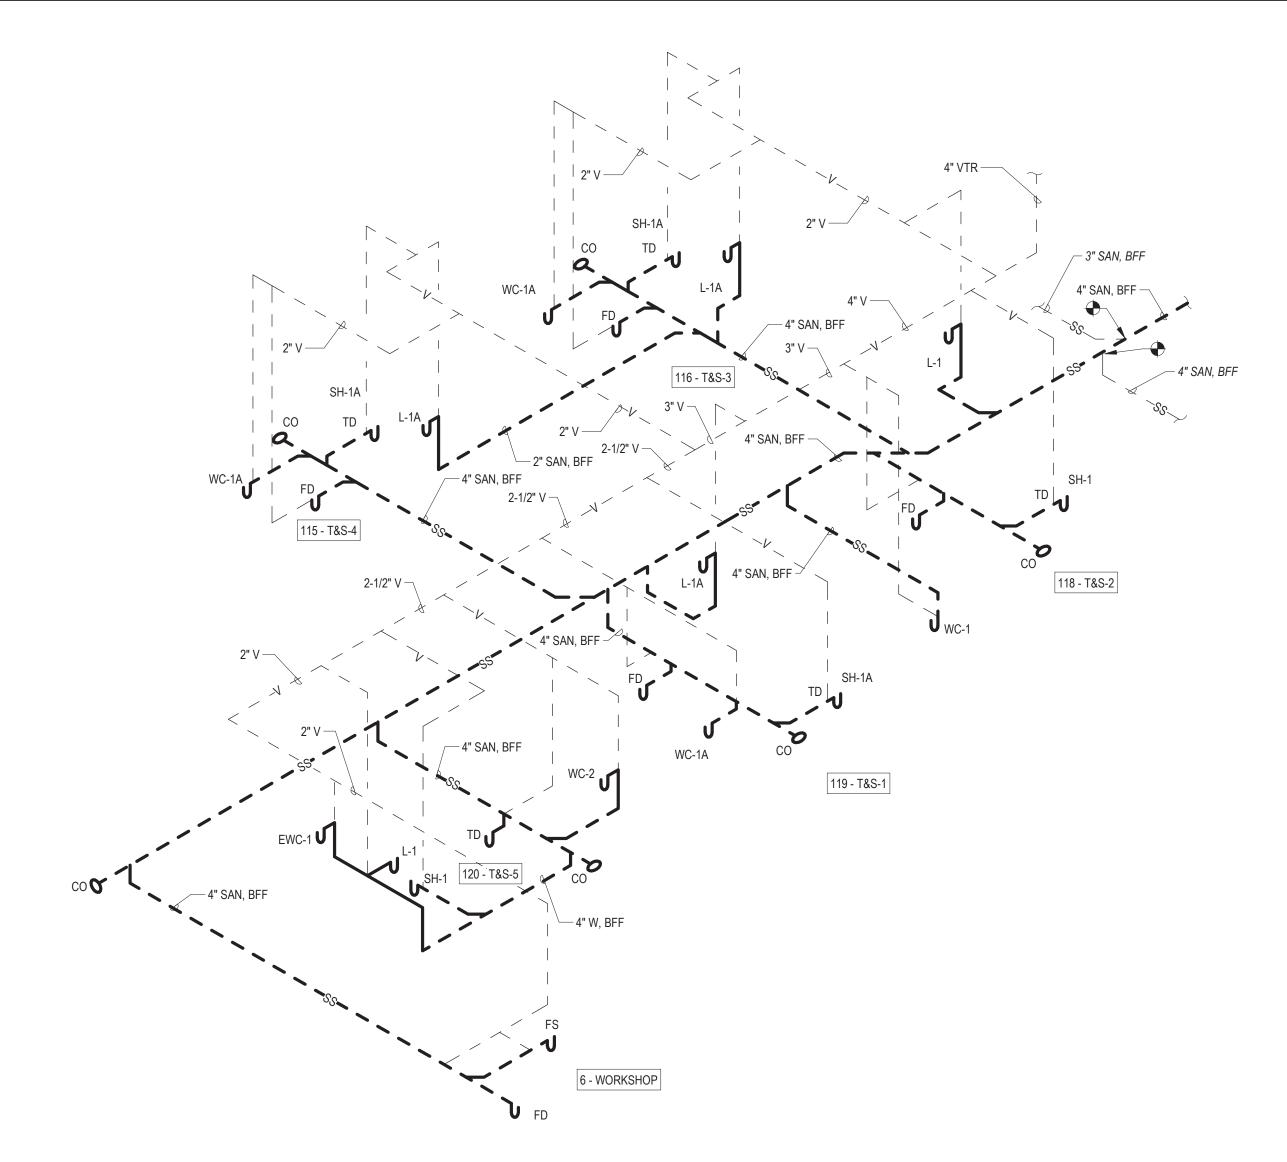
# PLUMBING - PARTIAL DOMESTIC WATER RISER DIAGRAM NOT TO SCALE

### PLUMBING NEW WORK KEYNOTES

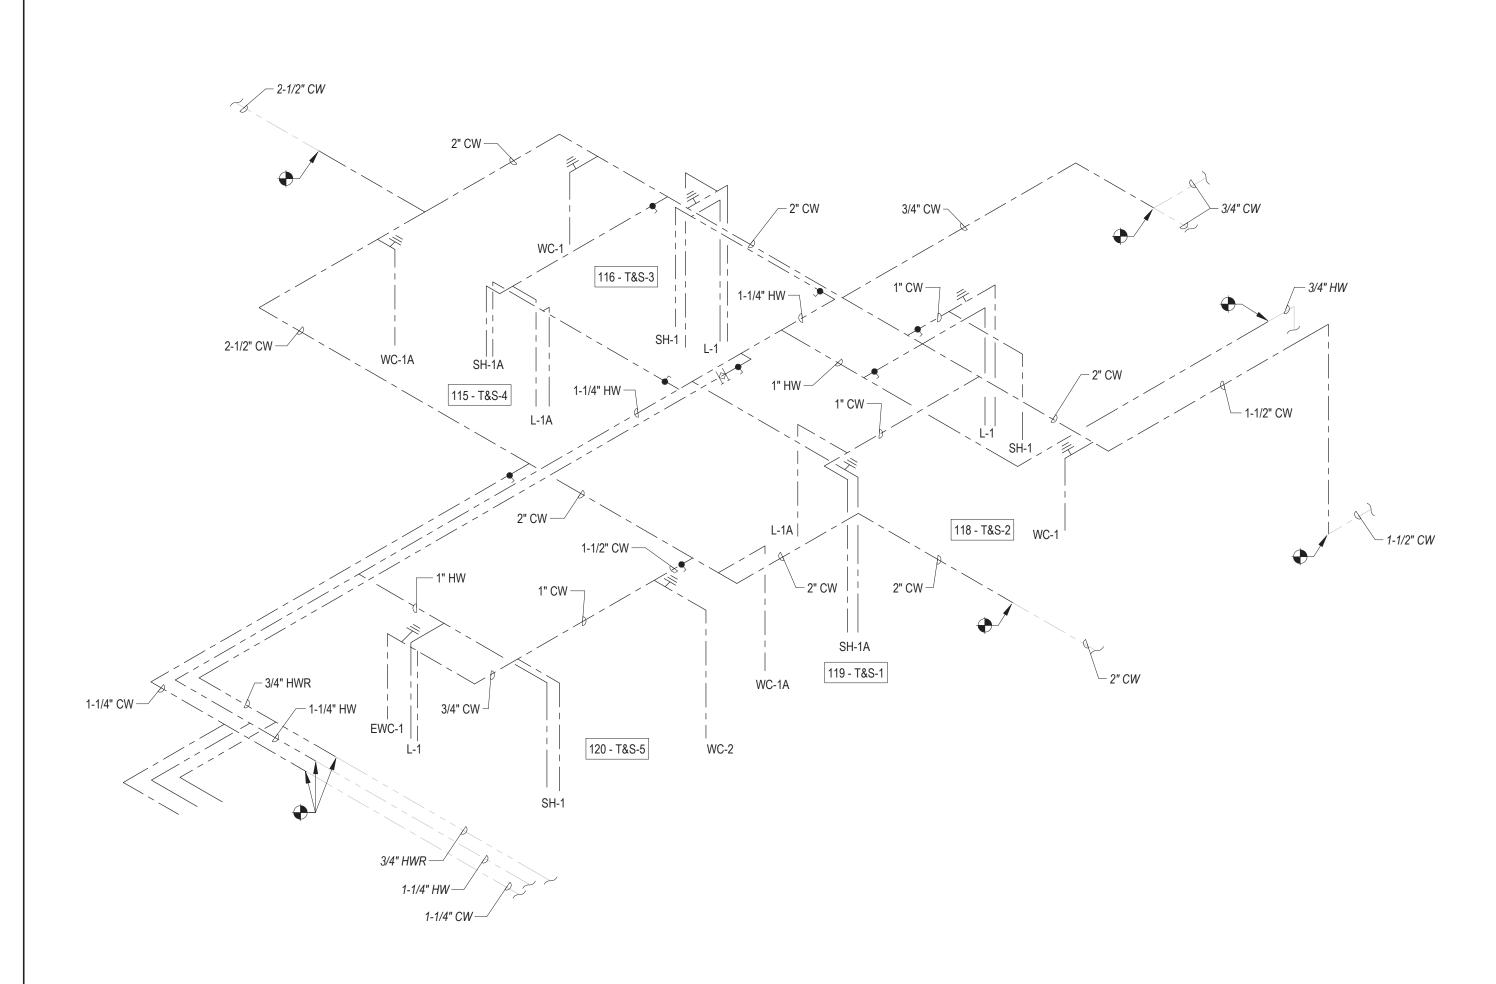3" ROOF DRAIN (NOT SHOWN IN VIEW), REFER TO ARCHITECTURAL ROOF PLAN FOR EXACT LOCATION. EXTEND 3" STORM DRAIN PIPING FROM ROOF DRAIN TO DISCHARGE ON GRADE OR NEAREST EXISTING STORM DRAIN PIPING INSIDE THE BUILDING WITH 1.5% SLOPE.
FIELD COORDINATE EXACT ROUTING WITH OWNER.



## **NEW ROOF DRAIN SECTION**

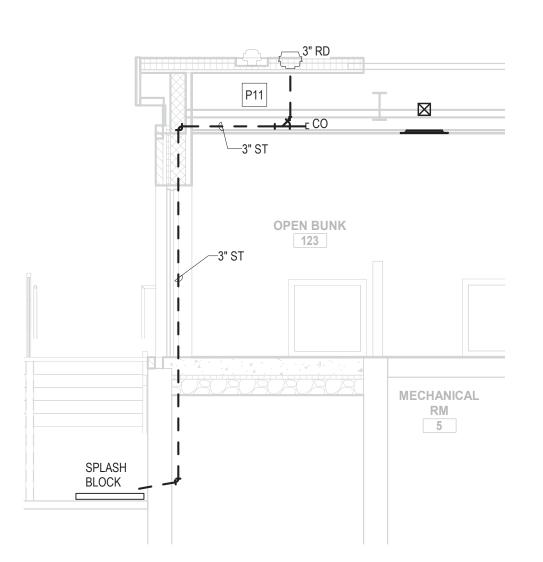

PLUMBING - PARTIAL SANITARY AND VENT RISER DIAGRAM
NOT TO SCALE

SUBDIVISION: FULLERTON

SEAL MANNING MANNING	PROFESSIONAL CERTIFIC	CATION	AS-BUILT / REV	ISION	BY	DATE	P.W.A. NO.	KEY SHEET	POSITION SHT	DRAWIN	G SCALE	
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SO TO	PROFESSIONAL ENGINEER UNDER THE LAWS C MARYLAND.						R.O.W NO.	-	-	PROFILE SCALE:		DIRECT DI
	LICENSE NO. 22942 EXPIRATION DA	ATE: 12-24-2026					-	-	-	TROFILE SCALE.		DATE:
22042 M	ENGINEER:UDAY PATEL, PE, LEED BD+C	DGN BY: CCJM	BUREAU OF ENGINEERING AND CONSTRUCTION		HIGH	IWAYS	STRUCTURES	STORM DRAINS	SEWER	WATER	FIELD ENGINEER	PROPERTY MANAGEMENT
A SOONAL ENGINEER	PRINCIPAL MECHANICAL ENGINEER C.C. JOHNSON & MALHOTRA, P.C.	DWN BY: CCJM	REVIEWED BY:									APPROVED BY:
DATE : 3/01/25	400 EAST PRATT STREET, SUITE 604 BALTIMORE, MARYLAND 21202 (P) 410-461-9920	CHKD BY: CCJM	DATE REVIEWED:									DATE:
10111111												

BALTIMORE COUNTY OFFICE OF BUDGET AND FINANCE, PROPERTY MANAGEMENT FULLERTON FIRE STATION #8 - RENOVATION & ADDITION RISER DIAGRAMS 4401 FITCH AVENUE, NOTTINGHAM, MARYLAND, 21236 ELECTION DIST. NO.: 14C5

SHEET DESIGNATION CONTRACT NUMBER P500 25034 PF0 RE-BID JOB ORDER NUMBER  $241\hbox{-}220\hbox{-}0054\hbox{-}0012$ SHEET 47 of 58 DRAWING NUMBER 2022-2363 FILE NO.: 20-120

						PLUMBING FIXTURES SCHEDULE						
	CONNECTIONS ROUGH-IN SIZE											
TAG	DESCRIPTION	COLD	HOT	WASTE	VENT	REMARKS						
WC-1A	WATER CLOSET - ADA	WATER 1"	WATER -	4"	2"	ACCESSIBLE, 1.28 GPF, FLOOR MOUNTED, WATER CLOSET WITH MANUAL EXPOSED FLUSHOMETER AND RIM HEIGHT 17" AFF. TOTO MODEL CT705ELN(G) WATER CLOSET; SC534 SEAT & SLOAN VALVE MODEL REGAL 111-1.28XL FLUSHOMETER						
WC-1	WATER CLOSET	1"	-	4"	2"	1.28 GPF, FLOOR MOUNTED, WATER CLOSET WITH MANUAL EXPOSED FLUSHOMETER AND RIM HEIGHT 17" AFF. TOTO MODEL CT705ELN(G) WATER CLOSET; SC534 SEAT & SLOAN VALVE MODEL REGAL 111-1.28XL FLUSHOMETER						
WC-2	WATER CLOSET - WALL MOUNTED	1"	-	4"	2"	1.28 GPF, WALL MOUNTED, WATER CLOSET WITH MANUAL EXPOSED FLUSHOMETER AND RIM HEIGHT 17" AFF. TOTO MODEL CT708E(G) WATER CLOSET; SC534 SEAT & SLOAN VALVE MODEL REGAL 111-1.28XL FLUSHOMETER						
EWC-1	ELECTRICAL WATER COOLER ADA	3/4"	-	1-1/2"	1-1/2"	ACCESSIBLE, WALL MOUNTED, HIGH EFFICIENCY, VANDAL RESISTANT, DUAL LEVEL STAINLESS STEEL WITH WATER BOTTLE FILLER AND WALTER FILTER, CANE TOUCH APRON. 8 GPH OF 50 °F WATER AT 90 °F AMBIENT AND 80 °F INLET WATER 6 FLA, 120V/1 PH/60 HZ						
SH-1A	SHOWER, INDIVIDUAL - ADA	1/2"	1/2"	3"	1-1/2"	ACCESSIBLE, 1.5 GPM, WATER SENSE CERTIFIED. BARDLEY MODEL HN300-HDT1-SF-LHV-LBJ-ST-HS-NS-NONE-AP-BP-NONE-NONE SHOWER CONTROLS. OTHER ACCESSORIES AND SHOWER MODULE SPECIFIED ON ARCHITECTURAL PLANS & SPECIFICATIONS						
SH-1	SHOWER, INDIVIDUAL	1/2"	1/2"	3"	1-1/2"	1.5 GPM, WATER SENSE CERTIFIED. BRADLEY MODEL 1C-HDT1-ST-SF-NONE-LBJ-NONE-NONE-NONE-AP SHOWER CONTROLS. OTHER ACCESSORIES AND SHOWER MODULE SPECIFIED ON ARCHITECTURAL PLANS & SPECIFICATIONS						
L-1A	UNDERCOUNTER LAVATORY - ADA	1/2"	1/2"	2"	1-1/2"	ACCESSIBLE, UNDERCOUNTER MOUNTED WITH REAR INTEGRAL OVERFLOW, CENTER FLAT STRAINER DRAIN, COLOR SELECTED BY ARCHITECT. MANUAL-TYPE SINGLE-CONTROL MIXING FAUCET WITH 0.5 GPM LAMINAR SPRAY OUTLET. TOTO MODEL LT546G LAVATORY AND MOEN FAUCET MODEL 8210 [NOTE 2, 7]						
L-1	UNDERCOUNTER LAVATORY	1/2"	1/2"	2"	1-1/2"	UNDERCOUNTER MOUNTED WITH REAR INTEGRAL OVERFLOW, CENTER FLAT STRAINER DRAIN, COLOR SELECTED BY ARCHITECT. MANUAL-TYPE SINGLE-CONTROL MIXING FAUCET WITH 0.5 GPM LAMINAR SPRAY OUTLET. TOTO MODEL LT546G LAVATORY AND MOEN FAUCET MODEL 8210 [NOTE 2, 7]						
TD	TRENCH DRAIN	-	-	3"	1-1/2"	BOTTOM DRAIN CONNECTION. SEE ARCHITECTURAL DRAWINGS. PROVIDE DEEP SEAL TRAP WITH PROSET TRAPGUARD						
MB-1	MOP SERVICE SINK	3/4"	3/4"	3"	2"	WALL-HUNG CAST IRON, 24" X 20.5" X 11" SERVICE SINK WITH BACK AND RIM GUARD, CAST IRON "P" TRAP AND 3" STRAINER. AMERICAN STANDARD MODEL AKRON 7695.008. CHICAGO MODEL 305VBRCF WALL MOUNT SERVICE FAUCET.						
FD	FLOOR DRAIN	-	-	3"	1-1/2"	DEEP SEAL TRAP WITH PROSET TRAPGUARD						
WSB-1	WATER SUPPLY CONTROL BOX	3/4"	3/4"	4"	1-1/2"	WATER SUPPLY FOR WASHER. TWO CONTROL BOXES AS PER MANUFACTURER'S REQUIREMENTS. IPS CORP. WIDE MOUTH MODEL# W8900HACP RECESSED OUTLET BOX. WATER HAMMER ARRESTORS, 1/4 TURN COPPER SWEAT VALVES, AND 2" DRAIN CONNECTION. FIRE RATED OUTLET BOX IN RATED WALLS/PARTITIONS. FIVE FEET LONG BRAIDED STAINLESS STEEL OR HEAVY DUTY PVC HOSE SEALED WITH RIGID CORRUGATED OUTER WALL WASHING MACHINE AUTO SHUT-OFF CONNECTORS.						
SCHED	JLE NOTES:											
1.	COORDINATE MOUNTING HEIGHTS AND	LOCATIONS FOR	R ALL FIXTURE	ES BEFORE IN	STALLATION, R	EFER TO ARCHITECTURAL ELEVATION DRAWINGS. ROUGH-IN AND INSTALL BARRIER-FREE/ACCESSIBLE FIXTURES PER ADA REQUIREMENTS. COORDINATE AUTOMATIC FLUSH VALVE HEIGHT WITH GRAB BARS.						
2.	FAUCET AS SPECIFIED; WATER SUPPLII	ES, OFFSET TRA	P; PROVIDE IN	ISULATION ON	WASTE AND V	ATER SUPPLIES.						
3.	PROVIDE FLOOR MOUNTED CHAIR-CAR	RIER TYPE FIXTU	JRE SUPPORT	S FOR EACH (	OFF-THE-FLOO	R MOUNTED FIXTURE SUCH AS LAVATORIES, URINALS, WATER CLOSETS, WATER COOLERS, AND SIMILAR OTHER FIXTURES.						
4.	HEAVY DUTY, ONE-PIECE CONSTRUCTI	ON, CHROME PLA	ATED BRASS,	VANDAL-RESIS	STANT BUBBLE	RS. PROVIDE CANE APRON LKAPREZL, FRONT ACCESS STAINLESS STEEL PANEL, MLP100 IN-WALL SUPPORT FRAME, AND 51300C WATERSENTRY PLUS FILTER AND WATERSENTRY VII FILTER KIT. 8 GPH CAPACITY. 120 VOLT, 1 PHASE, 60 HZ.						
5.	HEAVY DUTY, ONE-PIECE CONSTRUCTI	ON, CHROME PL	ATED BRASS,	VANDAL-RESIS	STANT BUBBLE	RS. PROVIDE CANE APRON LKAPREZL, FRONT ACCESS STAINLESS STEEL PANEL, MLP200 IN-WALL SUPPORT FRAME, AND 51300C WATERSENTRY PLUS FILTER AND WATERSENTRY VII FILTER KIT. 8 GPH CAPACITY. 120 VOLT, 1 PHASE, 60 HZ.						
6.	PIPE WASTE FROM THE FIXTURE AS IND	DIRECT WASTE T	O NEAREST F	LOOR DRAIN/F	FLOOR SINK. PI	ROVIDE READY ACCESS FOR INDIRECT WASTE PIPING FOR MEANS OF FLUSH COLLECTION PER OSHA MANDATED USER TESTING.						
7.	PROVIDE MANUFACTURED PROTECTIVE	E SHIELDING PIP	E COVERS AN	D ENCLOSURE	ES FOR COVER	ING EACH ADA PLUMBING FIXTURE HOT- AND COLD-WATER SUPPLIES AND TRAP AND DRAIN PIPING TO COMPLY WITH ADA REQUIREMENTS. TRUEBRO LAV GUARD2 OR APPROVED EQUAL. OMIT WHERE FRONT CLOSURE PANEL OCCURS ON ARCHITECTURAL DRAWINGS.						

A/C & VRF SYSTEM CONDENSATE PIPE SIZING SCHEDULE									
UNIT COOLING CAPACITY (TON)  BRANCH/MAIN (INCHES)  RUNOUTS (INCHES)									
0-3.0 1-1/4 1-1/4									
3.1-6.0 1-1/2 1-1/4									
6.1-12.0	2	1-1/4							
12.1-20.0	2-1/2	1-1/4							
20.1-30.0	3 -								
NOTES:									
1.	THE ABOVE SCHEDULE IS A STANDAR ONLY WHERE PIPE SIZES ARE NOT SI								
2.	MINIMUM PIPE SIZE SHALL BE 1-1/4" AND/OR EQUIPMENT CONNECTION SIZES WHICHEVER IS LARGER.								
3.	PROVIDE CONDENSATE DRAIN PIPING FROM EACH MBC/SBC/SSU/DOAS AND EXTEND TO NEAREST INDIRECT WASTE FUNNEL DRAIN. DO NOT DISCHARGE TO ANY OTHER FLOOR DRAINS OR ELSEWHERE. COORDINATE DRAIN LOCATIONS SHOWN ON PLUMBING FLOOR PLANS.								
4.	APPLY TO PLUMBING AND MECHANIC	AL DRAWINGS.							

PLUMBING SPECIALTIES SCHEDULE											
TAG	DESCRIPTION	MANUFACTURER	MODEL	CAPACITY	REMARKS						
СО	CLEANOUT - FLOOR (VCT/CERAMIC TILE)	ZURN	ZB-1400-BP-TX	MINIMUM 4" OR LINE SIZE (UNO)	NOTE 1						
ECO	CLEANOUT - EXTERIOR	ZURN	Z-1400-BP-HD	MINIMUM 4", LINE SIZE (UNO)							
WCO	CLEANOUT - WALL	ZURN	Z-1447-BP	MINIMUM 4" OR LINE SIZE (UNO)	NOTE 1						
CO AP	CLEANOUT - ACCESS PANEL	ACUDOR	UF-5000-PS-CL-16X16		PROVIDE FOR ALL EXISTING AND NEW WALL CLEANOUTS						
FD	FLOOR DRAIN - VCT/CERAMIC TILE	ZURN	ZN-415-6S-HD-VP	6" X 6" HEAVY DUTY STRAINER, MIN. 3" OR LINE SIZE (UNO)	PROVIDE DEEP SEAL TRAP AND PROSET TRAP GUARD. NOTE 2						
FS	FLOOR SINK	ZURN	ZM1751-HD-KC-YS-19	12" X 12" X 8" TYPE 316 STAINLESS STEEL HEAVY DUTY. 23 SQ. IN. GRATE OPEN AREA. 4" SIZE (UNO)	PROVIDE DEEP SEAL TRAP AND PROSET TRAP GUARD. NOTE 2						
RD	ROOF DRAIN	ZURN	ZA-100-C-EA-R-SC-VP-XJ-84	15"∅ALUMINUM DOME	PROVIDE ZURN ZARB199-SS NOZZLE AT 18" AFG WITH 24"LX3"HX12"W CONCRETE SPLAS BLOCK WHERE ON GRADE ROOF DRAIN DISCHARGE IS APPROVED						
WHA	WATER HAMMER ARRESTER	ZURN	Z-1700	AS PER PDI							
WDT	COMMERCIAL/INDUSTRIAL WASHER DRAIN THROUGH	H-M COMPANY	HM70	SUITABLE FOR SPECIFIED 65 LB INDUSTRIAL WASHER-EXTRACTOR DRAIN CAPACITY MIN. 48" L X 24" W X 18" H, 3" TOP INLETS AND 4" SIDE / BOTTOM OUTLET	1/4" THICK POLYPROPYLENE BODY, 1/4" PVC REMOVABLE LINT FILTER WITH 3/8" PERFORATIONS, 3/4" THICK POLYPROPYLENE REMOVABLE LID AND SIDE FLANGES FASTENED WITH STAINLESS STEEL SCREWS RECESSED IN FLOOR/CONCRETE PAD.						

LUMBING SPECIALTIES SCHEDULE NOTES:	

SUBDIVISION: FULLERTON

- 1. REPLACE CLEANOUT COVERS TO MATCH EXISTING SIZE AND SHAPE FOR ALL FLOOR AND WALL CLEANOUTS TO SUIT NEW FINISHES, WHETHER SHOWN OR NOT.
- 2. REPLACE FLOOR DRAIN STRAINERS TO MATCH EXISTING SIZE AND SHAPE FOR ALL FLOOR DRAINS TO SUIT NEW FINISHES, WHETHER SHOWN OR NOT.

SEAL WINNING MASON		PROFESSIONAL CERTIFICATION		AS-BUILT / REV	ISION	BY I	DATE	P.W.A. NO.	KEY SHEET	POSITION SHT	DRAWIN	G SCALE			
		I HEREBY CERTIFY THAT THESE DOCUMENTS APPROVED BY ME, AND THAT I AM A DULY LIC		BID/PERM	ΙΤ		3/01/25	-	MSW	27NE21	PLAN SCALE:	NONE	APPROVED BY:	Mihai T Pot	
	= 1   2   2   2   2	PROFESSIONAL ENGINEER UNDER THE LAWS O MARYLAND.						R.O.W NO.	-	-	DDOEH E COALE	-	03/26	6/2025	DIRECTO
		LICENSE NO. 22942 EXPIRATION DA	ATE: 12-24-2026					-	-	-	PROFILE SCALE:		DATE:		
	22042	ENGINEER:UDAY PATEL, PE, LEED BD+C	DGN BY: CCJM	BUREAU OF ENGINEERING AND CONSTRUCTION		HIGHV	WAYS	STRUCTURES	STORM DRAINS	SEWER	WATER	FIELD ENGINEER	PROP.	ERTY MANAG	EMENT
	WAS NOW APENLITY	PRINCIPAL MECHANICAL ENGINEER C.C. JOHNSON & MALHOTRA, P.C.	DWN BY: CCJM	REVIEWED BY:									APPROVED BY:		
	0 (0) (0)	400 EAST PRATT STREET, SUITE 604 BALTIMORE, MARYLAND 21202 (P) 410-461-9920	СНКО ВУ: ССЈМ	DATE REVIEWED:									DATE:		СНІЕ
	DATE.			1		l	- 1								

		BALTIMORE COUNTY OFFICE	OF BUDGET AND FINANCE	E. PROPERTY MANAGEMENT
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FULLERTON FIRE STATION #8 - RENOVATION & ADDITION

SCHEDULES

4401 FITCH AVENUE, NOTTINGHAM, MARYLAND, 21236

	WORE CO
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14C5	MRYLAND

SHEET DESIGNATION CONTRACT NUMBER 25034 PF0 RE-BID JOB ORDER NUMBER 241-220-0054-0012 SHEET 48 of 58 DRAWING NUMBER 2022-2364 FILE NO.: 20-120

GW GROUND WIRE HC HANDICAP HD HEAVY DUTY

HID HIGH INTENSIFY DISCHARGE

HOA HAND-OFF-AUTOMATIC

HPS HIGH PRESSURE SODIUM


HP HORSE POWER

## ELECTRICAL, COMMUNICATION, ELECTRONIC SAFETY AND SPECIAL SYSTEMS LEGEND

	ABBR	REVIAT	TIONS
BBREV	DESCRIPTION	ABBREV	DESCRIPTION
AS/AF	AMPERES SWITCH & FUSE RATING	HTR	HEATER
A, AMP	AMPERES	HV	HIGH VOLTAGE
AC	ALTERNATING CURRENT, ARMORED CABLE	MDP	MAIN DISTRIBUTION PANEL
ACU	AIR CONDITIONING UNIT	MTD	MOUNTED
AF AFF	AMPERE FRAME ABOVE FINISHED FLOOR	MLO	MAIN LUGS ONLY
AFG	ABOVE FINISHED FLOOR ABOVE FINISHED GRADE	MTG N	MOUNTING NEUTRAL
AHU	AIR HANDLING UNIT	NEC	NATIONAL ELECTRICAL CODE
AIC	AMPERE INTERRUPTING CAPACITY	NIC	NOT-IN-CONTRACT
ATC	AUTOMATIC TEMPERATURE CONTROL	NL	NIGHT LIGHT
ATS	AUTOMATIC TRANSFER SWITCH	NO	NORMALLY OPEN
AUX	AUXILIARY	NTS	NOT TO SCALE
AWG	AMERICAN WIRE GAUGE	NFSS	NON FUSED SAFETY SWITCH
	BLDG ELECTRICAL SYSTEM	OC OL	ON CENTER OVERLOAD
BIL	BASIC IMPLUSE LEVEL	P	POLE OR POLES
	BUILDING	PF	POWER FACTOR
BKBD BRKR	BACKBOARD BREAKER	PH, φ	PHASE
C	CONDUIT	VT	POTENTIAL TRANSFORMER
CEC		PNL	PANELBOARD
CB	CIRCUIT BREAKER	PVC	POLYVINYL CHLORIDE
CCTV	CLOSED CIRCUIT TELEVISION	R	REMOVE
CKT	CIRCUIT	RAF	RETURN AIR FAN
CR	CARD READER	RECEPT	RECEPTACLE
CL	CURRENT LIMITING	REQD	REQUIRED
CLG	CEILING	RGS	RIGID GALVANIZED STEEL
CPT	CONTROL POWER TRANSFORMER	RMS RS	ROOT MEAN SQUARE RAPID START
CT	CURRENT TRANSFORMER	RVAT	REDUCED VOLTAGE AUTOTRANSFORMER
CUH	CABINET UNIT HEATER	S/N	SOLID NEUTRAL
CW	COOL WHITE	SD	SMOKE DETECTOR
DGS DIA	DIESEL GENERATOR SET DIAMETER	SEC	SECONDARY
	DISCONNECT	SFA	SPRINKLER FLOW ALARM
	DISTRIBUTION	SMR	SURFACE METAL RACEWAY
	DOWN	ST	SHUNT TRIP
DP	DISTRIBUTION PANEL	SS	SUB STATION
DVR	DIGITAL VIDEO RECORDER	STR SW	STARTER SWITCH
DWG	DRAWING	SWBD	SWITCHBOARD
	EMERGENCY	SWGR	SWITCHGEAR
	ELECTRIC BASEBOARD HEATER	SYS	SYSTEM
	EMPTY CONDUIT	SYM	SYMMETRICAL
ECB EF	ENCLOSED CIRCUIT BREAKER	SOPN	SPACE OR POLE NUMBER
	EXHAUST FAN ELECTRIC GENERATOR SET	TA	TRIP AMPERE
	ELECTRIC HEATER	TB	TERMINAL BOX
	ELECTRICAL	TC	TIME CLOCK
-	ELECTRICAL METALLIC TUBING	TD	TIME DELAY
ENCL	ENCLOSURE	TTB	TELEPHONE TERMINAL BOARD/BLOCK
EQUIP	EQUIPMENT	TTC TYP	TELEPHONE TERMINAL CLOSET TYPICAL
	EXISTING RELOCATED	TV	TELEVISION
	EXISTING-TO-REMAIN	UC	UNDER COUNTER
	EXISTING	UG	UNDERGROUND
	EXHAUST FUSED OR FUSIBLE	UOI	UNLESS OTHERWISE INDICATED
	FRAME AMPERE	UON	UNLESS OTHERWISE NOTED
	FIRE ALARM ANNUNCIATOR PANEL	USB	UNIVERSAL SERIAL BUS
	FIRE ALARM CONTROL PANEL	V	VOLT (S) OR VOLTAGE
	FIRE ALARM AND DETECTION SYSTEM	VA	VOLT AMPERE
	FURNISHED BY OTHERS	VFD	VARIABLE FREQUENCY DRIVE
FDR	FEEDER	W	WIRE
	FLUORESCENT	W/	WITH
	FUSED SAFETY SWITCH	WP WW	WEATHER PROOF, WORK PHONE
	FOOT OR FEET		WIREWAY
	FULL VOLTAGE NON REVERSING	XFMR	TRANSFORMER AT
GFCI	GROUND FAULT CURRENT INTERRUPTER	@	/M
GND GRS	GROUND GALVANIZED RIGID STEEL		
GNO	OUFAUNTED IVIQID OTEEF	I	

POWER DISTRIBUTION								
	PANELBOARD - SURFACE MTD							
	PANELBOARD - RECESSED							
J , ①	JUNCTION BOX							
IJ <sub>D</sub> ,IJ <sub>D</sub>	JUNCTION BOX FOR SYSTEM FURNITURE DATA - 18" AFF							
	CIRCUIT BREAKER							
	MOTOR CONNECTION							
	SAFETY SWITCH NONFUSED, SIZE AS INDICATED							
F	SAFETY SWITCH FUSED, SIZE AS INDICATED							
	ELECTRICAL DEVICE AS INDICATED							
⊠h	COMBINATION TYPE MOTOR STARTER, SIZE AS INDICATED							
	CONDUIT, CONCEALED IN CEILING OR WALL OR CHASE							
	CONDUIT CONCEALED IN FLOOR OR UNDERFLOOR OR UNDERGROUND							
—  II	SYSTEM GROUND OR EQUIPMENT GROUND							
_	208 VOLT PANELBOARD							
	480 VOLT PANELBOARD							
	MEDIA CENTER							

	WIRING DEVICES								
Φ	DUPLEX RECEPTACLE - 20A, 2P, 3W, 120V								
	DUPLEX RECEPTACLE - FLUSH MOUNTED FLOOR BOX								
<b>+</b>	TWO DUPLEX RECEPTACLE IN TWO-GANG BOX - 20A, 2P, 3W, 120V								
•	RANGE RECEPTACLE								
Φ	SWITCH DUPLEX RECEPTACLE CIRCUIT - 20A, 2P, 3W, 120V								
$\Diamond$	SPECIAL RECEPTACLE, SIZE AND TYPE AS NOTED								
₩P	GFCI WP RECEPTACLE WITH IN-USE BUBBLE COVER								
ФGFI	DUPLEX RECEPTACLE WITH GROUND FAULT CIRCUIT 20A, 2P, 3W, HOSPITAL GRADE								
Фм	RECEPTACLE - FLAT DISPLAY PANEL								
Фwс	DUPLEX RECEPTACLE FOR ELECTRIC WATER COOLER								
₽ <sup>EM</sup>	RECEPTACLE - EMERGENCY POWER								
ФС	DUPLEX RECEPTACLE - CEILING								
ФUSВ	DUPLEX RECEPTACLE WITH (2) UNIVERSAL SERIAL BUS PORTS								
φIG	DUPLEX RECEPTACLE ISOLATED GROUND - 20A, 2P, 3W, 120V								
HTV	TV POWER OUTLET WITH CABLE HOOK-UP (SEE TELECOMMUNICATION/ NETWORK LEGEND FOR SPECIFICATIONS)								

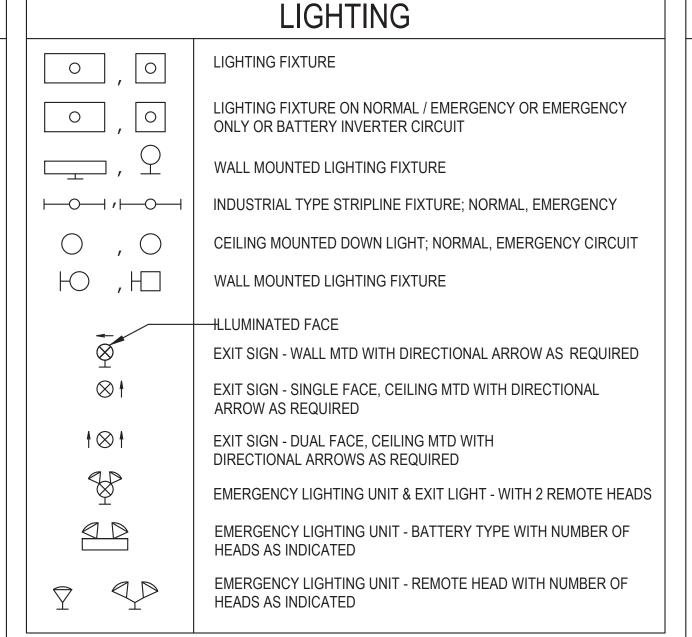

	SWITCHING SYMBOLS
\$	SINGLE POLE SWITCH
\$3	THREE WAY SWITCH
\$M	MANUAL MOTOR STARTER WITH THERMAL OVERLOAD AND HOA SWITCH
<sub>\$</sub> L∨	LOW VOLTAGE SWITCH
\$LD	LOW VOLTAGE DIMMER
\$ <sup>L2</sup>	TWO BUTTON ENTRY ROOM CONTROL STATION (LIGHTING)
<sub>\$</sub> L3	THREE BUTTON ENTRY ROOM CONTROL STATION (LIGHTING)
(OS)	OCCUPANCY SENSOR
VS	VACANCY SENSOR
PS	PHOTO SENSOR
PP	POWER PACK

### WIRING NOTES

- BRANCH CIRCUIT WIRING FOR 120 VOLT 20 AMP CIRCUITS WIRED TO 208Y/120V SYSTEMS SHALL BE ADJUSTED FOR DISTANCE VOLTAGE DROP AND LOAD HARMONIC CONTENTS AS FOLLOWS:
- GENERAL RECEPTACLES AND RESISTIVE LOADS: UP TO 100 FEET IN LENGTH: 3#12, 1#12N, 1#12G - 3/4"C OVER 100 FEET IN LENGTH: 3#10, 1#10N, 1#10G - 3/4"C 2. COMPUTER RECEPTACLES, LED LIGHTING:
- UP TO 100 FEET IN LENGTH: 3#12, 1#10N, 1#12G 3/4"C OVER 100 FEET IN LENGTH: 3#10, 1#8N, 1#10G - 3/4"C
- B. ALL WORK IS NEW, UNLESS NOTED OTHERWISE

SUBDIVISION: FULLERTON

C. ALL CONDUIT SHALL BE 3/4" MINIMUM. ALL CONDUCTORS SHALL BE #12 THHN,

### **ANNOTATIONS** · A INDICATES TYPE OF LIGHTING FIXTURE REFER TO FIXTURE SCHEDULE a INDICATES SWITCH LEG OR CONTROL ZONE 0 — 3 INDICATES CIRCUIT NUMBER \$a \$a ← a INDICATES SWITCH LEG OR CONTROL ZONE ¥3 ✓ 3 INDICATES CIRCUIT NUMBER INDICATES SPECIAL / KEYED NOTE. UNLESS ( xx ) OTHERWISE NOTED, SPECIAL / KEYED NOTE APPLIES ONLY TO THE DRAWING ON WHICH IT APPEARS. ELECTRICAL GENERAL NOTE APPLY TO ALL DRAWINGS, UNLESS OTHERWISE NOTED. EXISTING EXISTING (INDICATED WITH SLANTED TEXT) HOME RUN TO PANELBOARD DISTRIBUTION EQUIPMENT AS INDICATED. 2,4 NUMBERS INDICATE SOPN NUMBER FOR PANEL R INDICATES THE PANEL CROSS HATCH LINES INDICATE THE NUMBER OF CURRENT CARRYING CONDUCTORS CROSS HATCH LINES WITH DOT AT END INDICATES THE EQUIPMENT GROUNDING CONDUCTOR (GREEN

### MOUNTING HEIGHTS

12 GROUND FOR BRANCH CIRCUIT WIRING IN MINIMUM 3/4" RACEWAY UNLESS OTHERWISE INDICATED IN THE SCHEDULES.

WIRE) AND SHALL BE SIZED IN ACCORDANCE WITH NEC ARTICLE 250. GREEN GROUNDING WIRE SHALL BE PROVIDED WITH EACH CIRCUIT, AND/OR FEEDER. WHERE NO WIRES ARE INDICATED, PROVIDE 2 (TWO) CURRENT CARRYING # 12 AWG CONDUCTORS AND 1 (ONE) #

NOTE: UNLESS OTHERWISE INDICATED, STANDARD MOUNTING HEIGHTS FOR OUTLET BOXES FOR THE FOLLOWING EQUIPMENT/DEVICE SHALL BE ABOVE FINISHED FLOOR AND SHALL BE TO THE CENTER LINE OF EQUIPMENT & FIELD COORDINATED.

### EQUIPMENT/DEVICE | MOUNTING HEIGHT

LQUI		MODIVINOTILIOTTI					
SWITCHES		48 INCH					
RECEPTACLE	-GENERAL	18 INCH					
RECEPTACLE	-SPECIAL	18 INCH					
RECEPTACLE	-SINGLE	18 INCH					
RECEPTACLE	-REST ROOM	9 INCH ABOVE BASIN					
RECEPTACLE	-COUNTER	8 INCH ABOVE COUNTER					
RECEPTACLE	- MONITOR (DISPLAY)	78 INCH OR DIRECTED BY OWNER					
RECEPTACLE	-EXTERIOR	30 INCH					
CABLE TV OU	TLET	78 INCH, 18 INCH FOR APARTMENTS, UON					
TELEPHONE/[	DATA-GENERAL	18 INCH					
TELEPHONE-\	WALL TYPE	54 INCH, (48 INCH ADA ACCESSIBLE)					
FIRE ALARM F	PULL STATION	48 INCH					
FIRE ALARM A	AUDIO/VISUAL DEVICE	80 INCH					
CARD READE	R	40 INCH					
EXIT LIGHT W	ALL MOUNTED	MAX. 90 INCH					
SAFETY SWIT	CH	72 INCH TO HANDLE					
PANELBOARD		72 INCH TO TOP CB					
MANUAL MOT	OR STARTER	48 INCH					
PUSH BUTTO	N	48 INCH					
AUTOMATIC E	OOR OPENER	36 INCH					
APARTMENT (	JNITS						
I	DATA, KITCHEN ONLY	48 INCH					
REFRIGERATO	OR RECEPTACLE	48 INCH					
WASHER/DRY	ER RECEPTACLE	36 INCH					


SEAL OF MARY		PROFESSIONAL CERTIFICATION		AS-BUILT / REV	ISION	BY	DATE	P.W.A. NO.	KEY SHEET	POSITION SHT	DRAWIN	G SCALE	
		I HEREBY CERTIFY THAT THESE DOCUMENTS WERE PREPARED OR APPROVED BY ME, AND THAT I AM A DULY LICENSED		BID/PERM	T		3/01/25	-	MSW	27NE21	PLAN SCALE:	NONE	APPROVED BY: Mihai T Petrisor
PRO 44864 ENITED STONAL ENITED	PROFESSIONAL ENGINEER UNDER THE LAW MARYLAND.						R.O.W NO.		- - -	PROFILE SCALE:	-	DIRE 03/26/2025	
	ENGINEER: TA CHIH LIN, PE	DGN BY: CCJM	BUREAU OF ENGINEERING AND CONSTRUCTION		HIGH	IWAYS	STRUCTURES	S STORM DRAINS	SEWER	WATER	FIELD ENGINEER	PROPERTY MANAGEMENT	
	11/1/S/ONAL ENGINE	PRINCIPAL ELECTRICAL ENGINEER C.C. JOHNSON & MALHOTRA, P.C.	DWN BY: CCJM	REVIEWED BY:									APPROVED BY:
	DATE : 3/01/25	400 EAST PRATT STREET, SUITE 604 BALTIMORE, MARYLAND 21202 (P) 410-461-9920	CHKD BY: CCJM	DATE REVIEWED:									DATE:

BALTIMORE COUNTY OFFICE OF BUDGET AND FINANCE, PROPERTY MANAGEMENT

FULLERTON FIRE STATION #8 - RENOVATION & ADDITION

SYMBOLS AND ABBREVIATIONS

4401 FITCH AVENUE, NOTTINGHAM, MARYLAND, 21236

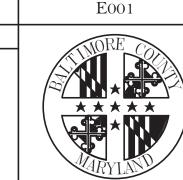


SHEET DESIGNATION | CONTRACT NUMBER 25034 PF0 RE-BID JOB ORDER NUMBER 241-220-0054-0012 SHEET 49 of 58 DRAWING NUMBER 2022-2365


FILE NO.: 20-120


#### POWER AND SYSTEMS DEMOLITION GENERAL NOTES

- EXISTING ELECTRICAL SYSTEM IS DESCRIBED BASED ON SITE CONDITIONS VISIBLE AT THE TIME OF 7. THE SURVEY. THE CONTRACTOR SHALL VISIT THE JOB SITE TO FAMILIARIZE HIMSELF WITH THE EXTENT OF EXISTING WORK TO BE DEMOLISHED
- ELECTRICAL CONTRACTOR SHALL REMOVE ALL ELECTRICAL EQUIPMENT AFFECTED BY THE DEMOLITION. COORDINATE EXACT SCOPE OF WORK WITH ARCHITECTURAL, MECHANICAL AND PLUMBING DRAWINGS
- ALL EXPOSED CONDUITS, HANGERS, SUPPORTS, ETC. THAT ARE ABANDONED SHALL BE REMOVED. 8. CONDUIT WHICH IS BURIED IN CONCRETE OR OTHERWISE INACCESSIBLY POSITIONED MAY BE ABANDONED. IN SUCH CASES, WIRE SHALL BE PULLED OUT OF THE CONDUIT AND THE CONDUIT ITSELF PLUGGED AT EACH END
- WHERE EXISTING DEVICES, CONDUIT WIRE, SUPPORTS, HANGERS AND OTHER ELECTRICAL EQUIPMENT MUST BE REMOVED AS A RESULT OF THE ALTERATIONS, THEY SHALL BE COMPLETELY REMOVED, BACK TO THE FIRST OUTLET WHICH IS LEFT UNAFFECTED. IF REMOVED BACK TO THE PANEL, LABEL THAT CIRCUIT AS SPACE
- PATCH ALL HOLES IN SLABS, WALLS AND CEILING WHERE ELECTRICAL DEVICES AND/OR CONDUIT ARE REMOVED. IF THE REMOVAL OF CONDUIT, BOXES, EQUIPMENT, ETC. COMPROMISES THE FIRE RATING OF THESE ITEMS, THE CONTRACTOR SHALL SEAL OPENINGS WITH CODE APPROVED FIRE STOPPING MATERIAL
- WHERE EXISTING ELECTRICAL WORK PREVENTS PROPER CONSTRUCTION OF NEW WORK, REMOVE, REROUTE, RELOCATE, OR IN OTHER WAYS ALTER EXISTING WORK TO ACCOMMODATE

- SOME EXCEPTIONS MAY ARISE WHEREIN EQUIPMENT, EITHER IN ALTERED AREAS OR OTHER AREAS, MUST BE KEPT IN SERVICE, REQUIRING THAT FEEDERS, SIGNAL CONDUCTORS, CONDUITS, BOXES ETC. SERVING THE SAME ALSO BE KEPT IN SERVICE. IN SUCH CASES, THE ELECTRICAL FEEDERS, SIGNAL CONDUCTORS, CONDUITS, ETC. SHALL BE REROUTED AND RECONNECTED BEFORE PRESENT WORK IS REMOVED. IF THIS IS NOT POSSIBLE, TEMPORARY WIRING SHALL BE PROVIDED TO ALLOW FOR INSTALLATION OF NEW WORK, AFTER WHICH TEMPORARY WIRING SHALL BE
- ALL PROPOSED DEMOLITION WORK SHALL BE THOROUGHLY COORDINATED WITH ALL OTHER
- CONTRACTOR IS TO PERFORM DEMOLITION WORK IN A NEAT, SKILLFUL, AND CAREFUL MANNER SO AS NOT TO DAMAGE OR DEFACE EXISTING CONSTRUCTION THAT IS TO REMAIN 1
- CONFIRM WITH THE MANUFACTURERS OF EXISTING EQUIPMENT THAT IS TO BE REVISED OR EXTENDED. ENSURE THAT EXISTING EQUIPMENT COMPLIES WITH NEW WORK REQUIREMENTS
- 11. ELECTRICAL CONTRACTOR TO REROUTE, AND REFEED ALL EXISTING EQUIPMENT/DEVICES TO REMAIN BUT MAY BE AFFECTED BY EQUIPMENT BEING DEMOLISHED

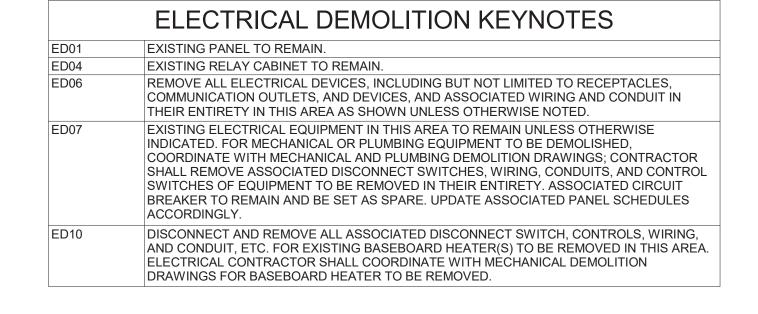

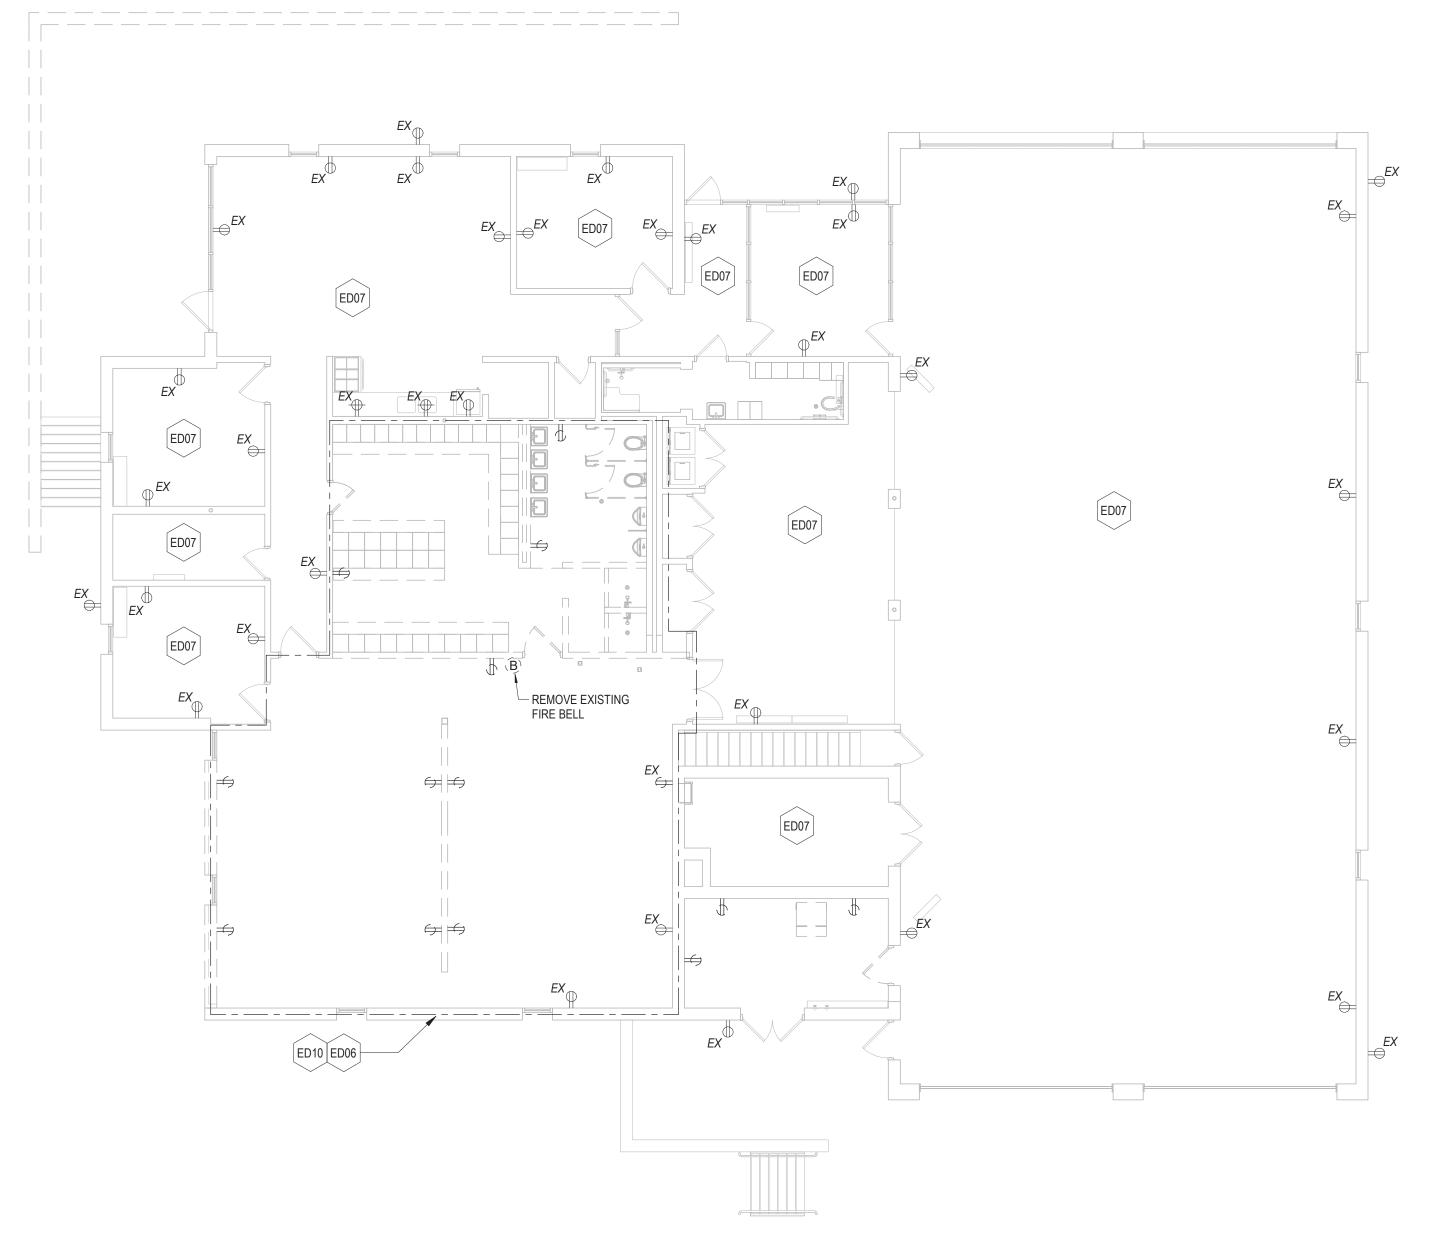

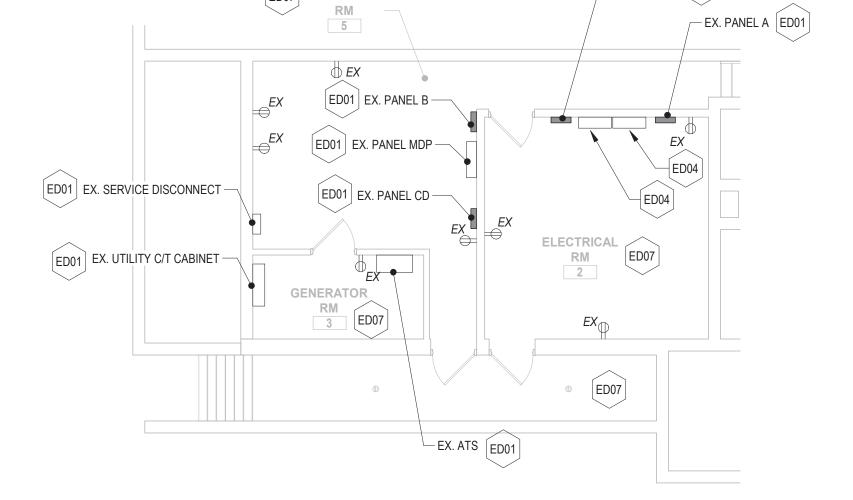

EX. PANEL E ED01

**ELECTRICAL - FIRST FLOOR PLAN - DEMOLITION** 

**ELECTRICAL - BASEMENT FLOOR PLAN - DEMOLITION** 

SEAL MINIMULA	PROFESSIONAL CERTIFIC	CATION	AS-BUILT / REV	VISION	BY	DATE	P.W.A. NO.	KEY SHEET	POSITION SHT	DRAWIN	G SCALE		
WILL OF MARY	I HEREBY CERTIFY THAT THESE DOCUMENTS APPROVED BY ME, AND THAT I AM A DULY LIC		BID/PERM	ΙΤ		3/01/25	-	MSW	27NE21	PLAN SCALE:	AS INDICATED	APPROVED BY: Mihai T Pot	risor
The state of the s	PROFESSIONAL ENGINEER UNDER THE LAWS C MARYLAND.	OF THE STATE OF					R.O.W NO.	-	-	PROFILE SCALE:	-	03/26/2025	DIRECTO
	LICENSE NO. 44664 EXPIRATION DA	ATE: 06-18-2025					-	-	-	THOTTEL SCALL.	-	DATE:	
	ENGINEER:	DGN BY: CCJM	BUREAU OF ENGINEERING AND CONSTRUCTION		HIGH	WAYS	STRUCTURES	STORM DRAINS	SEWER	WATER	FIELD ENGINEER	PROPERTY MANAG	EMENT
PROPERTY AND	PRINCIPAL ELECTRICAL ENGINEER C.C. JOHNSON & MALHOTRA, P.C.	DWN BY: CCJM	REVIEWED BY:									APPROVED BY:	CHIP
DATE : 3/01/25	400 EAST PRATT STREET, SUITE 604 BALTIMORE, MARYLAND 21202 (P) 410-461-9920	CHKD BY: CCJM	DATE REVIEWED:									DATE:	CHIE

BALTIMORE COUNTY OFFICE OF BUDGET AND FINANCE, PROPERTY MANAGEMENT

FULLERTON FIRE STATION #8 - RENOVATION & ADDITION

SUBDIVISION: FULLERTON

POWER AND SYSTEMS - FIRST & BASEMENT FLOOR PLANS - DEMOLITION

4401 FITCH AVENUE, NOTTINGHAM, MARYLAND, 21236

ELECTION DIST. NO.: 14C5


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* * * * *	SHEET 50 of 8
\ \ <b>\;\</b>	DRAWING NUME
MARVINO	2022-2366
1111111	FILE NO.: 20-120

### POWER AND SYSTEMS DEMOLITION GENERAL NOTES

1. SEE ED100 FOR ADDITIONAL POWER AND SYSTEMS DEMOLITION GENERAL NOTES

ELECTRICAL DEMOLITION KEYNOTES REMOVE EXISTING EXHAUST FAN AND ASSOCIATED DISCONNECT, WIRING, AND CONDUIT BACK TO SOURCE. COORDINATE ALL WORK WITH MECHANICAL CONTRACTOR. REMOVE EXISTING MECHANICAL EQUIPMENT, HEAT PUMP UNIT, AND ASSOCIATED INDOOR UNIT, DISCONNECT SWITCH, WIRING, AND CONDUIT BACK TO SOURCE. COORDINATE ALL WORK WITH MECHANICAL CONTRACTOR. EXISTING TO REMAIN EXISTING INCOMING CABLES TO REMAIN AND BE REROUTED. DISCONNECT EXISTING CABLES AND MAKE READY FOR REROUTING. ASSOCIATED TERMINATION POINT TO REMAIN

AND BE RECONNECTED. SEE NEW WORK PLAN FOR ADDITIONAL INFORMATION.

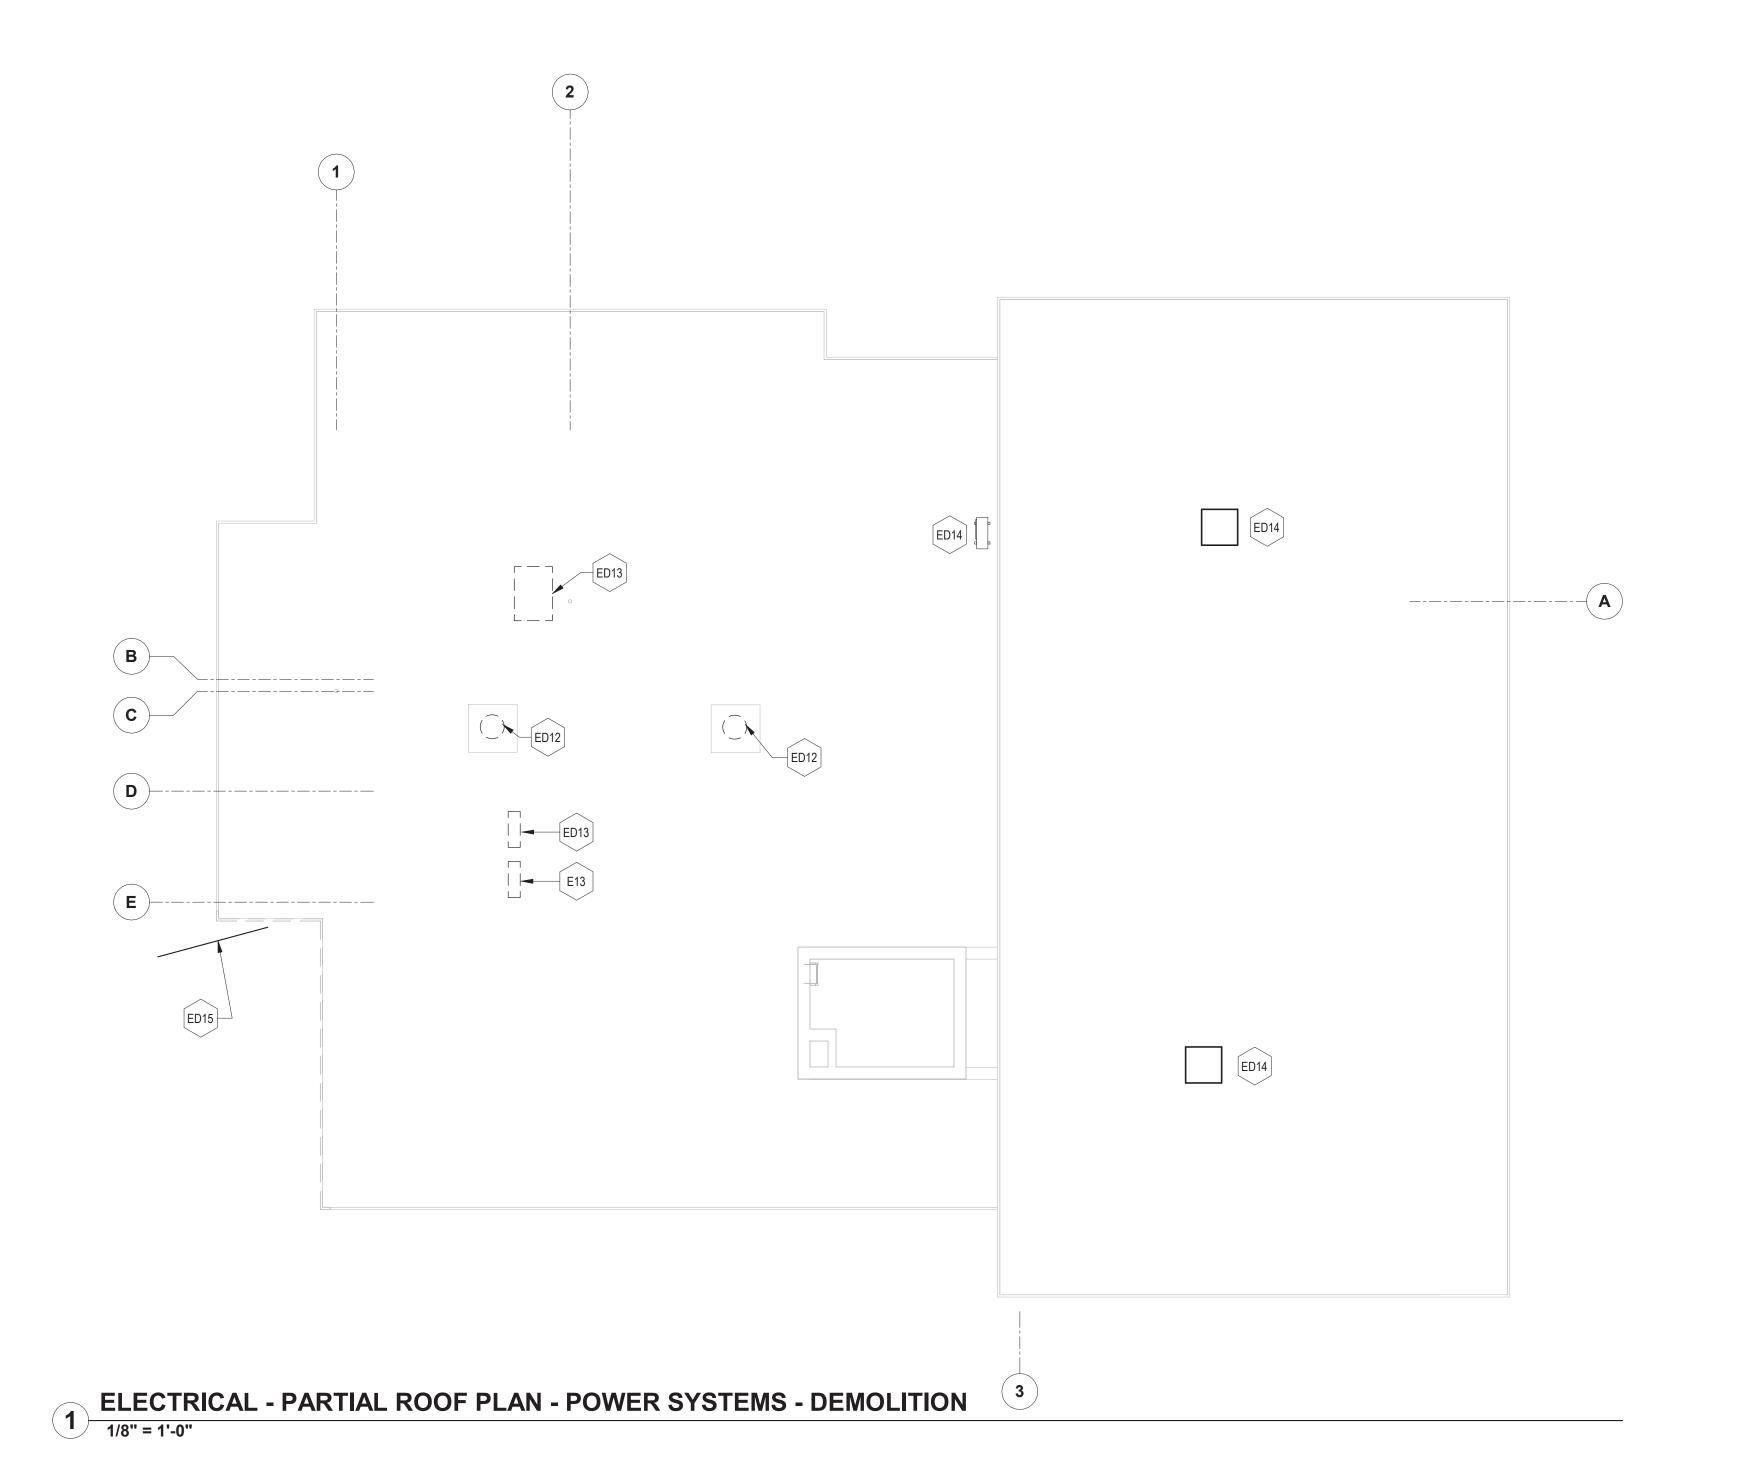

1///		PROFESSIONAL CERTIFIC	CATION	AS-BUILT / REV	VISION	BY	DATE	P.W.A. NO.	KEY SHEET	POSITION SHT	DRAWIN	IG SCALE			
RHIM	\ [	I HEREBY CERTIFY THAT THESE DOCUMENTS V APPROVED BY ME, AND THAT I AM A DULY LICE		BID/PERM	ΙΤ		3/01/25	-	MSW	27NE21	PLAN SCALE:	NONE	APPROVED BY: Mi	hai T Petr	risor
A A SECOND		PROFESSIONAL ENGINEER UNDER THE LAWS OF MARYLAND.	F THE STATE OF					R.O.W NO.	-	-	PROFILE SCALE:	-	O3/26/20	25	DIRE
		LICENSE NO. 44664 EXPIRATION DA	T						-	-		-			
	MUZ	ENGINEER:	DGN BY: CCJM	BUREAU OF ENGINEERING AND CONSTRUCTION		HIGH	WAYS	STRUCTURES	STORM DRAINS	SEWER	WATER	FIELD ENGINEER	PROPERT	TY MANAGE	EMENT
ENGILLA	0	PRINCIPAL ELECTRICAL ENGINEER C.C. JOHNSON & MALHOTRA, P.C.	DWN BY: CCJM	REVIEWED BY:									APPROVED BY:		
<i>III</i>	١ ١	400 EAST PRATT STREET, SUITE 604 BALTIMORE, MARYLAND 21202 (P) 410-461-9920	CHKD BY: CCJM	DATE REVIEWED:									DATE:		(

BALTIMORE COUNTY OFFICE OF BUDGET AND FINANCE, PROPERTY MANAGEMENT

FULLERTON FIRE STATION #8 - RENOVATION & ADDITION

POWER AND SYSTEMS - ROOF PLAN - DEMOLITION

SUBDIVISION: FULLERTON


4401 FITCH AVENUE, NOTTINGHAM, MARYLAND, 21236

ELECTION DIST. NO.:	14C5

SHEET DESIGNATION	CONTRACT NUMBER	
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\ \ <b></b> *\\	DRAWING NUMBER	2025
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THE THE	FILE NO.: 20-120 REV. 10/13	2/3

### LIGHTING GENERAL DEMOLITION NOTES

- BEFORE THE PERFORMANCE OF ANY DEMOLITION WORK, THE ELECTRICAL CONTRACTOR SHALL VERIFY THE EXISTING CONDITIONS OF LIGHT FIXUTRES. THE ELECTRICAL CONTRACTOR SHALL BE RESPONSIBLE FOR PROVIDING, INSTALLING, AND MAINTAINING ALL SUPPORTS AND BRACING REQUIRED TO COMPLETE THE WORK.
- LIGHTING DEMOLITION WORK IS INDICATED IN THE DRAWING BELOW. IT IS THE ELECTRICAL CONTRACTOR RESPONSIBILITY OF THE CONTRACTOR TO REVIEW ALL DOCUMENTS FOR ALL DISCIPLINES FOR ANY ADDITIONAL DEMOLITION WORK.
- THE OWNER SHALL BE MAINTAINING OCCUPANCY OF THE SITE AND PORTIONS OF THE BUILDING DURING THE CONSTRUCTION PROCESS. THE GENERAL CONTRACTOR SHALL COORDINATE WITH THE OWNER AND THE OWNER'S REPRESENTATIVE THROUGHOUT THE CONSTRUCTION TO MINIMIZE ANY DISRUPTIONS IN THE OWNER'S WORKING PROCEDURES. PHASING SHALL BE DETERMINED BY THE ELECTRICAL CONTRACTOR AND SHALL NOT BE A REASON FOR ADDITIONAL FEES. THE ELECTRICAL CONTRACTOR SHALL COORDINATE WITH THE OWNER A MINIMUM OF 72 HOURS BEFORE ANY DISRUPTION OF SERVICES/UTILITIES IS REQUIRED TO COMPLETE THE WORK.
- 4. ALL LIGHTING INDICATED TO BE REMOVED SHALL REMAIN THE PROPERTY OF THE OWNER UNLESS OTHERWISE NOTED. THE CONTRACTOR SHALL COORDINATE WITH THE OWNER OF ANY ITEMS TO BE REMOVED AND RETAINED BY THE OWNER BEFORE ANY DEMOLITION WORK IS PERFORMED. ALL ITEMS TO BE RETAINED BY THE OWNER SHALL BE REMOVED BY THE CONTRACTOR AND DELIVERED TO THE OWNER IN THE CONDITION FOUND. ALL OTHER ITEMS INDICATED TO BE REMOVED SHALL BE DISPOSED OF OFF-SITE BY THE CONTRACTOR IN A LAWFUL MANNER.

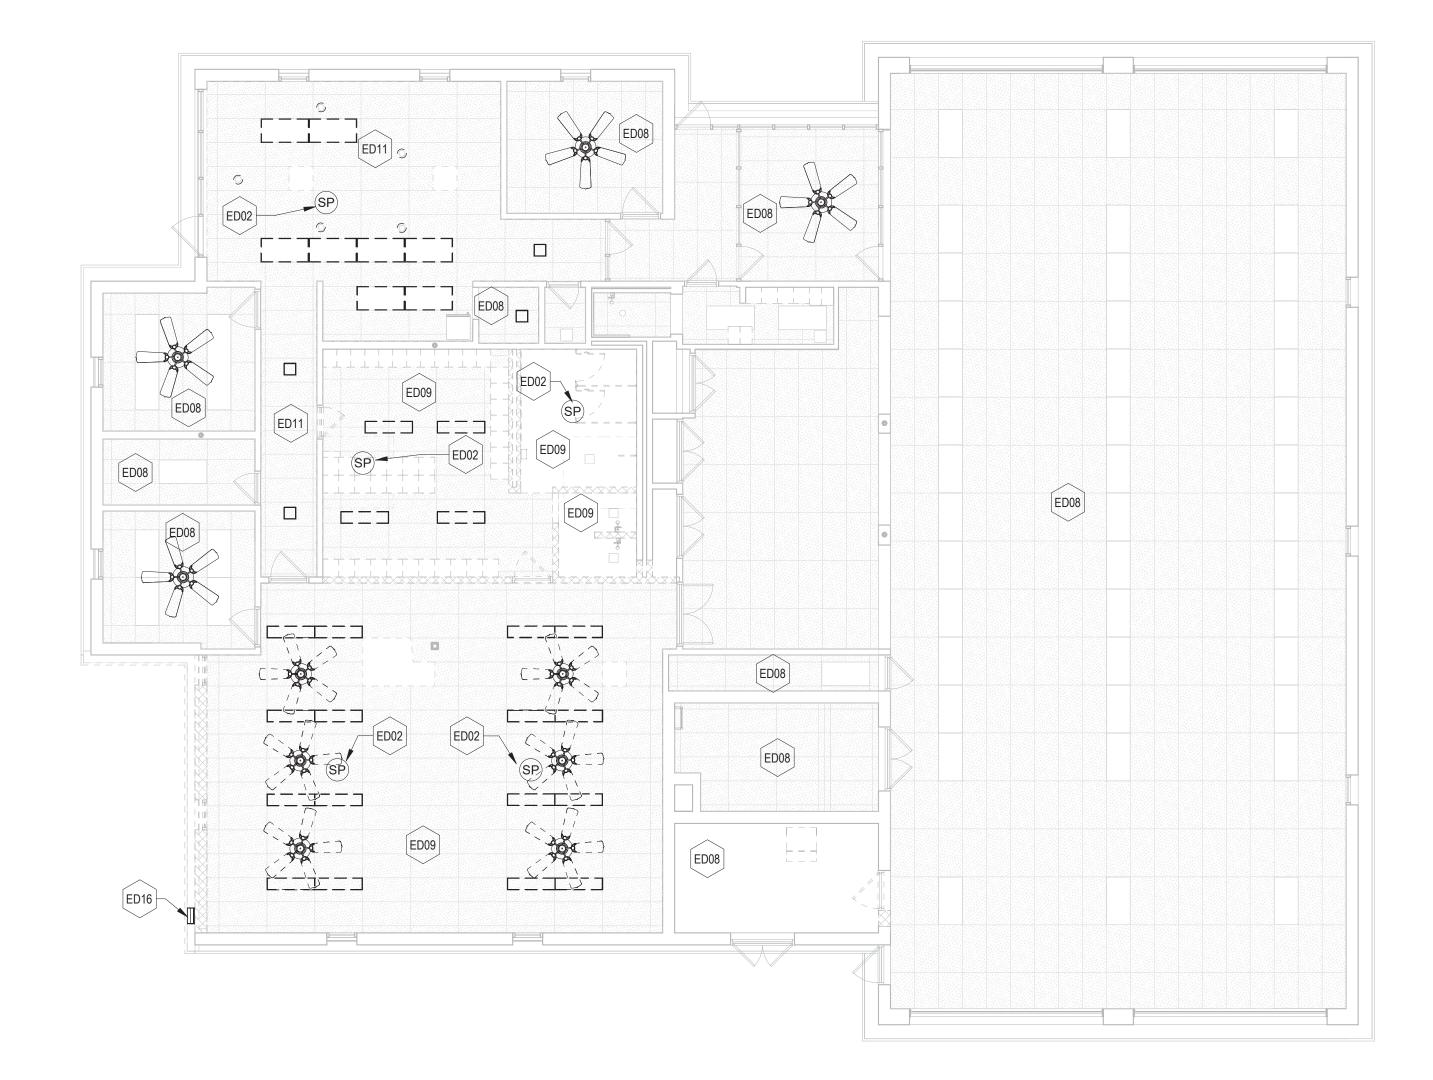

**ELECTRICAL - FIRST FLOOR PLAN - LIGHTING DEMOLITION** 

S	EAL MINIMINA	PROFESSIONAL CERTIFI	CATION	AS-BUILT / RE	VISION	BY	DATE	P.W.A. NO.	KEY SHEET	POSITION SHT	DRAWIN	NG SCALE	
	WILLIAM OF MARY	I HEREBY CERTIFY THAT THESE DOCUMENTS APPROVED BY ME, AND THAT I AM A DULY LIC		BID/PERM	IT		3/01/25	-	MSW	27NE21	PLAN SCALE:	AS INDICATED	APPROVED BY: Mihai T Petrisor
	S. C.	PROFESSIONAL ENGINEER UNDER THE LAWS						R.O.W NO.	]	-			03/26/2025
		MARYLAND. LICENSE NO. 44664 EXPIRATION D	ATE: 06-18-2025					-	] -	-	PROFILE SCALE:	-	DATE:
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	11/1/SIONAL ENGINEER	PRINCIPAL ELECTRICAL ENGINEER  C.C. JOHNSON & MALHOTRA, P.C.	DWN BY: CCJM	REVIEWED BY:									APPROVED BY:
	ATE : 3/01/25	400 EAST PRATT STREET, SUITE 604 BALTIMORE, MARYLAND 21202 (P) 410-461-9920	CHKD BY: CCJM	DATE REVIEWED:									DATE:

BALTIMORE COUNTY OFFICE OF BUDGET AND FINANCE, PROPERTY MANAGEMENT

FULLERTON FIRE STATION #8 - RENOVATION & ADDITION

SUBDIVISION: FULLERTON

LIGHTING - FIRST FLOOR PLAN - DEMOLITION

4401 FITCH AVENUE, NOTTINGHAM, MARYLAND, 21236

ELECTION DIST. NO.: 14C5

SHEET DESIGNATION ED102 JOB ORDER NUMBER 241-220-0054-0012 SHEET 52 of 58 DRAWING NUMBER 2022-2368

FILE NO.: 20-120

**ELECTRICAL DEMOLITION KEYNOTES** 

CABLING AND MAKE READY FOR REINSTALLATION AT NEW LOCATION.

DETERMINE WORKING CONDITIONS.

TO OWNER.

EXISTING INTERCOMMUNICATION DEVICE TO BE RELOCATED TO NEW LOCATION AS

INDICATED ON NEW WORK PLAN. CAREFULLY DISCONNECT DEVICE AND ASSOCIATED

EXISTING LIGHTING FIXTURES, INCLUDING COMBINATION LIGHT AND CEILING FANS, IN THIS AREA AND ASSOCIATED WIRING, CONDUIT, AND LIGHTING CONTROL DEVICES TO REMAIN.

CONTRACTOR TO FIELD VERIFY ALL ELECTRICAL EQUIPMENT AND EXISTING LIGHTING TO

REMOVE EXISTING LIGHTING FIXTURES IN THIS AREA AND ASSOCIATED WIRING, CONDUIT, AND LIGHTING CONTROL DEVICES BACK TO SOURCE. EXISTING COMBINATION LIGHT AND

CEILING FANS IN THE AREA TO BE CAREFULLY REMOVED, SALVAGED, AND RETURNED TO

EXISTING LIGHTING FIXTURES IN THIS AREA ARE TO BE RELOCATED. CAREFULLY REMOVE

LIGHTING CONTROL DEVICE TO REMAIN AND BE REUSED. CONTRACTOR TO COORDINATE

EXISTING OUTDOOR LIGHT FIXTURE TO BE RELOCATED. CAREFULLY DISCONNECT FIXTURE

AND REMOVE ASSOCIATED WIRING AND CONDUIT AS REQUIRED FOR FIXTURE

RELOCATION. SEE NEW WORK PLAN FOR ADDITIONAL INFORMATION.

WITH ARCHITECTURAL DRAWING BEFORE INSTALLATION. EXISTING COMBINATION LIGHT AND CEILING FANS IN THE AREA TO BE CAREFULLY REMOVED, SALVAGED, AND RETURNED


EXISTING LIGHTING FIXTURE AND MAKE READY FOR INSTALLATION AT NEW LOCATION.

REMOVE ASSOCIATED WIRING AND CONDUIT BACK TO JUNCTION POINT. ASSOCIATED

CONTRACT NUMBER

### POWER AND SYSTEMS NEW WORK GENERAL NOTES

- 1. SEE E601 FOR ADDITIONAL POWER AND SYSTEMS NEW WORK GENERAL NOTES.
- THE ELECTRICAL CONTRACTOR SHALL BE RESPONSIBLE FOR VERIFYING THE INTEGRITY AND CONDITION OF THE EXISTING BRANCH CIRCUIT. WIRING IS TO BE REUSED FOR NEW EQUIPMENT CIRCUITING ACCORDING TO THE NATIONAL ELECTRIC CODE. ALL DAMAGED WIRING OR WIRING FOUND TO BE NONFUNCTIONAL SHALL BE REPLACED.
- EXISTING BRANCH CIRCUITS SHALL BE EXTENDED AND CONNECTED TO ALL EXISTING RELOCATED EQUIPMENT, AS REQUIRED FOR A COMPLETE WORKING SYSTEM.
- RECONNECT ALL EXISTING CIRCUITING THAT ORIGINATES OR PASSES THROUGH THE RENOVATED AREAS BUT SERVES OTHER AREAS NOT BEING RENOVATED. EXTEND THESE CIRCUITS AS MAY BE NECESSARY TO THE EXISTING DESIGNATED PANELBOARDS. UTILIZE SPARE CIRCUIT BREAKERS.
- DRAWINGS ARE DIAGRAMMATIC ONLY; EXACT LOCATIONS, MOUNTING HEIGHTS OF EQUIPMENT, AND ROUTING OF RACEWAYS SHALL BE COORDINATED WITH EQUIPMENT SPECIFICATIONS AND
- THE ELECTRICAL CONTRACTOR SHALL FURNISH AND INSTALL ALL INCIDENTAL ACCESSORIES NECESSARY TO MAKE ELECTRICAL WORK COMPLETE AND READY TO OPERATE.
- ALL ELECTRICAL WORK SHALL BE DONE PER THE NATIONAL ELECTRICAL CODE AND LOCAL GOVERNING AUTHORITIES.
- THE ELECTRICAL CONTRACTOR SHALL COORDINATE WITH THE HVAC AND PLUMBING DRAWINGS FOR THE EXACT LOCATION AND ROUGH IN DIMENSIONS; ALL EQUIPMENT SHALL MAKE ALL FINAL POWER CONNECTIONS AS REQUIRED, I.E., POWER, CONTROLS, INTERLOCKS, ETC.

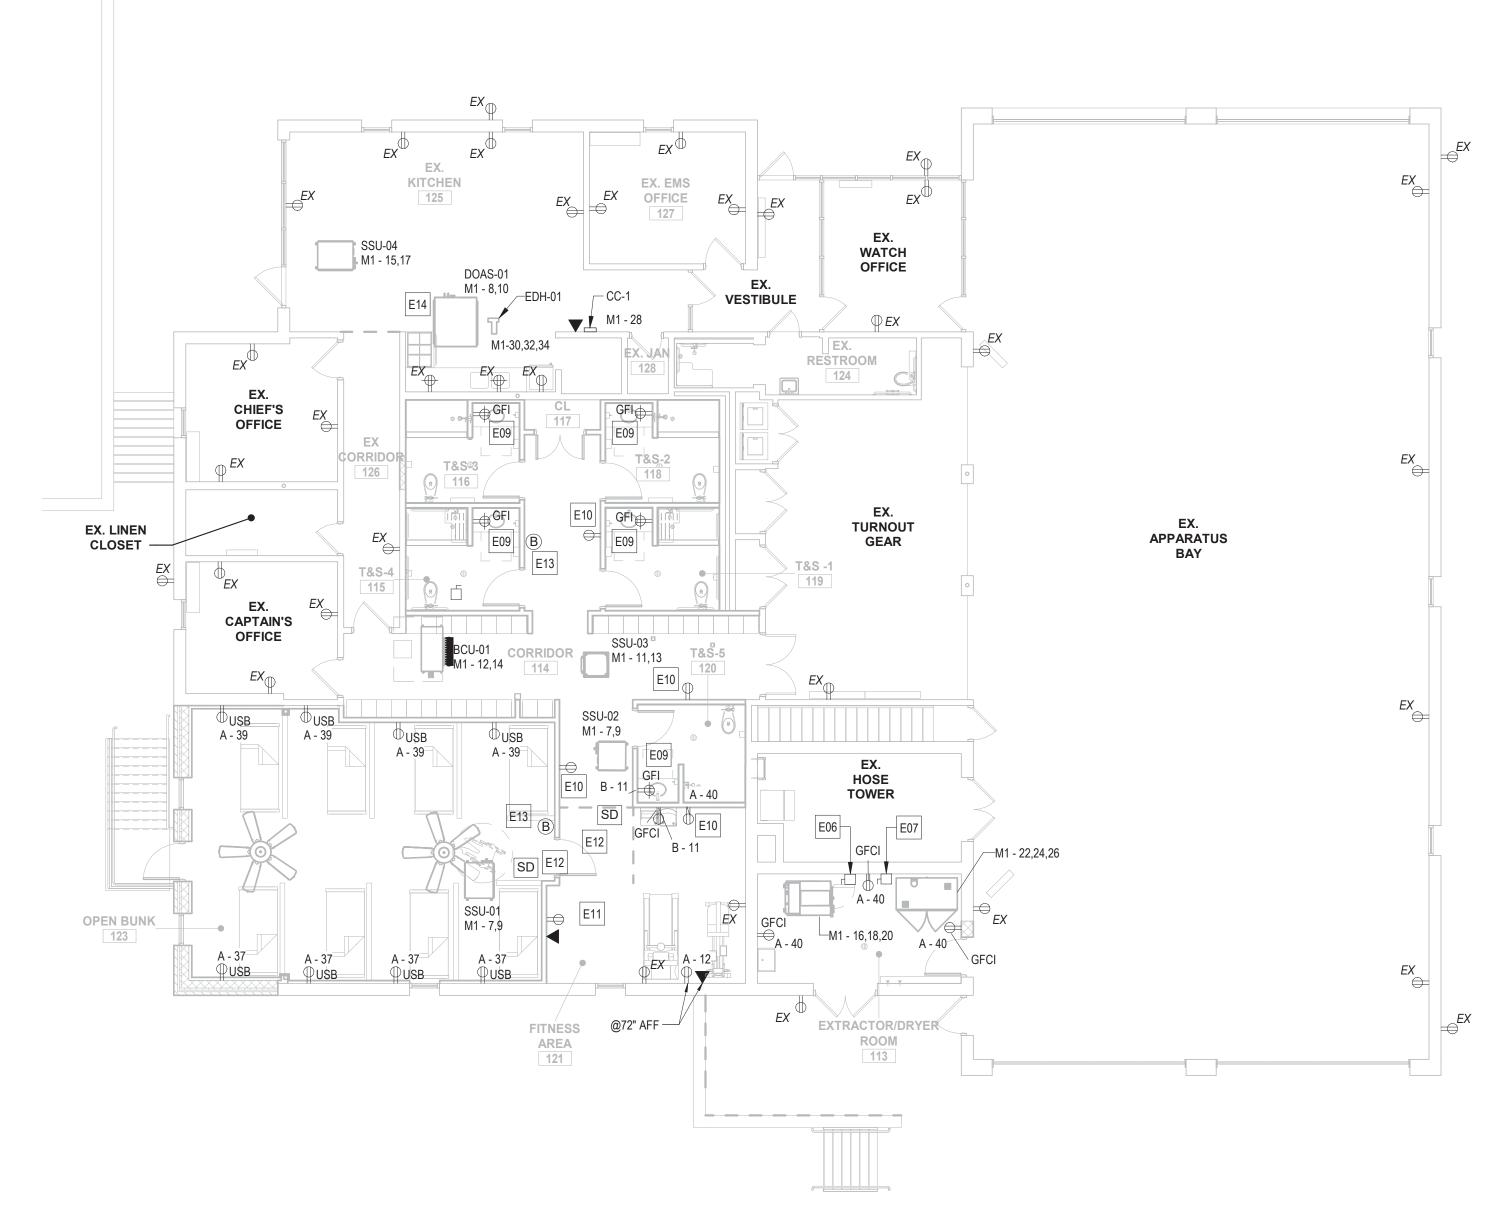

**ELECTRICAL - FIRST FLOOR PLAN - NEW WORK** 

EX. PANEL E EXISTING SERVER LOCATION: POWER MUST BE MAINTAIN AT **MECHANICAL** — EX. PANEL A EX. PANEL MDP -EX. SERVICE DISCONNECT = EX. PANEL CD -EX. UTILITY C/T CABINET EX. ATS -

**ELECTRICAL - BASEMENT FLOOR PLAN - NEW WORK** 

SEAL MINIMINA	PROFESSIONAL CERTIFIC	CATION	AS-BUILT / REVISI	ION	BY I	DATE	P.W.A. NO.	KEY SHEET	POSITION SHT	DRAWIN	IG SCALE	
WILL OF MARY	I HEREBY CERTIFY THAT THESE DOCUMENTS APPROVED BY ME, AND THAT I AM A DULY LIC		BID/PERMIT			3/01/25	-	MSW	27NE21	PLAN SCALE:	AS INDICATED	APPROVED BY: Mihai T Petrisor
No.	PROFESSIONAL ENGINEER UNDER THE LAWS O MARYLAND.						R.O.W NO.	-	-		-	DIRECTO 03/26/2025
		ATE: 06-18-2025					-	-	-	PROFILE SCALE:	-	DATE:
PRO 44864 HOLLINGSIONAL ENGINEERS	ENGINEER:	DGN BY: CCJM	BUREAU OF ENGINEERING AND CONSTRUCTION		HIGHV	WAYS	STRUCTURES	STORM DRAINS	SEWER	WATER	FIELD ENGINEER	PROPERTY MANAGEMENT
MINISONAL ENGINE	PRINCIPAL ELECTRICAL ENGINEER C.C. JOHNSON & MALHOTRA, P.C.	DWN BY: CCJM	REVIEWED BY:									APPROVED BY:
DATE : 3/01/25	400 EAST PRATT STREET, SUITE 604 BALTIMORE, MARYLAND 21202 (P) 410-461-9920	CHKD BY: CCJM	DATE REVIEWED:									DATE:

BALTIMORE COUNTY OFFICE OF BUDGET AND FINANCE, PROPERTY MANAGEMENT

FULLERTON FIRE STATION #8 - RENOVATION & ADDITION

SUBDIVISION: FULLERTON

POWER AND SYSTEMS - FIRST & BASEMENT FLOOR PLANS - NEW WORK

4401 FITCH AVENUE, NOTTINGHAM, MARYLAND, 21236

ELECTION DIST. NO.: 14C5

ELECTRICAL NEW WORK KEYNOTES

PROVIDE 2#12 + 1#12G IN 3/4"C TO AREA GFI BATHROOM RECEPTACLE CIRCUIT.

PROVIDE 2#12 + 1#12G IN 3/4"C FOR RECEPTACLES IN THIS ROOM TO AREA DORM

REINSTALL SALVAGED OR NEW INTERCOMMUNICATION SYSTEM DEVICE, FIRE BELL,

INTERCOMMUNICATION SYSTEM. PROVIDE ADDITIONAL WIRING AND RACEWAYS AS

RECEPTACLE CIRCUIT MADE SPARE DURING DEMOLITION AT PANEL A-17. FIELD VERIFY

COMBINATION SMOKE AND CARBON MONOXIDE DETECTOR. LOCATE DEVICE MINIMUM 3

PROVIDE 15 AMP, 208 VOLT, 2 POLE DISCONNECT AND MOUNT ON THE UNIT OR NEAR THE UNIT, WITH BRANCH CIRCUIT WIRING/RACEWAY AS INDICATED. COORDINATE LOCATION

WITH THE MECHANICAL CONTRACTOR IN THE FIELD BEFORE ROUGH-INS TO MEET ALL THE

FEET AWAY FROM ANY AND ALL CEILING FANS IN THE AREA. CONNECT TO EXISITING SMOKE

DEMOLITION AT PANEL A-15. FIELD VERIFY CIRCUIT LOCATION AND LOAD.

DETECTOR CIRCUIT ON PANEL A WITH 2#12 +1#12G IN 3/4"C.

COMPATIBLE WITH EXISTING SYSTEM AND RECONNECT TO EXISTING

REQUIRES FOR A COMPLETE AND FULLY OPERATIONAL SYSTEM.

ENCLOSURE, FUSED @ 35A, FOR DRYER.

WORKING CLEARANCE REQUIREMENTS

CIRCUIT LOCATION AND LOAD.

PROVIDE AND INSTALL 3 PHASE, 30A, 208V, FUSIBLE DISCONNECT SWITCH IN NEMA 4X ENCLOSURE, FUSED @ 15A, FOR WASHER EXTRACTOR.


PROVIDE AND INSTALL 3 PHASE, 60A, 208V, FUSIBLE DISCONNECT SWITCH IN NEMA 4X

PROVIDE 2#12 + 1#12G IN 3/4"C TO AREA DORM RECEPTACLE CIRCUIT MADE SPARE DURING

FILE NO.: 20-120

SHEET DESIGNATION

CONTRACT NUMBER 25034 PF0 RE-BID JOB ORDER NUMBER 241-220-0054-0012 SHEET 53 of 58 DRAWING NUMBER 2022**-**2369

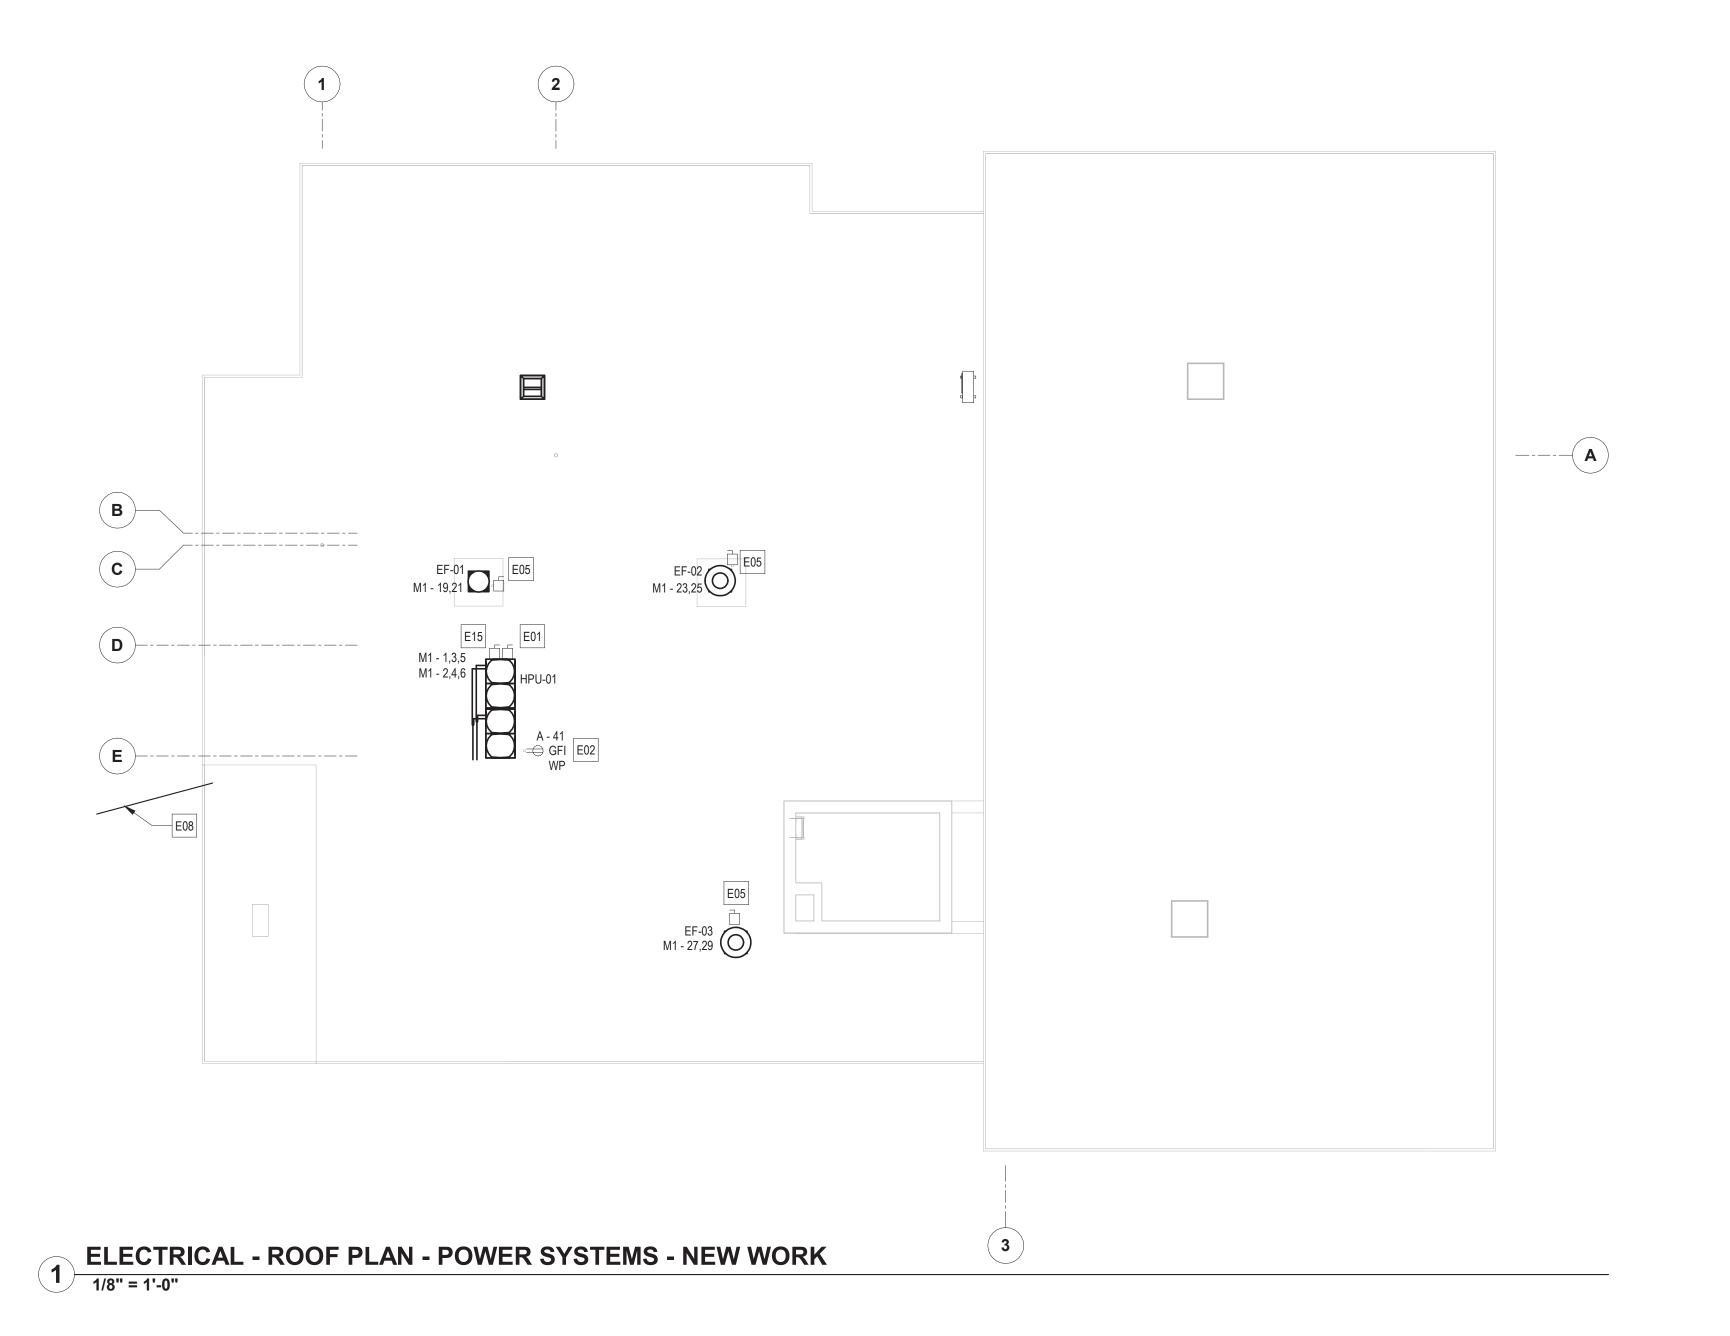

BY DATE P.W.A. NO. KEY SHEET POSITION SHT

PLAN SCALE:

WATER FIELD ENGINER

	ELECTRICAL NEW WORK KEYNOTES
E01	FURNISH AND INSTALL 3 PHASE, 100A, 208V, FUSIBLE DISCONNECT SWITCH IN NEMA 3R ENCLOSURE, FUSED AT 90A. PROVIDE INDEPENDANT SUPPORTS.
E02	PROVIDE INDEPENDENT SUPPORTS FOR ROOFTOP RECEPTACLE. PROVIDE 2#12 + 1#12G IN 3/4"C TO PANEL AS INDICATED.
E05	PROVIDE AND INSTALL 1 PHASE, 30A, 208V, NON-FUSIBLE DISCONNECT SWITCH IN NEMA 3R ENCLOSURE, FOR EXHAUST FAN.
E08	RECONNECT EXISTING CABLING TO ASSOCIATED TERMINATION POINTS. PROVIDE ADDITIONAL CONNECTORS, SPLITTERS, AND COMPATIBLE ACCESSORIES AS REQUIRED TO RESTORE CONTINUITY OF CABLING TO ASSOCIATED TERMINATION POINTS. COORDINATE EXACT ROUTING OF CABLING IN THE FIELD.
E15	FURNISH AND INSTALL 3 PHASE, 100A, 208V, FUSIBLE DISCONNECT SWITCH IN NEMA 3R

### POWER AND SYSTEMS NEW WORK GENERAL NOTES

- 1. SEE E601 FOR ADDITIONAL POWER AND SYSTEMS NEW WORK GENERAL NOTES.
- 2. THE ELECTRICAL CONTRACTOR SHALL BE RESPONSIBLE FOR VERIFYING THE INTEGRITY AND CONDITION OF THE EXISTING BRANCH CIRCUIT. WIRING IS TO BE REUSED FOR NEW EQUIPMENT CIRCUITING ACCORDING TO THE NATIONAL ELECTRIC CODE. ALL DAMAGED WIRING OR WIRING FOUND TO BE NONFUNCTIONAL SHALL BE REPLACED.

ENCLOSURE, FUSED AT 80A. PROVIDE INDEPENDANT SUPPORTS.

- EXISTING BRANCH CIRCUITS SHALL BE EXTENDED AND CONNECTED TO ALL EXISTING RELOCATED EQUIPMENT, AS REQUIRED FOR A COMPLETE WORKING SYSTEM.
- RECONNECT ALL EXISTING CIRCUITING THAT ORIGINATES OR PASSES THROUGH THE RENOVATED AREAS BUT SERVES OTHER AREAS NOT BEING RENOVATED. EXTEND THESE CIRCUITS AS MAY BE NECESSARY TO THE EXISTING DESIGNATED PANELBOARDS. UTILIZE SPARE CIRCUIT BREAKERS.
- DRAWINGS ARE DIAGRAMMATIC ONLY; EXACT LOCATIONS, MOUNTING HEIGHTS OF EQUIPMENT, AND ROUTING OF RACEWAYS SHALL BE COORDINATED WITH EQUIPMENT SPECIFICATIONS AND FIELD CONDITIONS.
- 6. THE ELECTRICAL CONTRACTOR SHALL FURNISH AND INSTALL ALL INCIDENTAL ACCESSORIES NECESSARY TO MAKE ELECTRICAL WORK COMPLETE AND READY TO OPERATE.
- 7. ALL ELECTRICAL WORK SHALL BE DONE PER THE NATIONAL ELECTRICAL CODE AND LOCAL GOVERNING AUTHORITIES.
- 8. THE ELECTRICAL CONTRACTOR SHALL COORDINATE WITH THE HVAC AND PLUMBING DRAWINGS FOR THE EXACT LOCATION AND ROUGH IN DIMENSIONS; ALL EQUIPMENT SHALL MAKE ALL FINAL POWER CONNECTIONS AS REQUIRED, I.E., POWER, CONTROLS, INTERLOCKS, ETC.

BALTIMORE COUNTY OFFICE OF BUDGET AND FINANCE, PROPERTY MANAGEMENT	
FULLERTON FIRE STATION #8 - RENOVATION & ADDITION	
POWER AND SYSTEMS - ROOF PLAN - NEW WORK	
4401 FITCH AVENUE, NOTTINGHAM, MARYLAND, 21236	ELECTION

SHEET DESIGNATION | CONTRACT NUMBER 25034 PF0 RE-BID JOB ORDER NUMBER  $241 \hbox{--} 220 \hbox{--} 0054 \hbox{--} 0012$ SHEET 54 of 58 DRAWING NUMBER 2022-2370

FILE NO.: 20-120

ION DIST. NO.: 14C5

BID/PERMIT I HEREBY CERTIFY THAT THESE DOCUMENTS WERE PREPARED OR APPROVED BY ME, AND THAT I AM A DULY LICENSED PROFESSIONAL ENGINEER UNDER THE LAWS OF THE STATE OF R.O.W NO. LICENSE NO. 44664 HIGHWAYS STRUCTURES STORM DRAINS SEWER 'A CHIH LIN. PE REVIEWED BY: C.C. JOHNSON & MALHOTRA, P.C. 400 EAST PRATT STREET, SUITE 604 BALTIMORE, MARYLAND 21202

PROFESSIONAL CERTIFICATION

AS-BUILT / REVISION

DATE REVIEWED:

SUBDIVISION: FULLERTON


APPROVED BY: Mihai T Petrisor
DIRECTOR

PROPERTY MANAGEMENT

03/26/2025

### LIGHTING NEW WORK GENERAL NOTES

- 1. THE ELECTRICAL CONTRACTOR SHALL PROVIDE ALL LIGHTING FIXTURES COMPLETE WITH MOUNTING ACCESSORIES TO MEET JOB REQUIREMENTS.
- 2. THE ELECTRICAL CONTRACTOR SHALL VERIFY FIXTURE MOUNTING AND LOCATION WITH AN ARCHITECTURAL REFLECTED CEILING PLAN. CONFIRM THE EXACT LOCATION OF ALL FIXTURES WITH THE ARCHITECT BEFORE ROUGHING IN.
- REFER TO LIGHTING FIXTURE SCHEDULE ON ELECTRICAL DRAWING E601 FOR LIGHTING ELECTRICAL SPECIFICATIONS, VOLTAGE, AND LAMP REQUIREMENTS.

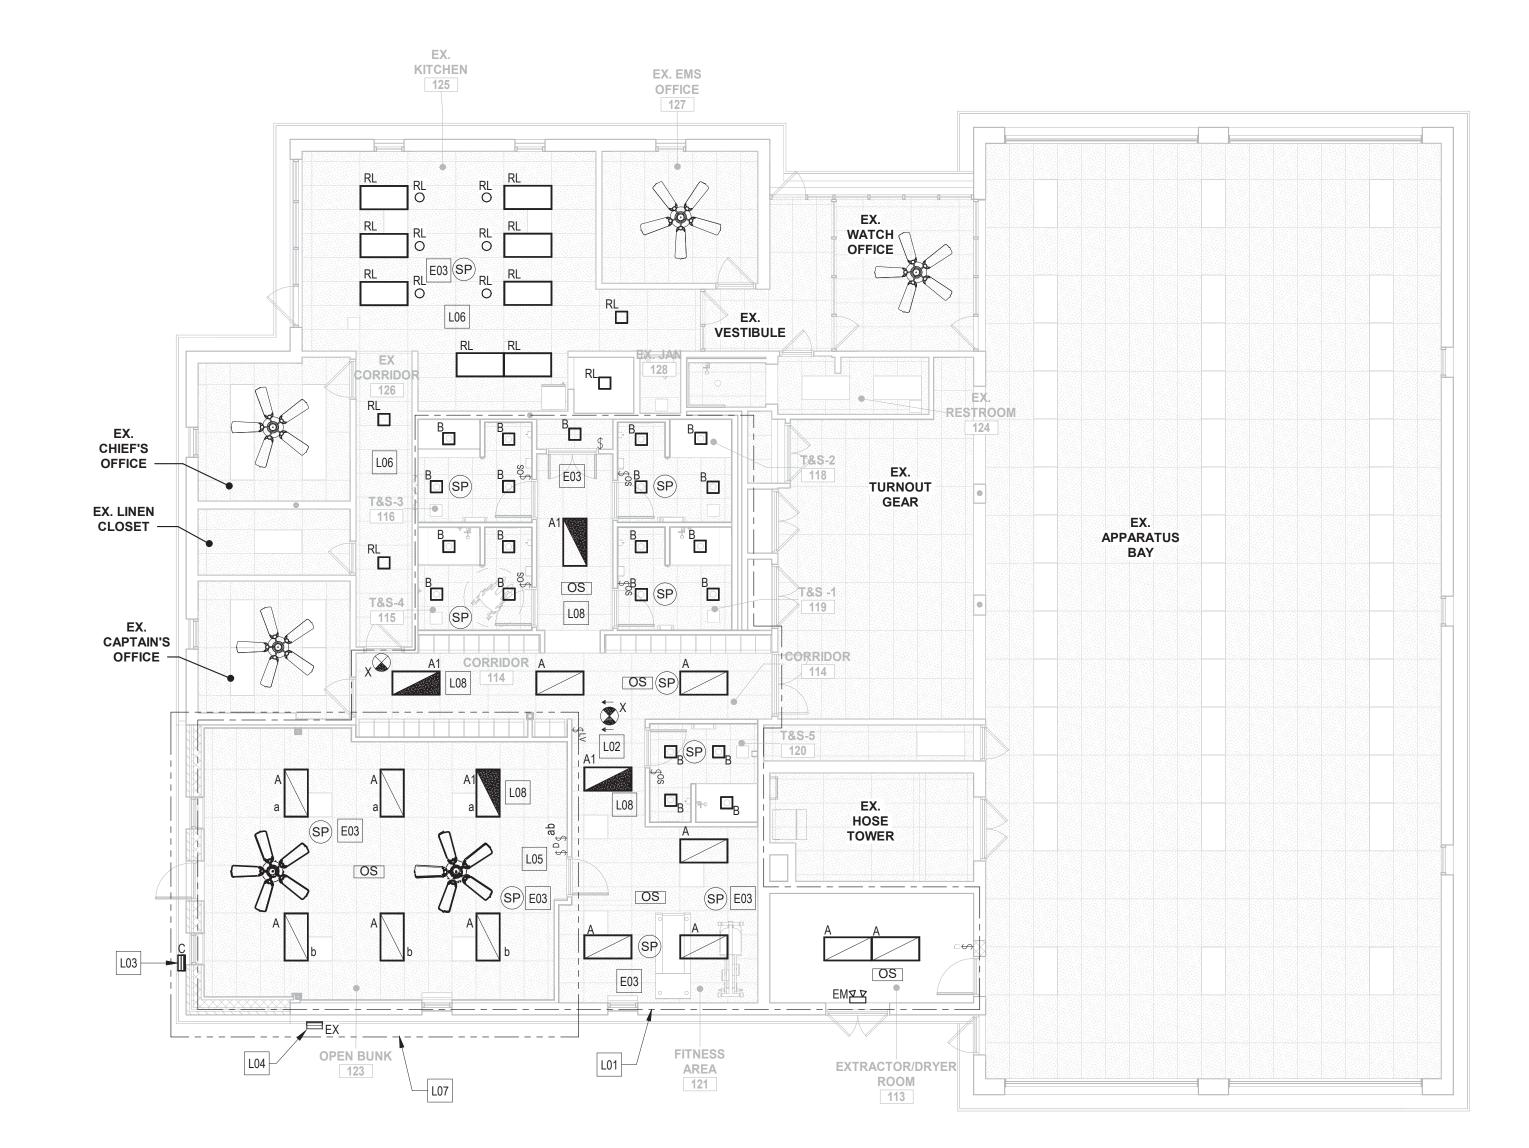

1 ELECTRICAL - FIRST FLOOR PLAN - LIGHTING NEW WORK

SEAL MINIMULA	PROFESSIONAL CERTIFIC	CATION	AS-BUILT / REV	ISION	BY	DATE	P.W.A. NO.	KEY SHEET	POSITION SHT	DRAWIN	IG SCALE	
WILL OF MARY	I HEREBY CERTIFY THAT THESE DOCUMENTS APPROVED BY ME, AND THAT I AM A DULY LIC		BID/PERMI	Т		3/01/25	-	MSW	27NE21	PLAN SCALE:	AS INDICATED	APPROVED BY: Mihai T Potrisor
S TO THE STATE OF	PROFESSIONAL ENGINEER UNDER THE LAWS O MARYLAND.						R.O.W NO.	-	-		-	DIRECTO 03/26/2025
S		ATE: 06-18-2025					-	-	-	PROFILE SCALE:	-	DATE: 03/20/2023
	ENGINEER: TA CHIH LIN, PE	DGN BY: CCJM	BUREAU OF ENGINEERING AND CONSTRUCTION		HIGH	WAYS	STRUCTURES	STORM DRAINS	SEWER	WATER	FIELD ENGINEER	PROPERTY MANAGEMENT
PROPERTY A4864	PRINCIPAL ELECTRICAL ENGINEER  C.C. JOHNSON & MALHOTRA, P.C.	DWN BY: CCJM	REVIEWED BY:									APPROVED BY:CHII
DATE : 3/01/25	400 EAST PRATT STREET, SUITE 604 BALTIMORE, MARYLAND 21202 (P) 410-461-9920	СНКО ВҮ: ССЈМ	DATE REVIEWED:									DATE:

### **ELECTRICAL NEW WORK KEYNOTES**

REINSTALL SALVAGED OR NEW INTERCOMMUNICATION SYSTEM DEVICE COMPATIBLE WITH EXISTING SYSTEM AND RECONNECT TO EXISTING INTERCOMMUNICATION SYSTEM. PROVIDE ADDITIONAL WIRING AND RACEWAYS AS REQUIRES FOR A COMPLETE AND FULLY OPERATIONAL SYSTEM.

	LIGHTING NEW WORK KEYNOTES
L01	PROVIDE 2#12 + 1#12G IN 3/4"C TO EXISTING AREA LIGHTING CIRCUIT IN THIS AREA UNLESS FIXTURE IS DESIGNATED AS AN EMERGENCY OR EXIT LIGHT FIXTURE.
L02	EMERGENCY OR EXIT LIGHT FIXTURE. PROVIDE 2#12 + 1#12G IN 3/4"C TO EXISTING AREA EMERGENCY LIGHTING CIRCUIT.
L03	CONNECT NEW EXTERIOR LIGHT FIXTURE TO EXISTING 120V, EXTERIOR LIGHTING BRANCH CIRCUIT WITH 2#12 + 1#12G IN 3/4"C. ELECTRICAL CONTRACTOR SHALL VERIFY FIXTURE MOUNTING HEIGHT AND LOCATION WITH ARCHITECTURAL PLANS. EXACT LOCATION OF ALL FIXTURES SHALL BE CONFIRMED PRIOR TO BID.
L04	EXISTING EXTERIOR FIXTURE AT NEW LOCATION. SPLICE, EXTEND, AND PROVIDE WIRING AND CONDUIT TO EXISTING EXTERIOR LIGHTING CIRCUIT. WIRING AND CONDUIT TO EQUAL EXISTING BUT NOT LESS THAN WHAT IS REQUIRED BY THE NEC. LIGHTING CONTROL TO BE RESTORED TO EXISTING OPERATIONAL CONDITION AND SCHEDULE.
L05	PROVIDE 120V WALL CONTROL BY FAN SUPPLIER FOR CEILING FAN(S) INSTALLED IN THIS AREA. SEE MECHANICAL DRAWINGS FOR CEILING FAN EXACT MOUNTING LOCATIONS AND SPECIFICATIONS.
L06	REINSTALL EXISTING LIGHTING FIXTURES IN THIS AREA AT NEW LOCATIONS AT NEW CEILING AS INDICATED. PROVIDE 2#12 + 1#12G IN 3/4"C TO EXISTING AREA LIGHTING CIRCUIT. RECONNECT FIXTURES TO ASSOCIATED LIGHTING CONTROL DEVICES. LIGHTING CONTROL SCHEME TO MATCH EXISTING.
L07	PROVIDE CONTROL RELAY FOR LIGHTING FIXTURES IN THIS AREA TO CONTROL LIGHTS VIA FIREMAN'S MASTER CONTROL STATION.
L08	EMERGENCY LIGHT FIXTURE WITH UL924 GENERATOR TRANSFER DEVICE ON LOCAL AREA CONTROL. PROVIDE 2#12 + 1#12G IN 3/4"C FOR NORMAL POWER OF FIXTURE TO AREA LIGHTING CIRCUIT. PROVIDE 2#12 + 1#12G IN 3/4"C FOR EMERGENCY POWER OF FIXTURE TO UNSWITCHED AREA EMERGENCY LIGHTING CIRCUIT. UPON NORMAL POWER LOSS,

EMERGENCY LIGHTING FIXTURE TO BE POWERED TO FULL ILLUMINATION.

SHEET DESIGNATION | CONTRACT NUMBER


FULLERTON FIRE STATION #8 - RENOVATION & ADDITION

LIGHTING - FIRST FLOOR PLAN - NEW WORK

BALTIMORE COUNTY OFFICE OF BUDGET AND FINANCE, PROPERTY MANAGEMENT

JOB ORDER NUMBER 241-220-0054-0012 SHEET 55 of 58 DRAWING NUMBER 2022-2371 FILE NO.: 20-120

4401 FITCH AVENUE, NOTTINGHAM, MARYLAND, 21236 SUBDIVISION: FULLERTON ELECTION DIST. NO.: 14C5

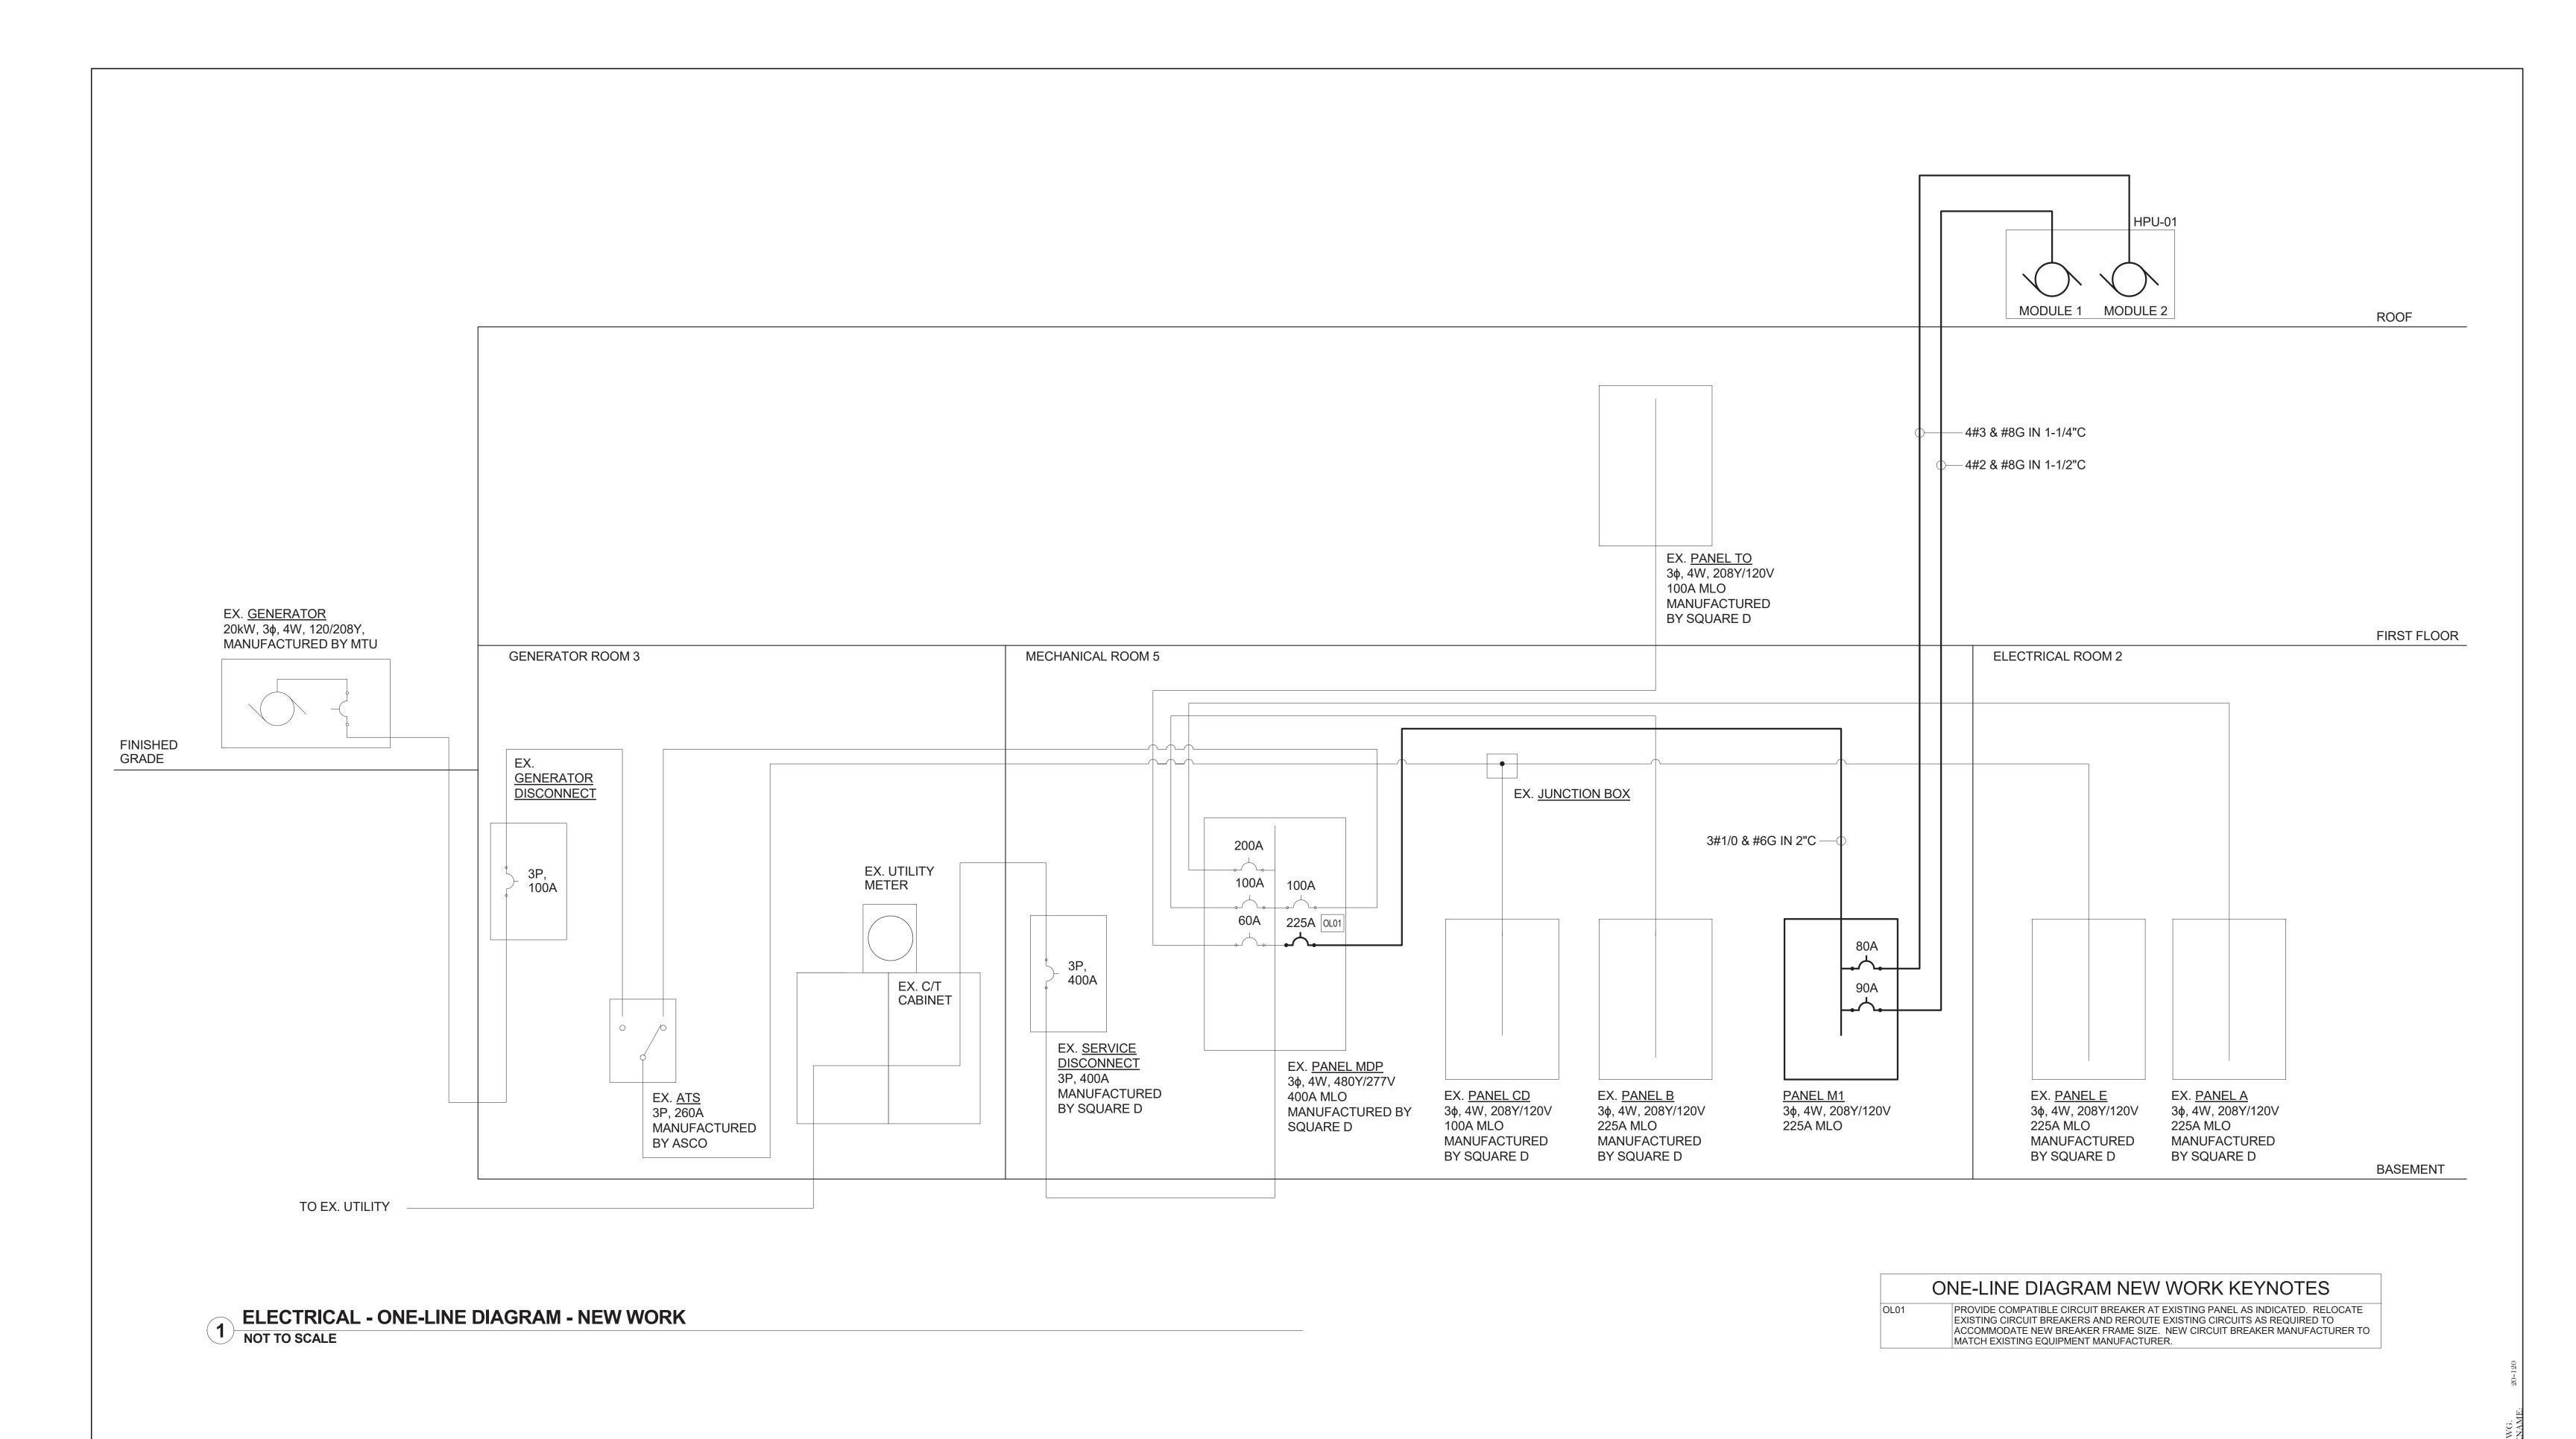

SUBDIVISION: FULLERTON

PROFESSIONAL CERTIFICATION AS-BUILT / REVISION BY DATE P.W.A. NO. KEY SHEET POSITION SHT DRAWING SCALE APPROVED BY:\_Mihai T Petrisor BID/PERMIT HEREBY CERTIFY THAT THESE DOCUMENTS WERE PREPARED OR PLAN SCALE: APPROVED BY ME, AND THAT I AM A DULY LICENSED PROFESSIONAL ENGINEER UNDER THE LAWS OF THE STATE OF R.O.W NO. 03/26/2025 MARYLAND. LICENSE NO. 44664 EXPIRATION DATE: 06-18-2025 BUREAU OF ENGINEERING AND CONSTRUCTION NGINEER: \_\_\_\_\_ HIGHWAYS STRUCTURES STORM DRAINS SEWER WATER FIELD ENGINEE PROPERTY MANAGEMENT 'A CHIH LIN. PE REVIEWED BY: APPROVED BY: C.C. JOHNSON & MALHOTRA, P.C. 00 EAST PRATT STREET, SUITE 604 ALTIMORE, MARYLAND 21202 DATE REVIEWED:

FULLERTON FIRE STATION #8 - RENOVATION & ADDITION

ELECTRICAL RISER DIAGRAM

4401 FITCH AVENUE, NOTTINGHAM, MARYLAND, 21236

BALTIMORE COUNTY OFFICE OF BUDGET AND FINANCE, PROPERTY MANAGEMENT

ELECTION DIST. NO.: 14C5

E501

25034 PF0 RE-BID JOB ORDER NUMBER  $241 \hbox{-} 220 \hbox{-} 0054 \hbox{-} 0012$ SHEET 56 of 58 DRAWING NUMBER 2022-2372

SHEET DESIGNATION | CONTRACT NUMBER

FILE NO.: 20-120

Ex. Branch Panel: A  Location: ELECTRICAL RM 2  Supply From:  Mounting: Surface	Volts: 120/208 Wye Phases: 3 Wires: 4	A.I.C. Rating: 10 kAIC  Mains Type: MLO  Mains Rating: 225 A	Sup	anel: B  Location: MECHANICAL RM 5 ply From: Mounting: Surface	Volts: 120/208 Wye Phases: 3 Wires: 4	A.I.C. Rating: 10 kAIC  Mains Type: MLO  Mains Rating: 100 A	Ex. Branch	Panel: E  Location: ELECTRICAL RM 2  Supply From:  Mounting: Surface	Volts: 120/20 Phases: 3 Wires: 4	08 Wye	A.I.C. Rating: 10 Mains Type: ML Mains Rating: 22	_0
Enclosure: Type 1	WIIeS. 4	MCB Rating: N/A		inclosure: Type 1	WHES. 4	MCB Rating: N/A		Enclosure: Type 1	Wiles. 4		MCB Rating: N/	
<b>Notes:</b> SUPPLIED FROM 3P, 200A BREAKER AT PANEL MDP			Notes: SUPPLIED FROM 3P, 100A BREAK	ER AT PANEL MDP			Notes: PANEL BACKED UP BY EXISTIN	NG 30KW GENERATOR. SUPPLIED FROM 3P, 100A C	IRCUIT BREAKER AT PANEL I	MDP. BREAKER IS SHARE	ED WITH EXISTING PANEL CD.	
1 DORM CEILING 2 3 FIRE WATCH RECEPTACLE 2 5 LOCKER RECEPTACLE 2 7 REC ROOM RECETACLE 2 9 HEATER 2 11 1 13 UNIT HEATER #1 2 15 DORM RECEPTACLE 2 17 DORM RECEPTACLE 2 18 DORM RECEPTACLE 2 19 DORM RECEPTACLE 2 21 SHOP RECEPTACLE 2 22 SHOP RECEPTACLE 2 23 EQUIP. RECEPTACLE 2 25 UNIT HEATER #2 2 26 UNIT HEATER #2 2 27 SMOKE DETECTOR 2 28 KITCHEN HOOD FAN 2 31 REFRIGERATOR 2 33 KITCHEN RECEPTACLE(S) 2 34 WATER COOLER 2 37 RECEP. OPEN BUNK 123 1-#12, 1-#12, 1-#12 3/4" 2 39 RECEP. OPEN BUNK 123 1-#12, 1-#12, 1-#12 3/4" 2 41 ROOFTOP RECEPT. 1-#12, 1-#12, 1-#12 3/4" 2	) A 1 720 VA 720 VA 1	20 A TOWER LIGHTING 2 20 A TOWER LIGHTING 4 20 A FIRE WATCH LIGHT 6 20 A MICROWAVE 8 20 A ICE MAKER 10 20 A ICE MAKER 10 20 A HALLWAY LIGHTS 10 20 A DRIVER'S ROOM LIGHTS 10 20 A DRIVEWAY LIGHTS 10 20 A CHIEF'S ROOM LIGHTS 20 20 A CAPTAIN ROOM LIGHTS 20 20 A LIGHTS 20 20 A LIGHTS 20 20 A LIGHTS 20 20 A DRIVEWAY LIGHTS 20 20 A CAPTAIN ROOM LIGHTS 20 20 A LIGHTS 20 20 A LIGHTS 20 20 A LIGHTS 30 20 A CAPTAIN ROOM LIGHTS 30 20 A CAPTAIN ROOM LIGHTS 30 20 A REC ROOM LIGHTS 30 20 A 3/4" 1-#12, 1-#12, 1-#12 EWC-1 EXERCISE 106 20 A 3/4" 1-#12, 1-#12, 1-#12 RECEPTACLES 106, 105	1 BASMENT UNIT HEATER 3 EQUIP. AREA UNIT 5 SPARE 7 EQUIP. AREA UNIT 9 EXISTING LOAD 11 RECEPTACLES 105, 106 13 SPARE 15 SPARE 15 SPARE 17 EXISTING LOAD 0 19 SPARE 21 SPARE 22 SPARE 23 SPARE 24 23 SPARE 25 HEATING UNIT 27 HEATING UNIT 27 HEATING UNIT 29 21 SPACE 31 FLOOD LIGHTS 33 66 SPACE 37 SPACE 39 SPARE	Wire Size         Conduit Size         Trip         Poles            20 A         1         0 VA            20 A         2         0 VA              0 VA              0 VA              0 VA              0 VA              0 VA             0 VA	0 VA 0 VA 1 0 VA 1 0 VA 0 VA 0 VA 0 VA 2 0 VA 0 VA 2 0 VA 0 VA 2 0 VA	20 A BATHROOM GFI 20 A BATHROOM HEATER 20 A EXHAUST FAN 20 A SPARE 20 A SPARE 20 A RECEPTACLES 20 A BOILER ROOM 20 A RECETACLES 20 A BOILER ROOM 20 A EXHAUST FAN 20 A SPACE 20 A SPACE 20 A EXISTING LOAD 20 A EXISTING LOAD 20 A EXISTING LOAD	CKT         Circuit Description           1         DORM LIGHTS           4         3         REC ROOM           6         5         CAPTIAN ROOM LIGHTS           8         7         DRIVEWAY LIGHTS           10         9         CANOPY LIGHTS           12         11         RELAY CABINET (LOW           14         13         EMERGENCY           16         15         TURRET           18         17         EXIT LIGHT           20         19         TELEPHONE RECETPACE           22         21         RACK RECEPTACLE           23         SUB PANEL BOILER           26         25            28         27         MOTORIZED DOOR           30         29            32         31         UNKNOWN CIRCUIT           34         35            38         37         UNKNOWN CIRCUIT           40         42         41	20 A 1 20 A 2 0 40 A 2 0 20 A 3 0	VA 0 VA 0 VA 0 VA 0 VA	0 VA 0 VA 1 A 1 A 2 0 VA 0 VA 1 A 2 0 VA 0 VA A 0 VA 0 VA A 0 VA 0 VA A 1 1 0 VA 0 VA 1 3 A 0 VA 0 VA 1	20 A	Circuit Description LOCKER ROOM LIGHTS HALLWAY EMER. LIGHTS DRIVER LIGHTS DRIVER LIGHTS CANOPY LIGHTS LIGHTS CHIEF ROOM LIGHTS FIRE WATCH ELECTRIC HEATING UNI AIR COMPRESSOR MODEM HPDNET MAIN TOILET OVERHEA UNKNOWN CIRCUIT UNKNOWN CIRCUIT
gend:	·		Legend:	·			Legend:	·				
	onnected Load Demand Factor Estimated Demand	Panel Totals	Load Classification	Connected Load	Demand Factor Estimated Demand	Panel Totals	Load Classification	Connected Load	Demand Factor	Estimated Demand		Panel Totals
AC hting wer ceptacle	0 VA     0.00%     0 VA       0 VA     0.00%     0 VA       0 VA     0.00%     0 VA       2520 VA     100.00%     2520 VA	Total Conn. Load: 2890 VA Total Est. Demand: 2890 VA Total Conn.: 8 A Total Est. Demand: 8 A	HVAC Lighting Power Receptacle	0 VA 0 VA 0 VA 380 VA	0.00%     0 VA       0.00%     0 VA       0.00%     0 VA       100.00%     380 VA	Total Conn. Load: 380 VA Total Est. Demand: 380 VA Total Conn.: 1 A Total Est. Demand: 1 A	HVAC Lighting Power Receptacle	0 VA 0 VA 0 VA 0 VA	0.00% 0.00% 0.00% 0.00%	0 VA 0 VA 0 VA 0 VA	Total Conn. I Total Est. Den Total C Total Est. Den	nand: 0 VA
Panelboard MDP	PROVIDED FOR INFORMATIONAL PURPOSES. FIELD VERIFY AND CON		Branch P	anel: M1		FIRM EXISTING LOADS PRIOR TO COMMENCING WORK.	Notes: LOADS BASED ON FIELD SURV	VEY OF PANEL SCHEDULE AND ARE PROVIDED FOR	INFORMATIONAL PURPOSES	S. FIELD VERIFY AND COI	NFIRM EXISTING LOADS PRIOR T	O COMMENCING WORK.
Location: MECHANICAL RM 5 Supply From:	Volts: 120/208 Wye Phases: 3	A.I.C. Rating:  Mains Type: MLO		Location: MECHANICAL RM 5 ply From: PANEL MDP	Volts: 120/208 Wye Phases: 3	A.I.C. Rating: 22KAIC  Mains Type: MLO						
<b>Mounting:</b> Surface <b>Enclosure:</b> Indoor	Wires: 4	Mains Rating: 400 A MCB Rating: 400 A		Mounting: Surface inclosure: Type 1	Wires: 4	Mains Rating: 225 A  MCB Rating: N/A						
lotes: 00A SERVICE DISCONNECT			Notes:	Totalia. Type T		mos rading. 14/7						
JUA SERVICE DISCONNECT												
				Condui		Condui						
1 PANEL A 2 PANEL B		P Rating Load Remarks 200 A 2890 VA DOUBLE WIDTH BREAKER 100 A 380 VA	CKT   Circuit Description	Wire Size         t Size         Trip         Poles           3-#2, 1-#2, 1-#8         1-1/2"         90 A         3         6845 VA	6365 3 6845 VA 6365 VA	Trip         t Size         Wire Size         Circuit Description           80 A         1-1/4"         3-#3, 1-#3, 1-#8         HPU-01 (MODULE 2)	2 4					
1 PANEL A 2 PANEL B 3 PANEL E & PANEL CD VIA ATS 4 GAS RANGE	3 2 3 3 3	200 A 2890 VA DOUBLE WIDTH BREAKER  100 A 380 VA  100 A 0 VA  20 A 0 VA	1 HPU-01 (MODULE 1) 3 5 7 SSU - 01, 02	3-#2, 1-#2, 1-#8	6365	80 A 1-1/4" 3-#3, 1-#3, 1-#8 HPU-01 (MODULE 2) 15 A 3/4" 2-#14, 1-#14, 1-#14 DOAS - 01	2 4 6 8 10					
1 PANEL A	3 2 3 3 3 3 3 3	200 A 2890 VA DOUBLE WIDTH BREAKER 100 A 380 VA 100 A 0 VA	1 HPU-01 (MODULE 1) 3 5	3-#2, 1-#2, 1-#8 1-1/2" 90 A 3 6845 VA	3 3 43 VA 343 VA 55 VA 66 VA 67 C 75 VA 86 VA 2	80 A 1-1/4" 3-#3, 1-#3 HPU-01 (MODULE 2)	CKT   2   4   6   8   10   12   14					

CKT	Circuit Description	# of Poles	Frame Size	Trip Rating	Load	Remarks
1	PANEL A	3		200 A	2890 VA	DOUBLE WIDTH BREAKER
2	PANEL B	3		100 A	380 VA	
3	PANEL E & PANEL CD VIA ATS	3		100 A	0 VA	
4	GAS RANGE	3		20 A	0 VA	
5	TOWER FAN	3		60 A	0 VA	
6	PANEL TO (TURNOUT)	3		60 A	0 VA	
7	AC-2 (DORM)	3		60 A	0 VA	
8	AC-1 (KITCHEN)	3		30 A	0 VA	
9	SPARE	3		30 A	0 VA	
10	PANEL M1	3		225 A	60213 VA	
11						
12						
13						
14						
		<u>'</u>	Tot	al Conn. Load:	63483 VA	

Load Classification	Connected Load	Demand Factor	Estimated Demand	Panel	Totals
Equipment	0 VA	0.00%	0 VA		
HVAC	0 VA	0.00%	0 VA	Total Conn. Load:	63483 VA
Lighting	0 VA	0.00%	0 VA	Total Est. Demand:	63483 VA
Other	0 VA	0.00%	0 VA	Total Conn.:	176 A
Power	0 VA	0.00%	0 VA	Total Est. Demand:	176 A

0.00%

0 VA

0 VA

Receptacle

Notes:						
EXISTING LOADS BASED ON FIELD SURVEY OF PANEL SCHEDULE AND	ARE PROVIDED FOR	INFORMATIONAL PUI	RPOSES. I	FIELD VERIFY AND C	ONFIRM EXISTING	LOADS
PRIOR TO COMMENCING WORK.						

				Condui											Condui			
С	KT Circuit Descri	ption Wire	e Size	t Size	Trip	Poles	Α			3		С	Poles	Trip	t Size	Wire Size	Circuit Description	CKT
	1 HPU-01 (MODULE	1) 3-#2, 1-	-#2, 1-#8	1-1/2"	90 A	3	6845 VA	45 VA 6365					3	3 80 A		3-#3, 1-#3, 1-#8	HPU-01 (MODULE 2)	2
	3								6845 VA	6365 VA								4
	5										6845	6365 VA			-			6
	7 SSU - 01, 02	2-#14, 1-	#14, 1-#14	3/4"	15 A	2	339 VA	343 VA					2	15 A	3/4"	2-#14, 1-#14, 1-#14	DOAS - 01	8
	9								339 VA	343 VA					-			10
· .	1 SSU - 03	2-#14, 1-	#14, 1-#14	3/4"	15 A	2					75 VA	86 VA	2	15 A	3/4"	2-#14, 1-#14, 1-#14	BCU-01	12
- C	3						75 VA	86 VA							-			14
- L	5 SSU - 04	2-#14, 1-	#14, 1-#14	3/4"	15 A	2			219 VA	841 VA			3	15 A	3/4"	3-#14, 1-#14, 1-#14	WASHER EXTRACTOR	16
<i>'</i>	7										219 VA	841 VA			-			18
	9 EF-01	2-#12, 1-	#12, 1-#12	3/4"	20 A	2	93 VA	841 VA							1			20
2	21								93 VA	2402 VA			3	35 A	1/2"	3-#8, 1-#8, 1-#10	DRYER	22
	23 EF-02	2-#12, 1-	#12, 1-#12	3/4"	20 A	2					186 VA	2402 VA			-			24
	25						186 VA	2402							-			26
1	P.7 EF-03	2-#12, 1-	#12, 1-#12	3/4"C	20 A	2			186 VA	500 VA			1	20 A	3/4"	1-#12, 1-#12, 1-#12	CC-1	28
- 2	9										186 VA	2600 VA	3	20 A	3/4"	3-#10, 1-#10, 1-#10	EDH-01	30
- (	SPARE				20 A	1	0 VA	2600										32
	3 SPARE				20 A	1			0 VA	2600 VA								34
	SPARE				20 A	1					0 VA	0 VA	1	20 A			SPARE	36
	7 SPACE						0 VA	0 VA					1	20 A			SPARE	38
	9 SPACE								0 VA	0 VA							SPACE	40
4	1 SPACE										0 VA	0 VA					SPACE	42
			·		Tota	Load:	20175	5 VA	2073	3 VA	1980	05 VA						

Load Classification	Connected Load	Demand Factor	Estimated Demand	Panel	Totals
HVAC	0 VA	0.00%	0 VA		
Lighting	0 VA	0.00%	0 VA	Total Conn. Load:	60213 VA
Power	9728 VA	100.00%	9728 VA	Total Est. Demand:	60213 VA
Receptacle	0 VA	0.00%	0 VA	Total Conn.:	167 A
				Total Est. Demand:	167 A
Notes:	-				

SUBDIVISION: FULLERTON

SEAL	PROFESSIONAL CERTIFIC	CATION	AS-BUILT / REV	ISION	BY	DATE	P.W.A. NO.	KEY SHEET	POSITION SHT	DRAWIN	IG SCALE			
WILL OF MARY	I HEREBY CERTIFY THAT THESE DOCUMENTS APPROVED BY ME, AND THAT I AM A DULY LIC		BID/PERMI'	Т		3/01/25	-	MSW	27NE21	PLAN SCALE:	NONE	APPROVED BY:	Mihai T P	etrisor
6	PROFESSIONAL ENGINEER UNDER THE LAWS O MARYLAND.						R.O.W NO.	-	-		-	03/20	6/2025	DIRECTO
	LICENSE NO. 44664 EXPIRATION DA	ATE: 06-18-2025					-	-	-	PROFILE SCALE:	-	DATE:		
	ENGINEER: TA CHIH LIN, PE	DGN BY: CCJM	BUREAU OF ENGINEERING AND CONSTRUCTION		HIGH	WAYS	STRUCTURES	STORM DRAINS	SEWER	WATER	FIELD ENGINEER	PROPI	ERTY MANAC	GEMENT
11/1/SIONAL ENGLISH	PRINCIPAL ELECTRICAL ENGINEER  C.C. JOHNSON & MALHOTRA, P.C.	DWN BY: CCJM	REVIEWED BY:									APPROVED BY:		СНІЕ
DATE : 3/01/25	400 EAST PRATT STREET, SUITE 604 BALTIMORE, MARYLAND 21202 (P) 410-461-9920	CHKD BY: CCJM	DATE REVIEWED:									DATE:		

BALTIMORE COUNTY OFFICE OF BUDGET AND FINANCE, PROPERTY MANAGEMENT

FULLERTON FIRE STATION #8 - RENOVATION & ADDITION

ELECTRICAL PANEL SCHEDULES

4401 FITCH AVENUE, NOTTINGHAM, MARYLAND, 21236

E600

SHEET DESIGNATION CONTRACT NUMBER 25034 PF0 RE-BID JOB ORDER NUMBER 241-220-0054-0012 SHEET 57 of 58 DRAWING NUMBER

ELECTION DIST. NO.: 14C5

2022-2373 FILE NO.: 20-120

### GENERAL ELECTRICAL NOTES (APPLIES TO ALL ELECTRICAL WORK)

- ALL DOCUMENTS AND PUBLICATIONS (SUCH AS, BUT NOT LIMITED TO, MANUALS, HANDBOOKS, CODES, STANDARDS AND SPECIFICATIONS) WHICH ARE CITED IN THIS CONTRACT OR THE SPECIFICATIONS INCORPORATED HEREIN, FOR THE PURPOSE OF ESTABLISHING REQUIREMENTS APPLICABLE TO EQUIPMENT. MATERIALS OR WORKMANSHIP UNDER THIS CONTRACT SHALL BE DEEMED TO BE INCORPORATED HEREIN AS FULLY AS IF PRINTED AND BOUND WITH THIS CONTRACT. WHEREVER REFERENCE IS MADE TO ANY SUCH DOCUMENT. THE CONTRACTOR SHALL COMPLY WITH THE REQUIREMENTS SET OUT IN THE EDITION SPECIFIED IN THIS CONTRACT, OR IF NOT SPECIFIED, THE LATEST EDITION OR REVISION THEREOF, AS WELL AS THE LATEST AMENDMENT OR SUPPLEMENT OR SUPPLEMENT THERETO, EXCEPT AS MODIFIED BY, OR OTHERWISE PROVIDED IN THE SPECIFICATIONS OR THIS CONTRACT.
- CONTRACTOR SHALL COORDINATE THE WORK WITH EXISTING FIELD CONDITIONS & THE WORK OF OTHER TRADES. UNRESOLVABLE CONFLICTS OR INTERFERENCES SHALL BE BROUGHT TO THE IMMEDIATE ATTENTION OF THE ARCHITECT/ENGINEER AND OWNER.
- ALL AUXILIARY ELECTRICAL COMPONENTS, OR CONTROL & POWER WIRING, REQUIRED TO ENSURE THE FUNCTIONALITY OF THE ITEMS SHOWN ON THE DRAWINGS SHALL BE PROVIDED, EVEN IF NOT SPECIFICALLY SHOWN ON THE DRAWINGS. THIS INCLUDES SUCH ITEMS AS LOW VOLTAGE CONTROL POWER AND WIRING TO REMOTE MOUNTED INTERLOCK DEVICES. CONTRACTOR SHALL CONSULT ALL TRADES FURNISHING EQUIPMENT & OBTAIN FROM THEM ALL DATA AND INSTALLATION INSTRUCTIONS TO ENSURE THAT ALL ELECTRICAL REQUIREMENTS ARE INCLUDED.
- DRAWINGS ARE DIAGRAMMATIC AND DO NOT SHOW ALL OF THE RACEWAY, BOXES, PENETRATIONS, SUPPORTS AND OTHER COMPONENTS THAT ARE REQUIRED TO COMPLETE THE WORK ONLY MAJOR ITEMS ARE SHOWN ON THE DRAWINGS. PROVIDE ALL WORK AS REQUIRED FOR A COMPLETE AND FULLY FUNCTIONAL ELECTRICAL SYSTEM.
- **EQUIPMENT MANUFACTURER'S WRITTEN INSTALLATION** INSTRUCTIONS AND ALL LABELS AND WARNINGS AFFIXED TO THE INSTALLED EQUIPMENT SHALL BE STRICTLY ADHERED TO.
- ALL WORK SHALL BE DONE IN ACCORDANCE WITH THE LATEST REQUIREMENTS OF ALL APPLICABLE CODES & REGULATIONS.
- CONDUCTOR SIZING, BREAKER TRIP RATINGS AND FUSE SIZES FOR MECHANICAL EQUIPMENT FEEDERS AS SHOWN ON THE DRAWINGS ARE BASED ON PRELIMINARY DESIGN INFORMATION. CONTRACTOR SHALL VERIFY THE PROPER SIZING AND RATINGS FROM THE FURNISHED EQUIPMENT WRITTEN DATA OR EQUIPMENT NAMEPLATES PRIOR TO ROUGH IN. IMMEDIATELY ADVISE THE ARCHITECT/ENGINEER AND OWNER OF ANY DISCREPANCIES.
- PROVIDE EQUIPMENT DISCONNECT SWITCHES IN STRICT COMPLIANCE WITH CODE REQUIREMENTS. (NOT ALL LOCAL DISCONNECT SWITCHES ARE SHOWN)
- ALL OUTLET BOXES SHALL BE PROVIDED WITH PROPER COVER PLATES.
- 10. IN AREAS WHERE COUNTERS ARE PROVIDED, COORDINATE EXACT LOCATION OF OUTLETS AND WIRING WITH CASEWORK.
- 11. CONDUITS SHALL BE CONCEALED IN WALLS AND CEILINGS TO THE GREATEST EXTENT POSSIBLE. INTERIOR SURFACE METAL RACEWAY (WIREMOLD OR EQUAL) MAY BE USED FOR LIGHTING FIXTURES OR WIRING DEVICES LOCATED ON INACCESSIBLE BUILDING ELEMENTS, SUCH AS CONCRETE CEILINGS OR MASONRY WALLS. SURFACE METAL RACEWAY SHALL BE MOUNTED TIGHT TO WALLS OR CEILINGS. LOCATION AND ROUTING SHALL BE APPROVED BY ARCHITECT AND OWNER. SEE TECHNICAL SPECIFICATION FOR FURTHER INFORMATION.
- 12. ALL OUTDOOR RECEPTACLES SHALL BE WEATHERPROOF (W.P.) AND THE GFI TYPE.
- 13. ALL OUTDOOR ENCLOSURES SHALL BE NEMA 3R. THE PADLOCKED TYPE WITH TAMPER PROOF SCREWS.
- 14. THE CONTRACTOR SHALL PROVIDE ALL LABOR AND MATERIALS NECESSARY FOR A COMPLETE AND FUNCTIONING ELECTRICAL SYSTEM.
- 15. ALL MATERIALS AND EQUIPMENT SHALL BE ERECTED, INSTALLED, CONNECTED, CLEANED, ADJUSTED, TESTED, CONDITIONED, AND PLACED IN SERVICE IN ACCORDANCE WITH THE MANUFACTURER'S DIRECTIONS AND RECOMMENDATIONS.
- 16. CONDUIT RUNS OR PULL BOXES SHALL NOT BLOCK OR PREVENT FULL COMPLETE ACCESS AND/OR OPERATION OF HVAC EQUIPMENT, ACCESS DOORS, PIPING VAULTS, JUNCTION BOXES MAIN RETURN AIR DUCTS, PULL BOXES, CLEANOUTS, ETC.

- 17. VERIFY CLEARANCES FOR ALL NEW ELECTRICAL WORK BEFORE PROCEEDING WITH CONSTRUCTION. COORDINATE USAGE OF AVAILABLE SPACE WITH ALL TRADES. IN THE EVENT OF CONFLICTS, NOTIFY THE ARCHITECT/ENGINEER AND OWNER BEFORE PROCEEDING WITH THE WORK.
- 18. SEAL ALL NEW WALL AND FLOOR CONDUIT PENETRATIONS.
- 19. CIRCUITS ARE SIZED ASSUMING THAT NO MORE THAN THREE CURRENT CARRYING CONDUCTORS ARE IN A SINGLE CONDUIT. FOR CONDUITS CONTAINING MORE THAN THREE, PROVIDE APPROPRIATE DERATING OF CONDUCTORS PER CODE.
- 20. NUMBERED CIRCUITS ARE CREATED FOR THE CONVENIENCE OF DESIGN ONLY. DESIGN INTENT MUST BE FOLLOWED THROUGHOUT, INDICATE THE CIRCUIT NUMBERS AND CORRESPONDING ROOM NUMBERS USED ON THE "AS-BUILT" DRAWINGS. EMERGENCY PANEL CIRCUIT NUMBERS MAY VARY. ACTUAL FIELD CONDITIONS SHALL BE VERIFIED.
- NO WIRING SHALL BE INSTALLED PRIOR TO THE CONTRACTOR'S REVIEW OF THE PROJECT EQUIPMENT SHOP DRAWINGS AND COORDINATION WITH THE DESIGN DOCUMENTS. ANY DISCREPANCIES SHALL BE BROUGHT TO THE ARCHITECT/ENGINEER AND OWNER ATTENTION FOR FINAL RESOLUTION. WORK THAT HAS TO BE REPLACED DUE TO LACK OF PROPER SHOP DRAWINGS COORDINATION SHALL BE DONE AT CONTRACTOR'S EXPENSE.
- 22. MOTOR SIZES AND LOCATIONS SHOWN ON THE DRAWINGS ARE BASED ON INFORMATION OBTAINED DURING DESIGN. VERIFY THE ACTUAL LOCATIONS AND PROVIDE WIRING AND PROTECTION OF PROPER SIZES AS REQUIRED. WIRE THE MOTORS FOR PROPER DIRECTION OF ROTATION AND CHECK ROTATION AT START-UP.
- 23. ALL INCOMING POWER & LOW VOLTAGE CONDUCTORS SHALL RUN IN CONCEALED CONDUIT. UTILIZE EXISTING CONDUIT WHERE POSSIBLE.
- 24. ALL EQUIPMENT INSTALLED IN MECHANICAL AIR PLENUM SPACE SHALL BE RATED FOR THAT USE PER LOCAL REQUIREMENT.
- 25. FOR 15A OR 20A BRANCH CIRCUITS, PROVIDE WIRE SIZES AND RACEWAYS AS PER WIRING NOTES ON DRAWING E001.
- 26. NOTIFY ARCHITECT AND OWNER NO FEWER THAN SEVEN (7) DAYS IN ADVANCE OF PROPOSED INTERRUPTION OF ELECTRICAL SERVICE. DO NOT PROCEED WITH INTERRUPTION OF ELECTRICAL SERVICE WITHOUT ARCHITECT'S AND OWNER WRITTEN PERMISSION.
- SURFACE MOUNTED METAL RACEWAYS ONLY PERMISSIBLE ON EXISTING WALLS, WHERE CONDUIT CANNOT BE CONCEALED, IN OCCUPIED, OR NON-OCCUPIED SPACES.
- 28. REFER TO ARCHITECTURAL DRAWINGS FOR TEMPORARY LIVING FACILITY TRAILERS. PROVIDE TRAILERS WITH TEMPORARY ELECTRIC, DATA, SECURITY, FIRE ALARM, AND OTHER UTILITIES THROUGHOUT THE DURATION OF CONSTRUCTION.

	LIGHTING FIXTURE SCHEDULE													
TYPE	DESCRIPTION		BASIS OF DESIGN		LAMP			COMMENTS						
ITPE	DESCRIPTION	MANUFACTURER	MODEL	TYPE	WATTS	EFFICACY	VOLTAGE	COMMENTS						
А	GTL 2X4 7200 NOMINAL LUMENS A12 LENS 3500K	LITHONIA LIGHTING	2GTL 4 40L A19 EZ1 LP835	LED	34 W	149 lm/W								
A1	GTL 2X4 7200 NOMINAL LUMENS A12 LENS 3500K FOR EMERGENCY LIGHTING	LITHONIA LIGHTING	2GTL 4 40L A19 EZ1 LP835 N80 BGTD	LED	34 W	149 lm/W								
В	4" SQUARE LED RECESSED DOWNLIGHT UL LISTED FOR WET LOCATION	GOTHAM LIGHTING	EVO4SQSH-SQ-35-20-DFR-SMO-MVOLT-EZ10	LED	20 W	81 lm/W								
С	EXTERIOR WALL MOUNTED LED	LITHONIA LIGHTING	TWP LED ALO 40K T3M MVOLT PE SF DBLXD	LED	48 W	149 lm/W								
EM	EMERGENCY BATTERY PACK	LITHONIA LIGHTING	ELM2L-LP220L-W-UVOLT-SDRT	LED				WALL MOUNTED 7'-11" AFF						
RL	EXISTING FIXTURE RELOCATED TO NEW LOCATION	EXISTING	-	EX.	0 W									
Х	EXIT DIRECTIONAL SIGN	LITHONIA LIGHTING	LQM S W 1 G MVOLT	LED			120 V							

### LIGHT FIXTURE GENERAL NOTES

- REFER TO ARCHITECTURAL DRAWING FOR MOUNTING CONSTRUCTION.
- LISTED CATALOG NUMBER AND MANUFACTURER CONSTITUTES "BASIS OF DESIGN". LISTING OF ALTERNATE MANUFACTURER'S NAMES DOES NOT IMPLY ACCEPTANCE OF THEIR STANDARD PRODUCT. MANUFACTURERS ARE RESPONSIBLE FOR PROVIDING FIXTURES THAT ARE EQUAL IN ALL RESPECTS TO THE "BASIS OF DESIGN" FIXTURES. "INTENT IS TO ALLOW FOR COMPETITIVELY BID LIGHTING PACKAGE. FOR FIXTURES WITH MULTIPLE NAMED MANUFACTURERS."
- SUBSTITUTIONS OF FIXTURES ONLY ALLOWED WHEN APPROVED IN ADVANCE BEFORE SHOP DRAWINGS SUBMITTAL AND REQUEST FOR SUBSTITUTION IS SUBMITTED IN ACCORDANCE WITH SPECIFICATION REQUIREMENTS.
- LIGHTING FIXTURES SUBMITTALS SHALL INCLUDE, AS A MINIMUM: A) FIXTURE TYPE (TO MATCH WITH SCHEDULE), DIMENSIONS AND FINISH. B) LAMP DATA/LED DATA FOR EACH TYPE OF FIXTURE INCLUDING: TYPE, QUANTITY, WATTAGE, AND PHOSPHOR COLOR. C) DRIVER FOR EACH FIXTURE TYPE AND FIXTURE VOLTAGE.
- PROVIDE UNIVERSAL 120/277 VOLT, 0-10V DIMMING DRIVER FOR DIMMING TO 1% UNLESS OTHERWISE INDICATED.
- VERIFY CEILING/WALL TRIM COMPATIBILITY PRIOR TO SUBMITTING THE FIXTURES. COLOR AND FIXTURE FINISHES AS SELECTED BY ARCHITECT WHETHER SHOWN OR NOT. PROVIDE ADAPTER AND ADDITIONAL MOUNTING EQUIPMENT AS REQUIRED TO MOUNT FIXTURE TO SURFACE.
- PROVIDE LABOR AND EQUIPMENT FOR FOCUSING OF ADJUSTABLE FIXTURES AND PRESETTING OF LIGHTING CONTROL SYSTEMS. FOCUSING AND PRESETTING SHALL BE DONE IN THE PRESENCE OF THE OWNER AND ARCHITECT/ENGINEER.
- PROVIDE ALL CONTROL WIRES FOR 0-10V DIMMING. PROVIDE DIMMING BALLAST (DIMMABLE FROM 10%-100%)
- IF THE CONTRACTOR OPTS TO USE THE FIXTURE OF ALTERNATE MANUFACTURER (WHERE ACCEPTABLE), THE CONTRACTOR SHALL BE RESPONSIBLE TO PROVIDE POINT-TO-POINT CALCULATIONS FOR ALL AREAS AS DIRECTED BY THE ENGINEER AT THE TIME OF SUBSTITUTION REQUEST.
- PROVIDE ALL CHANNELS, HANGERS, CABLES, SUPPORTS AND OTHER ACCESSORIES AS REQUIRED FOR SUSPENDED FIXTURES FOR COMPLETE WORKING SYSTEM WITHOUT ADDITIONAL COST TO OWNER. PROVIDE SIDE BRACKETS TO MOUNT TO WALL /COVE/SUPPORTS.
- 11. IF MULTIPLE VOLTAGES ARE INDICATED, FIXTURE IS COMPATIBLE WITH MULTIPLE VOLTAGES. FIXTURE TO BE WIRED TO VOLTAGE INDICATED IN PARENTHESES ().
- 12. PROVIDE INSTALLED UL LABELS WITH THE MAXIMUM SCHEDULED WATTAGE.
- 13. LED SHALL BE 3500K COLOR TEMPERATURE.

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- 14. REFER TO LIGHTING PLANS FOR (\*) ROW LENGTH.
- 15. LIGHTING FIXTURES IN EQUIPMENT ROOMS TO BE INSTALLED AFTER ALL EQUIPMENT, PIPING, DUCTWORK, ETC. HAS BEEN INSTALLED SO AS NOT TO CREATE INTERFERENCES AND TO MAXIMIZE ILLUMINATION LEVELS.
- THE BATTERY BACKUP SYSTEM SHALL MEET LOCAL REQUIREMENTS (MINIMUM 90 MIN. BACKUP TIME, TEST SWITCH & INDICATOR). BALLAST SELECTION FOR ALL FIXTURES SHALL BE COORDINATED WITH THE LIGHTING CONTROL MANUFACTURER BEFORE BID. PROVIDE DIMMING BALLAST AS IT IS INDICATED ON LIGHTING PLANS, MOUNTING METHOD AND HEIGHT FOR PENDANT-TYPE FIXTURES SHALL BE COORDINATED WITH THE ARCHITECT AND ARCHITECTURAL PLANS. PROVIDE PLENUM-RATED FIXTURE WHERE IT IS APPLICABLE. REFER TO MECHANICAL DRAWING FOR INFORMATION.

SEAL MINIMULA	PROFESSIONAL CERTIFIC	CATION	AS-BUILT / RE	VISION	BY	DATE	P.W.A. NO.	KEY SHEET	POSITION SHT	DRAWIN	G SCALE			
WILL OF MARY	I HEREBY CERTIFY THAT THESE DOCUMENTS APPROVED BY ME, AND THAT I AM A DULY LIC		BID/PERMIT			3/01/25	-	MSW	27NE21	27NE21 PLAN SCALE:		APPROVED BY:	Mihai T Poti	risor
I STATE I	PROFESSIONAL ENGINEER UNDER THE LAWS						R.O.W NO.	· .	-		-			DIRECTO
		ATE: 06-18-2025					-	-	-	PROFILE SCALE:	-	DATE: <u>03/2</u>	26/2025	
44664 HOUSE ON ALL ENGINEERS	ENGINEER: TA CHIH LIN, PE	DGN BY: CCJM	BUREAU OF ENGINEERING AND CONSTRUCTION		HIGH	WAYS	STRUCTURES	STORM DRAINS	SEWER	WATER	FIELD ENGINEER	PROP:	ERTY MANAGE	MENT
MINIONAL ENGLISH	PRINCIPAL ELECTRICAL ENGINEER  C.C. JOHNSON & MALHOTRA, P.C. 400 EAST PRATT STREET, SUITE 604	DWN BY: CCJM	REVIEWED BY:									APPROVED BY:		CHIE
DATE : 3/01/25	400 EAST FRATE STREET, SOUTE 004 BALTIMORE, MARYLAND 21202 (P) 410-461-9920	CHKD BY: CCJM	DATE REVIEWED:									DATE:		

BALTIMORE COUNTY OFFICE OF BUDGET AND FINANCE. PROPERTY MANAGEMENT

FULLERTON FIRE STATION #8 - RENOVATION & ADDITION

LIGHT FIXTURE SCHEDULE

4401 FITCH AVENUE, NOTTINGHAM, MARYLAND, 21236

\*\*\*\* ELECTION DIST. NO.: 14C5

E601

SHEET DESIGNATION CONTRACT NUMBER 25034 PF0 RE-BID JOB ORDER NUMBER 241-220-0054-0012 SHEET 58 of 58 DRAWING NUMBER 2022**-**2374

FILE NO.: 20-120