ABBREVIATIONS

ACOUSTICAL CEILING TILE NO. OR # AIR CONDITIONING NOM. NOMINAL **ADJUSTABLE** N.I.C. NOT IN CONTRACT ABOVE FINISHED FLOOR NET SQUARE FEET ABOVE BENCHMARK N.T.S. NOT TO SCALE AIR HANDLING UNIT ON CENTER ALUM ALUMINUM OPNG. OPENING **APPROX APPROXIMATE ARCHITECTURAL** PLYWOOD P.T. PORCELAIN TILE **BASE CABINET** PAINTED BD. BITUM. **BITUMINOUS** REFRIDGERATOR BLDG. BLOCK BLKD. BULKHEAD ROOM

SQUARE FEET CENTER LINE STRUCTURAL GLAZED TILE S.G.T. C.B. CHALK BOARD SHEET CL. CLOSET CLG. CEILING S.O.G. SLAB ON GRADE CONCRETE MASONRY UNIT SNT. SEALANT COL SPECIFICATION CONC. CONCRETE STD. STANDARD CONT CONTINUOUS STL. **CONTROL JOINT** STAINLESS STEEL **STORAGE**

STRUCTURE

TEMPORARY

TOP OF SLAB

TOP OF JOIST

THICK

TOILET

TONGUE & GROOVE

SQUARE SUSPENDED

CPT. CARPET STOR. C.T. **CERAMIC TILE** STRUCT. SQ. DEMOLITION DEMO D.F. DRINKING FOUNTAIN DIM. DIMENSION **DOWN** DIAMETER T.O.J. DS DOWN SPOUT TLT.

DWG. DRAWING TYP. **TYPICAL EXPANSION JOINT UNLESS NOTED ELEVATOR** OTHERWISE ELEV. **ELEVATION** VINYL COMPOSITION TILE ETC VERT. ETCETERA **VERTICAL** E.T.R. **EXISTING TO REMAIN** V.I.F. **VERIFY IN FIELD EQUIP EQUIPMENT** VERIFY IN FIELD WITH ARCHITECT EXIST. **EXISTING**

EXTERIOR WITH WIDTH F.E.C. FIRE EXTINGUISHER WALL BOARD FLOOR DRAIN WATER CLOSET W.C. F.F.E. FINISH FLOOR ELEVATION WD. WOOD WITHOUT FL. OR FLR. FLOOR FOM FACE OF MASONRY

ARCHITECT **GAUGE** GALV GALVINIZED GYP. BD. GYSUM BOARD GSF **GROSS SQUARE FEET** GWB GYSUM WALL BOARD **GLAZING TYPE**

FIELD VERIFY WITH

H OR HT HANDICAPPED HC H.M. **HOLLOW METAL** HORIZ. HORIZONTAL

F.V.W.A.

HEATING/VENTILATION, AIR CONDITIONING

INTERIOR **JANITOR**

LENGTH LAVATORY LEFT HAND MACH. MAT'L MATERIAL MAX. MAXIMUM

M.E. MATCH EXISTING MECH. MECHANICAL MEP MECHANICAL/ELECTRICAL/ PLUMBING MINIMUM MISCELLANEOUS MISC. MASONRY OPENING M.O.

> MOUNTED METAL

BALTIMORE COUNTY DETENTION CENTER LOBBY RENOVATIONS

720 BOSLEY AVENUE TOWSON, MD, 21204

100% CONSTRUCTION DOCUMENTS 06/13/2025

ARCHITECT MURPHY & DITTENHAFER ARCHITECTS 805 N. CHARLES ST. BALTIMORE, MD, 21211

TEL. 410.625.4823

STRUCTURAL ENGINEER COLUMBIA ENGINEERING, INC 6210 OLD DOBBIN LANE SUITE 150 COLUMBIA, MD, 21045

TEL. 410.992.9971

ME ENGINEER BOWMAN 300 EAST JOPPA RD SUITE 501 TOWSON, MD, 21289

TEL. 410.494.1111

PLUMBING AND FA ENGINEER SETTY

575 S. CHARLES ST SUITE 403 BALTIMORE, MD, 21201

TEL. 443.773.3494

AV / TELECOM CONVERGENT TECHNOLOGIES DESIGN GROUP, INC 6501 YORK RD, BALTIMORE, MD, 21212


TEL. 410.532.2395

COST ESTIMATOR MK CONSULTING ENGINEERS, LLC 1801 PORTER ST SUITE 401 BALTIMORE, MD, 21230

TEL. 667.210.2481

SUBDIVISION: TOWSON

VICINITY MAP LOCATION MAP

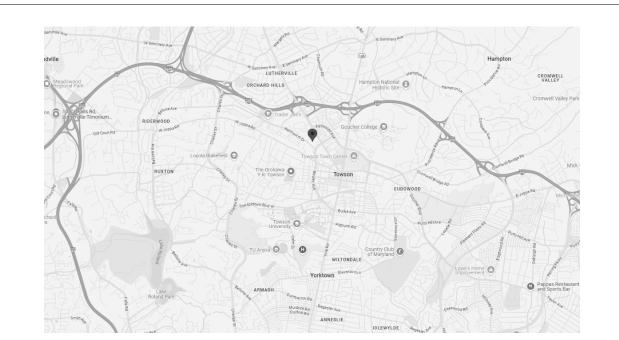




SHEET LIST

DRAWING SHEET

NUMBER	UMBER DESIGNATION SHEET NAME						
GENERAL							
2025 - 2112	CS-1	COVER SHEET					
2025 - 2113	CS-2	CODE SUMMARY					
ARCHITECT!	JRAL						
2025 - 2114	AD-001	FIRST FLOOR DEMOLITION PLAN					
2025 - 2115	AD-100	ENLARGED DEMO PLAN - AREA A					
2025 - 2116	AD-101	ENLARGED DEMO PLAN - AREA B					
2025 - 2117	AD-110	ENLARGED DEMO RCP PLAN - AREA A					
2025 - 2118	AD-111	ENLARGED DEMO RCP PLAN - AREA B					
2025 - 2119	A-001	AREA OF WORK PLAN					
2025 - 2120	A-100	ENLARGED PLAN_AREA A					
2025 - 2121	A-101	ENLARGED PLAN_AREA B					
2025 - 2122	A-110	ENLARGED REFLECTED CEILING PLAN - AREA A					
2025 - 2123	A-111	ENLARGED REFLECTED CEILING PLAN - AREA B					
2025 - 2124	A-300	INTERIOR ELEVATIONS					
2025 - 2125	A-500	DETAILS					
2025 - 2126	A-501	DETAILS					
2025 - 2127	A-600	DOOR AND GLAZING SCHEDULE					
2025 - 2128	A-601	PARTITION TYPES					
STRUCTURA	NL						
2025 - 2129	S001	GENERAL NOTES AND TYPICAL DETAILS					
2025 - 2130	S-101	PARTIAL THIRD FLOOR PLAN - STRUCTURAL WORK					
MECHANICA	I						
2025 - 2131	M001	MECHANICAL COVER SHEET					
2025 - 2132	M201	THIRD FLOOR PLAN - MECHANICAL - DEMOLITION AND NEW					
2025 - 2133	M801	MECHANICAL DETAILS AND SCHEDULES					

DRAWING NUMBER	SHEET DESIGNATION	SHEET NAME
ELECTRICAI	_	
2025 - 2134	E001	ELECTRICAL COVER SHEET
2025 - 2135	E201	THIRD FLOOR PLAN - ELECTRICAL - DEMOLITION AND NEW
IRE ALARM	1	
2025 - 2136	FA-001	GENERAL NOTES, SYMBOLS AND ABBREVIATIONS
2025 - 2137	FAD-100	LEVEL 3 FLOOR PLAN - FIRE ALARM DEMOLITION
2025 - 2138	FA-100	LEVEL 3 FLOOR PLAN - FIRE ALARM
2025 - 2139	FA-501	FIRE ALARM RISER DIAGRAM
2025 - 2140	FA-701	FIRE ALARM DETAILS
FIRE PROTE 2025 - 2141 2025 - 2142		GENERAL NOTES, SYMBOLS AND ABBREVIATIONS LEVEL 3 FLOOR PLAN - FIRE PROTECTION
		DEMOLITION
2025 - 2143	F-100	LEVEL 3 FLOOR PLAN - FIRE PROTECTION
2025 - 2144	F-701	FIRE PROTECTION DETAILS
.OW VOLTA		
OW VOLTA 2025 - 2145	TA-001	LOW VOLTAGE SYSTEMS TITLESHEET
OW VOLTA 2025 - 2145 2025 - 2146	TA-001 TA-002	LOW VOLTAGE RESPONSIBILITIES MATRIX
OW VOLTA 2025 - 2145 2025 - 2146 2025 - 2147	TA-001 TA-002 TA-100	LOW VOLTAGE RESPONSIBILITIES MATRIX LOW VOLTAGE FLOOR PLAN
OW VOLTA 2025 - 2145 2025 - 2146 2025 - 2147 2025 - 2148	TA-001 TA-002 TA-100 TA-120	LOW VOLTAGE RESPONSIBILITIES MATRIX LOW VOLTAGE FLOOR PLAN LOW VOLTAGE REFLECTED CEILING PLAN
OW VOLTA 2025 - 2145 2025 - 2146 2025 - 2147 2025 - 2148 2025 - 2149	TA-001 TA-002 TA-100 TA-120 TA-200	LOW VOLTAGE RESPONSIBILITIES MATRIX LOW VOLTAGE FLOOR PLAN LOW VOLTAGE REFLECTED CEILING PLAN FLAT PANEL DISPLAY ELEVATION DETAILS
OW VOLTA 2025 - 2145 2025 - 2146 2025 - 2147 2025 - 2148	TA-001 TA-002 TA-100 TA-120 TA-200 TA-500	LOW VOLTAGE RESPONSIBILITIES MATRIX LOW VOLTAGE FLOOR PLAN LOW VOLTAGE REFLECTED CEILING PLAN FLAT PANEL DISPLAY ELEVATION DETAILS LOW VOLTAGE SYSTEMS INFRASTRUCTURE DETAILS (1 OF 2)
OW VOLTA 2025 - 2145 2025 - 2146 2025 - 2147 2025 - 2148 2025 - 2149	TA-001 TA-002 TA-100 TA-120 TA-200	LOW VOLTAGE RESPONSIBILITIES MATRIX LOW VOLTAGE FLOOR PLAN LOW VOLTAGE REFLECTED CEILING PLAN FLAT PANEL DISPLAY ELEVATION DETAILS LOW VOLTAGE SYSTEMS

SYMBOLS

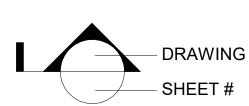









ELEVATIONS




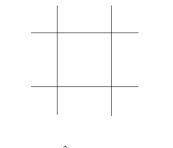

NEW SUSP. A.C.T. **CEILING &**

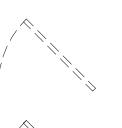


EXISTING DOOR (TO BE REMOVED)

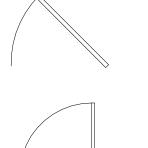

NEW DOOR

EXISTING

DOOR

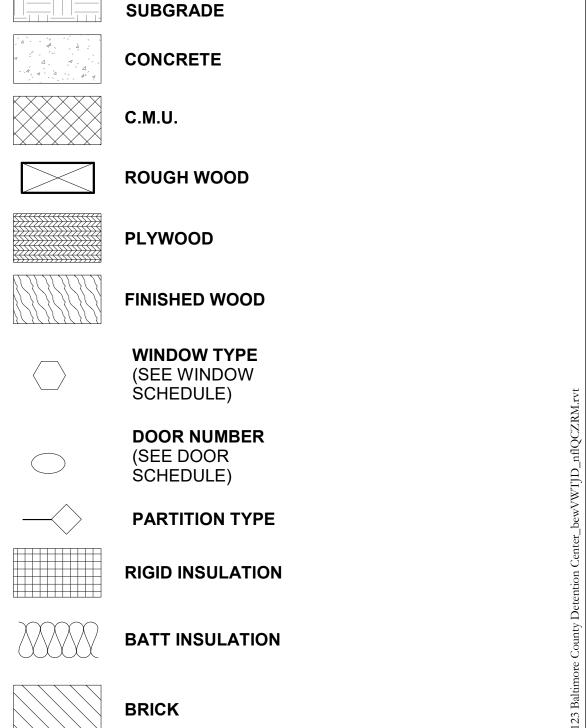

COMPACTED



CONTRACT NUMBER

file no.: 8

EXISTING WALLS

(TO BE REMOVED)

NEW PARTITION

25122 PO0

JOB ORDER NUMBER PROJ-10001187 SHEET 1 OF 60 DRAWING NUMBER 2025-2112

CS-1

BALTIMORE COUNTY OFFICE OF BUDGET AND FINANCE - PROPERTY MANAGEMENT


BCDC LOBBY RENOVATIONS

COVER SHEET

RENOVATION


720 BOSLEY AVENUE, TOWSON, MD 21204

ELECTION DIST. NO.: 9C6

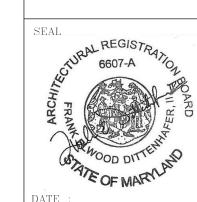

MTD

AS-BUILT / REVISION BY DATE P.W.A. NO. KEY SHEET POSITION SHT DRAWING SCALE PROPERTY MANAGEMENT HEREBY CERTIFY THAT THESE DOCUMENTS WERE PREPARED AM Doran APPROVED BY ME, AND THAT I AM A DULY LICENSED R.O.W NO. 8/19/2025 PROFILE SCALE 06/13/2027 NTRACT COMPLETION BOX HIGHWAYS STRUCTURES STORM DRAINS SEWER WATER Frank Elwood Dittenhafer, II REVIEWED BY: AS-BUILT PER RECORD PRINT CHKD BY: RDT DATE REVIEWED:

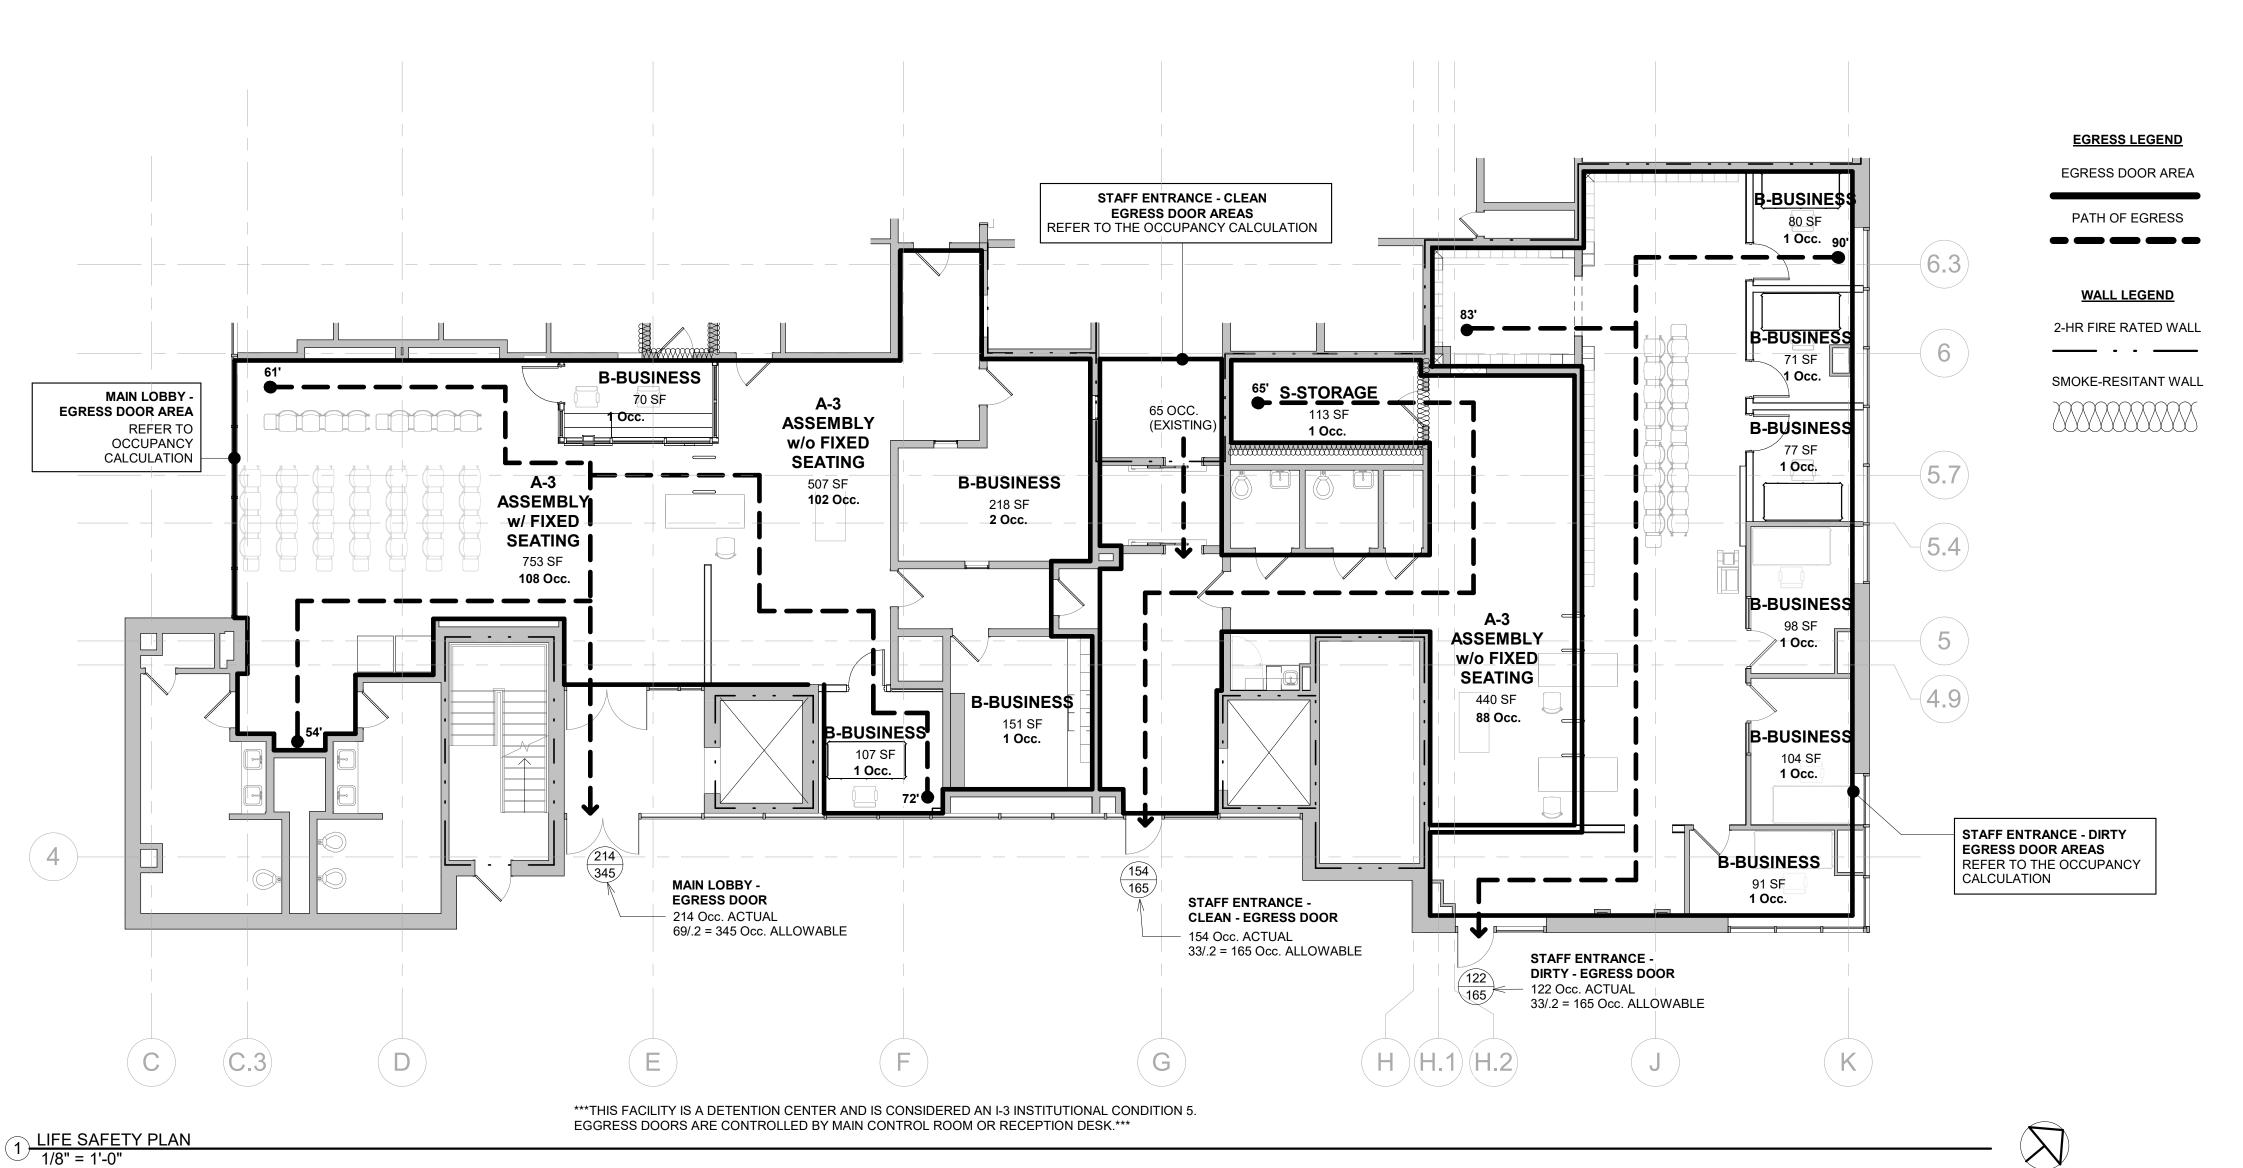

APPLICABLE CODES: 2021 INTERNATIONAL BUILDING CODE 2021 INTERNATIONAL EXISTING BUILDING CODE 2021 INTERNATIONAL MECHANICAL CODE 2021 ENERGY CONCERVATION CODE 2017 NATIONAL ELECTRIC CODE 2021 INTERNATIONAL PLUMBING CODE COMAR 09.12.53 ADOPTING 2010 ADAAG AND 1988 FHAA 2018 NFPA #1 FIRE PREVENTION CODE 2018 NFPA #101 LIFE SAFETY CODE 2016 NFPA #13 AUTOMATIC SPRINKLER SYSTEMS CODE 2016 NFPA #72 NATIONAL FIRE ALARM CODE

EXISTING BUILDING INFORMATION:

JURISDICTION: TOTAL BUILDING AREA: LEVEL 3 (LOBBY LEVEL) AREA: BUILDING HEIGHT:

CONSTRUCTION CLASSIFICATION: OCCUPANCY CLASSIFICAITON: EGRESS OCCUPANCY:

BALTIMORE COUNTY 255,981 GSF

46,958 GSF APPROX. 74'-0" W/AUTOMATIC SPRINKLERS TYPE 1B INSTITUTIONAL I-3, CONDITION 5 (IBC 308.4.5)

ASSEMBLY A-3 (W/FIXED SEATING) ASSEMBLY A-3 (W/O FIXED SEATING) **BUSINESS B**

PROPOSED NEW WORK:

INTERIOR RENOVATIONS TO THE MAIN LOBBY TO INSTALL A SECURE RECEPTION DESK AND RENOVATE THE SECURITY CHECK POINTS. A NEW OFFICE WILL BE CONSTRUCTED AND FINISHES WILL BE UPGRADED. A SECOND STAFF ENTRANCE WILL BE CREATED FROM AN EXISTING EXTERIOR DOOR. NEW SECURITY CHECK POINTS WILL BE CONSTRUCTED. EXISTING PARTITIONS WILL BE MODIFIED AND NEW PARTION WALLS WILL BE INSTALLED. THREE NEW OFFICES WILL BE CONSTRUCTED. FINISHES WILL BE UPGRADED.

TOTAL WORK AREA: 5,412 SF = 2% OF TOTAL BUILDING AREA (255,981 GSF) 5,412 SF = 12% OF TOTAL LEVEL 3 AREA (46,958 GSF)

2021 IEBC
PER SECTION 603, THE SCOPE OF WORK IS CLASSIFIED AS ALTERATION - LEVEL2, AND WILL COMPLY WITH CHAPTER 7 & CHAPTER 8.

2021 IEBC SECTION 701.2
AN EXISTING BUILDING OR PORTION THEREOF SHALL NOT BE ALTERED SUCH THAT THE BUILDING BECOMES LESS SAFE THAN ITS EXISTING CONDITION.

OCCUPANCY CALCULATIONS PER IBC TABLE 1004.5

MAIN LOBBY EGRESS DOOR
A-3 ASSEMBLY W/FIXED SEATING (NET 7) 752.72 SF / 7 = 107.5 ~ 108 OCCUPANTS

A-3 ASSEMBLY W/O FIXED SEATING (NET 5) 507.03 SF / 5 = 101.4 ~ 102 OCCUPANTS

B-BUSINESS (GROSS 150; FROM PLAN NORTH TO

SOUTH) 212 SF / 150 = 1.41 ~ 1 OCCUPANT 151 SF / 150 = 1.00 ~ 1 OCCUPANT 103 SF / 150 = 0.69 ~ 1 OCCUPANT (RECEPTION DESK) 77 SF / 150 = 0.51 ~ 1 OCCUPANT

STAFF ENTRANCE - CLEAN - EGRESS DOOR A-3 ASSEMBLY W/O FIXED SEATING (NET 5) 439.78 SF / 5 = 87.69 ~ 88 OCCUPANTS

S-STORAGE (GROSS 300) 113.41 SF / 150 = 0.37 ~ 1 OCCUPANT

TOTAL ACTUAL OCCUPANTS = 214

TOTAL ACTUAL OCCUPANTS = 154 STAFF ENTRANCE - DIRTY - EGRESS DOOR A-3 ASSEMBLY W/ FIXED SEATING (NET 7)

+ EXISTING FROM OTHER AREAS = 65 OCCUPANTS

810.43 SF / 7 = 115.8 ~ 116 OCCUPANTS B-BUSINESS (GROSS 150; FROM PLAN NORTH TO

57 SF / 150 = 0.38 ~ 1 OCCUPANT 50 SF / 150 = 0.33 ~ 1 OCCUPANT 64 SF / 150 = 0.43 ~ 1 OCCUPANT 98 SF / 150 = 0.65 ~ 1 OCCUPANT 104 SF / 150 = 0.69 ~ 1 OCCUPANT 91 SF / 150 = 0.61 ~ 1 OCCUPANT

TOTAL ACTUAL OCCUPANTS = 122

MAXIMUM COMMON PATH OF EGRESS TRAVEL IBC, TABLE 1006.2.1 SPACES WITH ONE EXIT ACCESS DOORWAY

ASSEMBLY: 75 FEET BUSINESS: 100 FEET STORAGE: 100 FEET

EGRESS CALCULATIONS

IBC, TABLE 1006.3.3 MINIMUM NUMBER OF EXITS FOR OCCUPANT LOAD: FOR 1 - 500 OCCUPANTS = MINIMUM NUMBER OF EXITS = 2 PROVIDED EXITS = 3 EGRESS WIDTH = 0.3" / OCCUPANT

EXIT DOOR SIZE 36" (33" CLEAR) 72" (69" CLEAR)


REFER TO EXIT SUMMARY TABLE FOR EXIT CAPACITY REQUIRED AND PROVIDED.

MINIMUM CORRIDOR WIDTH REQUIRED = 44 INCHES MINIMUM CORRIDOR WIDTH PROVIDED = 78 INCHES

COMPONENTS = 0.2" / OCCUPANT

EXIT, ACCESS TRAVEL DISTANCE

IBC, TABLE 1017.2, EXIT ACCESS TRAVEL DISTANCE FOR BUILDINGS WITH SPRINKLER SYSTEM. ASSEMBLY: 250 FEET **BUSINESS: 250 FEET**

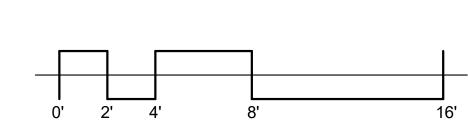

226 West Market Street, York, Pennsylvania 17401 717-848-8627 voice 717-843-2449 fax

BALTIMORE COUNTY OFFICE OF BUDGET AND FINANCE - PROPERTY MANAGEMENT

BCDC LOBBY RENOVATIONS

CODE SUMMARY


RENOVATION

SHEET DESIGNATION CS-2 ****

25122 PO0 JOB ORDER NUMBER PROJ-10001187 SHEET 2 OF 60 DRAWING NUMBER 2025-2113

CONTRACT NUMBER


file no.: 8

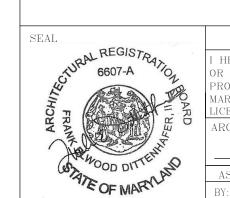

BY DATE P.W.A. NO. KEY SHEET POSITION SHT DRAWING SCALE PROFESSIONAL CERTIFICATION AS-BUILT / REVISION PROPERTY MANAGEMENT HEREBY CERTIFY THAT THESE DOCUMENTS WERE PREPARED PLAN SCALE: | As indicated 41NE2 R APPROVED BY ME, AND THAT I AM A DULY LICENSED R.O.W NO. PROPERTY MANAGER ROFESSIONAL ARCHITECT UNDER THE LAWS OF THE STATE OF PROFILE SCALE EXPIRATION DATE 06/13/2027 CONTRACT COMPLETION BOX ARCHITECT: BUREAU OF ENGINEERING AND CONSTRUCTION TRAFFIC HIGHWAYS STRUCTURES STORM DRAINS SEWER FIELD ENGINE WATER Frank Elwood Dittenhafer, II REVIEWED BY: S-BUILT PER RECORD PRINT DATE REVIEWED:

SUBDIVISION: TOWSON

720 BOSLEY AVENUE, TOWSON, MD 21204

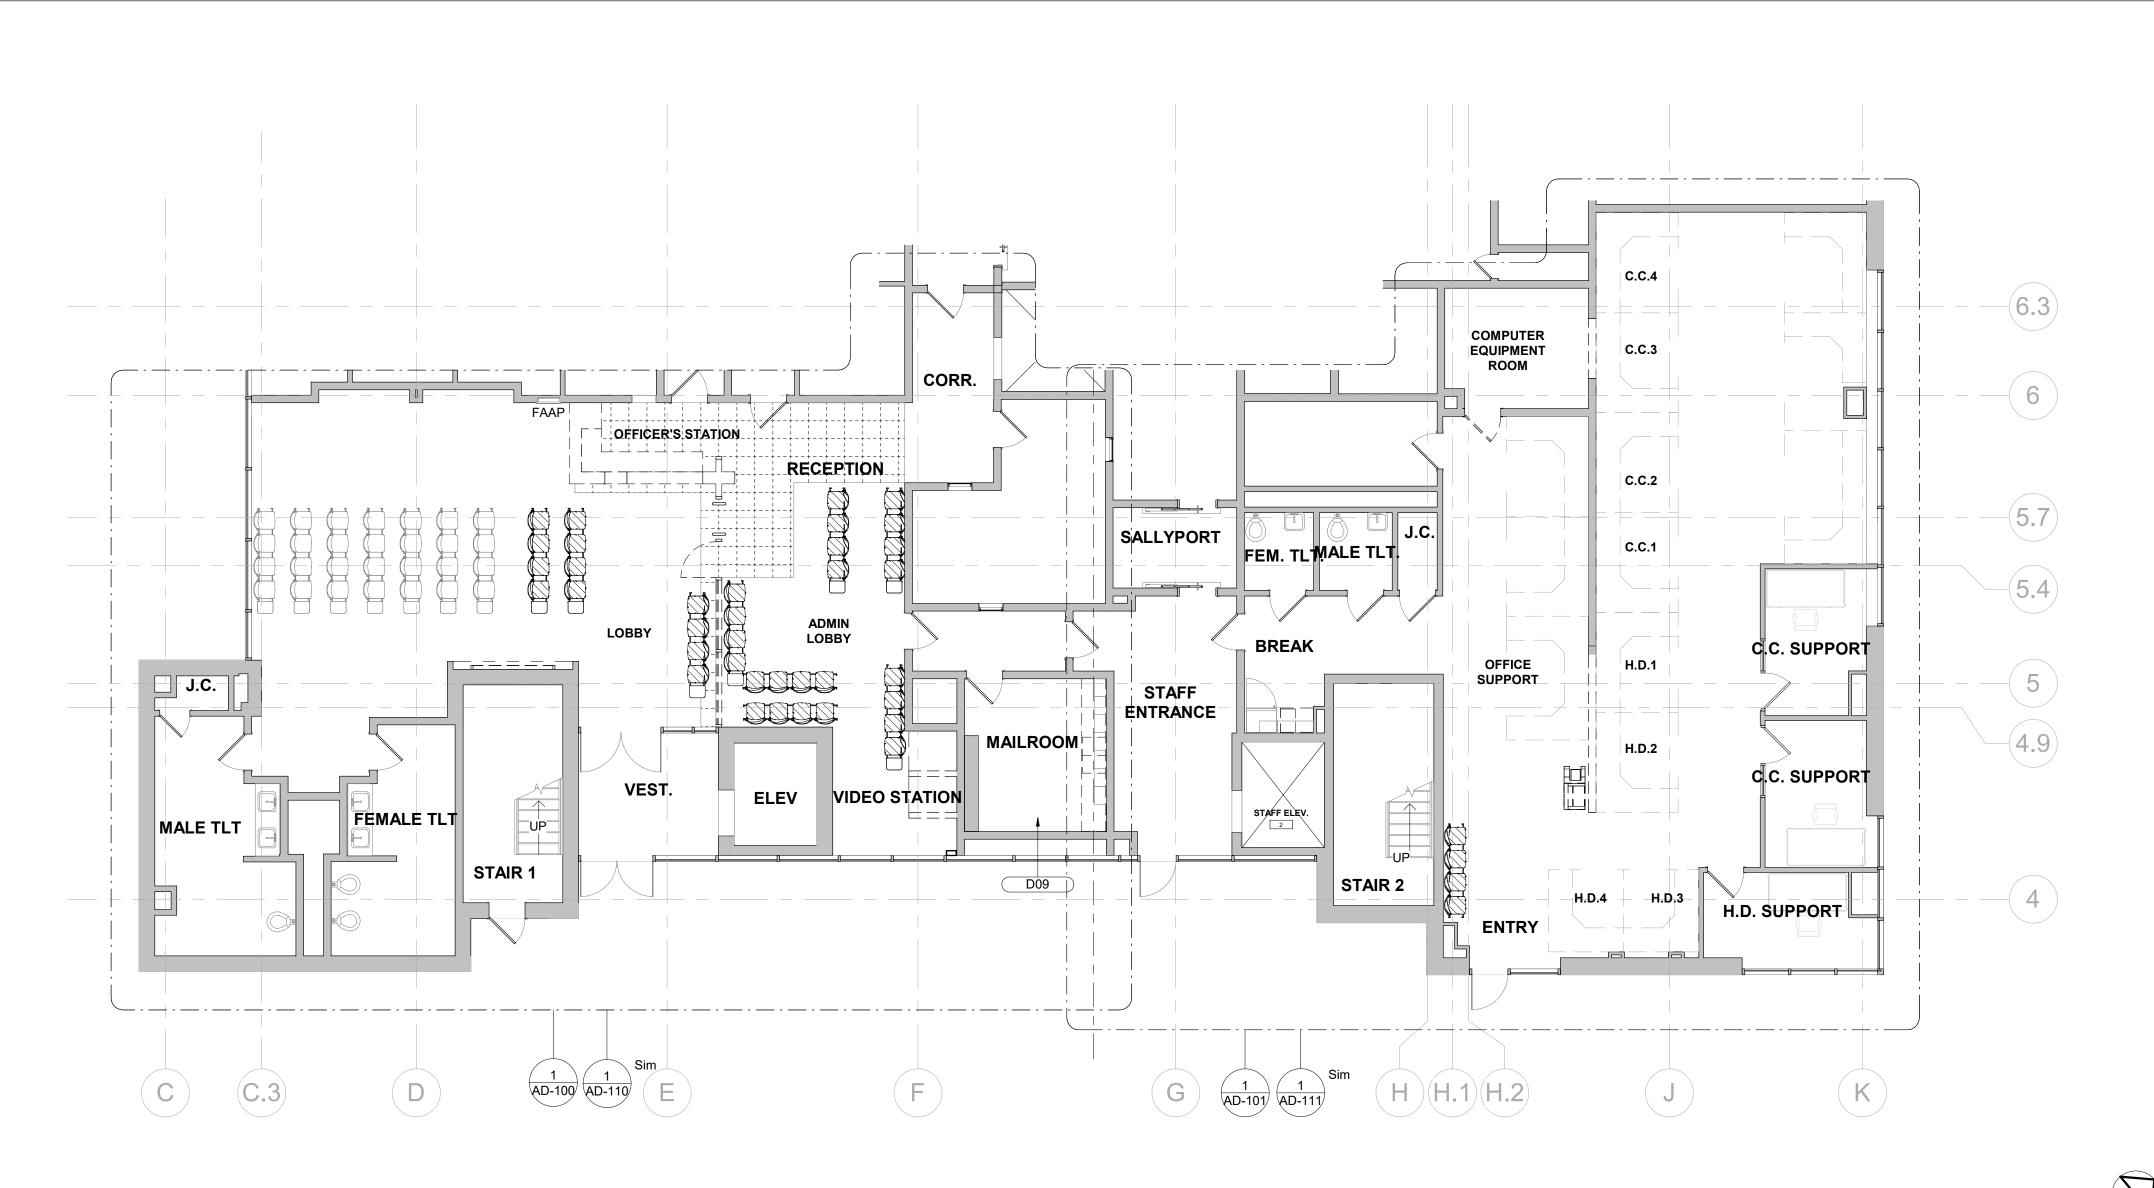

OVERALL DEMOLITION PLAN - AREA OF WORK

1/8" = 1'-0"

GENERAL DEMONOTES

- A. ALL DEMOLITION WORK SHALL BE PERFORMED FOLLOWING THE STRICTEST SAFETY STANDARDS TO PROTECT OCCUPANTS AND WORKERS. STRICTLY FOLLOWING OSHA, AND COUNTY SAFETY REGULATIONS. ALL DEMOLITION WORK SHALL BE PERFORMED SO AS NOT TO DAMAGE UNAFFECTED AREAS INDICATED BY THE DEMOLITION DRAWINGS. THE CONTRACTOR SHALL PROTECT THE EXISTING BUILDING AND ITS CONTENTS AGAINST DAMAGE FROM ANY SOURCE RELATED TO THEIR WORK. ANY DAMAGE TO THE EXISTING CONSTRUCTION TO REMAI SHALL BE REPAIRED TO MATCH EXISTING CONDITIONS AT NO ADDITIONAL COST TO THE OWNER BY THE CONTRACTOR RESPONSIBLE FOR THE DAMAGE.
- B. THE CONTRACTOR SHALL REMOVE FROM THE PREMISES ALL ACCUMULATED CONSTRUCTION DEBRIS AND RUBBISH AS CONSEQUENTIAL OFTHEIR WORK ON A DAILY BASIS. THE CONTRACTOR SHALL PAY FOR THEIR REQUIRED REMOVAL AND DISPOSAL FEES.
- C. THE CONTRACTOR SHALL COORDINATE WITH THE OWNER FOR ESTABLISHING AND MAINTAINING ON-SITE STORAGE. SECURITY FOR ALL EQUIPMENT AND MATERIALS IS THE RESPONSIBILITY OF THE CONTRACTOR.
- D. THE CONTRACTOR SHALL USE ALL PHYSICAL MEANS TO RESTRICT ACCESS AND PROTECT FULLY ALL PERSONS AROUND WORK AREAS, SAFETY AND DEVICES SHALL BE USED IN ACCORDANCE WITH ALL PERTIENT FEDERAL, STATE AND LOCAL SAFETY PRACTICES, STANDARD CODES AND ORDINANCES.
- E. VERIFY ALL EXISTING CONDITIONS PRIOR TO SELECTIVE DEMOLITION. NOTIFY OWNER/ARCHITECT IMMEDIATELY IN THE EVENT OF ANY AMBIGUITY OR INCONSISTENCIES.
- F. ALL DIMENSIONS ARE SHOWN FROM FINISH FACE TO FINISH FACE, UNLESS OTHERWISE NOTED.
- G. COORDINATE ARCHITECTURAL DEMOLITION WORK WITH THAT OF THE MECHANICAL, ELECTRICAL, IT & FIRE ALARM TRADES AND DRAWINGS, VERIFY ALL EXISTING CONDITIONS IN THE FIELD AND NOTIFY ARCHITECT OF ANY DISCREPANCY PRIOR TO COMMENCING WORK.
- H. DEMOLITION CONTRACTOR SHALL NOT USE ANY CONSTRUCTION METHODS THAT WILL CAUSE DAMAGE TO WORK TO BE LEFT IN PLACE. REPAIR DAMAGE TO THE EXISTING CONSTRUCTION CAUSED BY WORK UNDER THIS CONTRACT.
- I. OWNER HAS FIRST RIGHT OF REFUSAL OF ALL SALVAGEABLE ITEMS. CONTRACTOR SHALL COORDINATE WITH THE OWNER OR THEIR AUTHORIZED REPRESENTATIVE, TO DETERMINE ALL EXISTING EQUIPMENT AND DEVICES TO BE RETAINED BY THE OWNER. CONTRACTOR SHALL CAREFULLY REMOVEALL EQUIPMENT AND DEVICES TO BE RETAINED, PRESERVE AND STORE THE EQUIPMENT IN A LOCATION DESIGNATED BY THE OWNER. ALL OTHER DEVICES, EQUIPMENT, AND DEBRIS SHALL BE DISPOSED OF BY THE CONTRACTOR AT AN APPROPRIATE OFFSITE LOCATION.
- J. COORDINATE ALL CEILING MOUNTED EQUIPMENT WITH MEP DRAWINGS AND FIRE PROTECTION & FIRE ALARM DRAWINGS.
- K. ALL CEILING MOUNTED EQUIPMENT IS ON MEP DRAWINGS AND FIRE PROTECTION & FIRE ALARM DRAWINGS.
- L. REMOVE WALLS INDICATED TO BE DEMOLISHED FROM FLOOR TO STRUCTURE ABOVE AND INCLUDE ALL MECHANICAL, ELECTRICAL, EQUIPMENT, ETC. PREPARE ALL DISTURBED AREAS FOR NEW CONSTRUCTION.
- M. WHERE PARTIAL DEMOLITION OF A WALL IS REQUIRED, COORDINATE EXTENT AND LOCATION OF REMOVED PORTION WITH NEW CONSTRUCTION PLAN AND FIELD CONDITIONS.
- N. CLOSE OFF AND PATCH OPENINGS AND VOIDS LEFT BY THE REMOVAL OF EXISTING CONSTRUCTION, EQUIPMENT, PIPING, DUCTS, ELECTRICAL DEVICES, ETC. PREPARE ALL DISTURBED AREAS FOR NEW CONSTRUCTION.
- O. NO SAW CUTTING OF CMU. ALL MASONRY TO BE TOOTHED IN REMOVE ANY DAMAGED CMU.
- P. CONTRACTOR IS RESPONSIBLE FOR REMOVING AND STORING ALL FURNITURE AND EQUIPMENT FROM WORK AREA DURING CONSTRUCTION. CONTRACTOR IS RESPONSIBLE FOR RETURNING ALL FURNITURE AND EQUIPMENT AFTER CONSTRUCTION IS COMPLETE. COORDINATE STORAGE WITH OWNER.

KEY PLAN LEGEND





AD-001

CONTRACT NUMBER
25122 PO0

JOB ORDER NUMBER
PROJ-10001187

PROJ-10001187

SHEET 3 OF 60

DRAWING NUMBER

2025-2114

FILE NO.: 8

AS-BUILT / REVISION BY DATE P.W.A. NO. KEY SHEET POSITION SHT DRAWING SCALE PROFESSIONAL CERTIFICATION PROPERTY MANAGEMENT HEREBY CERTIFY THAT THESE DOCUMENTS WERE PREPARED 41NE2 | PLAN SCALE: | As indicated R APPROVED BY ME, AND THAT I AM A DULY LICENSED R.O.W NO. PROPERTY MANAGER ROFESSIONAL ARCHITECT UNDER THE LAWS OF THE STATE OF PROFILE SCALE: EXPIRATION DATE 06/13/2027 CONTRACT COMPLETION BOX BUREAU OF ENGINEERING AND CONSTRUCTION TRAFFIC HIGHWAYS STRUCTURES STORM DRAINS SEWER WATER FIELD ENGINEE Frank Elwood Dittenhafer, II REVIEWED BY: AS-BUILT PER RECORD PRINT CHKD BY: RDT DATE REVIEWED:

SUBDIVISION: TOWSON

FIRST FLOOR DEMOLITION PLAN

RENOVATION

720 BOSLEY AVENUE, TOWSON, MD 21204

BALTIMORE COUNTY OFFICE OF BUDGET AND FINANCE - PROPERTY MANAGEMENT

BCDC LOBBY RENOVATIONS


PROPERTY MANAGEMENT

SUBDIVISION: TOWSON

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- N. CLOSE OFF AND PATCH OPENINGS AND VOIDS LEFT BY THE REMOVAL OF EXISTING CONSTRUCTION, EQUIPMENT, PIPING, DUCTS, ELECTRICAL DEVICES, ETC. PREPARE ALL DISTURBED AREAS FOR NEW CONSTRUCTION.
- O. NO SAW CUTTING OF CMU. ALL MASONRY TO BE TOOTHED IN REMOVE ANY DAMAGED CMU.
- P. CONTRACTOR IS RESPONSIBLE FOR REMOVING AND STORING ALL FURNITURE AND EQUIPMENT FROM WORK AREA DURING CONSTRUCTION. CONTRACTOR IS RESPONSIBLE FOR RETURNING ALL FURNITURE AND EQUIPMENT AFTER CONSTRUCTION IS COMPLETE. COORDINATE STORAGE WITH OWNER.

	KEYNOTE LEGEND
TAG	DESCRIPTION
D01	REMOVE AND DISCARD RECEPTION DESK IN ITS ENTIRETY.
D02	REMOVE AND DISCARD DISPLAY CASE AND TACK BOARD IN THEIR ENTIRETY. PATCH AND PAINT WALL AS REQUIRED.
D03	REMOVE AND DISCARD INTERIOR STOREFRONT IN ITS ENTIRETY. PATCH AND PAINT WALL AS REQUIRED.
D04	REMOVE AND DISCARD CERAMIC TILE FLOORING IN ITS ENTIRETY DOWN TO FLOOR SLAB. PREP SLAB FOR INSTALLATION OF NEW FLOOR FINISH PER MFG'S REQUIREMENTS.
D05	REMOVE CHAIRS AND SALVAGE FOR RE-USE. COORDINATE WITH OWNER FOR STORAGE LOCATION.
D05A	REMOVE & RELOCATE CHAIRS PER NEW WORK PLANS.
D06	REMOVE AND DISCARD CARPET FLOORING IN ITS ENTIRETY DOWN TO FLOOR SLAB. PREP SLAB FOR INSTALLATION OF SEALED CONCRETE PER MFG'S REQUIREMENTS.
D07	REMOVE AND DISCARD CMU WING WALL UP TO ROOF DECK IN ITS ENTIRETY.
D08	REMOVE AND DISCARD (2) BASE CABINETS AND COUNTER. COUNTER MOUNTING BRACKETS TO REMAIN FOR REUSE.
D14	REMOVE AND DISCARD SCANNER AT OWNER'S DISCRETION.
D20	REMOVE AND DISCARD VINYL TILE FLOORING IN ITS ENTIRETY DOWN TO SLAB. PREP SLAB FOR SEALED CONCRETE FINISH PER MFG'S REQUIREMENTS.
D21	REMOVE AND DISCARD VINYL WALL BASE IN ITS ENTIRETY.

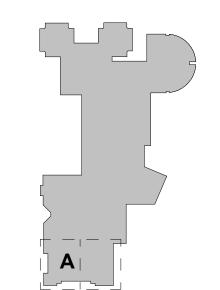

KEY PLAN LEGEND - AREA A



805 North Charles Street, Baltimore, Maryland 2120 410-625-4823 voice 410-625-4674 fax

SHEET DESIGNATION AD-100

CONTRACT NUMBER 25122 PO0

JOB ORDER NUMBER

PROJ-10001187 SHEET 4 OF 60 DRAWING NUMBER 2025-2115

file no.: 8

BALTIMORE COUNTY OFFICE OF BUDGET AND FINANCE - PROPERTY MANAGEMENT

BCDC LOBBY RENOVATIONS ENLARGED DEMO PLAN - AREA A

RENOVATION

720 BOSLEY AVENUE, TOWSON, MD 21204

ELECTION DIST. NO.: 9C6




PROFESSIONAL CERTIFICATION

HEREBY CERTIFY THAT THESE DOCUMENTS WERE PREPARED PLAN SCALE: As indicated APPROVED BY ME, AND THAT I AM A DULY LICENSED R.O.W NO. PROPERTY MANAGER OFESSIONAL ARCHITECT UNDER THE LAWS OF THE STATE O PROFILE SCALE 06/13/2027 CONTRACT COMPLETION BOX BUREAU OF ENGINEERING AND CONSTRUCTION TRAFFIC HIGHWAYS STRUCTURES STORM DRAINS SEWER WATER FIELD ENGINE Frank Elwood Dittenhafer, II REVIEWED BY: AS-BUILT PER RECORD PRINT CHKD BY: RDT DATE REVIEWED:

BY DATE P.W.A. NO. KEY SHEET POSITION SHT DRAWING SCALE

AS-BUILT / REVISION

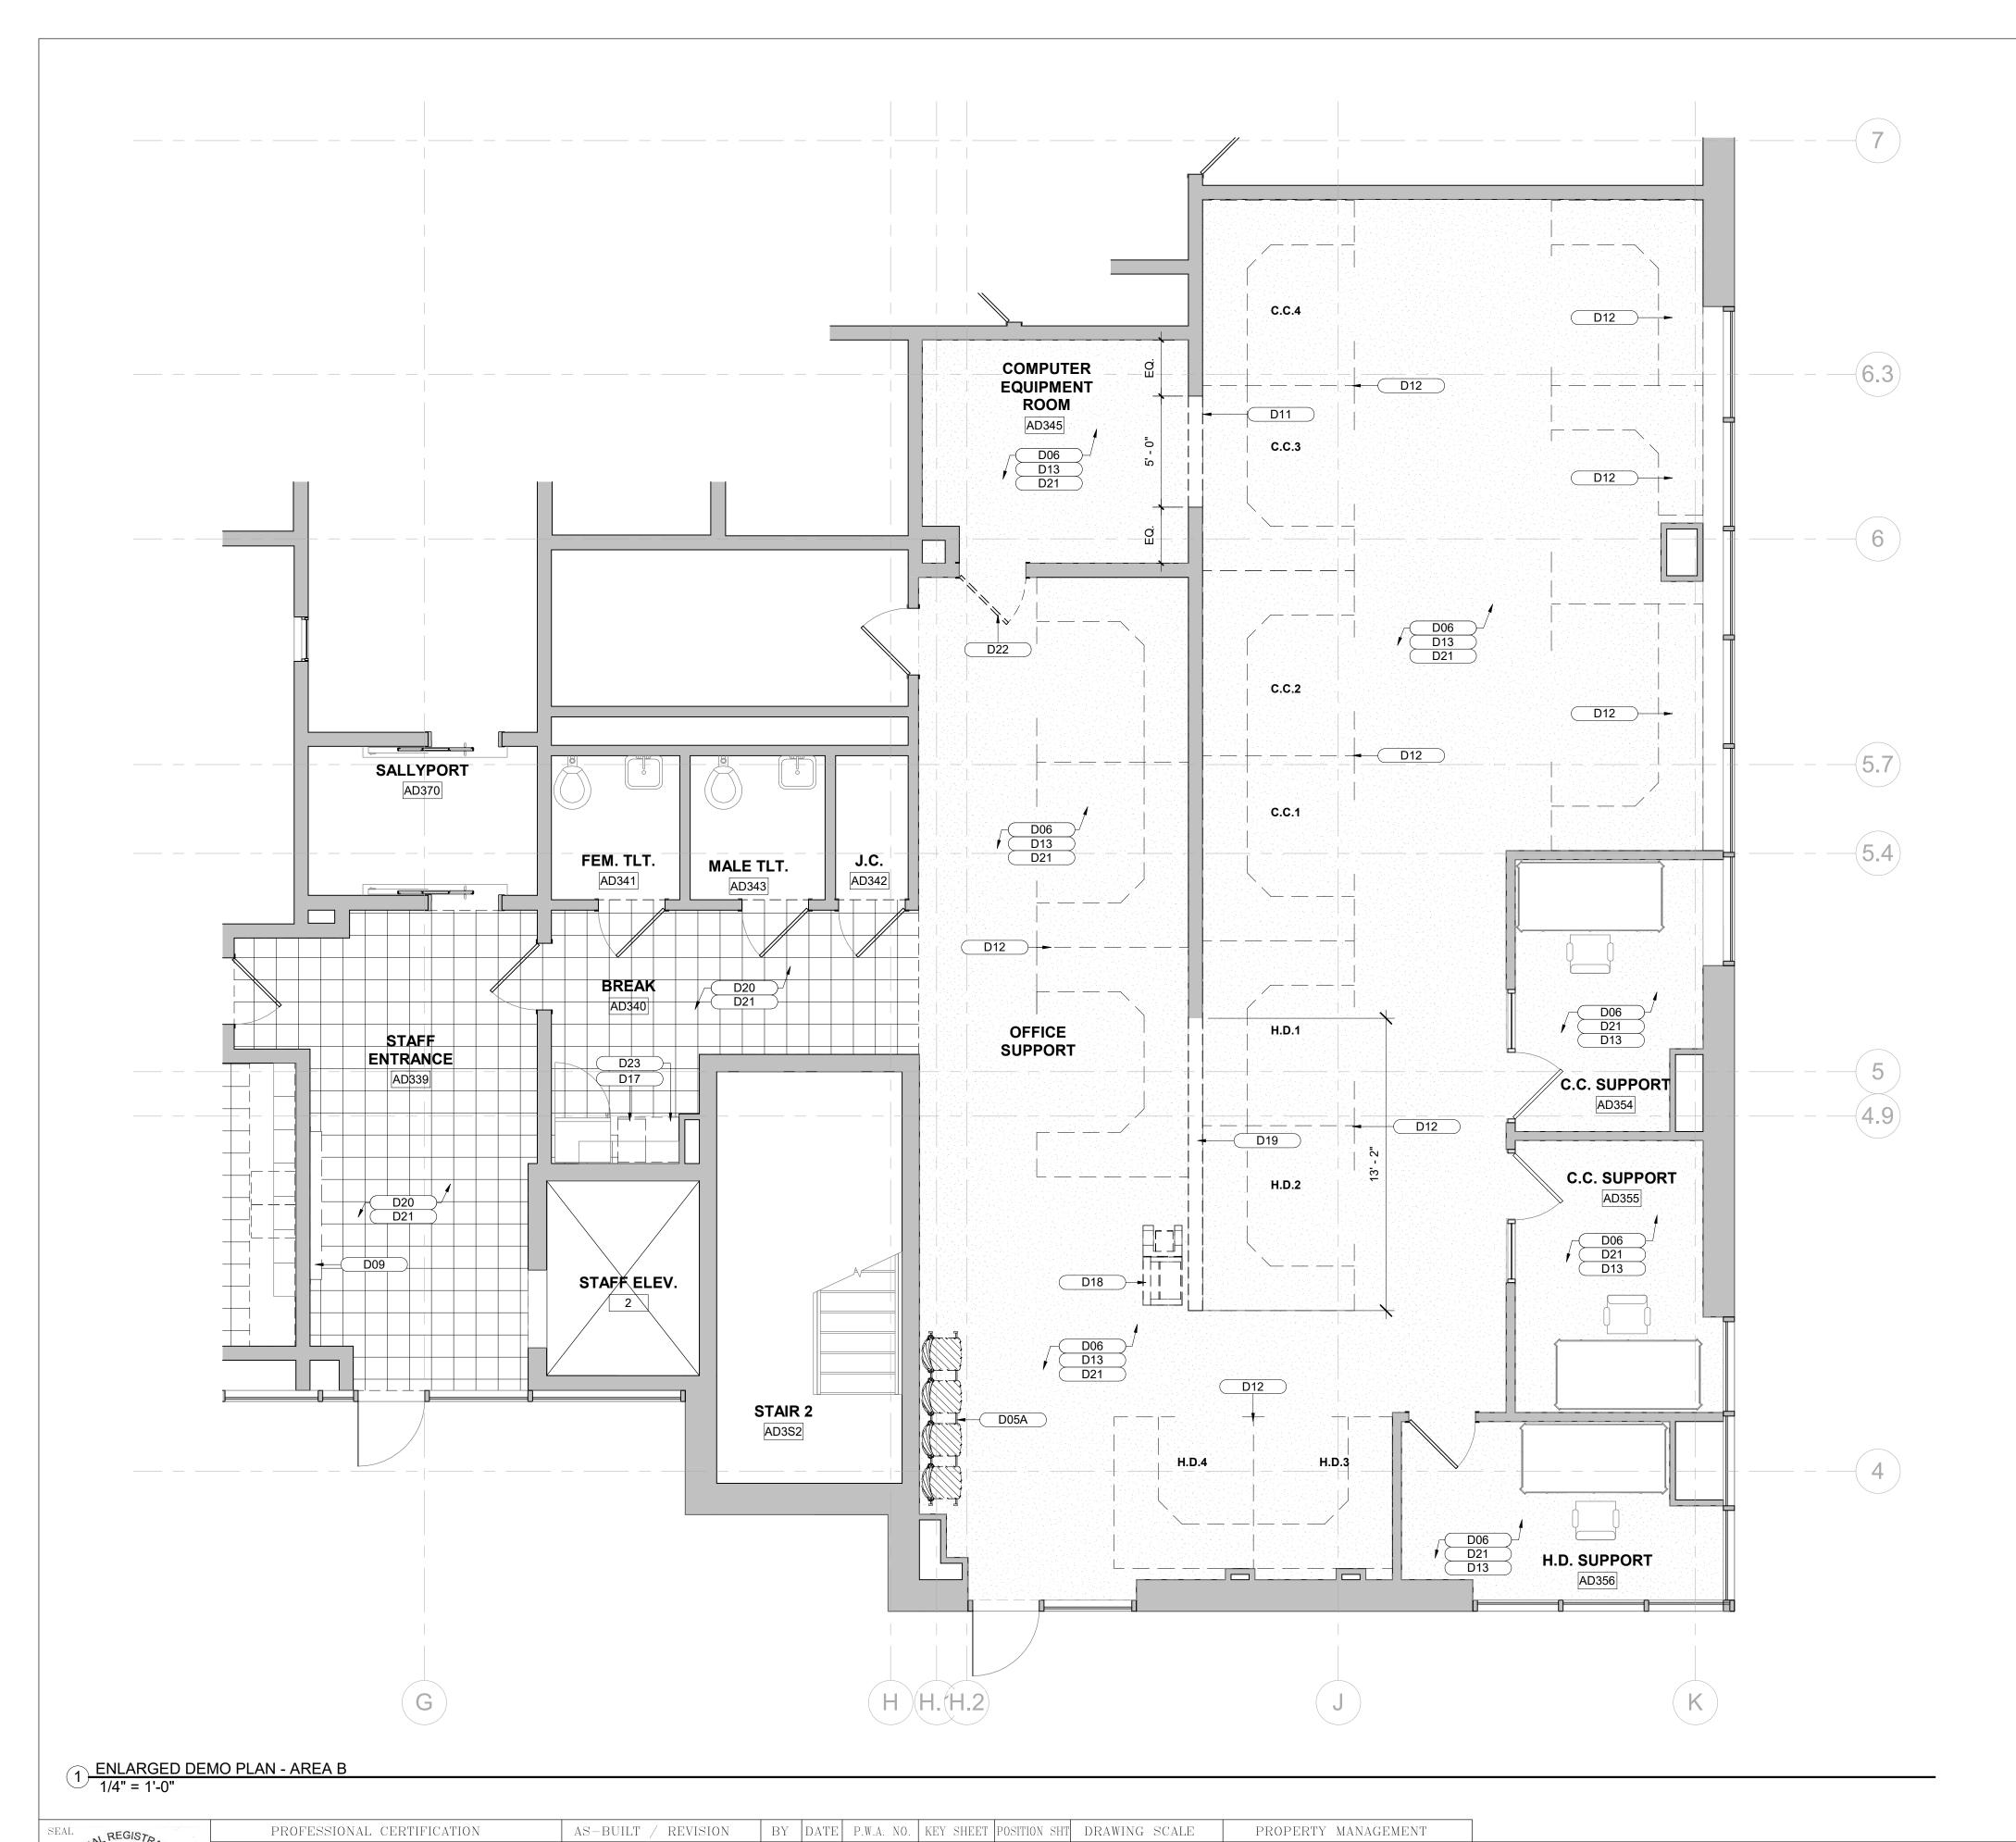

PLAN SCALE: As indicated

FIELD ENGINE

PROFILE SCALE

WATER

SEWER

PROPERTY MANAGER

SUBDIVISION: TOWSON

R.O.W NO.

TRAFFIC HIGHWAYS STRUCTURES STORM DRAINS

HEREBY CERTIFY THAT THESE DOCUMENTS WERE PREPARED

OFESSIONAL ARCHITECT UNDER THE LAWS OF THE STATE O

06/13/2027

CHKD BY: RDT

CONTRACT COMPLETION BOX

BUREAU OF ENGINEERING AND CONSTRUCTION

REVIEWED BY:

DATE REVIEWED:

APPROVED BY ME, AND THAT I AM A DULY LICENSED


Frank Elwood Dittenhafer, II

AS-BUILT PER RECORD PRINT

GENERAL DEMO NOTES

- A. ALL DEMOLITION WORK SHALL BE PERFORMED FOLLOWING THE STRICTEST SAFETY STANDARDS TO PROTECT OCCUPANTS AND WORKERS. STRICTLY FOLLOWING OSHA, AND COUNTY SAFETY REGULATIONS. ALL DEMOLITION WORK SHALL BE PERFORMED SO AS NOT TO DAMAGE UNAFFECTED AREAS INDICATED BY THE DEMOLITION DRAWINGS. THE CONTRACTOR SHALL PROTECT THE EXISTING BUILDING AND ITS CONTENTS AGAINST DAMAGE FROM ANY SOURCE RELATED TO THEIR WORK. ANY DAMAGE TO THE EXISTING CONSTRUCTION TO REMAI SHALL BE REPAIRED TO MATCH EXISTING CONDITIONS AT NO ADDITIONAL COST TO THE OWNER BY THE CONTRACTOR RESPONSIBLE FOR THE DAMAGE.
- B. THE CONTRACTOR SHALL REMOVE FROM THE PREMISES ALL ACCUMULATED CONSTRUCTION DEBRIS AND RUBBISH AS CONSEQUENTIAL OFTHEIR WORK ON A DAILY BASIS. THE CONTRACTOR SHALL PAY FOR THEIR REQUIRED REMOVAL AND DISPOSAL FEES.
- C. THE CONTRACTOR SHALL COORDINATE WITH THE OWNER FOR ESTABLISHING AND MAINTAINING ON-SITE STORAGE. SECURITY FOR ALL EQUIPMENT AND MATERIALS IS THE RESPONSIBILITY OF THE CONTRACTOR.
- D. THE CONTRACTOR SHALL USE ALL PHYSICAL MEANS TO RESTRICT ACCESS AND PROTECT FULLY ALL PERSONS AROUND WORK AREAS, SAFETY AND DEVICES SHALL BE USED IN ACCORDANCE WITH ALL PERTIENT FEDERAL, STATE AND LOCAL SAFETY PRACTICES, STANDARD CODES AND ORDINANCES.
- E. VERIFY ALL EXISTING CONDITIONS PRIOR TO SELECTIVE DEMOLITION. NOTIFY OWNER/ARCHITECT IMMEDIATELY IN THE EVENT OF ANY AMBIGUITY OR INCONSISTENCIES.
- F. ALL DIMENSIONS ARE SHOWN FROM FINISH FACE TO FINISH FACE, UNLESS OTHERWISE NOTED.
- G. COORDINATE ARCHITECTURAL DEMOLITION WORK WITH THAT OF THE MECHANICAL, ELECTRICAL, IT & FIRE ALARM TRADES AND DRAWINGS, VERIFY ALL EXISTING CONDITIONS IN THE FIELD AND NOTIFY ARCHITECT OF ANY DISCREPANCY PRIOR TO COMMENCING WORK.
- H. DEMOLITION CONTRACTOR SHALL NOT USE ANY CONSTRUCTION METHODS THAT WILL CAUSE DAMAGE TO WORK TO BE LEFT IN PLACE. REPAIR DAMAGE TO THE EXISTING CONSTRUCTION CAUSED BY WORK UNDER THIS
- I. OWNER HAS FIRST RIGHT OF REFUSAL OF ALL SALVAGEABLE ITEMS. CONTRACTOR SHALL COORDINATE WITH THE OWNER OR THEIR AUTHORIZED REPRESENTATIVE, TO DETERMINE ALL EXISTING EQUIPMENT AND DEVICES TO BE RETAINED BY THE OWNER. CONTRACTOR SHALL CAREFULLY REMOVEALL EQUIPMENT AND DEVICES TO BE RETAINED, PRESERVE AND STORE THE EQUIPMENT IN A LOCATION DESIGNATED BY THE OWNER. ALL OTHER DEVICES, EQUIPMENT, AND DEBRIS SHALL BE DISPOSED OF BY THE CONTRACTOR AT AN APPROPRIATE OFFSITE
- J. COORDINATE ALL CEILING MOUNTED EQUIPMENT WITH MEP DRAWINGS AND FIRE PROTECTION & FIRE ALARM
- K. ALL CEILING MOUNTED EQUIPMENT IS ON MEP DRAWINGS AND FIRE PROTECTION & FIRE ALARM DRAWINGS.
- L. REMOVE WALLS INDICATED TO BE DEMOLISHED FROM FLOOR TO STRUCTURE ABOVE AND INCLUDE ALL MECHANICAL, ELECTRICAL, EQUIPMENT, ETC. PREPARE ALL DISTURBED AREAS FOR NEW CONSTRUCTION.
- M. WHERE PARTIAL DEMOLITION OF A WALL IS REQUIRED, COORDINATE EXTENT AND LOCATION OF REMOVED
- PORTION WITH NEW CONSTRUCTION PLAN AND FIELD CONDITIONS.
- N. CLOSE OFF AND PATCH OPENINGS AND VOIDS LEFT BY THE REMOVAL OF EXISTING CONSTRUCTION, EQUIPMENT, PIPING, DUCTS, ELECTRICAL DEVICES, ETC. PREPARE ALL DISTURBED AREAS FOR NEW CONSTRUCTION.
- O. NO SAW CUTTING OF CMU. ALL MASONRY TO BE TOOTHED IN REMOVE ANY DAMAGED CMU.
- P. CONTRACTOR IS RESPONSIBLE FOR REMOVING AND STORING ALL FURNITURE AND EQUIPMENT FROM WORK AREA DURING CONSTRUCTION. CONTRACTOR IS RESPONSIBLE FOR RETURNING ALL FURNITURE AND EQUIPMENT AFTER CONSTRUCTION IS COMPLETE. COORDINATE STORAGE WITH OWNER.

	KEYNOTE LEGEND
TAG	DESCRIPTION
D05A	REMOVE & RELOCATE CHAIRS PER NEW WORK PLANS.
D06	REMOVE AND DISCARD CARPET FLOORING IN ITS ENTIRETY DOWN TO FLOOR SLAB. PREP SLAB FOR INSTALLATION OF SEALED CONCRETE PER MFG'S REQUIREMENTS.
D09	REMOVE GUN LOCKER AND SALVAGE FOR RE-USE. COORDINATE WITH OWNER FOR NEW LOCATION. PATCH AND PAINT WALL AS REQUIRED.
D11	REMOVE AND DISCARD PORTION OF CMU WALL. PATCH AND PAINT TO MATCH EXISTING. REFER TO STRUCTURAL FOR LINTEL REQUIREMENTS.
D12	REMOVE CUBICLES IN THEIR ENTIRETY. SALVAGE FOR RE-USE. COORDINATE WITH OWNER FOR STORAGE LOCATION.
D13	REMOVE ALL EXISTING EQUIPMENT AND FURNITURE. COORDINATE WITH OWNER FOR STORAGE LOCATION.
D17	REMOVE AND DISCARD COUNTERTOP.
D18	RELOCATE OFFICE PRINTER, SEE NEW WORK PLANS.
D19	REMOVE AND DISCARD PORTION OF CMU WALL TO EXTENTS SHOWN.
D20	REMOVE AND DISCARD VINYL TILE FLOORING IN ITS ENTIRETY DOWN TO SLAB. PREP SLAB FOR SEALED CONCRETE FINISH PER MFG'S REQUIREMENTS.
D21	REMOVE AND DISCARD VINYL WALL BASE IN ITS ENTIRETY.
D22	REMOVE AND DISCARD HOLLOW METAL DOOR AND FRAME IN ITS ENTIRETY, INCLUDING HARDWARE.
D23	REMOVE AND DISCARD BASE CABINETS. SALVAGE SINK FOR RE-USE.

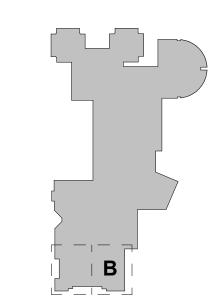

KEY PLAN LEGEND - AREA B



SHEET DESIGNATION AD-101

CONTRACT NUMBER 25122 PO0

JOB ORDER NUMBER PROJ-10001187 SHEET 5 OF 60 DRAWING NUMBER

2025-2116 file no.: 8


BALTIMORE COUNTY OFFICE OF BUDGET AND FINANCE - PROPERTY MANAGEMENT

BCDC LOBBY RENOVATIONS

ENLARGED DEMO PLAN - AREA B

RENOVATION

720 BOSLEY AVENUE, TOWSON, MD 21204

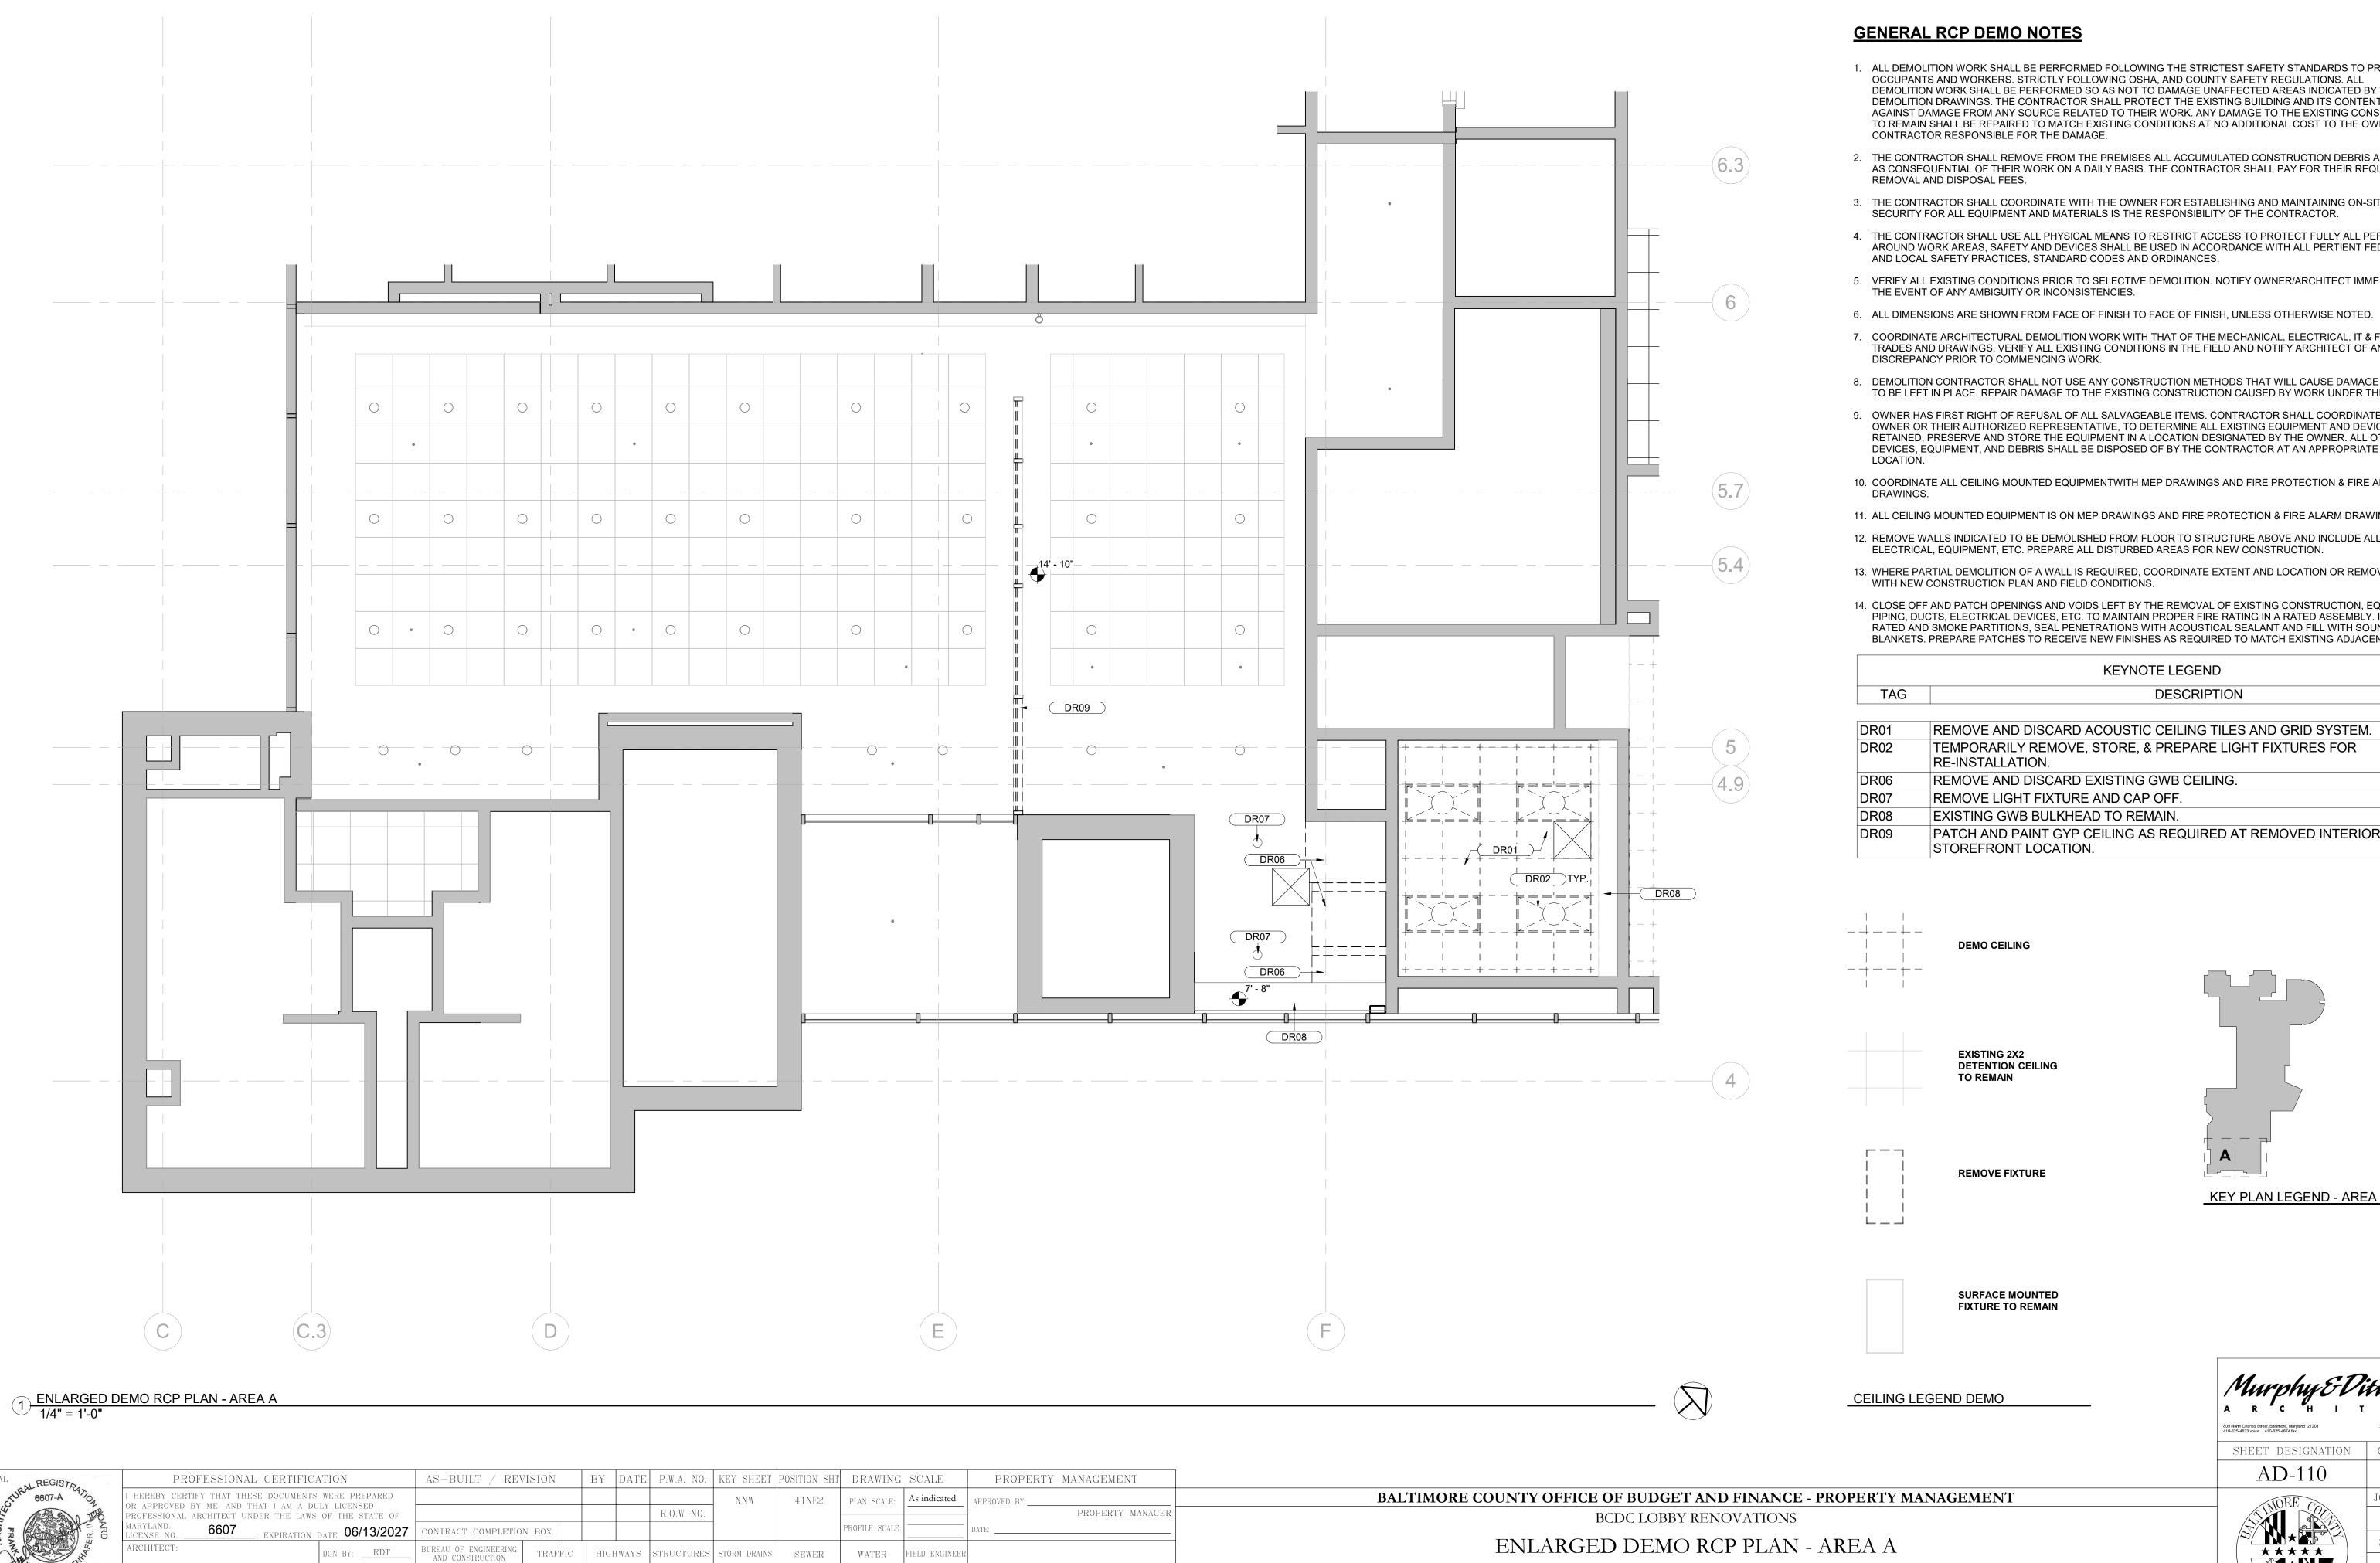

SUBDIVISION: TOWSON

Frank Elwood Dittenhafer, II

AS-BUILT PER RECORD PRINT


REVIEWED BY:

DATE REVIEWED:

CHKD BY: RDT

- 1. ALL DEMOLITION WORK SHALL BE PERFORMED FOLLOWING THE STRICTEST SAFETY STANDARDS TO PROTECT OCCUPANTS AND WORKERS. STRICTLY FOLLOWING OSHA, AND COUNTY SAFETY REGULATIONS. ALL DEMOLITION WORK SHALL BE PERFORMED SO AS NOT TO DAMAGE UNAFFECTED AREAS INDICATED BY THE DEMOLITION DRAWINGS. THE CONTRACTOR SHALL PROTECT THE EXISTING BUILDING AND ITS CONTENTS AGAINST DAMAGE FROM ANY SOURCE RELATED TO THEIR WORK. ANY DAMAGE TO THE EXISTING CONSTRUCTION TO REMAIN SHALL BE REPAIRED TO MATCH EXISTING CONDITIONS AT NO ADDITIONAL COST TO THE OWNER BY THE
- 2. THE CONTRACTOR SHALL REMOVE FROM THE PREMISES ALL ACCUMULATED CONSTRUCTION DEBRIS AND RUBBISH AS CONSEQUENTIAL OF THEIR WORK ON A DAILY BASIS. THE CONTRACTOR SHALL PAY FOR THEIR REQUIRED
- 3. THE CONTRACTOR SHALL COORDINATE WITH THE OWNER FOR ESTABLISHING AND MAINTAINING ON-SITE STORAGE. SECURITY FOR ALL EQUIPMENT AND MATERIALS IS THE RESPONSIBILITY OF THE CONTRACTOR.
- 4. THE CONTRACTOR SHALL USE ALL PHYSICAL MEANS TO RESTRICT ACCESS TO PROTECT FULLY ALL PERSONS AROUND WORK AREAS, SAFETY AND DEVICES SHALL BE USED IN ACCORDANCE WITH ALL PERTIENT FEDERAL, STATE
- 5. VERIFY ALL EXISTING CONDITIONS PRIOR TO SELECTIVE DEMOLITION. NOTIFY OWNER/ARCHITECT IMMEDIATELY IN
- 7. COORDINATE ARCHITECTURAL DEMOLITION WORK WITH THAT OF THE MECHANICAL, ELECTRICAL, IT & FIRE ALARM TRADES AND DRAWINGS, VERIFY ALL EXISTING CONDITIONS IN THE FIELD AND NOTIFY ARCHITECT OF ANY
- 8. DEMOLITION CONTRACTOR SHALL NOT USE ANY CONSTRUCTION METHODS THAT WILL CAUSE DAMAGE TO WORK TO BE LEFT IN PLACE. REPAIR DAMAGE TO THE EXISTING CONSTRUCTION CAUSED BY WORK UNDER THIS CONTRACT.
- 9. OWNER HAS FIRST RIGHT OF REFUSAL OF ALL SALVAGEABLE ITEMS. CONTRACTOR SHALL COORDINATE WITH THE OWNER OR THEIR AUTHORIZED REPRESENTATIVE, TO DETERMINE ALL EXISTING EQUIPMENT AND DEVICES TO BE RETAINED. PRESERVE AND STORE THE EQUIPMENT IN A LOCATION DESIGNATED BY THE OWNER, ALL OTHER DEVICES, EQUIPMENT, AND DEBRIS SHALL BE DISPOSED OF BY THE CONTRACTOR AT AN APPROPRIATE OFFSITE
- 10. COORDINATE ALL CEILING MOUNTED EQUIPMENTWITH MEP DRAWINGS AND FIRE PROTECTION & FIRE ALARM
- 11. ALL CEILING MOUNTED EQUIPMENT IS ON MEP DRAWINGS AND FIRE PROTECTION & FIRE ALARM DRAWINGS.
- 12. REMOVE WALLS INDICATED TO BE DEMOLISHED FROM FLOOR TO STRUCTURE ABOVE AND INCLUDE ALL MECHANICAL, ELECTRICAL, EQUIPMENT, ETC. PREPARE ALL DISTURBED AREAS FOR NEW CONSTRUCTION.
- 13. WHERE PARTIAL DEMOLITION OF A WALL IS REQUIRED, COORDINATE EXTENT AND LOCATION OR REMOVED PORTION
- 14. CLOSE OFF AND PATCH OPENINGS AND VOIDS LEFT BY THE REMOVAL OF EXISTING CONSTRUCTION, EQUIPMENT, PIPING, DUCTS, ELECTRICAL DEVICES, ETC. TO MAINTAIN PROPER FIRE RATING IN A RATED ASSEMBLY. IN NON-FIRE-RATED AND SMOKE PARTITIONS, SEAL PENETRATIONS WITH ACOUSTICAL SEALANT AND FILL WITH SOUND ATTENUATION BLANKETS. PREPARE PATCHES TO RECEIVE NEW FINISHES AS REQUIRED TO MATCH EXISTING ADJACENT FINISHES.

	KEYNOTE LEGEND
TAG	DESCRIPTION
DR01	REMOVE AND DISCARD ACOUSTIC CEILING TILES AND GRID SYSTEM.
DR02	TEMPORARILY REMOVE, STORE, & PREPARE LIGHT FIXTURES FOR RE-INSTALLATION.
DR06	REMOVE AND DISCARD EXISTING GWB CEILING.
DR07	REMOVE LIGHT FIXTURE AND CAP OFF.
DR08	EXISTING GWB BULKHEAD TO REMAIN.
DR09	PATCH AND PAINT GYP CEILING AS REQUIRED AT REMOVED INTERIOR STOREFRONT LOCATION.

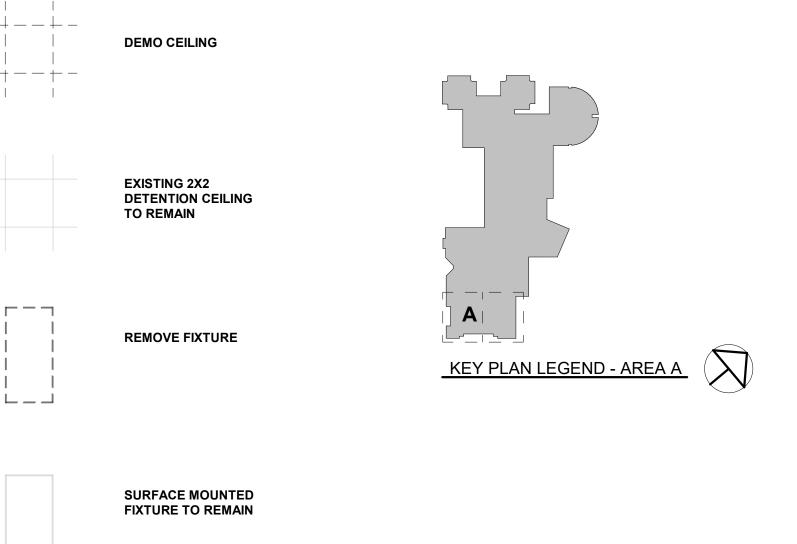

SHEET DESIGNATION

AD-110

CONTRACT NUMBER 25122 PO0


JOB ORDER NUMBER PROJ-10001187


file no.: 8

SHEET 6 OF 60 DRAWING NUMBER 2025-2117

RENOVATION

720 BOSLEY AVENUE, TOWSON, MD 21204

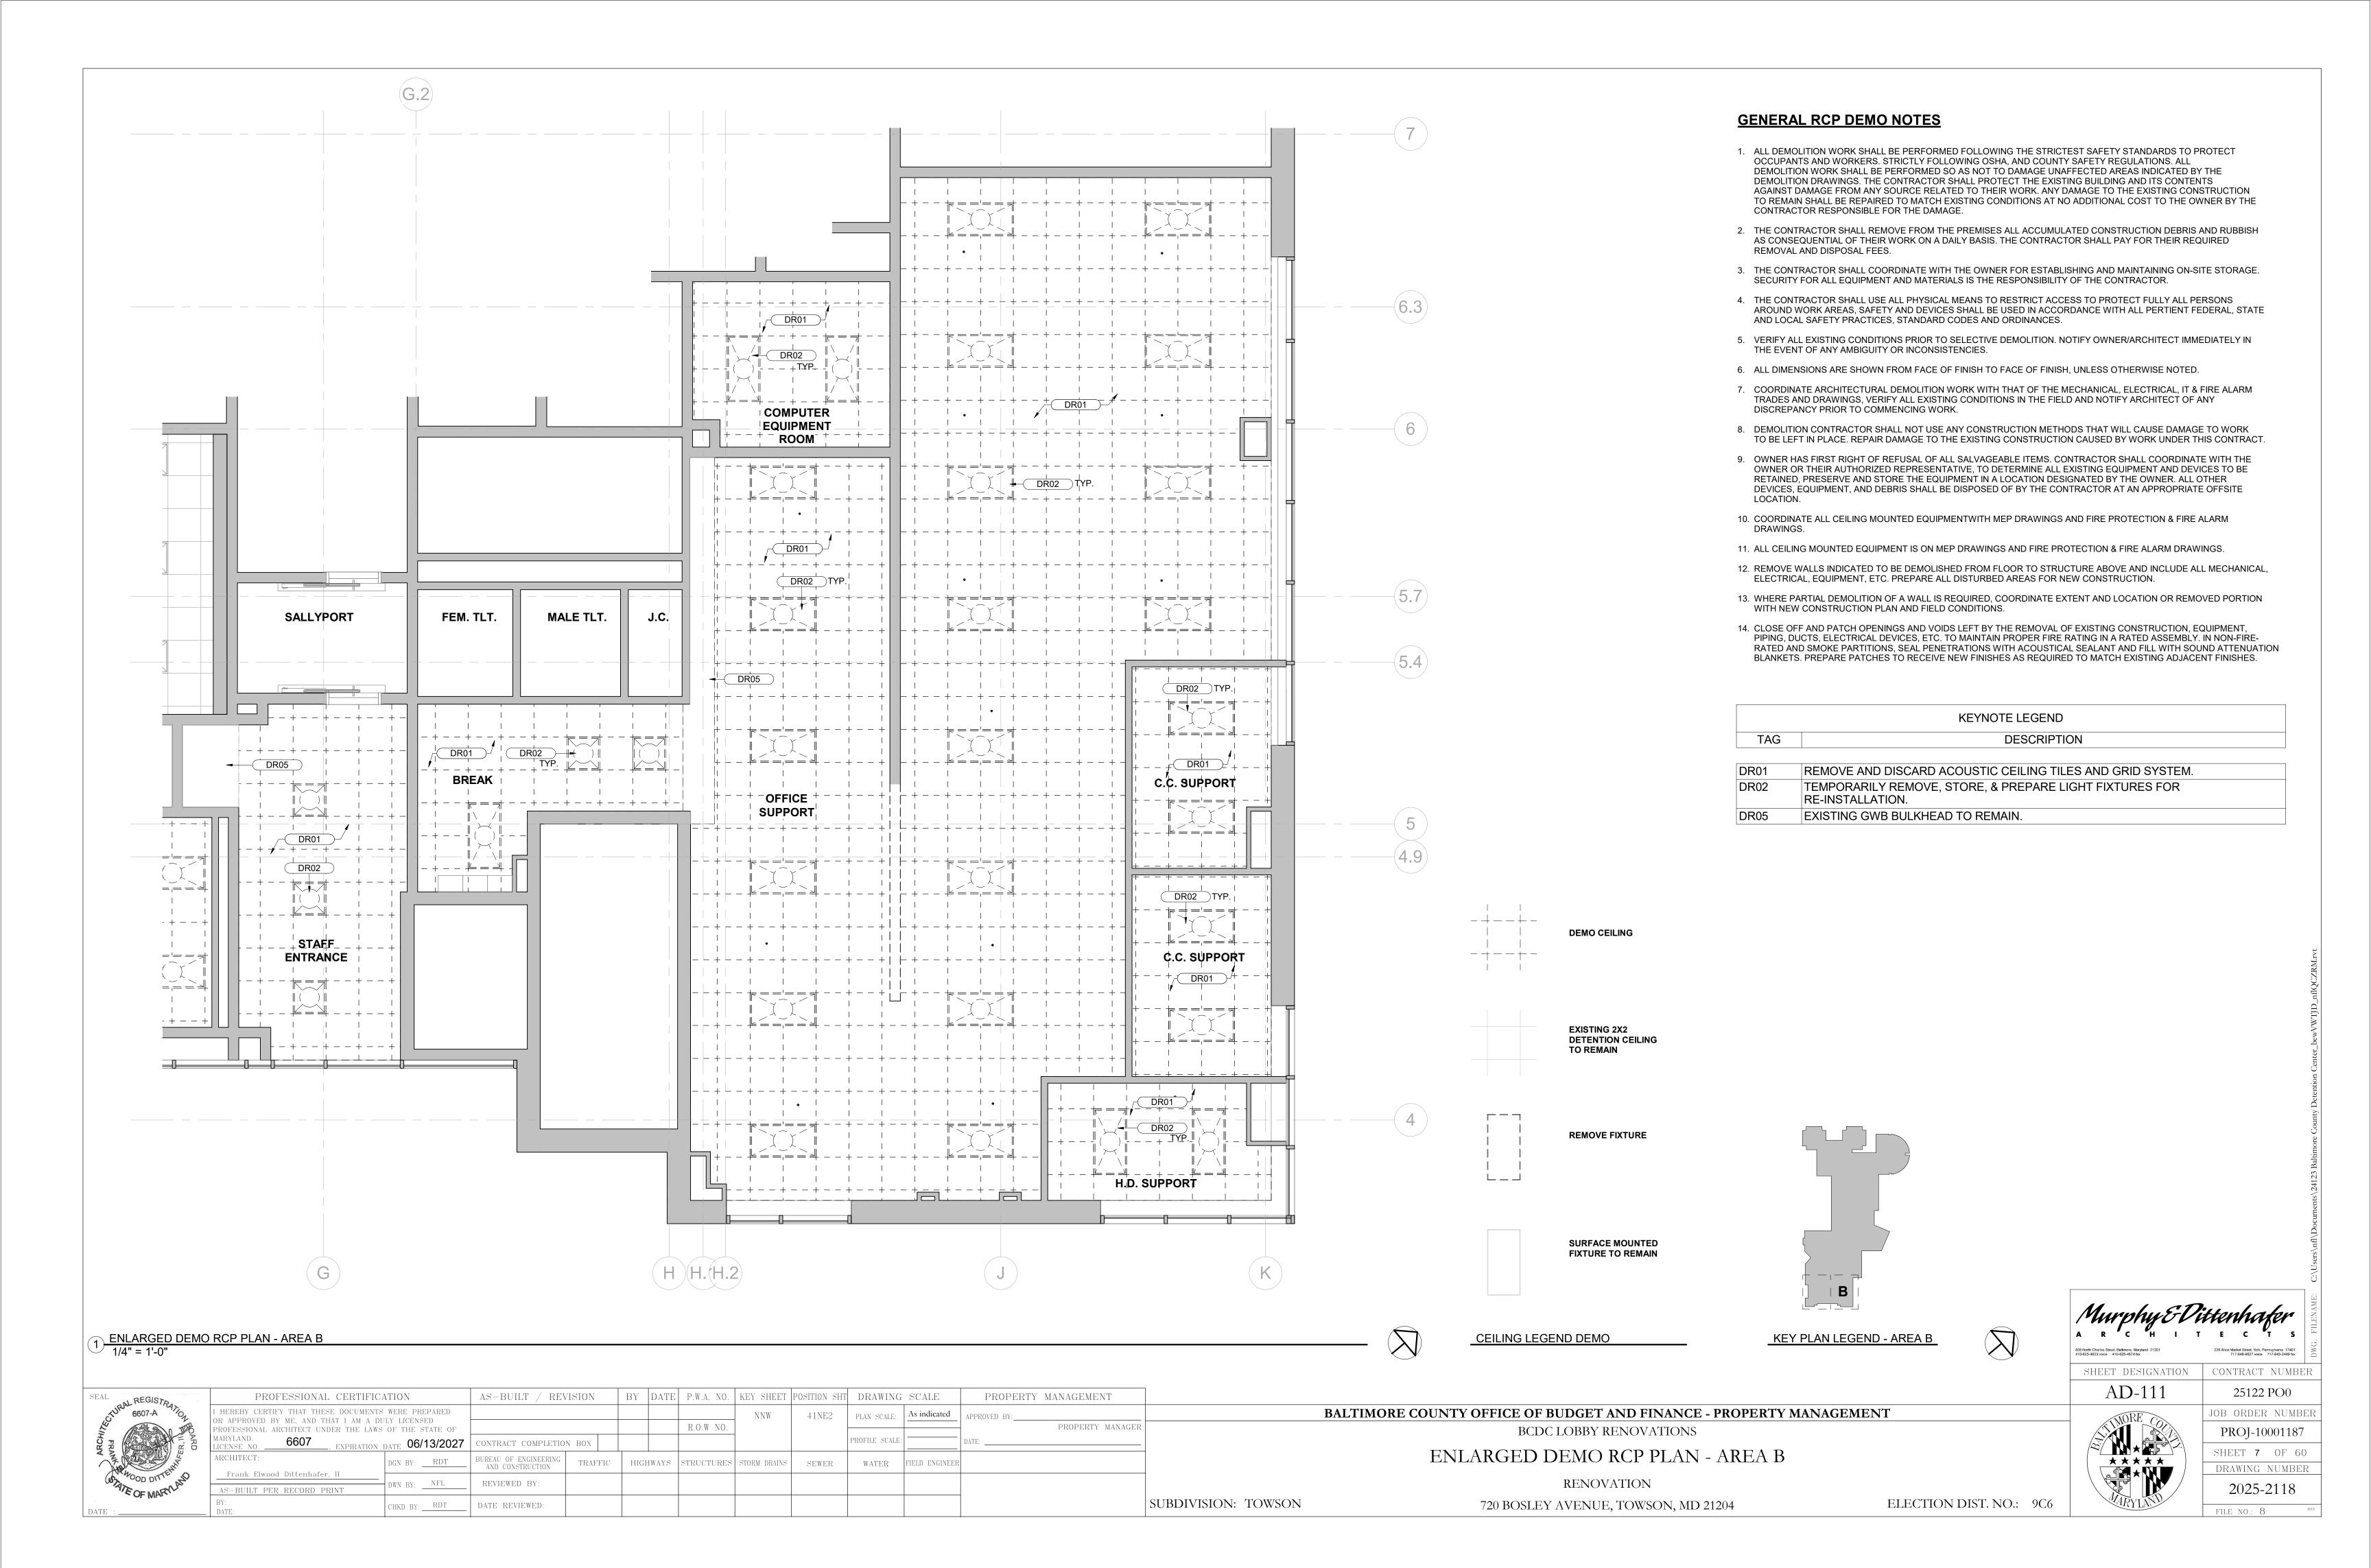

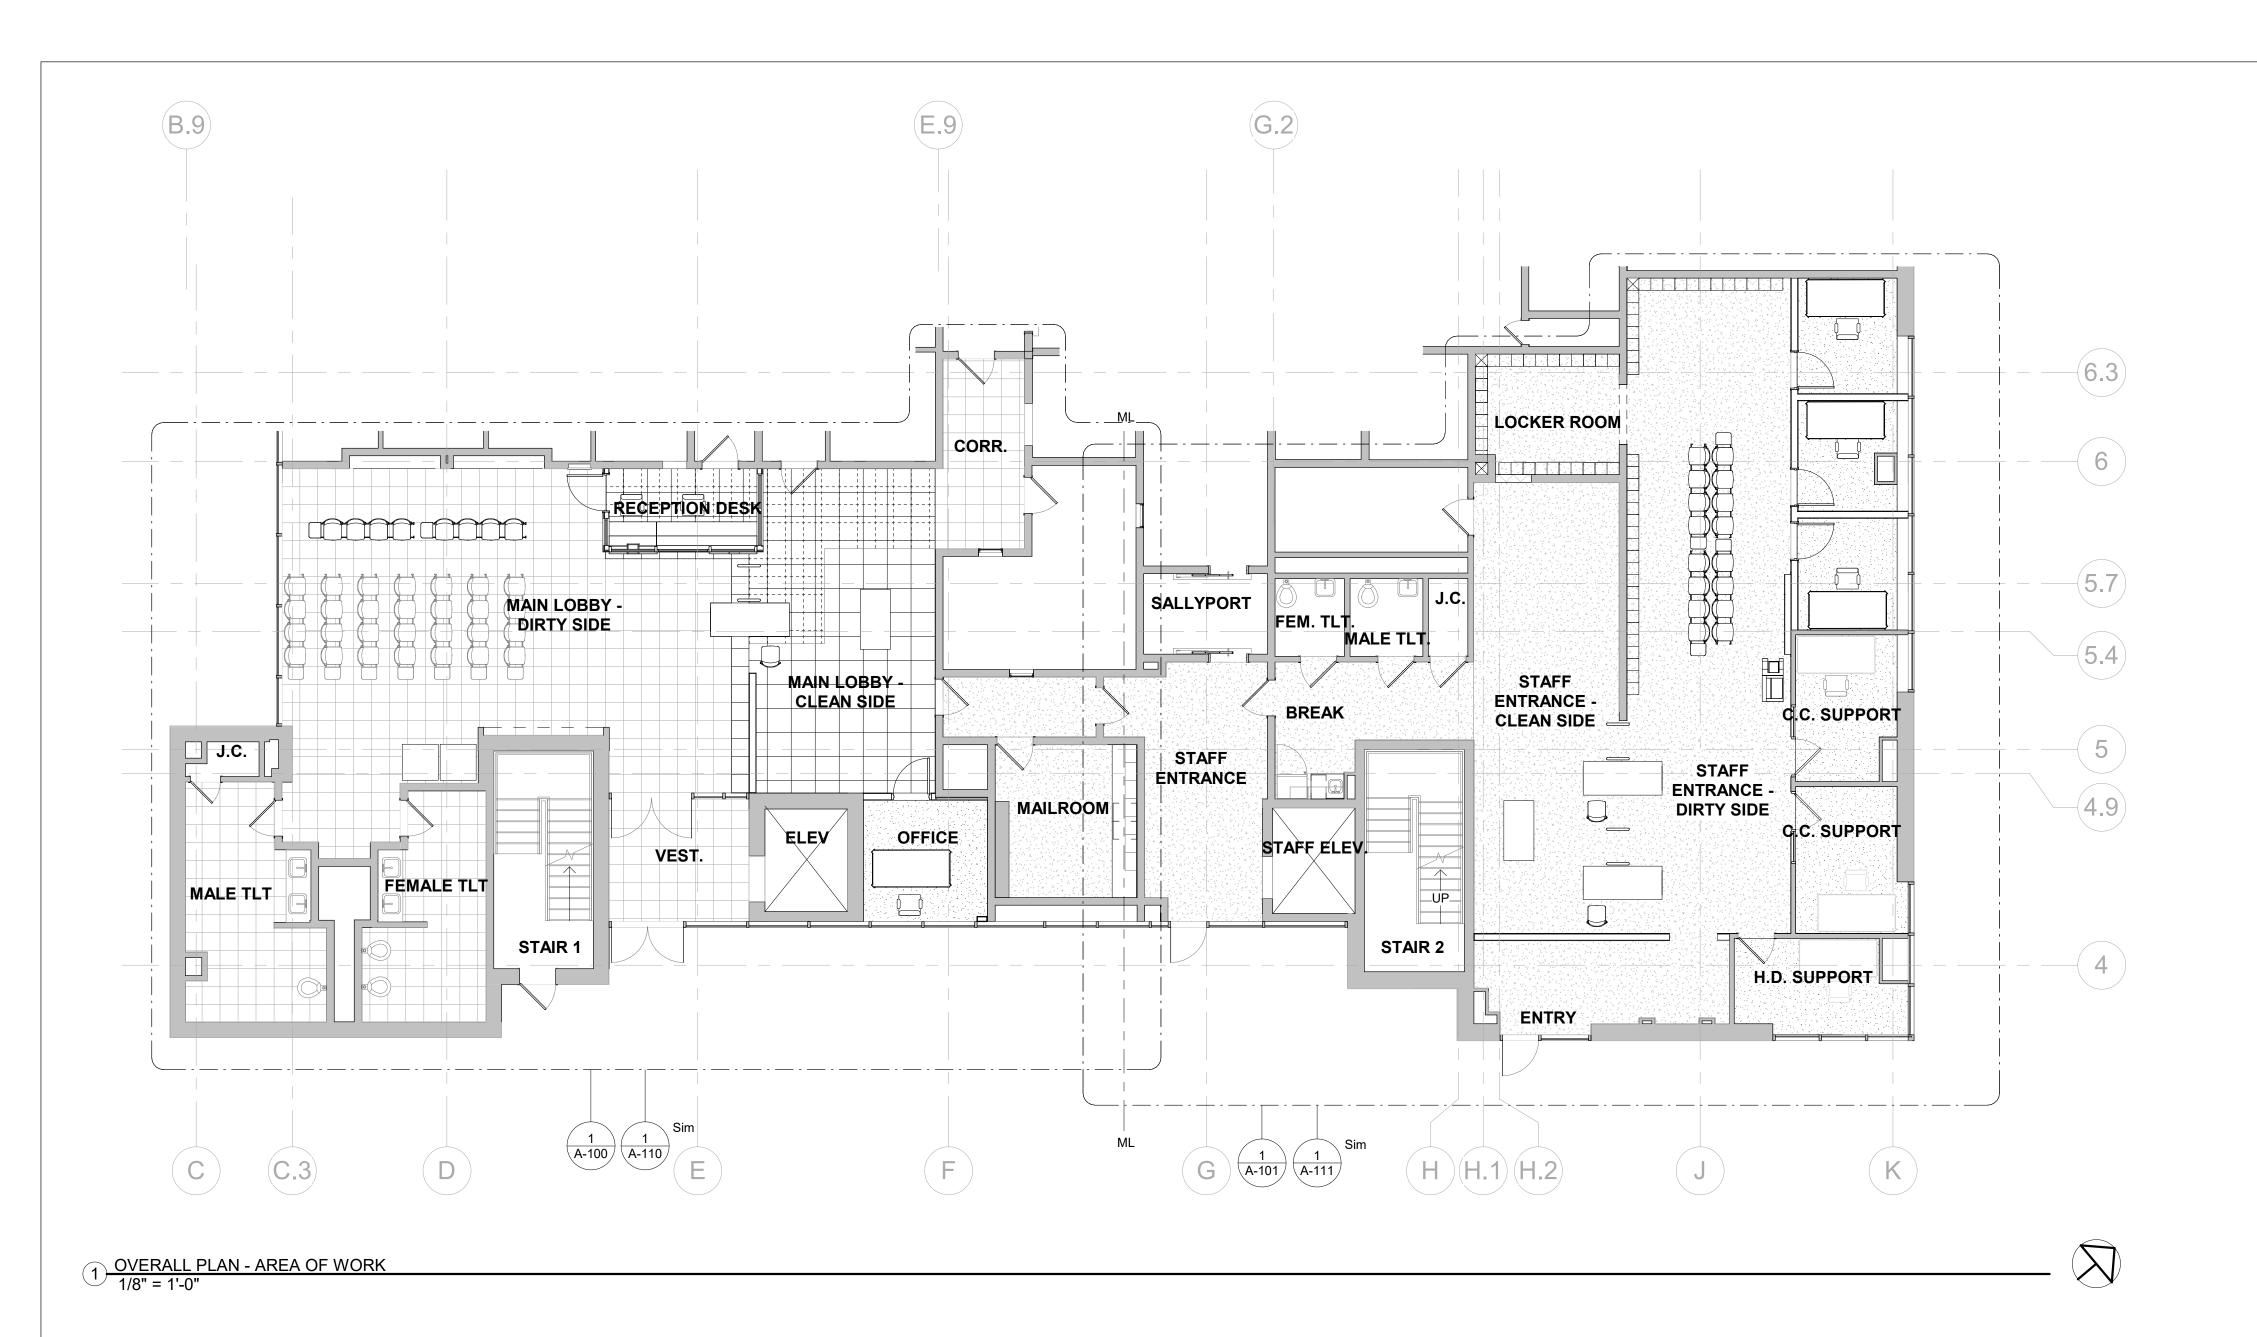

BY DATE P.W.A. NO. KEY SHEET POSITION SHT DRAWING SCALE

R.O.W NO.

TRAFFIC HIGHWAYS STRUCTURES STORM DRAINS SEWER

41NE2 | PLAN SCALE: | As indicated

PROFILE SCALE:

WATER


FIELD ENGINEE

GENERAL CONSTRUCTION NOTES

- 1. ALL DIMENSIONS ARE FROM FACE OF FINISH TO FACE OF FINISH UNLESS OTHERWISE NOTED.
- 2. ALL WORK SHALL CONFORM TO LOCAL AND STATE CODES. LOCAL AND STATE ARE TO TAKE PRECEDENCE OVER THE DRAWINGS AND SPECIFICATIONS. IF DISCREPANCY IS NOTED, INFORM THE ARCHITECT IMMEDIATELY AND BEFORE PROCEEDING WITH WORK.
- 3. CONTRACTOR SHALL VERIFY ALL EXISTING UTILITY LOCATIONS BEFORE INSTALLATION OF NEW PARTITIONS.
- 4. CONTRACTOR SHALL COORDINATE AND SCHEDULE HIS WORK WITH BUILDING OCCUPANTS, FOR MINIMAL DISRUPTION, AND ANY REQUIRED UTILITY SHUT-DOWNS.
- 5. RUN ALL NEW UTILITIES CONCEALED WHERE FEASIBLE WITHIN EXISTING CONSTRUCTION. WHERE IT IS NOT FEASIBLE TO RUN CONCEALED, PAINT UTILITIES TO MATCH ADJACENT FINISH.
- 6. PATCH DISTURBED SURFACES BACK TO THEIR EXISTING CONDITION.
- 7. PAINT NEW WALL PARTITIONS TO MATCH EXISTING .
- 8. WHERE EXISTING WALLS ARE TO BE PATCHED, MATCH TO EXISTING ADJACENT CONDITIONS, TYP.
- 9. NEW SEALANTS: CAULK ALL INTERSECTIONS OF DISSIMILAR MATERIALS WITH SEALANT (WITH EXCEPTION OF ACT).
- 10. REMOVE CEILING TILES AS REQUIRED FOR ACCESS AND ANY REQUIRED UTILITY WORK. WHERE TILES BECOME DAMAGED; REPLACE ACT INKIND - FURNISHED BY GC - CONTRACTOR SHALL PHOTOGRAPH CEILING AREAS TO BE DISTURBED TO DOCUMENT EXISTING CONDITIONS.

NOTES

FURNITURE SHOWN FOR REFERENCE AND TO BE OWNER PROVIDED, CONTRACTOR INSTALLED.

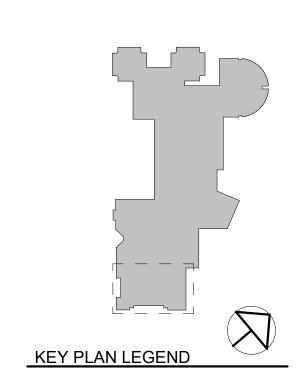

805 North Charles Street, Baltimore, Maryland 21201 410-625-4823 voice 410-625-4674 fax 226 West Market Street, York, Pennsylvania 17401 717-848-8627 voice 717-843-2449 fax

CONTRACT NUMBER 25122 PO0

SHEET DESIGNATION A-001

JOB ORDER NUMBER PROJ-10001187 SHEET **8** OF 60 ***

DRAWING NUMBER 2025-2119 file no.: 8

BALTIMORE COUNTY OFFICE OF BUDGET AND FINANCE - PROPERTY MANAGEMENT BCDC LOBBY RENOVATIONS

AREA OF WORK PLAN

RENOVATION

720 BOSLEY AVENUE, TOWSON, MD 21204

ELECTION DIST. NO.: 9C6



AS-BUILT / REVISION

CONTRACT COMPLETION BOX

BUREAU OF ENGINEERING AND CONSTRUCTION

REVIEWED BY:

DATE REVIEWED:

PROFESSIONAL CERTIFICATION

R APPROVED BY ME, AND THAT I AM A DULY LICENSED

Frank Elwood Dittenhafer, II

AS-BUILT PER RECORD PRINT

HEREBY CERTIFY THAT THESE DOCUMENTS WERE PREPARED

ROFESSIONAL ARCHITECT UNDER THE LAWS OF THE STATE OF


EXPIRATION DATE 06/13/2027

CHKD BY: RDT

SUBDIVISION: TOWSON

PROPERTY MANAGEMENT

PROPERTY MANAGER

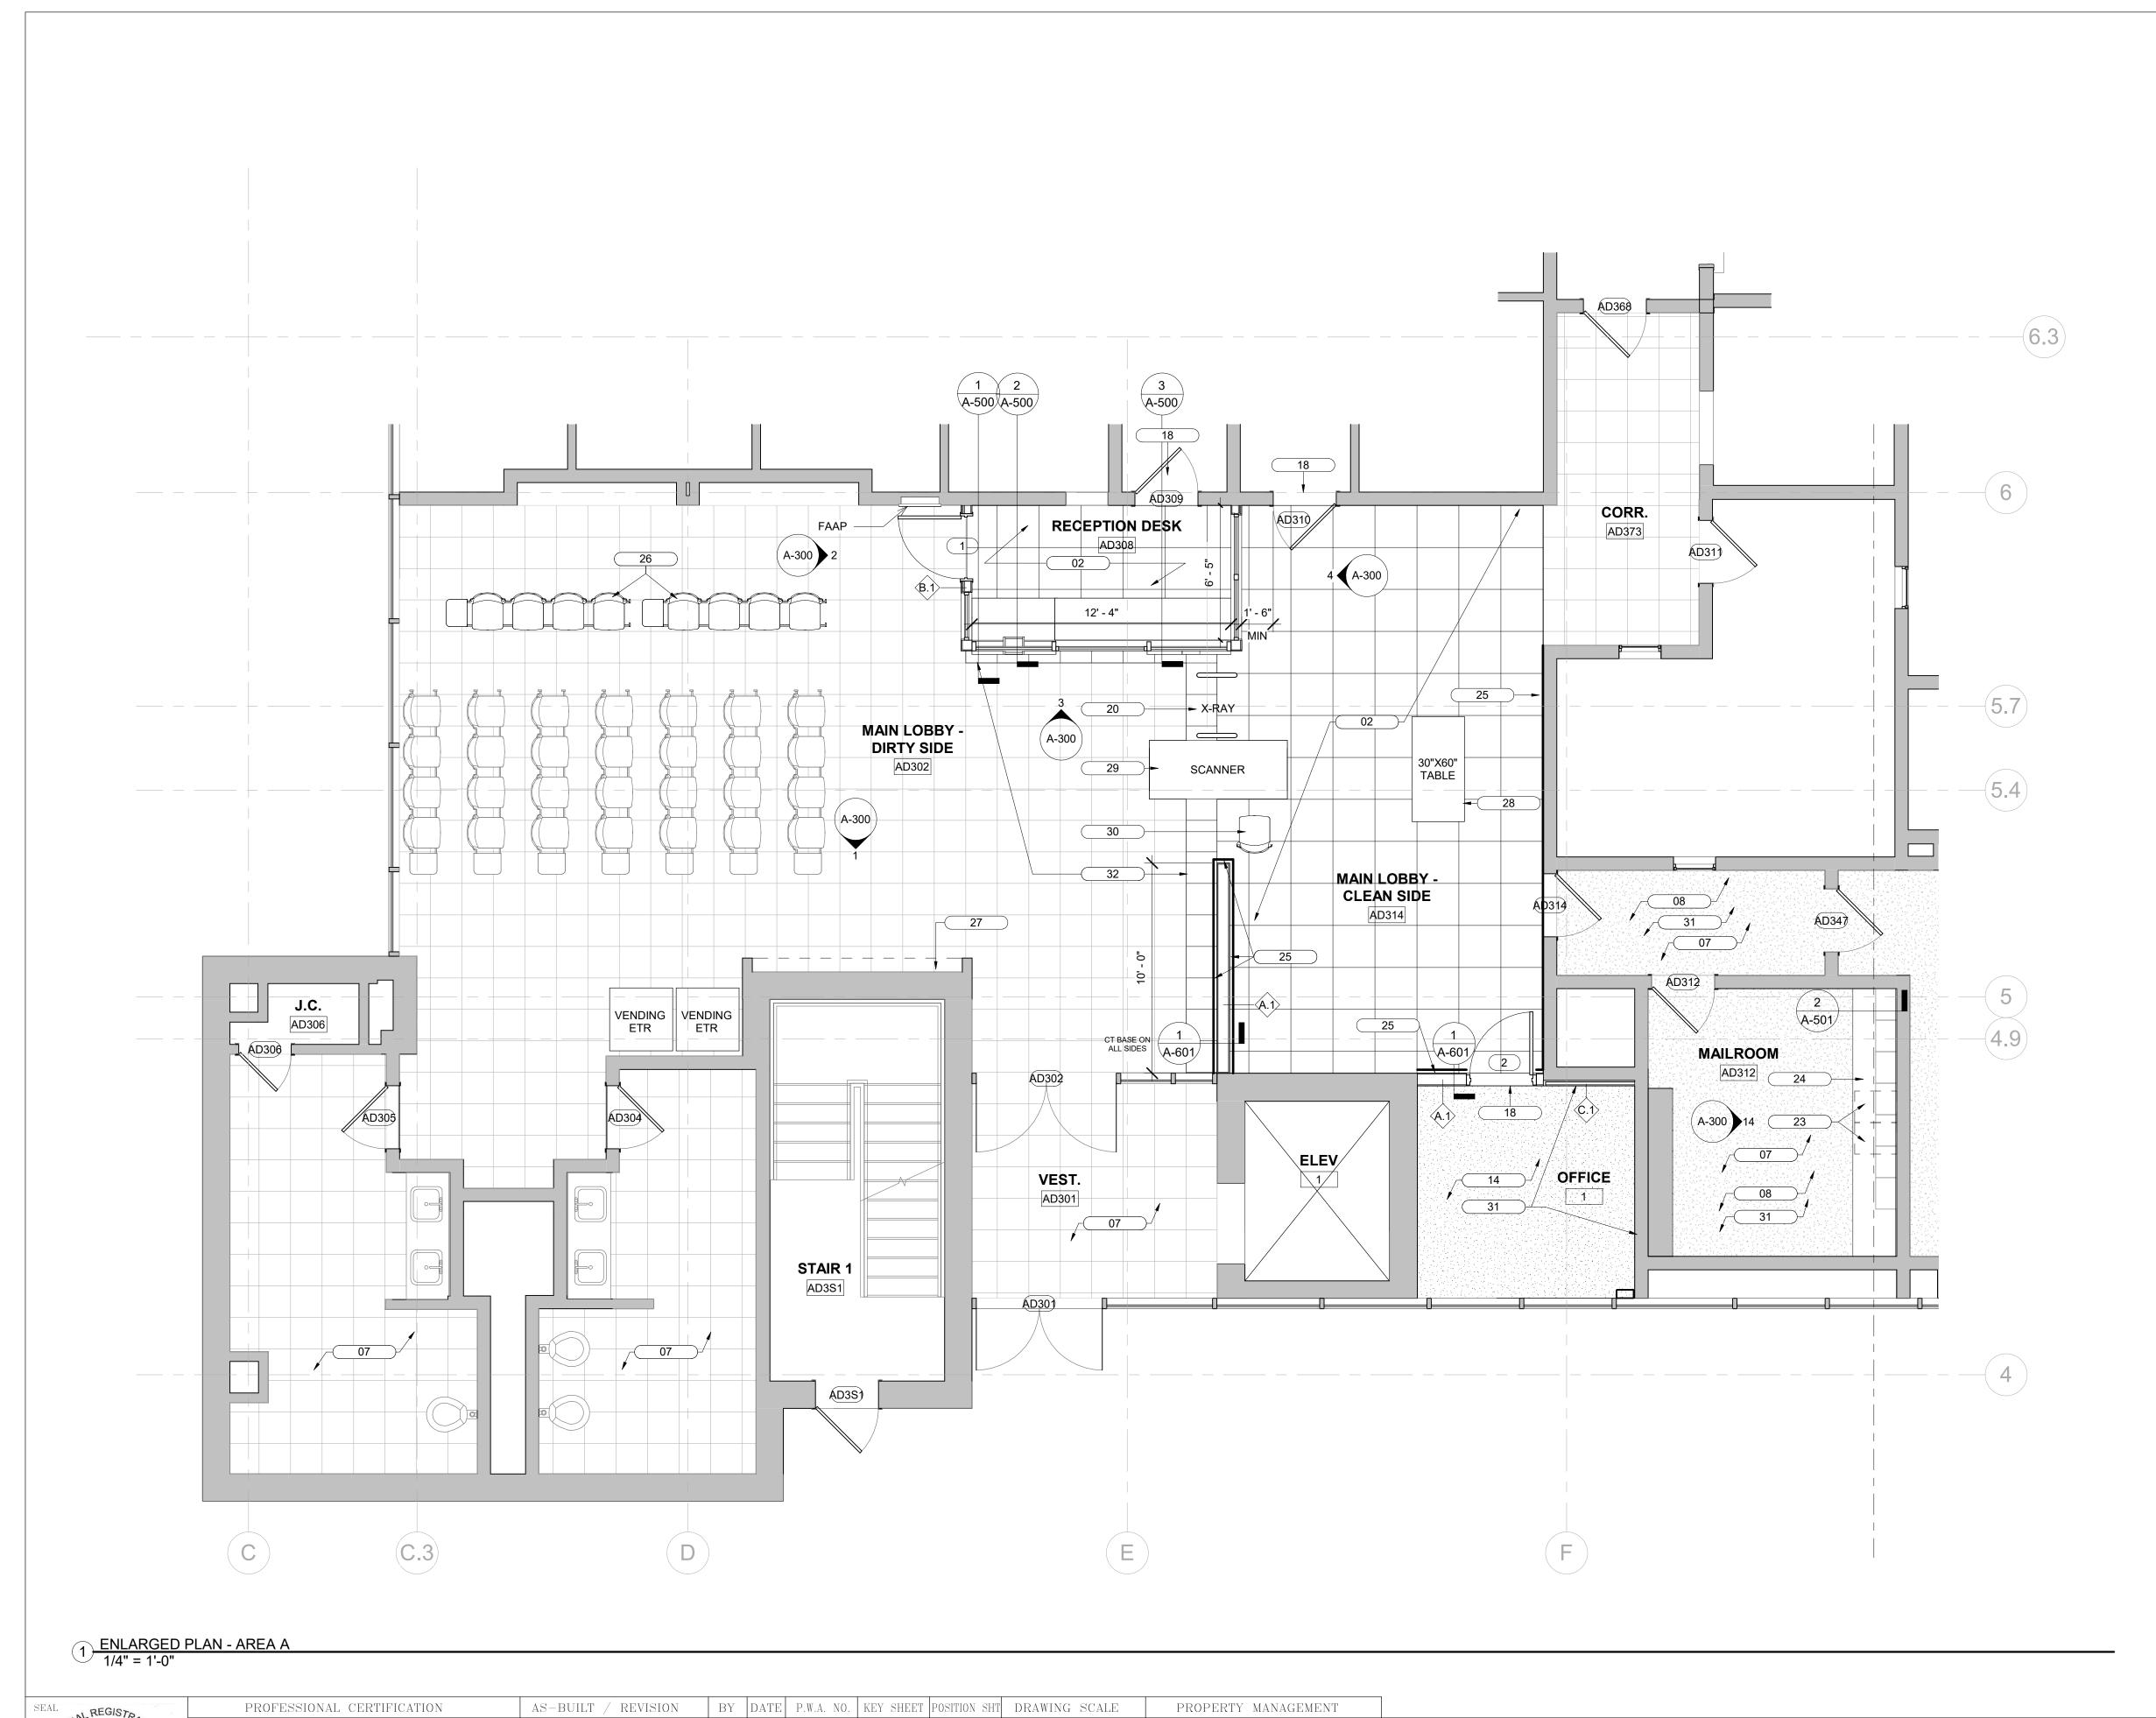

PLAN SCALE: As indicated

PROFILE SCALE:


PROPERTY MANAGER

GENERAL CONSTRUCTION NOTES

- 1. ALL DIMENSIONS ARE FROM FACE OF FINISH TO FACE OF FINISH UNLESS OTHERWISE NOTED.
- 2. ALL WORK SHALL CONFORM TO LOCAL AND STATE CODES. LOCAL AND STATE ARE TO TAKE PRECEDENCE OVER THE DRAWINGS AND SPECIFICATIONS. IF DISCREPANCY IS NOTED, INFORM THE ARCHITECT IMMEDIATELY AND BEFORE PROCEEDING WITH WORK.
- 3. CONTRACTOR SHALL VERIFY ALL EXISTING UTILITY LOCATIONS BEFORE INSTALLATION OF NEW
- 4. CONTRACTOR SHALL COORDINATE AND SCHEDULE HIS WORK WITH BUILDING OCCUPANTS, FOR MINIMAL DISRUPTION, AND ANY REQUIRED UTILITY SHUT-DOWNS.
- 5. RUN ALL NEW UTILITIES CONCEALED WHERE FEASIBLE WITHIN EXISTING CONSTRUCTION. WHERE IT IS NOT FEASIBLE TO RUN CONCEALED, PAINT UTILITIES TO MATCH ADJACENT FINISH.
- 6. PATCH DISTURBED SURFACES BACK TO THEIR EXISTING CONDITION.
- 7. PAINT NEW WALL PARTITIONS TO MATCH EXISTING
- 8. WHERE EXISTING WALLS ARE TO BE PATCHED, MATCH TO EXISTING ADJACENT CONDITIONS, TYP.
- 9. NEW SEALANTS: CAULK ALL INTERSECTIONS OF DISSIMILAR MATERIALS WITH SEALANT (WITH EXCEPTION OF ACT).
- 10. REMOVE CEILING TILES AS REQUIRED FOR ACCESS AND ANY REQUIRED UTILITY WORK. WHERE TILES BECOME DAMAGED; REPLACE ACT INKIND - FURNISHED BY GC - CONTRACTOR SHALL PHOTOGRAPH CEILING AREAS TO BE DISTURBED TO DOCUMENT EXISTING CONDITIONS.

FURNITURE SHOWN FOR REFERENCE AND TO BE OWNER PROVIDED, CONTRACTOR INSTALLED.

TAG	DESCRIPTION									
02	NEW CERAMIC TILE FLOORING AND BASE (WHERE APPLICABLE).									
07	REPAINT PREVIOUSLY PAINTED WALLS, HM DOORS, HM FRAMES.									
08	PROVIDE SEALED CONCRETE FLOORING.									
14	NEW CARPET (BROADLOOM) FLOORING.									
18	PROVIDE NEW THRESHOLD TRANSITION BETWEEN FLOOR FINISHES.									
20	PROVIDE PASSTHROUGH DETECTOR. BASIS OF DESIGN: GARRETT PD 65001 32" ADA OR CEIA USA: HI-PE PLUS									
23	PROVIDE NEW BASE CABINET.									
24	PROVIDE NEW COUNTERTOP.									
25	PROVIDE NEW CERAMIC TILE WALL BASE.									
26	RELOCATED CHAIRS.									
27	PATCH AND PAINT EXISTING HOLES WITHIN CMU WALL.									
28	NEW TABLE IS OWNER PROVIDED, CONTRACTOR-INSTALLED. TABLE TO BE BOLTED TO THE FLOOR, COORDINATE WITH OWNER FOR INSTALLATION LOCATION.									
29	PROVIDE BAGGAGE SCANNER. BASIS OF DESIGN: POINT SECURITY INC HI-SCAN 6040C.									
30	NEW CHAIR IS OWNER PROVIDED.									
31	PROVIDE NEW VINYL WALL BASE.									
32	ATTIC STOCK CERAMIC TILE FLOORING (WHERE APPLICABLE).									

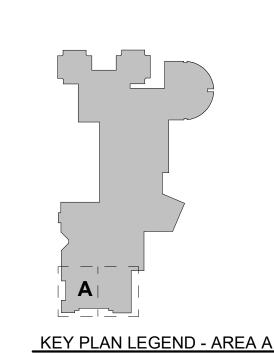



SHEET DESIGNATION A-100

25122 PO0

CONTRACT NUMBER

JOB ORDER NUMBER PROJ-10001187 SHEET 9 OF 60

DRAWING NUMBER 2025-2120

file no.: 8

BALTIMORE COUNTY OFFICE OF BUDGET AND FINANCE - PROPERTY MANAGEMENT BCDC LOBBY RENOVATIONS

ENLARGED PLAN_AREA A

RENOVATION

720 BOSLEY AVENUE, TOWSON, MD 21204

ELECTION DIST. NO.: 9C6

HEREBY CERTIFY THAT THESE DOCUMENTS WERE PREPARED


ROFESSIONAL ARCHITECT UNDER THE LAWS OF THE STATE OF

R APPROVED BY ME, AND THAT I AM A DULY LICENSED

EXPIRATION DATE 06/13/2027 BUREAU OF ENGINEERING AND CONSTRUCTION TRAFFIC HIGHWAYS STRUCTURES STORM DRAINS SEWER WATER Frank Elwood Dittenhafer, II REVIEWED BY: AS-BUILT PER RECORD PRINT SUBDIVISION: TOWSON CHKD BY: RDT DATE REVIEWED:

CONTRACT COMPLETION BOX

R.O.W NO.

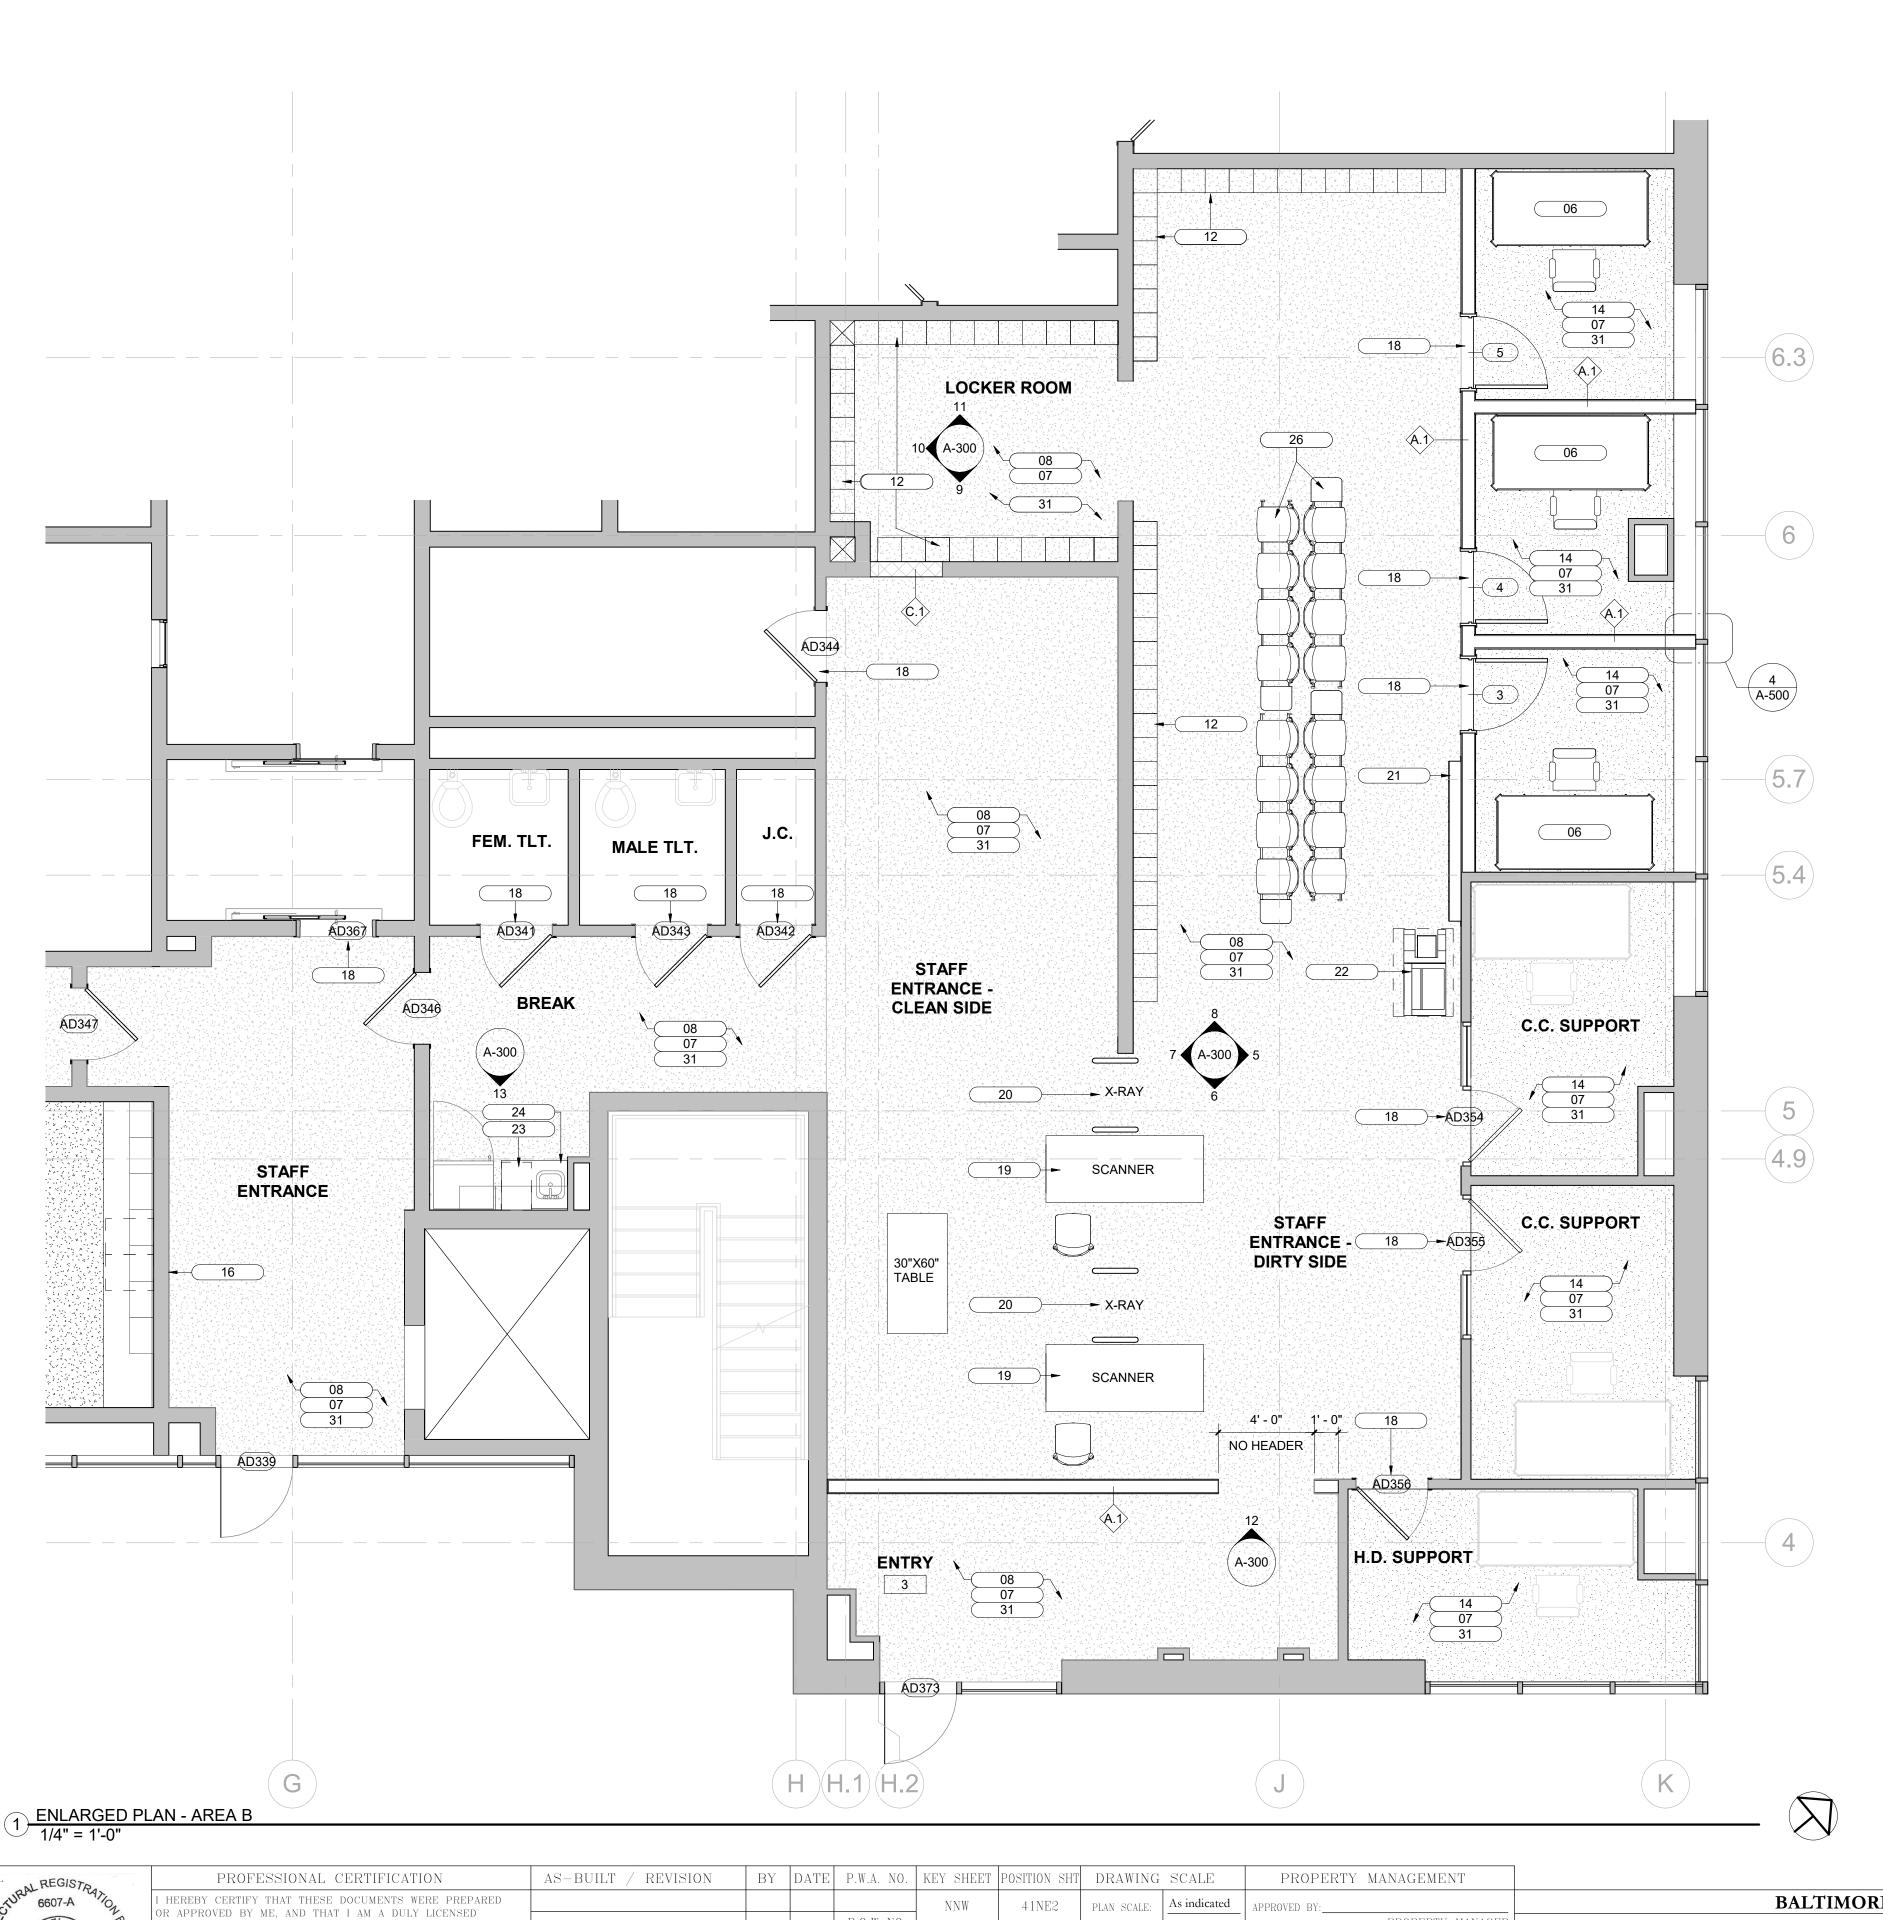

R.O.W NO.

TRAFFIC HIGHWAYS STRUCTURES STORM DRAINS

E 06/13/2027

CHKD BY: RDT

Frank Elwood Dittenhafer, II

AS-BUILT PER RECORD PRINT

CONTRACT COMPLETION BOX

BUREAU OF ENGINEERING AND CONSTRUCTION

REVIEWED BY:

DATE REVIEWED:

PROFILE SCALE:

WATER

SEWER

PROPERTY MANAGER


SUBDIVISION: TOWSON

GENERAL CONSTRUCTION NOTES

- 1. ALL DIMENSIONS ARE FROM FACE OF FINISH TO FACE OF FINISH UNLESS OTHERWISE NOTED.
- 2. ALL WORK SHALL CONFORM TO LOCAL AND STATE CODES. LOCAL AND STATE ARE TO TAKE PRECEDENCE OVER THE DRAWINGS AND SPECIFICATIONS. IF DISCREPANCY IS NOTED, INFORM THE ARCHITECT IMMEDIATELY AND BEFORE PROCEEDING WITH WORK.
- 3. CONTRACTOR SHALL VERIFY ALL EXISTING UTILITY LOCATIONS BEFORE INSTALLATION OF NEW PARTITIONS.
- 4. CONTRACTOR SHALL COORDINATE AND SCHEDULE HIS WORK WITH BUILDING OCCUPANTS, FOR MINIMAL DISRUPTION, AND ANY REQUIRED UTILITY SHUT-DOWNS.
- 5. RUN ALL NEW UTILITIES CONCEALED WHERE FEASIBLE WITHIN EXISTING CONSTRUCTION. WHERE IT IS NOT FEASIBLE TO RUN CONCEALED, PAINT UTILITIES TO MATCH ADJACENT FINISH.
- 6. PATCH DISTURBED SURFACES BACK TO THEIR EXISTING CONDITION.
- 7. PAINT NEW WALL PARTITIONS TO MATCH EXISTING.
- 8. WHERE EXISTING WALLS ARE TO BE PATCHED, MATCH TO EXISTING ADJACENT CONDITIONS, TYP.
- 9. NEW SEALANTS: CAULK ALL INTERSECTIONS OF DISSIMILAR MATERIALS WITH SEALANT (WITH EXCEPTION OF ACT).
- 10. REMOVE CEILING TILES AS REQUIRED FOR ACCESS AND ANY REQUIRED UTILITY WORK. WHERE TILES BECOME DAMAGED; REPLACE ACT INKIND - FURNISHED BY GC - CONTRACTOR SHALL PHOTOGRAPH CEILING AREAS TO BE DISTURBED TO DOCUMENT EXISTING CONDITIONS.

FURNITURE SHOWN FOR REFERENCE AND TO BE OWNER PROVIDED, CONTRACTOR INSTALLED.

	KEYNOTE LEGEND									
TAG	DESCRIPTION									
06	NEW OFFICE FOR (1) WORKSTATION WITH POWER AND DATA.									
07	REPAINT PREVIOUSLY PAINTED WALLS, HM DOORS, HM FRAMES.									
80	PROVIDE SEALED CONCRETE FLOORING.									
12	PROVIDE 12"X12"X12" METAL LOCKERS STACKED 6 HIGH ON METAL LEGS. LOCKERS TO HAVE KEYS FOR TEMPORARY USEAGE.									
14	NEW CARPET (BROADLOOM) FLOORING.									
16	PATCH AND PAINT WALL AFTER GUN LOCKER RELOCATION.									
18	PROVIDE NEW THRESHOLD TRANSITION BETWEEN FLOOR FINISHES.									
19	PROVIDE BAGGAGE SCANNER. BASIS OF DESIGN: POINT SECURITY INC. HI-SCAN 6040C.									
20	PROVIDE PASSTHROUGH DETECTOR. BASIS OF DESIGN: GARRETT PD 65001 32" ADA OR CEIA USA: HI-PE PLUS									
21	RELOCATED GUN LOCKERS. PROVIDE BLOCKING WITHIN WALL. AT EXISTING WALL, REMOVE GWB AND INSTALL BLOCKING. REINSTALL GWB, FINISH AND PAINT PRIOR TO INSTALLING GUN LOCKER.									
22	RELOCATED EXISTING OFFICE PRINTER.									
23	PROVIDE NEW BASE CABINET.									
24	PROVIDE NEW COUNTERTOP.									
26	RELOCATED CHAIRS.									
31	PROVIDE NEW VINYL WALL BASE.									

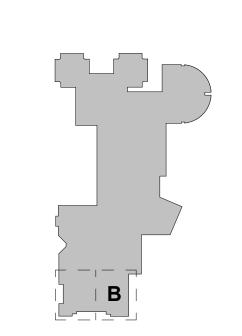

KEY PLAN LEGEND - AREA B



SHEET DESIGNATION A-101

CONTRACT NUMBER 25122 PO0

file no.: 8

JOB ORDER NUMBER PROJ-10001187


SHEET **10** OF 60 DRAWING NUMBER 2025-2121

BALTIMORE COUNTY OFFICE OF BUDGET AND FINANCE - PROPERTY MANAGEMENT BCDC LOBBY RENOVATIONS

ENLARGED PLAN_AREA B

RENOVATION

720 BOSLEY AVENUE, TOWSON, MD 21204

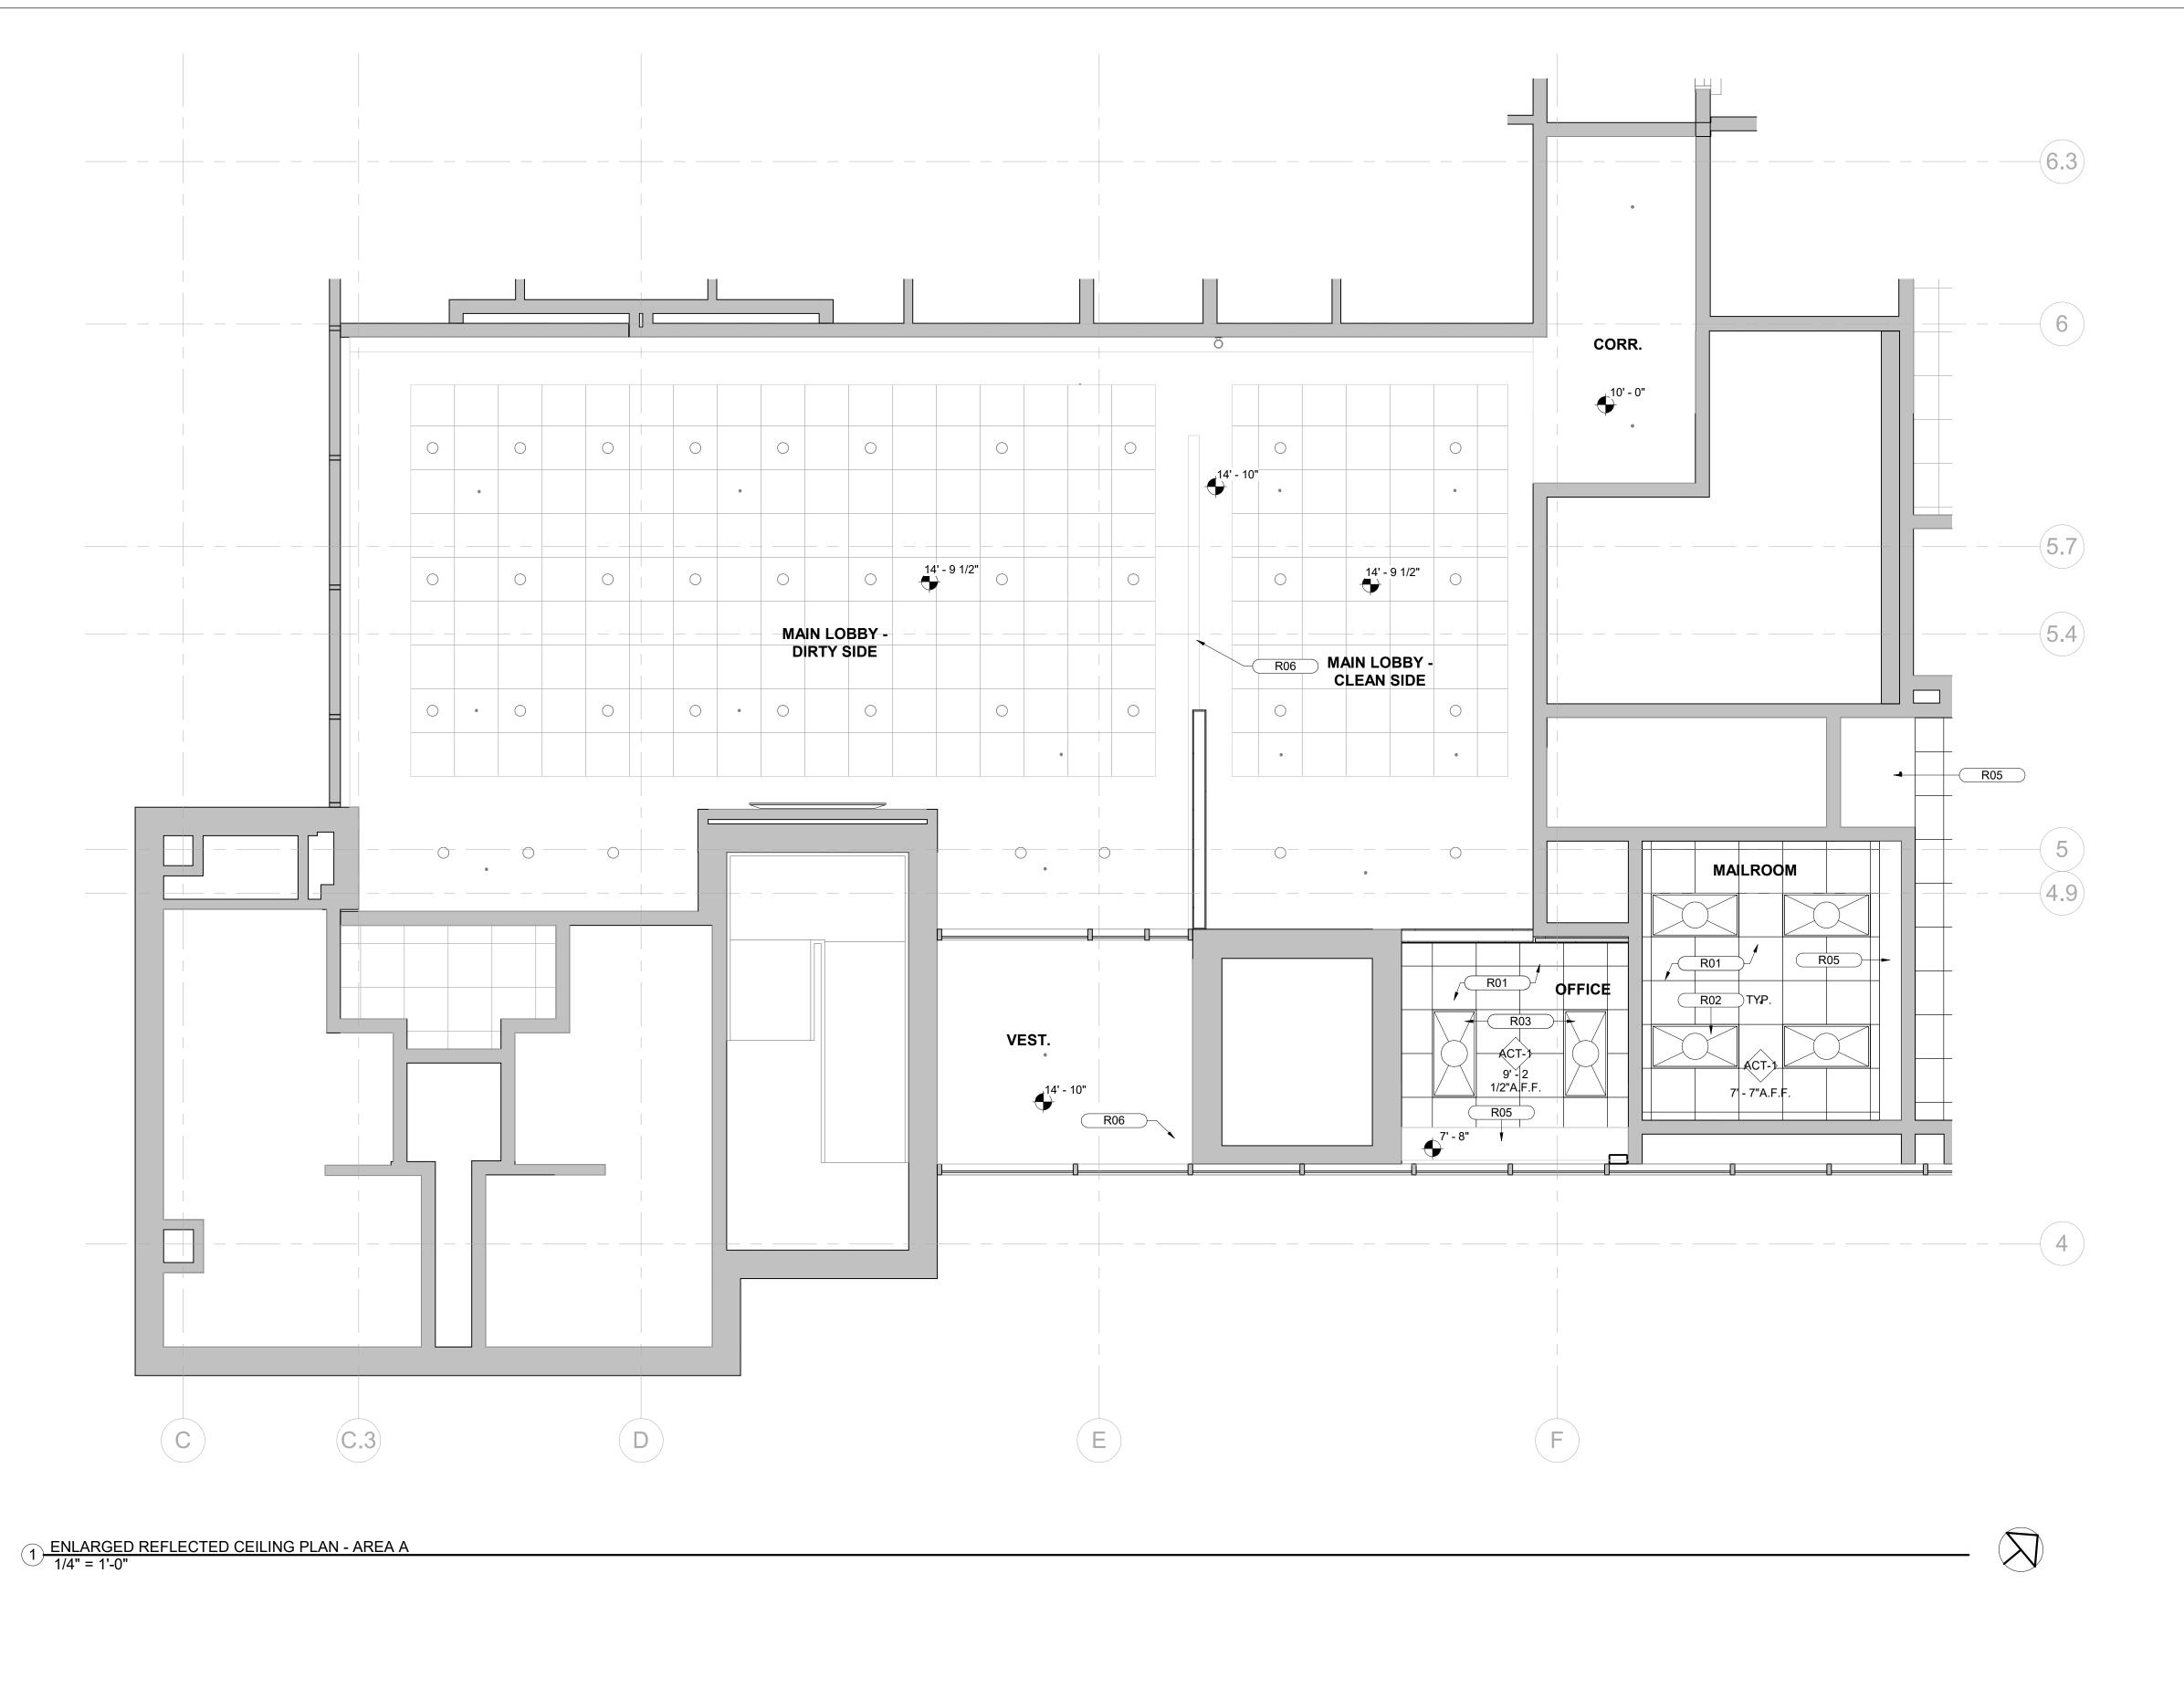


GENERAL RCP DEMO NOTES

- 1. ALL DEMOLITION WORK SHALL BE PERFORMED FOLLOWING THE STRICTEST SAFETY STANDARDS TO PROTECT OCCUPANTS AND WORKERS. STRICTLY FOLLOWING OSHA, AND COUNTY SAFETY REGULATIONS. ALL DEMOLITION WORK SHALL BE PERFORMED SO AS NOT TO DAMAGE UNAFFECTED AREAS INDICATED BY THE DEMOLITION DRAWINGS. THE CONTRACTOR SHALL PROTECT THE EXISTING BUILDING AND ITS CONTENTS AGAINST DAMAGE FROM ANY SOURCE RELATED TO THEIR WORK. ANY DAMAGE TO THE EXISTING CONSTRUCTION TO REMAIN SHALL BE REPAIRED TO MATCH EXISTING CONDITIONS AT NO ADDITIONAL COST TO THE OWNER BY THE CONTRACTOR RESPONSIBLE FOR THE DAMAGE.
- 2. THE CONTRACTOR SHALL REMOVE FROM THE PREMISES ALL ACCUMULATED CONSTRUCTION DEBRIS AND RUBBISH AS CONSEQUENTIAL OF THEIR WORK ON A DAILY BASIS. THE CONTRACTOR SHALL PAY FOR THEIR REQUIRED REMOVAL AND DISPOSAL FEES.
- 3. THE CONTRACTOR SHALL COORDINATE WITH THE OWNER FOR ESTABLISHING AND MAINTAINING ON-SITE STORAGE. SECURITY FOR ALL EQUIPMENT AND MATERIALS IS THE RESPONSIBILITY OF THE CONTRACTOR.
- 4. THE CONTRACTOR SHALL USE ALL PHYSICAL MEANS TO RESTRICT ACCESS TO PROTECT FULLY ALL PERSONS AROUND WORK AREAS, SAFETY AND DEVICES SHALL BE USED IN ACCORDANCE WITH ALL PERTIENT FEDERAL, STATE AND LOCAL SAFETY PRACTICES, STANDARD CODES AND ORDINANCES.
- 5. VERIFY ALL EXISTING CONDITIONS PRIOR TO SELECTIVE DEMOLITION. NOTIFY OWNER/ARCHITECT IMMEDIATELY IN THE EVENT OF ANY AMBIGUITY OR INCONSISTENCIES.
- 6. ALL DIMENSIONS ARE SHOWN FROM FACE OF FINISH TO FACE OF FINISH, UNLESS OTHERWISE NOTED.
- 7. COORDINATE ARCHITECTURAL DEMOLITION WORK WITH THAT OF THE MECHANICAL, ELECTRICAL, IT & FIRE ALARM TRADES AND DRAWINGS, VERIFY ALL EXISTING CONDITIONS IN THE FIELD AND NOTIFY ARCHITECT OF ANY
- DISCREPANCY PRIOR TO COMMENCING WORK. 8. DEMOLITION CONTRACTOR SHALL NOT USE ANY CONSTRUCTION METHODS THAT WILL CAUSE DAMAGE TO WORK

TO BE LEFT IN PLACE. REPAIR DAMAGE TO THE EXISTING CONSTRUCTION CAUSED BY WORK UNDER THIS CONTRACT.

- 9. OWNER HAS FIRST RIGHT OF REFUSAL OF ALL SALVAGEABLE ITEMS. CONTRACTOR SHALL COORDINATE WITH THE OWNER OR THEIR AUTHORIZED REPRESENTATIVE, TO DETERMINE ALL EXISTING EQUIPMENT AND DEVICES TO BE RETAINED, PRESERVE AND STORE THE EQUIPMENT IN A LOCATION DESIGNATED BY THE OWNER. ALL OTHER DEVICES, EQUIPMENT, AND DEBRIS SHALL BE DISPOSED OF BY THE CONTRACTOR AT AN APPROPRIATE OFFSITE
- 10. COORDINATE ALL CEILING MOUNTED EQUIPMENTWITH MEP DRAWINGS AND FIRE PROTECTION & FIRE ALARM
- 11. ALL CEILING MOUNTED EQUIPMENT IS ON MEP DRAWINGS AND FIRE PROTECTION & FIRE ALARM DRAWINGS.
- 12. REMOVE WALLS INDICATED TO BE DEMOLISHED FROM FLOOR TO STRUCTURE ABOVE AND INCLUDE ALL MECHANICAL, ELECTRICAL, EQUIPMENT, ETC. PREPARE ALL DISTURBED AREAS FOR NEW CONSTRUCTION.
- 13. WHERE PARTIAL DEMOLITION OF A WALL IS REQUIRED, COORDINATE EXTENT AND LOCATION OR REMOVED PORTION WITH NEW CONSTRUCTION PLAN AND FIELD CONDITIONS.
- 14. CLOSE OFF AND PATCH OPENINGS AND VOIDS LEFT BY THE REMOVAL OF EXISTING CONSTRUCTION, EQUIPMENT, PIPING, DUCTS, ELECTRICAL DEVICES, ETC. TO MAINTAIN PROPER FIRE RATING IN A RATED ASSEMBLY. IN NON-FIRE-RATED AND SMOKE PARTITIONS, SEAL PENETRATIONS WITH ACOUSTICAL SEALANT AND FILL WITH SOUND ATTENUATION BLANKETS. PREPARE PATCHES TO RECEIVE NEW FINISHES AS REQUIRED TO MATCH EXISTING ADJACENT FINISHES.

	KEYNOTE LEGEND							
TAG DESCRIPTION								
R01	NEW ACT-1 CEILING AND CEILING GRID TO EXTENTS SHOWN, REFER TO SPECIFICATIONS.							
R02	RE-INSTALL EXISTING LIGHT FIXTURES IN ORIGINAL LOCATIONS AS EXISTING U.N.O., SEE MEP DRAWINGS.							
R03	INSTALL NEW LED RECESSED 2X4 LIGHT FIXTURE.							
R05	EXISTING GWB BULKHEAD TO REMAIN.							
R06	PATCH AND REPAIR EXISTING GWB CEILING. PAINT TO MATCH EXISTING.							

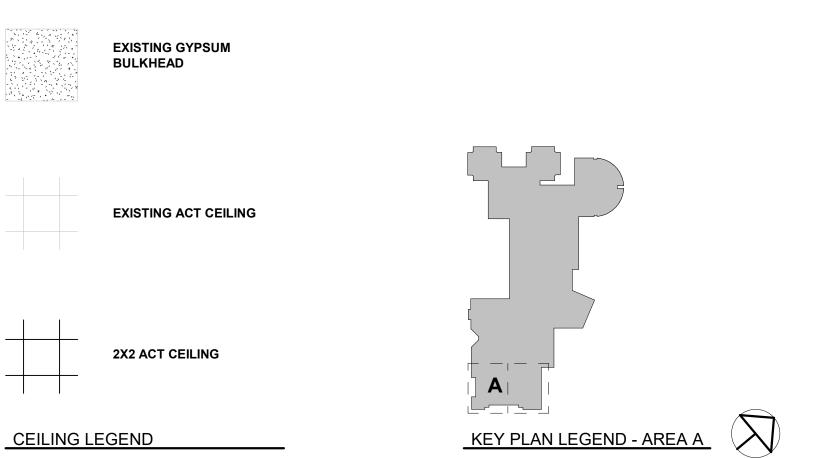

SEAL	NL REGISTA	PROFESSIONAL CERTIFICATION	AS-BUILT / REV	ISION	BY	DATE P.W.A. NO.	KEY SHEET	POSITION SHT	DRAWING	SCALE	PROPERTY MANAGEMEN'
.ch	000111	I HEREBY CERTIFY THAT THESE DOCUMENTS WERE PREPARED OR APPROVED BY ME, AND THAT I AM A DULY LICENSED					NNW	41NE2	PLAN SCALE:	As indicated	APPROVED BY:
17		PROFESSIONAL ARCHITECT UNDER THE LAWS OF THE STATE OF				R.O.W NO.					PROPERTY M
RCA		MARYLAND. LICENSE NO. 6607, EXPIRATION DATE 06/13/2027	CONTRACT COMPLETION	N BOX					PROFILE SCALE:		DATE:
A A	N. A.	ARCHITECT: DGN BY: RDT	BUREAU OF ENGINEERING AND CONSTRUCTION	TRAFFIC	HIGH	HWAYS STRUCTURES	STORM DRAINS	SEWER	WATER	FIELD ENGINEER	
(es)	WOOD DITTE NO	Frank Elwood Dittenhafer, II	DEVIEWED BV.								

BALTIMORE COUNTY OFFICE OF BUDGET AND FINANCE - PROPERTY MANAGEMENT

BCDC LOBBY RENOVATIONS


SUBDIVISION: TOWSON

ENLARGED REFLECTED CEILING PLAN - AREA A

RENOVATION

720 BOSLEY AVENUE, TOWSON, MD 21204

ELECTION DIST. NO.: 9C6

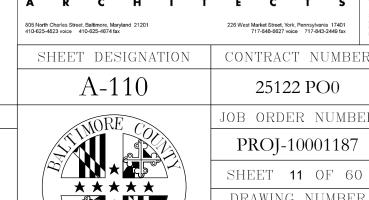

JOB ORDER NUMBER PROJ-10001187 SHEET 11 OF 60 DRAWING NUMBER 2025-2122

file no.: 8



BUREAU OF ENGINEERING AND CONSTRUCTION

REVIEWED BY:

DATE REVIEWED:

CHKD BY: RDT

Frank Elwood Dittenhafer, II

AS-BUILT PER RECORD PRINT

TRAFFIC HIGHWAYS STRUCTURES STORM DRAINS

SEWER

WATER


FIELD ENGINE


SUBDIVISION: TOWSON


GENERAL RCP DEMO NOTES

- 1. ALL DEMOLITION WORK SHALL BE PERFORMED FOLLOWING THE STRICTEST SAFETY STANDARDS TO PROTECT OCCUPANTS AND WORKERS. STRICTLY FOLLOWING OSHA, AND COUNTY SAFETY REGULATIONS. ALL DEMOLITION WORK SHALL BE PERFORMED SO AS NOT TO DAMAGE UNAFFECTED AREAS INDICATED BY THE DEMOLITION DRAWINGS. THE CONTRACTOR SHALL PROTECT THE EXISTING BUILDING AND ITS CONTENTS AGAINST DAMAGE FROM ANY SOURCE RELATED TO THEIR WORK. ANY DAMAGE TO THE EXISTING CONSTRUCTION TO REMAIN SHALL BE REPAIRED TO MATCH EXISTING CONDITIONS AT NO ADDITIONAL COST TO THE OWNER BY THE CONTRACTOR RESPONSIBLE FOR THE DAMAGE.
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KEYNOTE LEGEND								
TAG	DESCRIPTION							
R01	NEW ACT-1 CEILING AND CEILING GRID TO EXTENTS SHOWN, REFER TO SPECIFICATIONS.							
R02	RE-INSTALL EXISTING LIGHT FIXTURES IN ORIGINAL LOCATIONS AS EXISTING U.N.O., SEE MEP DRAWINGS.							
R04	INSTALL EXISTING LIGHT FIXTURE AT NEW LOCATION. SEE MEP DRAWINGS.							
R05	EXISTING GWB BULKHEAD TO REMAIN.							



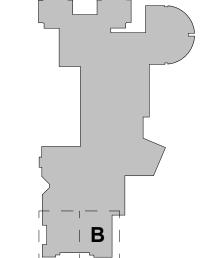

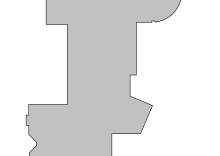

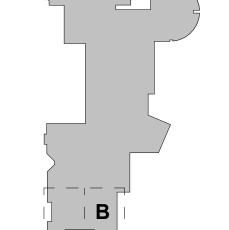KEY PLAN LEGEND - AREA B



SHEET DESIGNATION CONTRACT NUMBER A-111

25122 PO0 JOB ORDER NUMBER

2025-2123

file no.: 8

PROJ-10001187 SHEET **12** OF 60 DRAWING NUMBER

BALTIMORE COUNTY OFFICE OF BUDGET AND FINANCE - PROPERTY MANAGEMENT

ENLARGED REFLECTED CEILING PLAN - AREA B

EXISTING GYPSUM


EXISTING ACT CEILING


2X2 ACT CEILING


BULKHEAD

RENOVATION

720 BOSLEY AVENUE, TOWSON, MD 21204

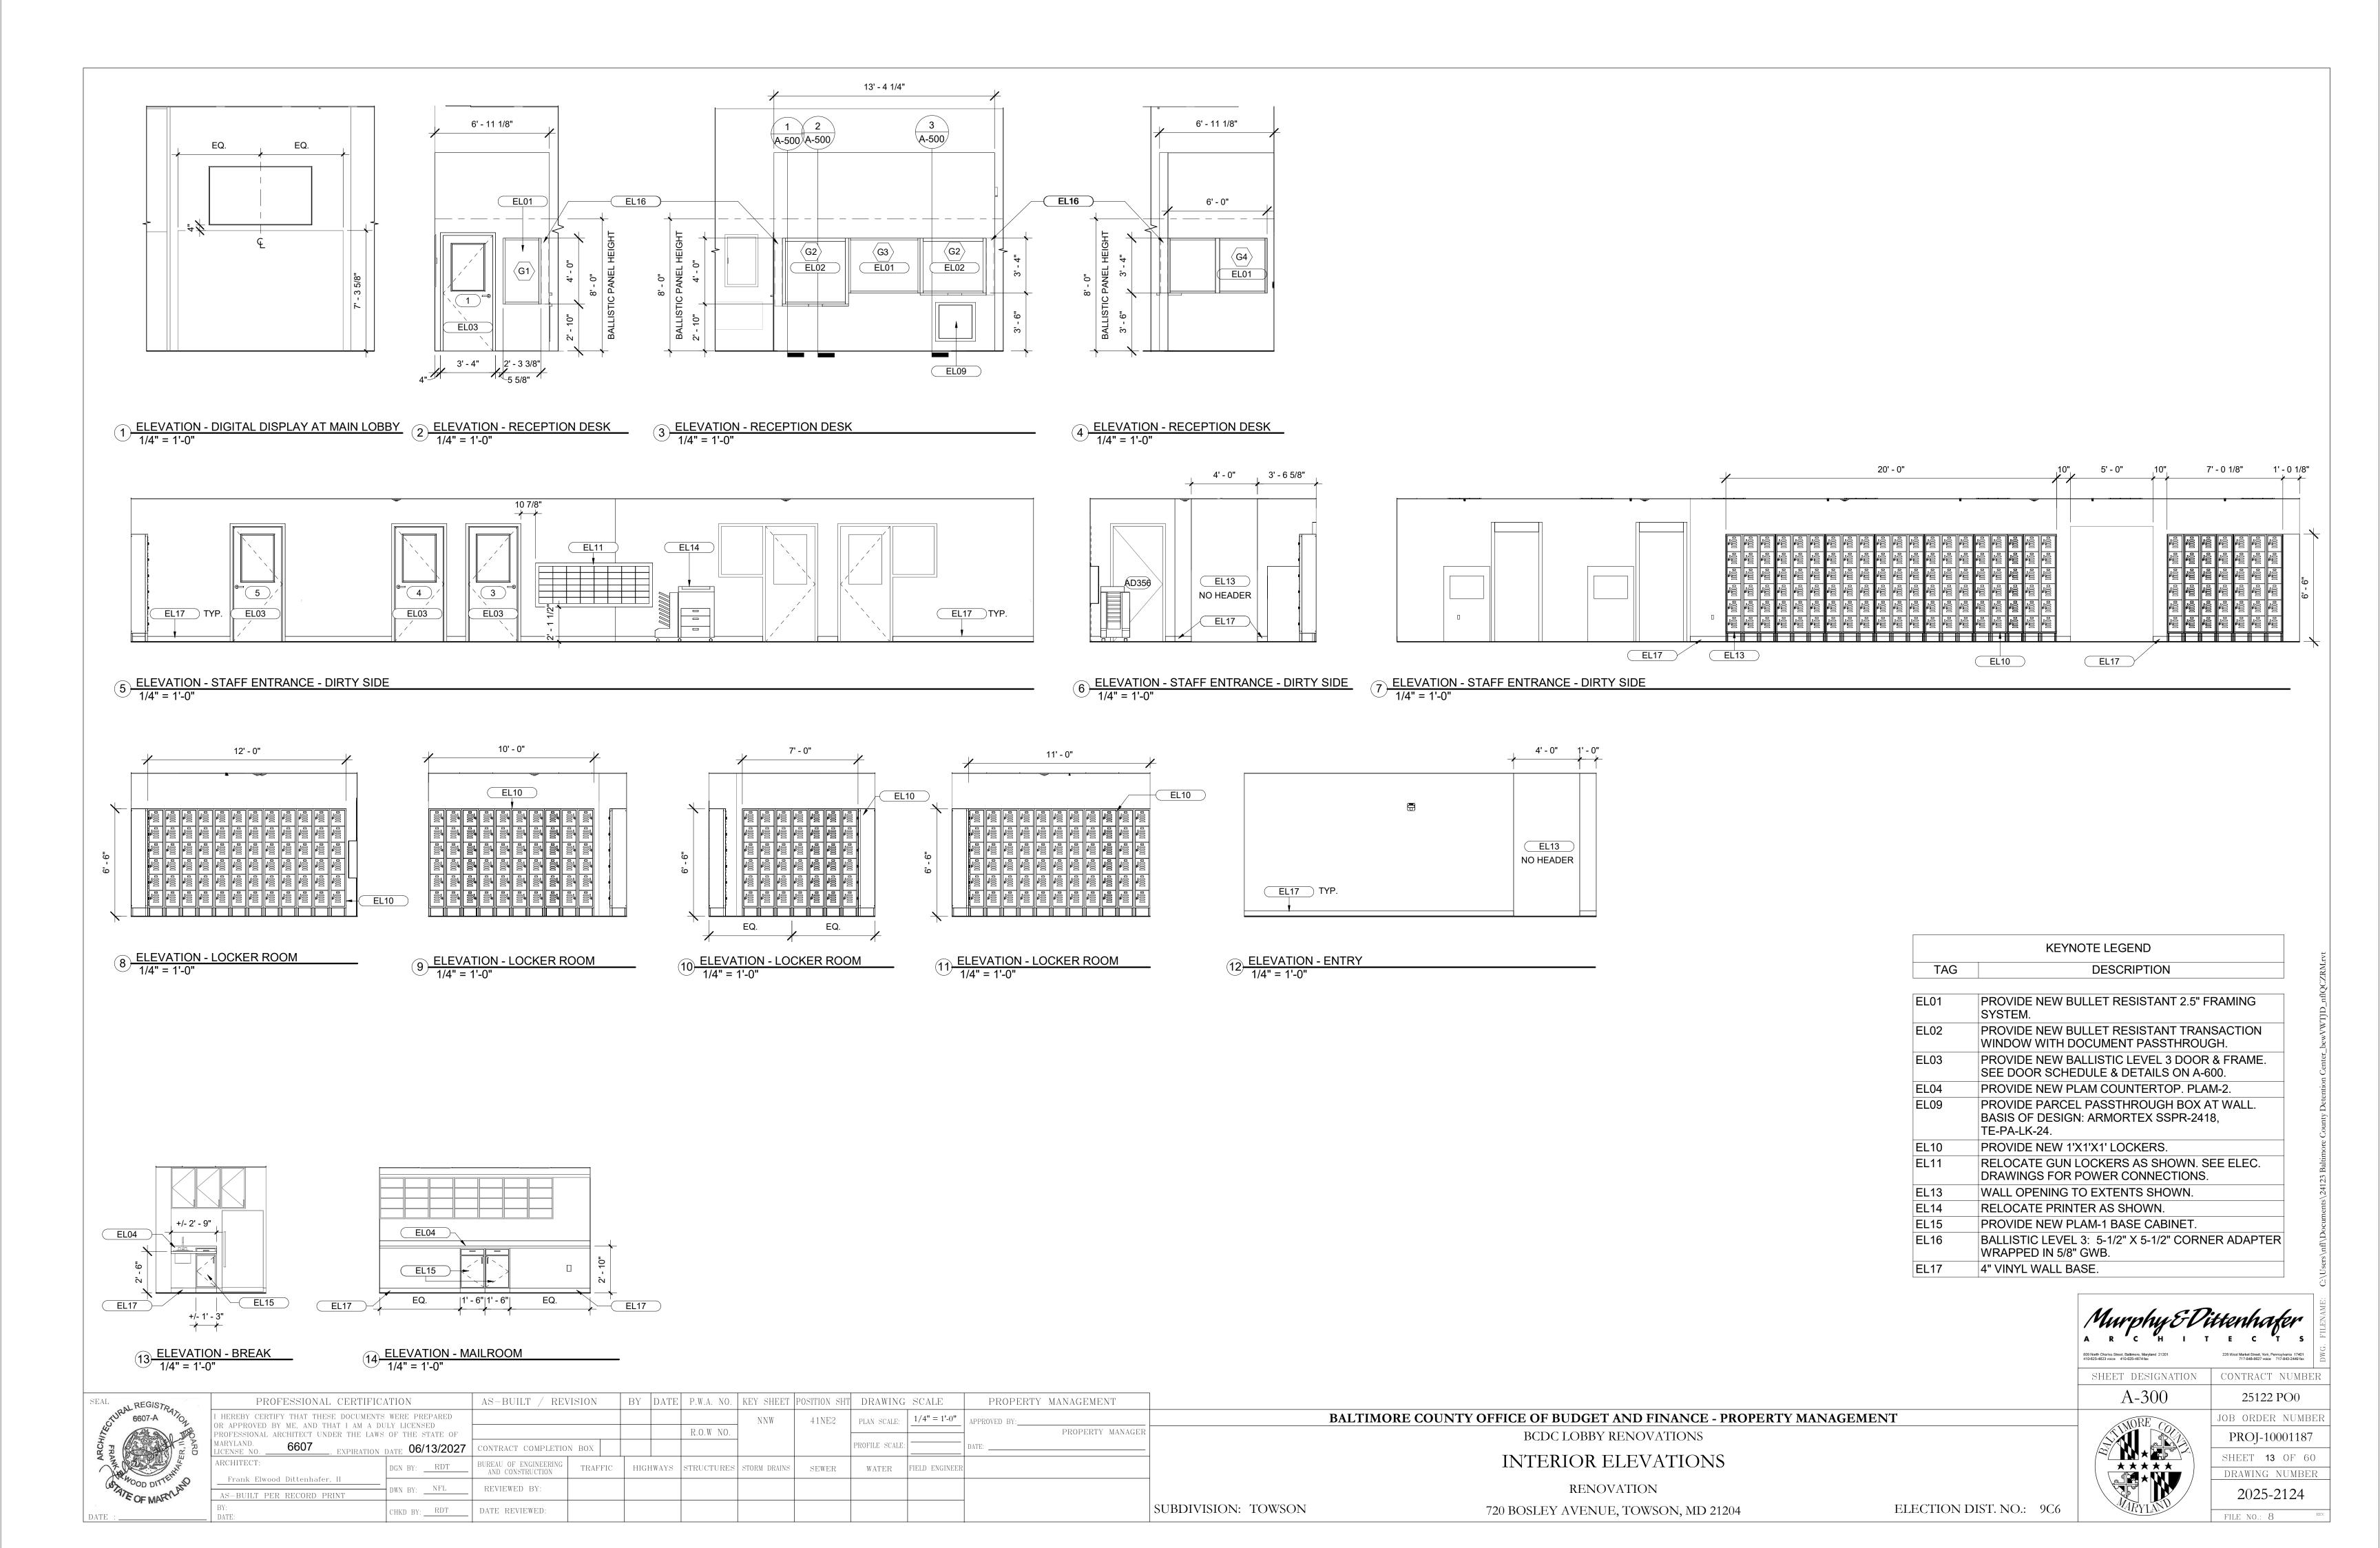

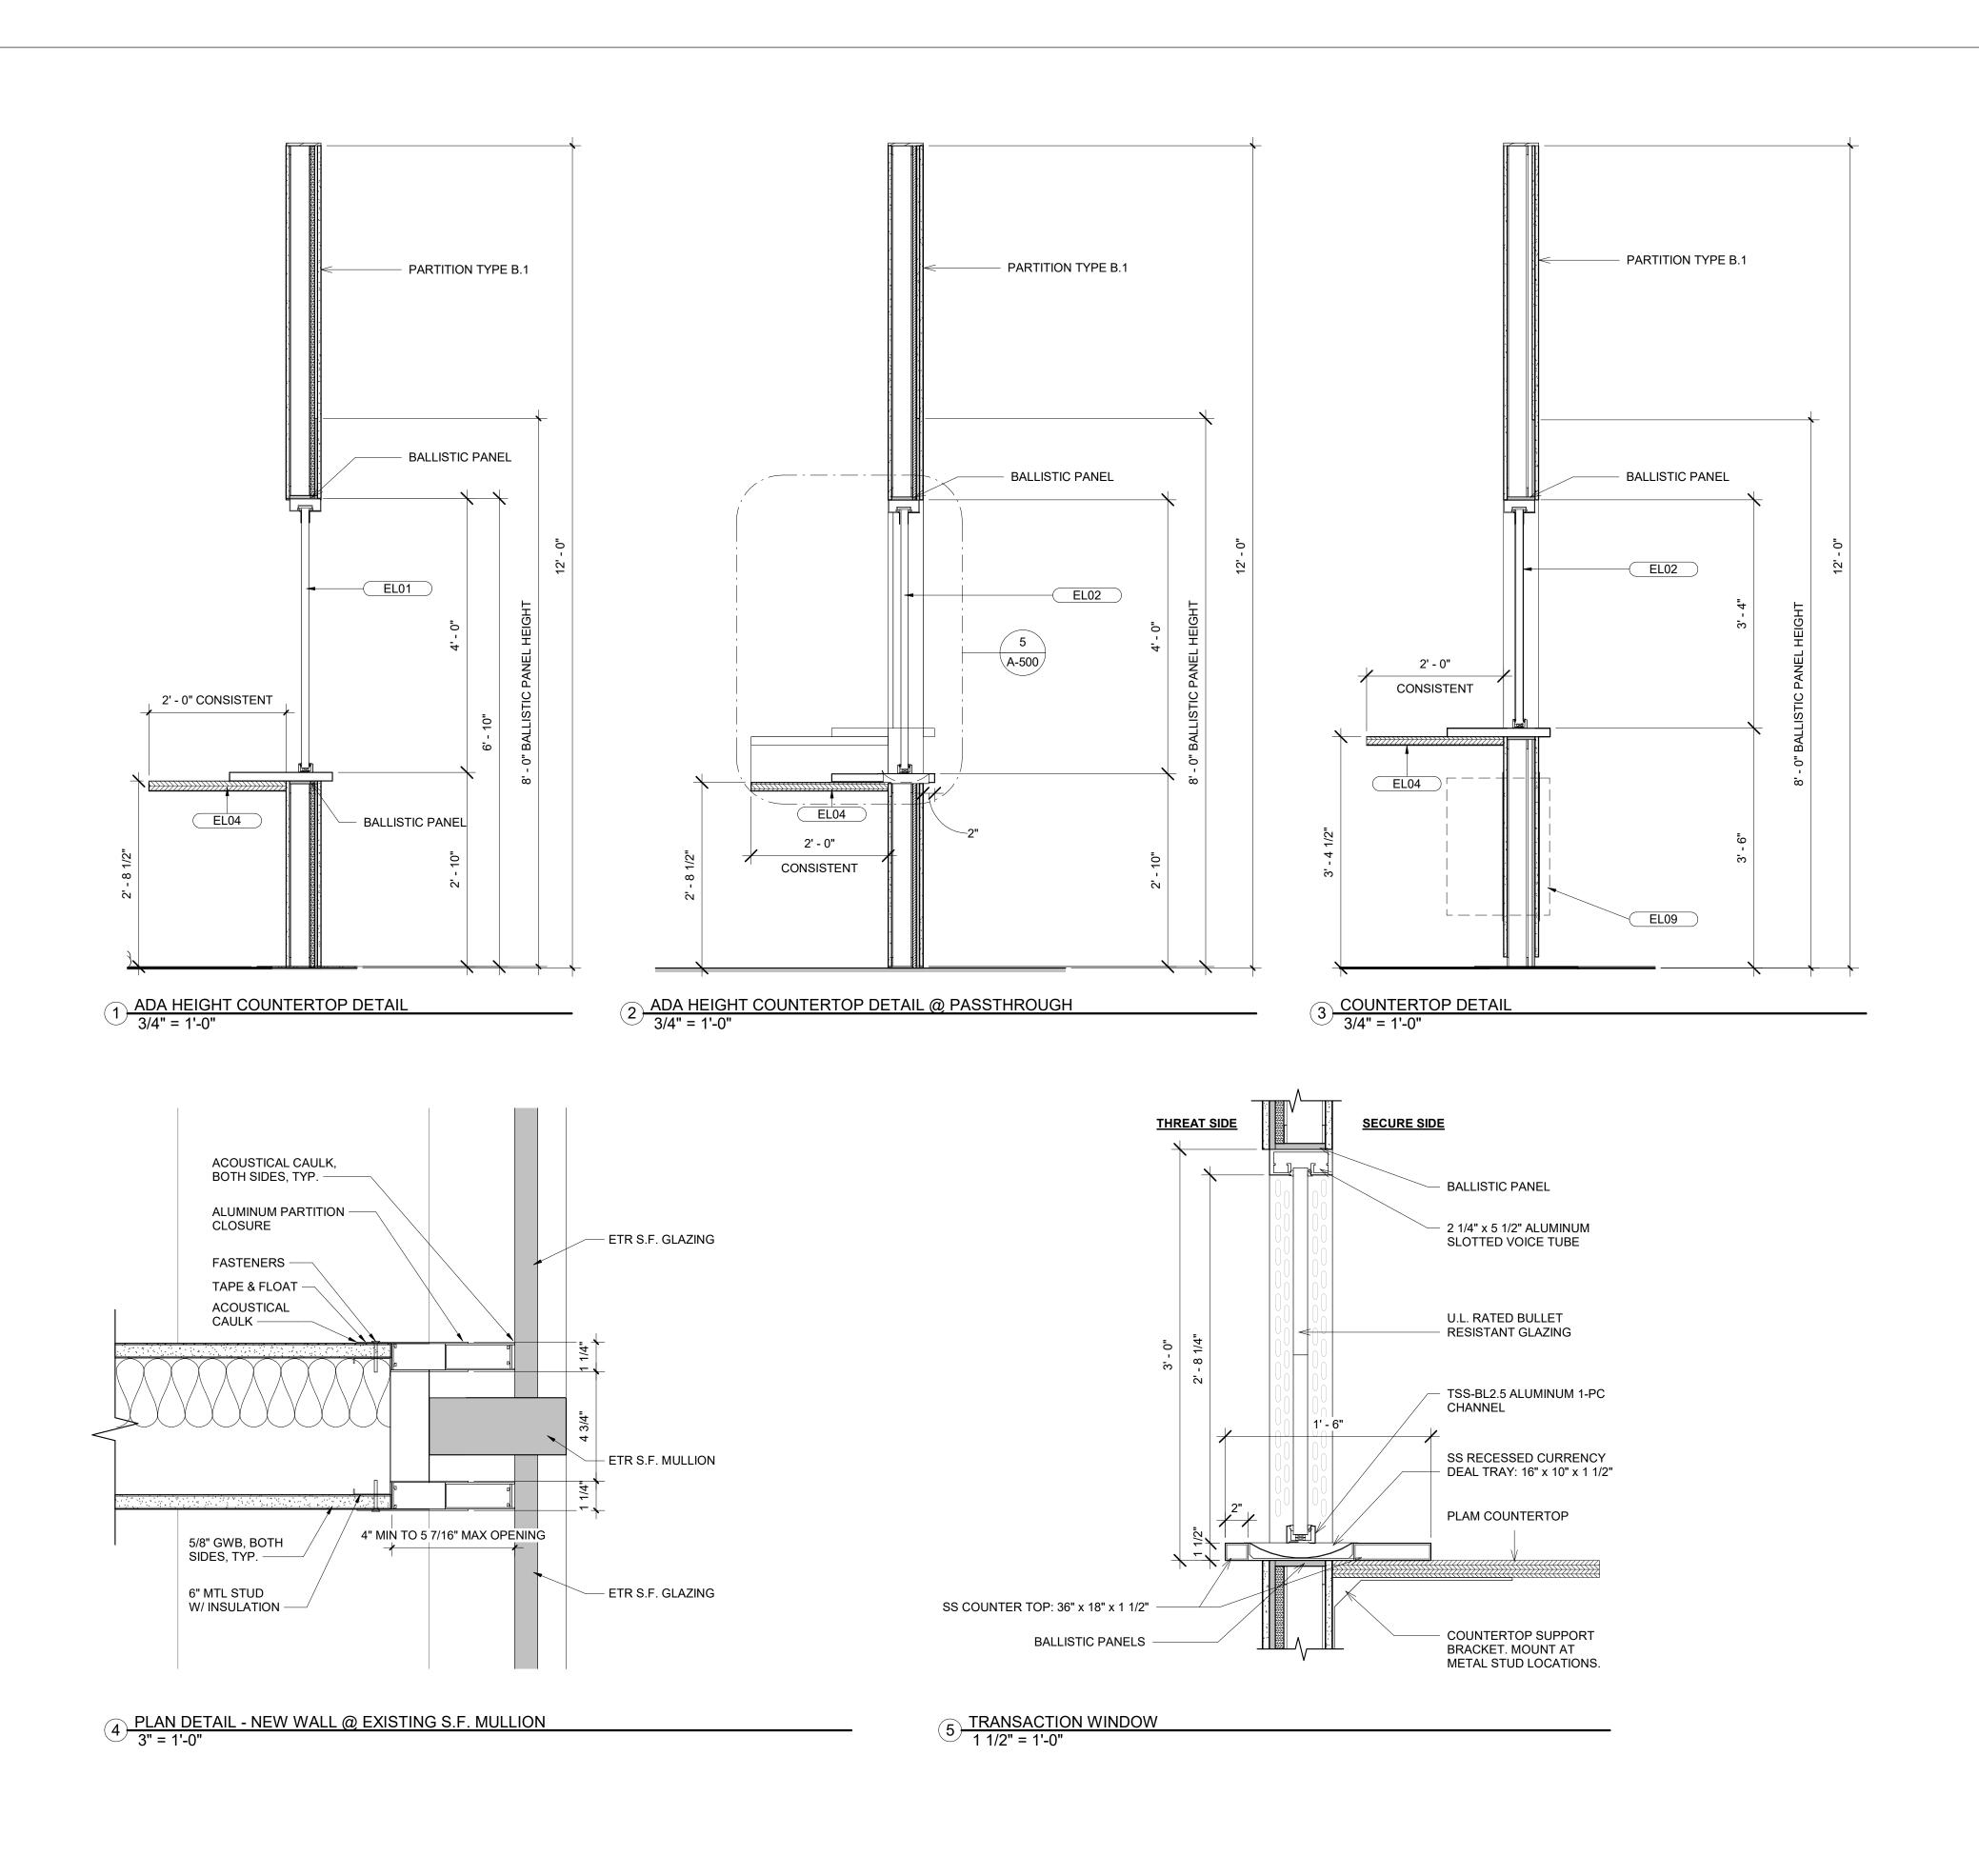

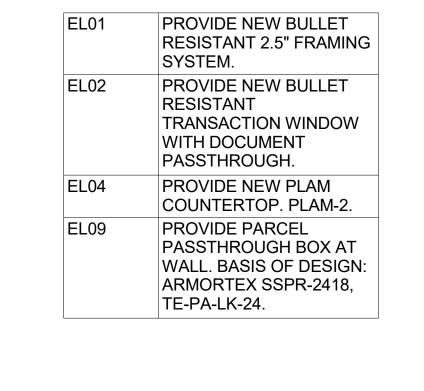

KEYNOTE LEGEND

DESCRIPTION

226 West Market Street, York, Pennsylvania 17401 717-848-8627 voice 717-843-2449 fax 805 North Charles Street, Baltimore, Maryland 21201 410-625-4823 voice 410-625-4674 fax

SHEET DESIGNATION A-500

* * * * *

CONTRACT NUMBER 25122 PO0

JOB ORDER NUMBER PROJ-10001187 SHEET **14** OF 60

DRAWING NUMBER 2025-2125 file no.: 8

BALTIMORE COUNTY OFFICE OF BUDGET AND FINANCE - PROPERTY MANAGEMENT BCDC LOBBY RENOVATIONS

DETAILS

RENOVATION

720 BOSLEY AVENUE, TOWSON, MD 21204

ELECTION DIST. NO.: 9C6

41NE2 | PLAN SCALE: | As indicated R APPROVED BY ME, AND THAT I AM A DULY LICENSED R.O.W NO. PROPERTY MANAGER ROFESSIONAL ARCHITECT UNDER THE LAWS OF THE STATE OF PROFILE SCALE EXPIRATION DATE **06/13/2027** CONTRACT COMPLETION BOX ARCHITECT: BUREAU OF ENGINEERING AND CONSTRUCTION TRAFFIC HIGHWAYS STRUCTURES STORM DRAINS SEWER FIELD ENGINEE WATER Frank Elwood Dittenhafer, II REVIEWED BY: AS-BUILT PER RECORD PRINT CHKD BY: RDT DATE REVIEWED:

BY DATE P.W.A. NO. KEY SHEET POSITION SHT DRAWING SCALE


PROPERTY MANAGEMENT

SUBDIVISION: TOWSON


AS-BUILT / REVISION

PROFESSIONAL CERTIFICATION

HEREBY CERTIFY THAT THESE DOCUMENTS WERE PREPARED

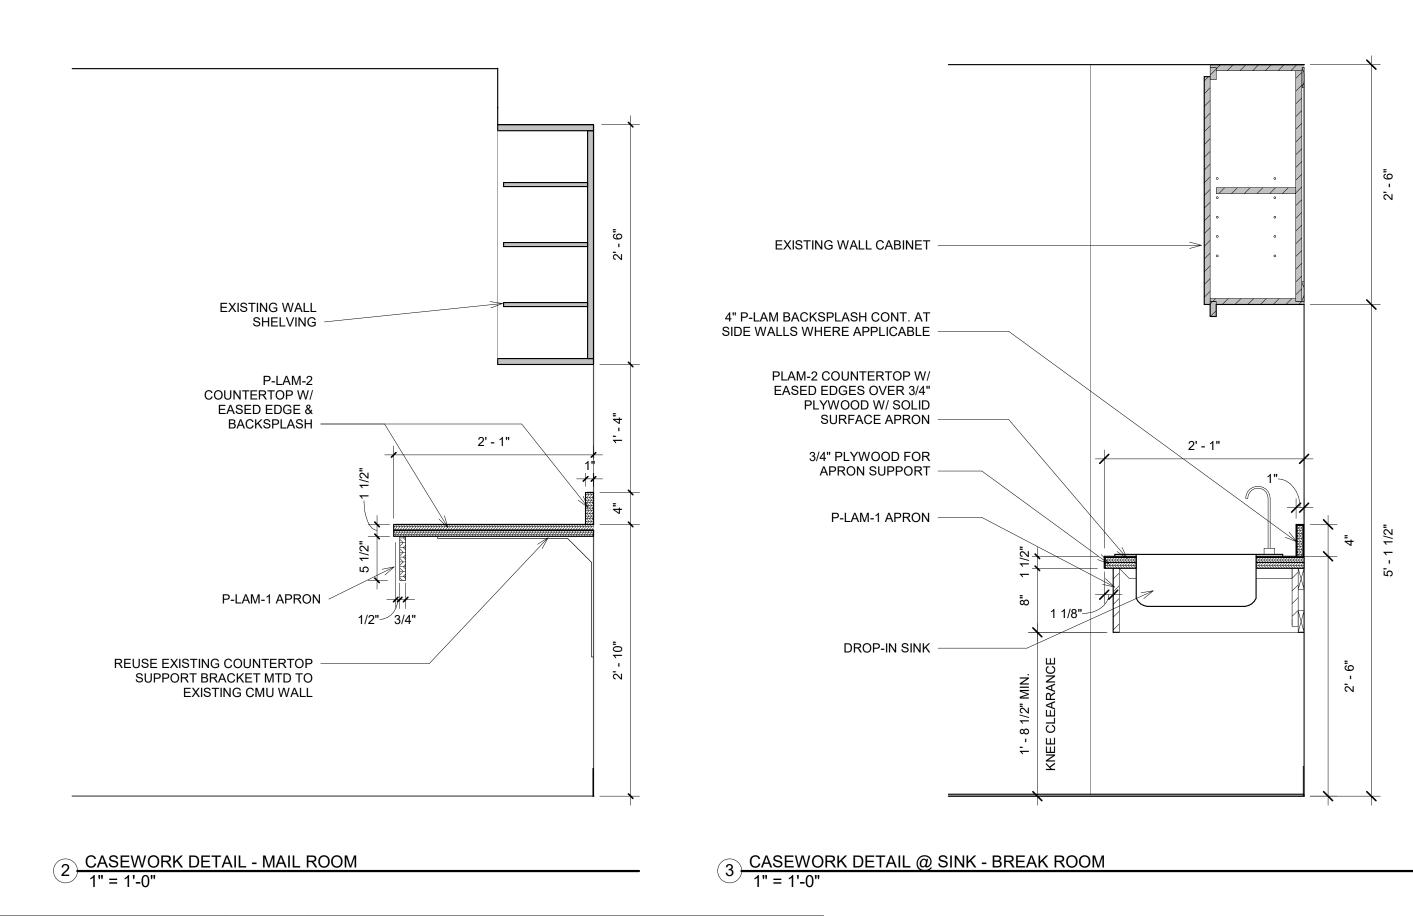

SUBDIVISION: TOWSON

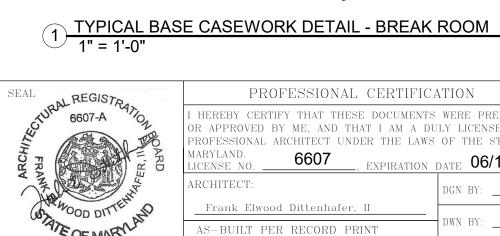

PLAM-2 -COUNTERTOP & BACKSPLASH

PLAM-1 PANEL

ADJUSTABLE PLAM SHELF

INTERIOR(TYP)

DOOR

1' - 11 1/8"

AS-BUILT / REVISION BY DATE P.W.A. NO. KEY SHEET POSITION SHT DRAWING SCALE PROPERTY MANAGEMENT PROFESSIONAL CERTIFICATION HEREBY CERTIFY THAT THESE DOCUMENTS WERE PREPARED 41NE2 PLAN SCALE: R APPROVED BY ME, AND THAT I AM A DULY LICENSED R.O.W NO. PROPERTY MANAGER ROFESSIONAL ARCHITECT UNDER THE LAWS OF THE STATE OF PROFILE SCALE: EXPIRATION DATE **06/13/2027** CONTRACT COMPLETION BOX BUREAU OF ENGINEERING AND CONSTRUCTION TRAFFIC HIGHWAYS STRUCTURES STORM DRAINS SEWER WATER FIELD ENGINEE Frank Elwood Dittenhafer, II REVIEWED BY: AS-BUILT PER RECORD PRINT CHKD BY: RDT DATE REVIEWED:

BALTIMORE COUNTY OFFICE OF BUDGET AND FINANCE - PROPERTY MANAGEMENT

BCDC LOBBY RENOVATIONS

DETAILS

RENOVATION

720 BOSLEY AVENUE, TOWSON, MD 21204

ELECTION DIST. NO.: 9C6

SHEET DESIGNATION A-501 * * * * *

805 North Charles Street, Baltimore, Maryland 21201 410-625-4823 voice 410-625-4674 fax


CONTRACT NUMBER 25122 PO0 JOB ORDER NUMBER PROJ-10001187 SHEET **15** OF 60


226 West Market Street, York, Pennsylvania 17401 717-848-8627 voice 717-843-2449 fax


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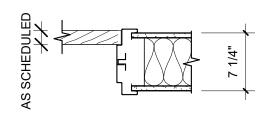
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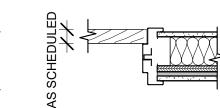
							DOOR S	CHEDULE	<u> </u>			
		DIMENSIONS			OOOR	F	RAME	CONS	TRUCTION [DETAILS	HARDWARE	
MARK	WIDTH	HEIGHT	THICKNESS	TYPE	MATERIAL	TYPE	MATERIAL	HEAD	JAMB	SILL	SET	COMMENTS
Existing												
AD301	ETR	ETR	ETR	ETR	ETR	ETR	НМ	ETR	ETR	ETR		ETR. CONTROLS FROM RECEPTION DESK TO REMAIN.
AD302	ETR	ETR	ETR	ETR	ETR	ETR	HM	ETR	ETR	ETR		ETR. CONTROLS FROM RECEPTION DESK TO REMAIN.
AD304	ETR	ETR	ETR	ETR	ETR	ETR	НМ	ETR	ETR	ETR		
AD305	ETR	ETR	ETR	ETR	ETR	ETR	НМ	ETR	ETR	ETR		
AD309	ETR	ETR	ETR	ETR	ETR	ETR	НМ	ETR	ETR	ETR		PROVIDE T-STRIP THRESHOLD
AD310	ETR	ETR	ETR	ETR	ETR	ETR	НМ	ETR	ETR	ETR		PROVIDE T-STRIP THRESHOLD
AD311	ETR	ETR	ETR	ETR	ETR	ETR	НМ	ETR	ETR	ETR		
AD314	ETR	ETR	ETR	ETR	ETR	ETR	НМ	ETR	ETR	ETR		
AD341	ETR	ETR	ETR	ETR	ETR	ETR	НМ	ETR	ETR	ETR		PROVIDE T-STRIP THRESHOLD
AD342	ETR	ETR	ETR	ETR	ETR	ETR	НМ	ETR	ETR	ETR		PROVIDE T-STRIP THRESHOLD
AD343	ETR	ETR	ETR	ETR	ETR	ETR	НМ	ETR	ETR	ETR		PROVIDE T-STRIP THRESHOLD
AD344	ETR	ETR	ETR	ETR	ETR	ETR	НМ	ETR	ETR	ETR		PROVIDE T-STRIP THRESHOLD
AD354	ETR	ETR	ETR	ETR	ETR	ETR	НМ	ETR	ETR	ETR		PROVIDE T-STRIP THRESHOLD
AD355	ETR	ETR	ETR	ETR	ETR	ETR	НМ	ETR	ETR	ETR		PROVIDE T-STRIP THRESHOLD
AD356	ETR	ETR	ETR	ETR	ETR	ETR	НМ	ETR	ETR	ETR		PROVIDE T-STRIP THRESHOLD
4D367	ETR	ETR	ETR	ETR	ETR	ETR	НМ	ETR	ETR	ETR		PROVIDE T-STRIP THRESHOLD
AD368	3' - 0"	7' - 0"	1 1/2"	ETR	ETR	ETR	HM	ETR	ETR	ETR		
AD373	3' - 0"	7' - 0"	1 1/2"	ETR	ETR	ETR	HM	ETR	ETR	ETR	4	CARD READER
New Constr	ruction											
1	3' - 0"	7' - 0"	1 3/4"	FG2	DHM	F1	DHM	H2	J2	S1	1	LEVEL 3 BALLISTIC DOOR, GLAZING & DOOR FRAME. CARD READER
2	3' - 0"	7' - 0"	1 3/4"	FG2	НМ	F1	HM	H1	H1	S1	2	PROVIDE T-STRIP THRESHOLD. CARD READER ACCESS MAIN LOBBY SIDE.
3	3' - 0"	7' - 0"	1 3/4"	FG2	WD	F1	НМ	H1	H1	S1	3	PROVIDE T-STRIP THRESHOLD.
4	3' - 0"	7' - 0"	1 3/4"	FG2	WD	F1	НМ	H1	H1	S1	3	PROVIDE T-STRIP THRESHOLD
5	3' - 0"	7' - 0"	1 3/4"	FG2	WD	F1	НМ	H1	H1	S1	3	PROVIDE T-STRIP THRESHOLD






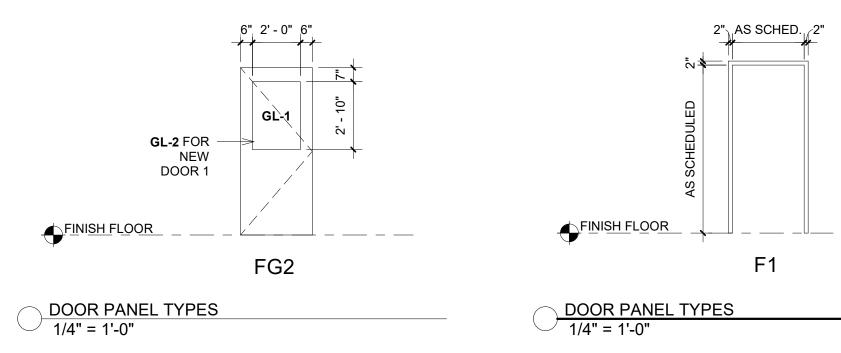

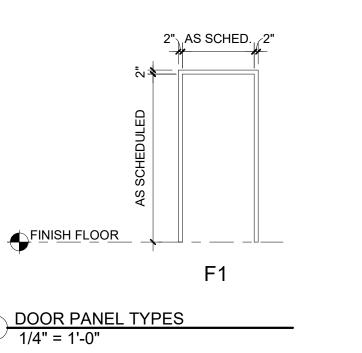


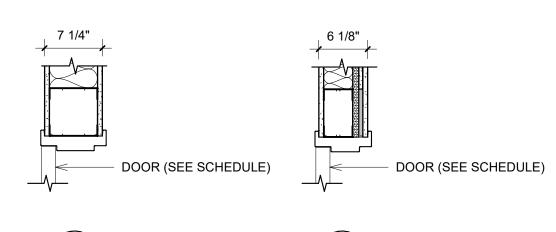




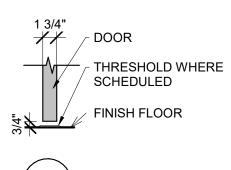

(S1)

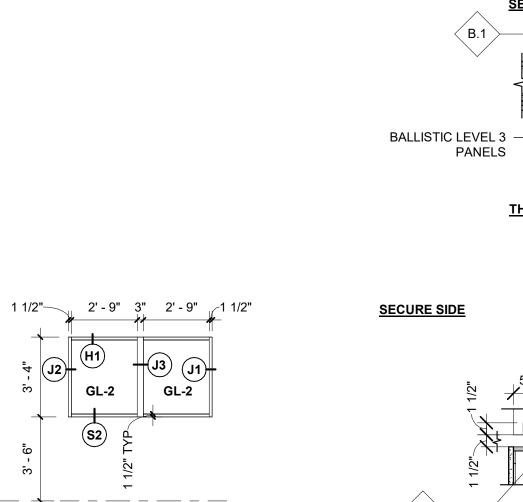

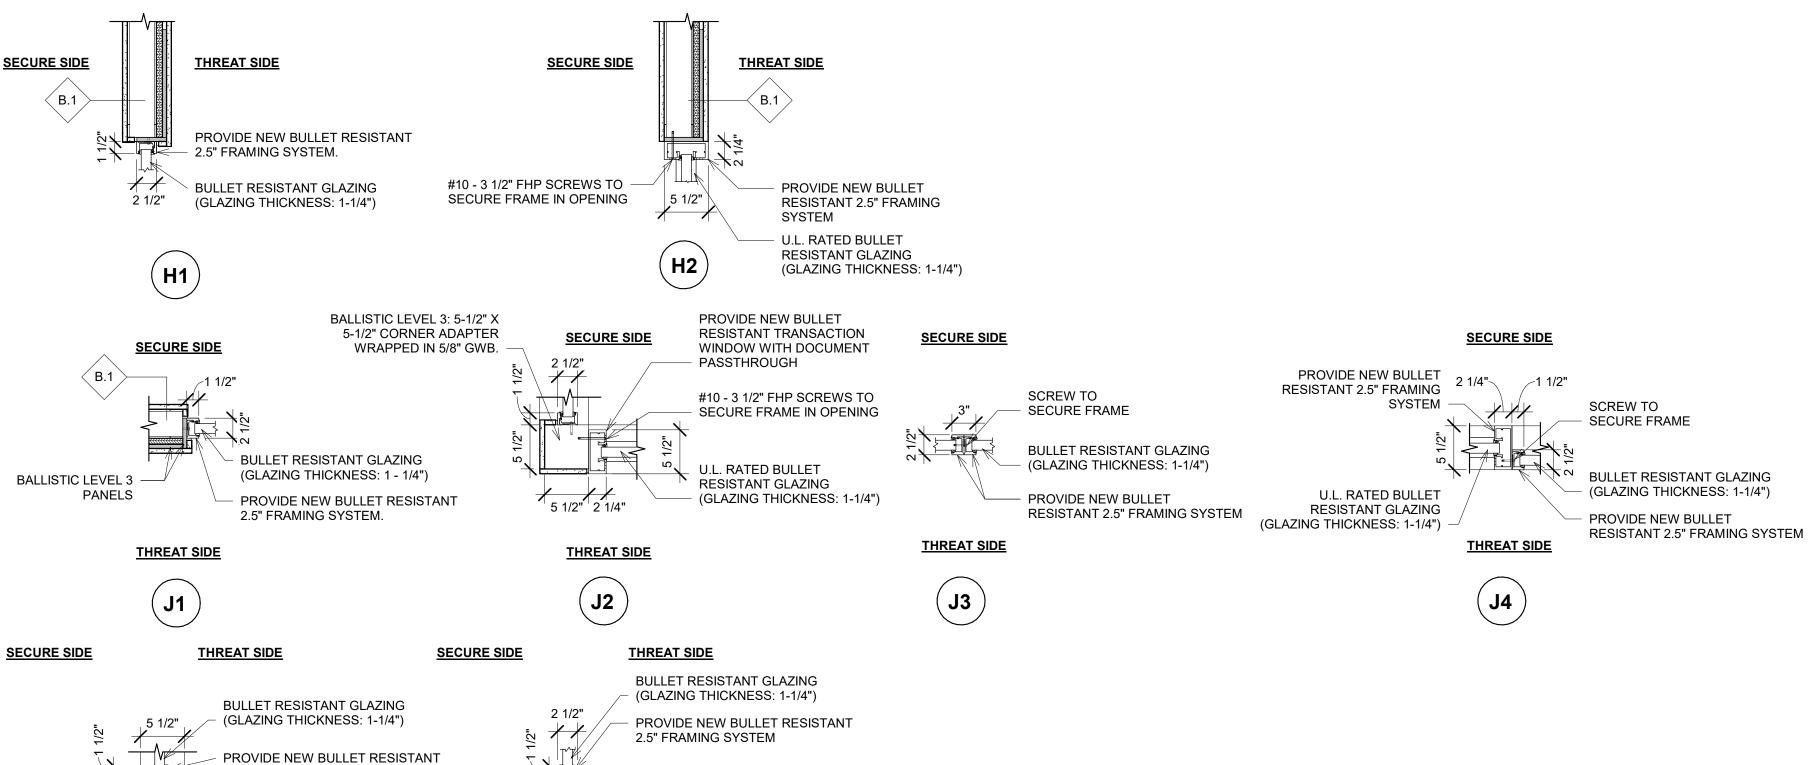


BALLISTIC LEVEL 3

PANELS

(s2)

SUBDIVISION: TOWSON

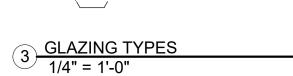

1 1/2" 2' - 0 3/8" 1 1/2"

 $\langle G1 \rangle$

(S1

TRANSACTION WINDOW WITH

DOCUMENT PASSTHROUGH

SS COUNTERTOP

GLAZING SCHEDULE
GL-1 CLEAR TEMPERED INTERIOR GLAZING GL-2 BALLISTIC LEVEL 3 GLAZING

SEAL REGISTA	PROFESSIONAL CERTIFICA	ATION	AS-BUILT / REV	/ISION	BY DATE	P.W.A. NO.	KEY SHEET	POSITION SHT	DRAWING	SCALE	PROPERTY MAN	NAGEMENT
3	I HEREBY CERTIFY THAT THESE DOCUMENTS						NNW	41NE2	PLAN SCALE:	As indicated	APPROVED BY:	
Cod Cod	OR APPROVED BY ME, AND THAT I AM A DUPROFESSIONAL ARCHITECT UNDER THE LAWS					R.O.W NO.					PROPERTY MAN	
THE RESERVE THE PROPERTY OF THE PARTY OF THE	MARYLAND. LICENSE NO. 6607 EXPIRATION	DATE 06/13/2027	CONTRACT COMPLETIO	N BOX					PROFILE SCALE:		DATE:	
A A THE STATE OF T	ARCHITECT:	DGN BY: RDT	BUREAU OF ENGINEERING AND CONSTRUCTION	TRAFFIC	HIGHWAYS	STRUCTURES	STORM DRAINS	SEWER	WATER	FIELD ENGINEER		
WATE OF MARNAGE	Frank Elwood Dittenhafer, II AS-BUILT PER RECORD PRINT	DWN BY: NFL	REVIEWED BY:									
DATE :	BY: DATE:	CHKD BY: RDT	DATE REVIEWED:									

 $\langle G4 \rangle$

3

4' - 4"

 $\langle G3 \rangle$

 $\langle G2 \rangle$

A-500

BALTIMORE COUNTY OFFICE OF BUDGET AND FINANCE - PROPERTY MANAGEMENT

BCDC LOBBY RENOVATIONS

DOOR AND GLAZING SCHEDULE

RENOVATION

ELECTION DIST. NO.: 9C6 720 BOSLEY AVENUE, TOWSON, MD 21204

SHEET DESIGNATION A-600 ***

805 North Charles Street, Baltimore, Maryland 21201 410-625-4823 voice 410-625-4674 fax

CONTRACT NUMBER 25122 PO0 JOB ORDER NUMBER PROJ-10001187

SHEET **16** OF 60 DRAWING NUMBER 2025-2127

file no.: 8

226 West Market Street, York, Pennsylvania 17401 717-848-8627 voice 717-843-2449 fax

N REGISTA	PROFESSIONAL CERTIFIC	AS-BUILT / REVISION	BY	DATE P.W.A. NO.	KEY SHEET	POSITION SHT	DRAWING	SCALE	PROPERTY MANAGEMENT		
RAL REGISTRATION	I HEREBY CERTIFY THAT THESE DOCUMENTS OR APPROVED BY ME. AND THAT I AM A DI					NNW	41NE2	PLAN SCALE:	1" = 1'-0"	APPROVED BY:	
ARD ARD	PROFESSIONAL ARCHITECT UNDER THE LAWS		CONTRACT COMPLETION BOX		R.O.W NO.	_		PROFILE SCALE:		PROPERTY MANAGER	
N. A. S.	ARCHITECT:	DGN BY: RDT	BUREAU OF ENGINEERING AND CONSTRUCTION TRAFFIC	HIG	HWAYS STRUCTURES	STORM DRAINS	SEWER	WATER	FIELD ENGINEER		
WOOD DITTEMENT	Frank Elwood Dittenhafer, II AS-BUILT PER RECORD PRINT	DWN BY: NFL	REVIEWED BY:								
	BY: DATE:	CHKD BY: RDT	DATE REVIEWED:								SUBDIVISION: TOWSON

BALTIMORE COUNTY OFFICE OF BUDGET AND FINANCE - PROPERTY MANAGEMENT BCDC LOBBY RENOVATIONS

PARTITION TYPES

RENOVATION 720 BOSLEY AVENUE, TOWSON, MD 21204

ELECTION DIST. NO.: 9C6

A-601 * * * * *

805 North Charles Street, Baltimore, Maryland 21201 410-625-4823 voice 410-625-4674 fax

SHEET DESIGNATION CONTRACT NUMBER 25122 PO0 JOB ORDER NUMBER

PROJ-10001187 SHEET **17** OF 60 DRAWING NUMBER 2025-2128

226 West Market Street, York, Pennsylvania 17401 717-848-8627 voice 717-843-2449 fax

file no.: 8

PROVIDE BACKER
BOARD AT
LOCATIONS WHERE
CERAMIC TILE WALL
BASE IS INSTALLED 5 1/2" ACOUSTICAL BATT INSULATION - FINISH FLOOR 1" = 1'-0"

PARTITION TYPES

1" = 1'-0"

A.1 AS SHOWN - MIN. STC RATING 50 BUT W/ GYP UP A.2 AS SHOWN - BUT WITH 3 5/8" MTL STUDS

A SERIES - MTL STUDS

UP TO STRUCTURE ABOVE,

- 6", 25 GAUGE METAL STUD

@ 16" O.C., 20 GAUGE FOR

WALLS 20'-0" + IN HEIGHT

5/8" GYPSUM WALL BOARD, BOTH SIDES

— 5 1/2" ACOUSTICAL BATT

- SEE FINISH SCHEDULE FOR

INSULATION

FINISH FLOOR

√ VB-1 TYP

CEILING (SEE FINISH SCHEDULE)

B SERIES - MTL STUDS B.1 AS SHOWN

– 3 5/8", 25 GAUGE METAL STUD @ 16" O.C. W/ BATT INSUL.

— 3 5/8", 25 GAUGE METAL STUD

@ 16" O.C. W/ BATT INSUL.

1/2" BALLISTIC PANELS ATTACHED PER MFG.

- 3/4" FR PLYWOOD

— 5/8" GYPSUM WALL BOARD, BOTH SIDES

- 1/2" BALLISTIC PANELS UP TO 8' ATTACHED PER MFG.

- 3/4" FR PLYWOOD

INSULATION

FINISH FLOOR

VB-1 TYP

- 3" ACOUSTICAL BATT

- SEE FINISH SCHEDULE FOR

- 3/4" FR PLYWOOD

— 5/8" GYPSUM WALL BOARD, BOTH SIDES

- 1/2" GWB ABOVE BALLISTIC PANELS

– 1/2" GWB

C SERIES - FURRING WALL

C.1 AS SHOWN

– VB-1 TYP

FINISH FLOOR

- SEE FINISH SCHEDULE FOR

- 1-5/8" .25 GAUGE METAL STUD @ 16" O.C., 20 GAUGE FOR WALLS 20'-0" + IN - 5/8" GYPSUM WALL

BOARD, ONE SIDE

CEILING (SEE FINISH SCHEDULE)

UP TO STRUCTURE ABOVE,

GENERAL NOTES

MASONRY:

CONCRETE MASONRY SHALL CONFORM TO THE LATEST EDITION OF ASTM SPECIFICATION C90. CONCRETE MASONRY SHALL BE SAMPLED AND TESTED BY THE MASONRY SUPPLIER ACCORDING TO ASTM C140. ALL CONCRETE MASONRY CONSTRUCTION SHALL CONFORM TO TMS 402, "BUILDING CODE REQUIREMENTS FOR MASONRY STRUCTURES" (LATEST LOCAL APPROVED EDITION) AND TMS 602, "SPECIFICATION FOR MASONRY STRUCTURES" (LATEST LOCAL APPROVED EDITION).

UNLESS OTHERWISE NOTED, CONCRETE MASONRY UNITS SHALL HAVE A MINIMUM COMPRESSIVE STRENGTH OF 2000 PSI ON THE NET AREA. ALL BRICK SHALL HAVE A MINIMUM COMPRESSIVE STRENGTH OF 3350 PSI ON THE NET AREA.

ALL MORTAR SHALL CONFORM TO ASTM C270. MORTAR TO BE USED SHALL BE SAMPLED AND TESTED BY THE BRICK AND MASONRY SUPPLIERS ACCORDING TO ASTM C780 AND RESULTS SUBMITTED TO THE ENGINEER FOR APPROVAL. MORTAR SHALL BE PORTLAND CEMENT/LIME MORTAR TYPE "S" AS A MINIMUM.

PROVIDE 16" MINIMUM BRICK OR 100% SOLID MASONRY BELOW ALL LINTELS.

LINTELS OVER OPENINGS 10'-0" WIDE OR LESS IN INTERIOR NON-BEARING MASONRY PARTITIONS NOT OTHERWISE SPECIFIED SHALL BE PRECAST LIGHTWEIGHT CONCRETE LINTELS REINFORCED WITH 1-#5 BAR TOP AND BOTTOM FOR EACH 4"

ALL SOLID CMU SHALL BE 100% SOLID BLOCK OR HOLLOW BLOCK WITH CELLS FILLED 100% SOLID WITH f 'c=3000 PSI COARSE AGGREGATE GROUT CONFORMING TO ASTM C476. GROUT SHALL BE PLACED IN POUR HEIGHTS NOT TO EXCEED 4'-0" AS CMU CONSTRUCTION PROGRESSES. THE WEBS OF THE MASONRY UNITS SHALL BE FULLY MORTARED AROUND ALL GROUTED CELLS.

ALL REINFORCED CELLS IN HOLLOW BLOCK SHALL BE GROUTED 100% SOLID PER NOTE ABOVE.

ALL SPLICES IN REINFORCING STEEL FOR MASONRY WALLS SHALL AS FOLLOWS UNLESS NOTED OTHERWISE:

 #4 BAR ---- 2'-8" • #5 BAR ---- 3'-4"

UNLESS NOTED OTHERWISE, 8" CMU WALLS SHALL BE REINFORCED WITH #4 AT 72"o.c.

IN ADDITION TO REINFORCING STEEL NOTED ON PLANS, SCHEDULES AND SECTIONS, PROVIDE VERTICAL BARS OF SAME SIZE WITHIN 8"OF EACH SIDE OF WALL CONTROL JOINTS, WITHIN 8" OF THE ENDS OF WALLS, WITHIN 16" OF EACH SIDE OF OPENINGS AND AT ALL CORNERS.

REINFORCING BAR POSITIONERS SHALL BE USED TO HOLD BARS IN PROPER LOCATION. POSITIONERS SHALL BE PLACED AT A MAXIMUM VERTICAL SPACING

#4 DOWELS AND SPACING TO MATCH VERTICAL REINFORCEMENT UNLESS NOTED OTHERWISE. NOTE: 13

GROUTED SOLID A MINIMUM OF 8" ABOVE AND BELOW THE ANCHOR AND A MINIMUM

ALL MASONRY ANCHORS SHALL BE INSTALLED IN MASONRY THAT HAS BEEN

ALL NON-BEARING CMU WALLS SHALL BE DOWELED TO THE SUPPORTING SLAB WITH

OF 8" EACH SIDE OF THE ANCHOR.

MASONRY CONSTRUCTION SHALL BE INSPECTED PER TMS 402, "BUILDING CODE REQUIREMENTS FOR MASONRY STRUCTURES" (LATEST LOCAL APPROVED EDITION)

NOTE: 15

REQUIRED QUALITY ASSURANCE LEVEL: 3

CONDUIT PLACED IN MASONRY SHALL CONFORM TO TMS 402, "BUILDING CODE REQUIREMENTS FOR MASONRY STRUCTURES" (LATEST LOCAL APPROVED EDITION). A SINGLE VERTICAL CONDUIT WITH A MAXIMUM DIAMETER OF 1" IS PERMITTED IN MASONRY PIERS. CONDUIT SHALL BE PLACED A MINIMUM 1" CLEAR FROM ALL VERTICAL REINFORCEMENT. LARGER CONDUIT AND/OR GREATER QUANTITIES ARE NOT PERMITTED IN MASONRY PIERS WITHOUT THE APPROVAL OF THE ENGINEER OF RECORD. NO CONDUIT SHALL BE PLACED IN BOND BEAMS.

TYPICAL INFILLING, REMOVAL AND REPAIR OF EXISTING MASONRY

WHERE NEW MASONRY IS TO BE ADDED, THE MASONRY SHALL BE TOOTHED AND MORTARED (SEE GUIDELINES FOR "REPAIR"). THE NEW MASONRY SHALL BEAR ON THE EXISTING CONCRETE FLOOR OR ON THE EXISTING MASONRY. IN THE LATER CASE, THE EXISTING MASONRY SHALL BE REMOVED TO GOOD, SOLID MATERIAL. THE DRAWINGS INDICATE THE APPROXIMATE EXTENT OF THE REQUIRED MASONRY INFILL. THIS IS A GUIDE ONLY AND THE EXACT EXTENT SHALL BE DETERMINED BY THE CONTRACTOR BASED ON FIELD CONDITIONS. WHEN THE RESULTING MASONRY WOULD BE PART NEW AND PART EXISTING AND WOULD FORM A PIER OR OTHERWISE SMALL ELEMENT, REMOVE ALL THE EXISTING MASONRY AND MAKE A NEW PIER OR

MASONRY CONTINUED:

IN THOSE AREAS WHERE NEW OPENINGS MUST BE MADE THROUGH EXISTING MASONRY WALLS, THE EXISTING MASONRY SHALL BE CAREFULLY REMOVED AFTER THE WALL THAT REMAINS ABOVE THE PROPOSED OPENING HAS BEEN TEMPORARILY SUPPORTED OR AFTER THE LINTELS HAVE BEEN PUT IN PLACE. ANY REQUIRED CUTTING BEYOND THE MASONRY OPENING SHALL BE PATCHED WITH MASONRY AND MORTAR (SEE GUIDELINES FOR "REPAIR"). WHEN THE MASONRY THAT REMAINS AFTER REMOVAL WOULD RESULT IN A PIER OR OTHERWISE SMALL ELEMENT, THE EXISTING MASONRY SHALL BE REMOVED AND A NEW PIER OR WALL SHALL BE CONSTRUCTED. THE CONTRACTOR IS RESPONSIBLE FOR THE SUPPORT OF THE WALLS PRIOR TO AND DURING THE INSTALLATION OF LINTELS REQUIRED TO SUPPORT THE MASONRY

ABOVE THE NEW OPENING.

IN THOSE AREAS WHERE THE EXISTING MASONRY HAS DETERIORATED, SAGGED OR CRACKED, THE MASONRY SHALL BE REMOVED AND REPLACED. EXISTING BRICKS MAY BE RE-USED PROVIDED THAT THEY ARE IN GOOD CONDITION. THE NEW MORTAR USED TO REPLACE THE EXISTING MORTAR SHALL MATCH SOUND EXISTING MORTAR IN STIFFNESS AND CONSISTENCY. IF NEW BRICKS ARE REQUIRED, THEY ALSO SHALL MATCH EXISTING BRICKS IN GOOD CONDITION. THE NEW MASONRY SHALL BE TOOTHED INTO THE EXISTING WALL. ALL NEW MASONRY WORK IS SUBJECT TO THE APPROVAL OF THE ARCHITECT.

POST-INSTALLED ANCHORS AND REINFORCING:

- ANCHORS SHALL BE THE FOLLOWING TYPES MANUFACTURED BY HILTI, INC.: a. MECHANICAL ANCHORS IN CONCRETE: HILTI KWIK BOLT TZ2 EXPANSION ANCHOR PER ICC ESR-4266
- b. MECHANICAL ANCHORS IN SOLID GROUTED MASONRY: HILTI KWIK BOLT TZ2 EXPANSION ANCHOR PER ICC ESR-4561

ALTERNATE MANUFACTURERS OR ANCHORS MUST BE SUBMITTED TO THE ARCHITECT FOR REVIEW AND APPROVAL PRIOR TO USE. THE CONTRACTOR SHALL PROVIDE SIGNED AND SEALED CALCULATIONS DEMONSTRATING THAT THE PROPOSED SUBSTITUTIONS, BASED ON THEIR SPECIFIC ICC-ES EVALUATION REPORTS, ARE CAPABLE OF ACHIEVING THE PERFORMANCE VALUES EQUAL TO OR GREATER THAN THOSE OF THE ANCHORS SPECIFIED.

MECHANICAL ANCHORS SHALL NOT BE INSTALLED UNTIL THE CONCRETE OR GROUT HAS ATTAINED 70% OF ITS DESIGN STRENGTH.

ALL POST INSTALLED ANCHORS AND REINFORCING SHALL BE INSTALLED IN DRY HOLES THAT HAVE BEEN DRILLED, CLEANED AND PREPARED IN STRICT ACCORDANCE WITH THE MANUFACTURER'S WRITTEN INSTALLATION INSTRUCTIONS AND THE RESPECTIVE ICC ES EVALUATION REPORTS.

ALL ANCHORS AND REINFORCING SHALL BE INSTALLED IN ACCORDANCE WITH THE SPACING AND EDGE DISTANCES SHOWN IN THE DRAWINGS. THE CONTRACTOR SHALL INFORM THE ARCHITECT PRIOR TO INSTALLING THE ANCHORS IF THE SPACING AND EDGE DISTANCES SHOWN IN THE DRAWINGS CANNOT BE ACHIEVED. IF THIS IS THE CASE, RE-DESIGN MIGHT BE REQUIRED AND THE ANCHORS SHOULD NOT BE INSTALLED UNTIL APPROVAL HAS BEEN PROVIDED BY COLUMBIA ENGINEERING, INC.

NOTE: 5

MECHANICAL ANCHORS INSTALLED IN GROUTED MASONRY SHALL BE LOCATED A MINIMUM 1 1/2" FROM VERTICAL MORTAR JOINTS.

NOTE: 6

DO NOT CUT ANY REINFORCING UNLESS IT IS SPECIFICALLY INDICATED IN THE DRAWINGS OR IS APPROVED BY COLUMBIA ENGINEERING INC.

STEEL:

NOTE: 1

STRUCTURAL STEEL FOR ANGLE SHAPES SHALL CONFORM TO ASTM SPECIFICATION A36. MILL TEST REPORTS SHALL BE SUBMITTED TO THE ARCHITECT. ALL STEEL SHALL BE DETAILED, FABRICATED AND ERECTED IN ACCORDANCE WITH THE AISC MANUAL, AISC SPECIFICATION AND AISC CODE OF STANDARD PRACTICE.

NOTE: 2

WELDS SHALL BE MADE WITH E70XX LOW HYDROGEN ELECTRODES. WELDING SEQUENCE AND TECHNIQUE SHALL BE SUCH THAT DISTORTION OF STEEL MEMBERS IS MINIMIZED AND UNDUE DISTORTION IS AVOIDED.

FIELD MODIFICATION OF THE STRUCTURAL STEEL IS NOT ALLOWED WITHOUT PRIOR REVIEW BY THE ARCHITECT AND STRUCTURAL ENGINEER.

NOTE: 3

ALL STRUCTURAL STEEL SHALL BE SHOP PAINTED WITH A RUST INHIBITIVE PRIMER.

EXISTING CONSTRUCTION:

NOTE: 1

COLUMBIA ENGINEERING INC. PREPARED THESE PLANS BASED ON A LIMITED AMOUNT OF FIELD EXPLORATION AND ON THE STRUCTURAL INFORMATION SHOWN IN THE ORIGINAL CONSTRUCTION DRAWINGS PREPARED BY DMJMH+N, DATED 08/23/2002. THE EXISTING MEMBER SIZES ARE NOTED (E) AND ARE SHOWN IN THE PLANS. THE CONTRACTOR SHALL VERIFY THAT THE EXISTING MEMBERS SHOWN IN THE PLANS MATCH EXISTING AS BUILT CONDITIONS PRIOR TO PREPARING SHOP DRAWINGS. IF THE AS BUILT CONDITIONS DO NOT CONFORM TO THE INFORMATION SHOWN IN THE PLANS, OR IF ANY STRUCTURAL MEMBER IS FOUND TO BE IN POOR CONDITION, THE CONTRACTOR SHALL INFORM COLUMBIA ENGINEERING INC. OF THE ACTUAL SIZES AND/OR CONDITION. RE-DESIGN AND ADDITIONAL FRAMING MAY BE REQUIRED.

EXISTING CONSTRUCTION CONTINUED:

CONTRACTOR SHALL SCAN EXISTING CONCRETE PRIOR TO CUTTING, DRILLING, OR OTHERWISE MODIFYING THE EXISTING STRUCTURE. IF CUTTING OF REINFORCEMENT OR EXISTING MEMBER CANNOT BE AVOIDED, THEN PRIOR TO CUTTING, THE CONTRACTOR SHALL PREPARE A DETAILED DRAWING SHOWING THE PROPOSED PENETRATION AND ALL THE AFFECTED REINFORCEMENT AND SUPPORTING MEMBERS AND SHALL SUBMIT THE DRAWING TO COLUMBIA ENGINEERING INC. FOR REVIEW AND APPROVAL. THE CONTRACTOR SHALL NOT CUT ANY REINFORCEMENT OR MEMBER WITHOUT THE PRIOR APPROVAL OF COLUMBIA ENGINEERING, INC.

SUBMITTALS:

SHOP DRAWINGS FOR ALL STRUCTURAL ELEMENTS SHOWN ON THE CONTRACT DOCUMENTS MUST BE SUBMITTED FOR REVIEW BY THE CONTRACTOR. IF A CONTRACTOR FAILS TO SUBMIT THE SHOP DRAWINGS, COLUMBIA ENGINEERING, INC. WILL NOT BE RESPONSIBLE FOR THE STRUCTURAL CERTIFICATION AND/OR THE DESIGN OF THE PROJECT.

COLUMBIA ENGINEERING'S REVIEW OF SUBMITTALS SHALL BE FOR GENERAL CONFORMANCE WITH THE DESIGN INTENT OF THE CONSTRUCTION DOCUMENTS. NO WORK SHALL BE STARTED WITHOUT SUCH REVIEW.

REPRODUCTION OF THE CONTRACT DOCUMENTS WILL NOT BE ACCEPTED AS SHOP DRAWINGS.

SHOP DRAWINGS FOR THE FOLLOWING ITEMS SHALL BE SUBMITTED FOR ARCHITECT/ENGINEER REVIEW: a. GROUT MIX DESIGN.

b. MASONRY REINFORCING STEEL.

SEE SPECIFICATIONS FOR ADDITIONAL REQUIRED SUBMITTALS.

ALL SHOP DRAWINGS USED FOR CONSTRUCTION SHALL BEAR THE STAMP OF THE ARCHITECT/ENGINEER AND SHALL BE MARKED "REVIEWED" OR "REVIEWED AS NOTED".

MISCELLANEOUS:

THE CONTRACTOR SHALL NOTIFY THE ARCHITECT AND STRUCTURAL ENGINEER OF ANY DISCREPANCIES BETWEEN THE STRUCTURAL DOCUMENTS AND ANY OTHER DOCUMENTS OR EXISTING CONDITIONS FOR RESOLUTION PRIOR TO PROCEEDING WITH FABRICATION OR CONSTRUCTION.

THE CONTRACTOR SHALL PROVIDE PROTECTION FOR ALL FINISHES.

ALL WORK SPECIFIED HEREIN SHALL BE INSPECTED IN ACCORDANCE WITH IBC CHAPTER 17 (EXCEPTIONS NOTED SHALL NOT BE PERMITTED) AND ALL LOCAL ORDINANCES. TESTING AND INSPECTION SERVICES SHALL BE PERFORMED BY AN INDEPENDENT, EXPERIENCED, QUALIFIED AGENCY. THE ENGINEER WILL NOT PERFORM THE REQUIRED INSPECTION AS A PART OF HIS DESIGN SERVICE. THE ENGINEER MAY VISIT THE SITE TO ASCERTAIN GENERAL CONFORMANCE TO THE CONTRACT DOCUMENTS, AND SUCH VISITS ARE NOT TO BE CONSTRUED AS MEETING INSPECTION REQUIREMENTS.

NOTE: 4

LEGAL USE OF DOCUMENTS THE PLANS, SPECIFICATIONS AND OTHER INFORMATION CONTAINED IN THESE DRAWINGS (COLLECTIVELY THE "DRAWINGS") WERE PREPARED BY COLUMBIA ENGINEERING. INC. AND ARE INSTRUMENTS OF PROFESSIONAL SERVICES RENDERED AND DELIVERED PURSUANT TO THE TERMS AND CONDITIONS OF A WRITTEN AGREEMENT (THE "AGREEMENT") ONLY TO THE RECIPIENT NAMED THEREIN. ANY USE OF THE DRAWINGS BY ANY PARTY WHICH IS INCONSISTENT WITH THE TERMS AND CONDITIONS OF THE AGREEMENT IS EXPRESSLY PROHIBITED. COLUMBIA ENGINEERING, INC. EXPRESSLY RESERVES ITS COPYRIGHT AND ALL INTELLECTUAL PROPERTY AND OTHER RIGHTS IN THE DRAWINGS. NO PORTION OF THE DRAWINGS ARE TO BE REPRODUCED, CHANGED OR OTHERWISE USED IN ANY FORM OR MANNER WHATSOEVER WHICH IS INCONSISTENT WITH EITHER THE AGREEMENT OR THE PURPOSES FOR WHICH THEY WERE ORIGINALLY PREPARED, NOR ARE THEY TO BE DEEMED ASSIGNED TO ANY PERSON OR ENTITY WITHOUT OBTAINING THE EXPRESS PRIOR WRITTEN PERMISSION AND CONSENT OF COLUMBIA ENGINEERING, INC. THE RECIPIENT OF THE DRAWINGS AGREES TO INDEMNIFY AND HOLD HARMLESS COLUMBIA ENGINEERING, INC., ITS EMPLOYEES, OFFICERS, DIRECTORS AND AGENTS, FROM AND AGAINST ANY AND ALL DAMAGES WHICH ARISE OUT OF OR IN CONNECTION WITH ANY VIOLATION OF THE FOREGOING.

PROPERTY MANAGEMENT

PROPERTY MANAGER

APPROVED BY:

DESIGN CODES:


TMS 402/602-16

41NE2

INTERNATIONAL BUILDING CODE: IBC 2021

BUILDING CODE REQUIREMENTS FOR MASONRY STRUCTURES:


DESIGN LOADS: IBC RISK CATEGORY 4

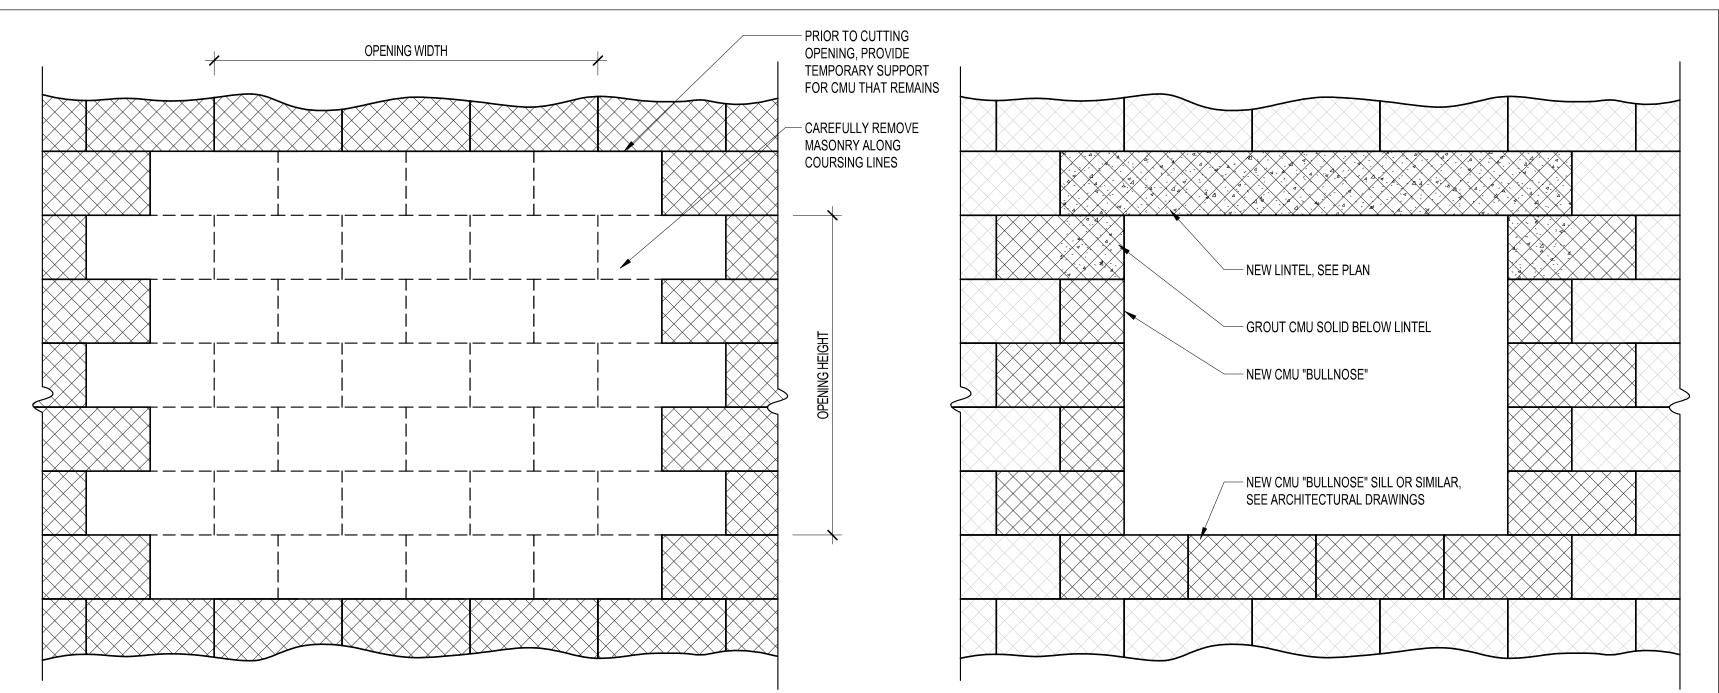

DEMOLITION

OPENING THROUGH EXISTING CMU WALL

\ TYPICAL DETAIL S-001 NOT TO SCALE

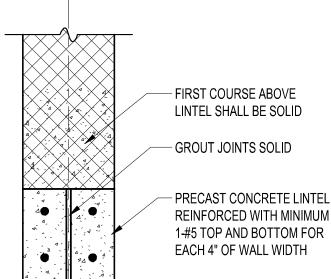

PRECAST LINTELS

1. PRECAST LINTELS SHALL BE INSTALLED OVER OPENINGS IN ALL INTERIOR NON-BEARING PARTITIONS UNLESS NOTED OTHERWISE. 2. PRECAST LINTELS SHALL NOT BE INSTALLED ABOVE OPENINGS WIDER THAN 10'-0" WITHOUT THE CONSENT OF THE ENGINEER OF RECORD.



SCALE: 1 1/2" = 1'-0"



805 North Charles Street, Baltimore, Maryland 2120 410-625-4823 voice 410-625-4674 fax 226 West Market Street, York, Pennsylvania 17401 717-848-8627 voice 717-843-2449 fax

SHEET DESIGNATION S-001

CONTRACT NUMBER 25122 PO0

JOB ORDER NUMBER

PROJ-10001187

SHEET 18 OF 60

DRAWING NUMBER

2025 - 2129

FILE NO.: 8

 $\star\star\star\star\star$

GENERAL NOTES AND TYPICAL DETAILS

BALTIMORE COUNTY OFFICE OF BUDGET AND FINANCE - PROPERTY MANAGEMENT

BCDC LOBBY RENOVATIONS

NEW WORK

RENOVATION

SEAL Digitally signed by Kevin G. McGrath

HEREBY CERTIFY THAT THESE DOCUMENTS WERE PREPARED R APPROVED BY ME, AND THAT I AM A DULY LICENSED COFESSIONAL ENGINEER UNDER THE LAWS OF THE STATE OF NGINEER OF RECORD: DGN BY: KGM KEVIN McGRATH DWN BY: AS-BUILT PER RECORD PRINT

PROFESSIONAL CERTIFICATION

CHKD BY: KGM

CONTRACT COMPLETION BOX

REVIEWED BY: DATE REVIEWED:

AS-BUILT / REVISION

TRAFFIC

HIGHWAYS STRUCTURES STORM DRAINS

R.O.W NO.

SEWER

BY DATE P.W.A. NO. KEY SHEET POSITION SHT DRAWING SCALE


WATER FIELD ENGINE

PROFILE SCAL

PLAN SCALE: As indicated

SUBDIVISION: TOWSON

720 BOSLEY AVENUE, TOWSON, MD 21204

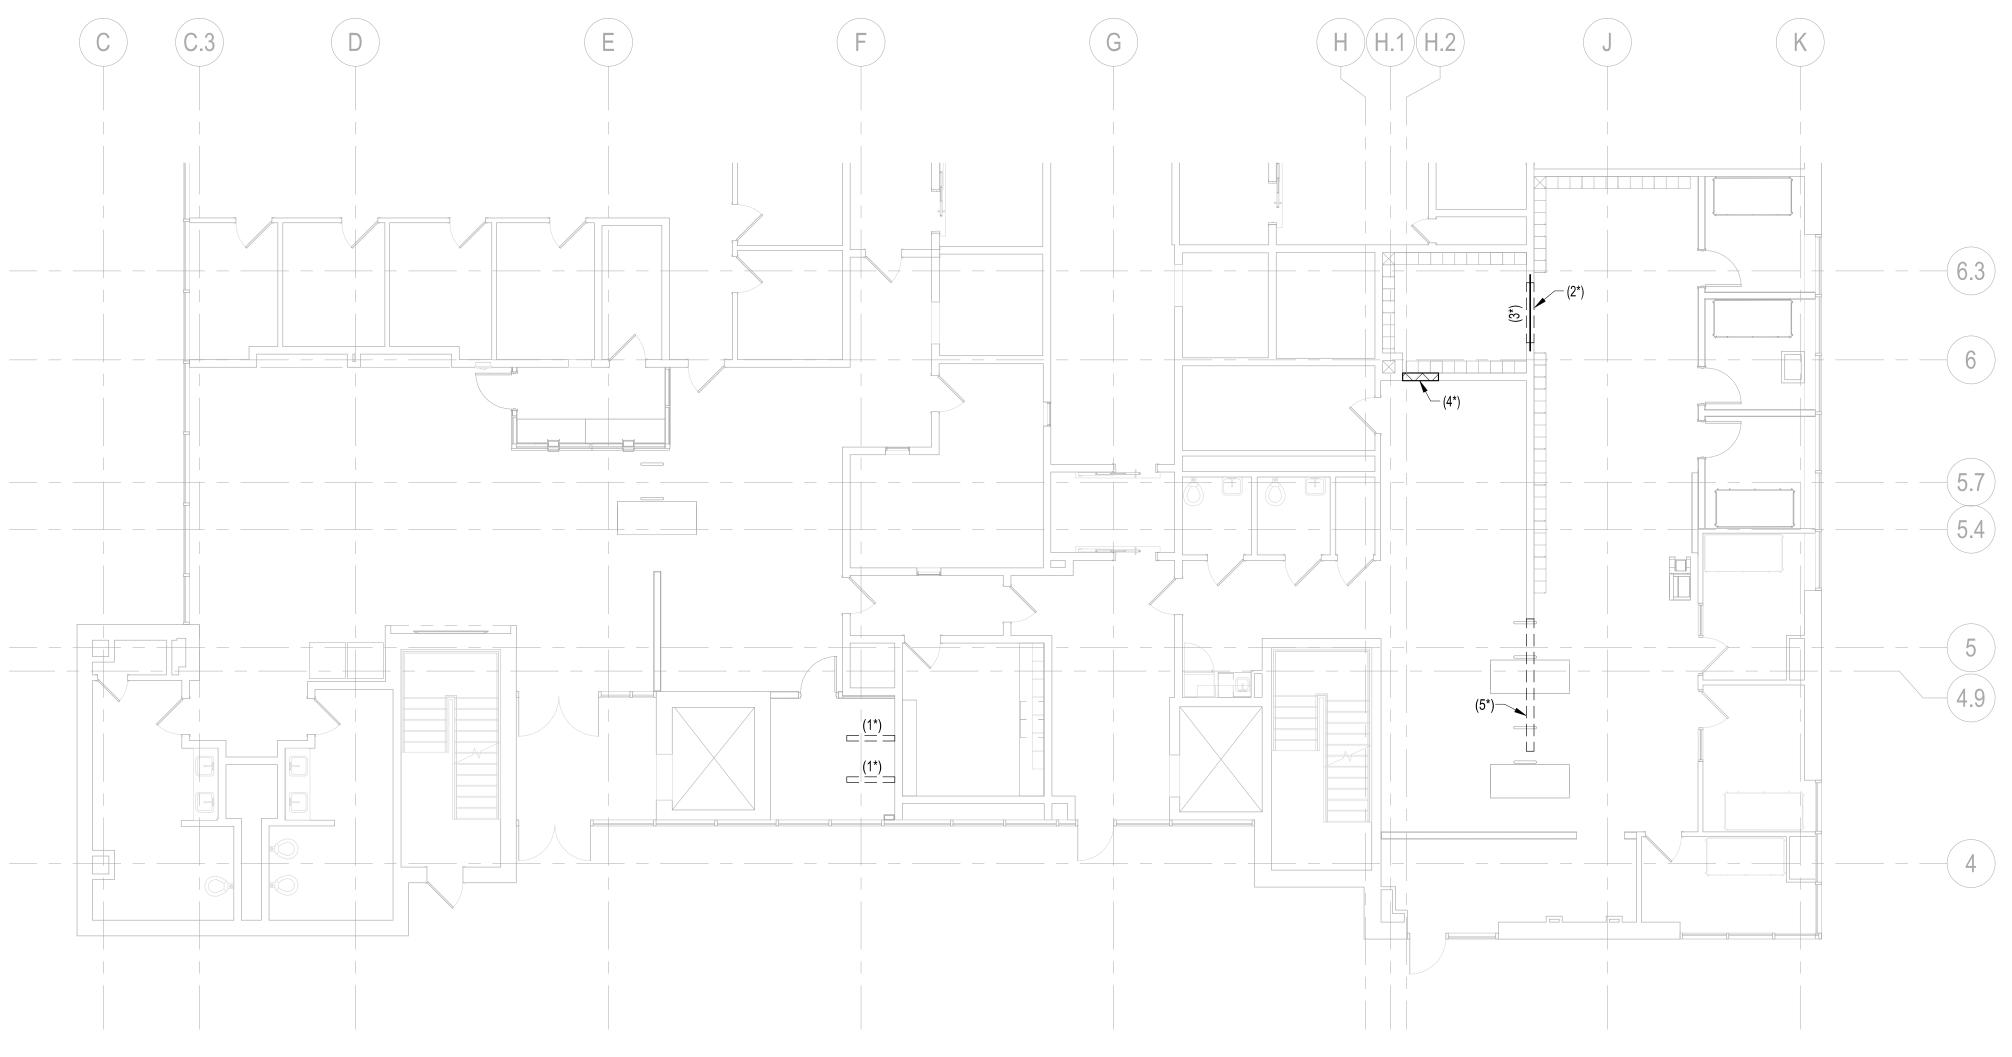

PARTIAL THIRD FLOOR PLAN - STRUCTURAL WORK

THIRD FLOOR NOTES:

1. (E) DENOTES EXISTING DIMENSION OR STRUCTURAL MEMBER. COLUMBIA ENGINEERING, INC. (CEI) PREPARED THIS STRUCTURAL LAYOUT BASED ON THE BUILDING'S ORIGINAL CONTRACT DOCUMENTS AND A LIMITED AMOUNT OF FIELD EXPLORATION. THE CONTRACTOR SHALL VERIFY ALL EXISTING DIMENSIONS AND CONDITIONS AND REPORT ANY DISCREPANCIES TO THE EOR PRIOR TO PROCEEDING WITH FABRICATION OR INSTALLATION.

THIRD FLOOR KEYNOTES:

 ${
m SEAL}$ Digitally signed by Kevin G. McGrath

- (1*) DEMOLISH EXISTING MASONRY WALL. PATCH AND REPAIR ADJACENT EXISTING-TO-REMAIN MASONRY AFTER REMOVAL.
- (2*) NEW OPENING IN EXISTING CMU WALL. REFER TO ARCHITECTURAL DRAWINGS FOR EXACT SIZE AND LOCATION. REFER TO SECTION A/S-001.
- (3*) NEW PRECAST MASONRY LINTEL ABOVE OPENING. INSTALL (2) 4"x8" PRECAST MASONRY LINTELS, EACH REINFORCED WITH 1-#5 TOP AND BOTTOM OR (1) 8"x8" PRECAST LINTEL REINFORCED WITH 2-#5 TOP AND BOTTOM. REFER TO SECTION B/S-001.
- (4*) INFILL EXISTING OPENING WITH NEW CMU TO MATCH EXISTING. REFER TO MASONRY NOTES ON SHEET S-001.
- (5*) DEMOLISH EXISTING CMU FULL HEIGHT. REFER TO ARCHITECTURAL DRAWINGS FOR EXACT EXTENT.

2	

AS-BUILT / REVISION BY DATE P.W.A. NO. KEY SHEET POSITION SHT DRAWING SCALE PROFESSIONAL CERTIFICATION PROPERTY MANAGEMENT HEREBY CERTIFY THAT THESE DOCUMENTS WERE PREPARED 41NE2 | PLAN SCALE: | 1/8" = 1'-0" | APPROVED BY:_____ R APPROVED BY ME, AND THAT I AM A DULY LICENSED R.O.W NO. PROPERTY MANAGER PROFILE SCALE: CONTRACT COMPLETION BOX BUREAU OF ENGINEERING
AND CONSTRUCTION ENGINEER OF RECORD: DGN BY: KGM TRAFFIC HIGHWAYS STRUCTURES STORM DRAINS SEWER FIELD ENGINEE WATER REVIEWED BY: AS-BUILT PER RECORD PRINT SUBDIVISION: TOWSON CHKD BY: KGM DATE REVIEWED:

BALTIMORE COUNTY OFFICE OF BUDGET AND FINANCE - PROPERTY MANAGEMENT

BCDC LOBBY RENOVATIONS

PARTIAL THIRD FLOOR PLAN - STRUCTURAL WORK

RENOVATION

720 BOSLEY AVENUE, TOWSON, MD 21204

ELECTION DIST. NO.: 9C6

805 North Charles Street, Baltimore, Maryland 21201 410-625-4823 voice 410-625-4674 fax 226 West Market Street, York, Pennsylvania 17401 717-848-8627 voice 717-843-2449 fax SHEET DESIGNATION CONTRACT NUMBER S-101 ***

25122 PO0 JOB ORDER NUMBER PROJ-10001187 SHEET 19 OF 60 DRAWING NUMBER 2025 - 2130

FILE NO.: 8

COLUMBIA ENGINEERING, INC. STRUCTURAL ENGINEERS 6210 Old Dobbin Lane, Suite 150 Columbia, Maryland 21045 410.992.9970 www.columbiaengineering.com

GENERAL DEMOLITION PROJECT NOTES

- 1. TEMPORARILY REMOVE EXISTING LAY-IN TILE CEILING SYSTEMS INCLUDING ALL GUY WIRE SUPPORTS AND ASSOCIATED SUSPENSION SYSTEMS WHERE REQUIRED TO COMPLETE WORK. LAY-IN TILE CEILING SYSTEMS SHALL THEN BE RE-INSTALLED AFTER NEW/DEMOLITION WORK. THE COST OF REPLACING/REPAIRING ANY DAMAGE TO THE EXISTING LAY-IN TILE CEILING SYSTEM SHALL BE INCURRED BY THE CONTRACTOR.
- . CAREFULLY REMOVE PLASTER TYPE CEILINGS AS REQUIRED TO FACILITATE THE INSTALLATION/REMOVAL OF ALL EXISTING/NEW DUCTWORK AND ALL EXISTING/NEW PIPING SYSTEMS AND ASSOCIATED APPURTENANCES. NEW PLASTER TYPE CEILINGS SHALL BE INSTALLED TO REPLACE EXISTING REMOVED PORTIONS WHERE INDICATED AND REQUIRED.
- NOTIFY THE OWNER, IN WRITING, AT LEAST FOURTEEN (14) DAYS IN ADVANCE OF ALL REQUIRED SHUTDOWNS OF WATER, SEWER, FIRE PROTECTION, GAS, ELECTRICAL SERVICE, OR OTHER UTILITIES. UPON WRITTEN RECEIPT OF APPROVAL FROM OWNER, SHUTDOWNS SHALL BE PERFORMED AS DIRECTED OTHERWISE BY THE OWNER AT NO ADDITIONAL CONTRACT COST. AT THE END OF EACH WORK DAY, SHUT
- DOWN SERVICES SHALL BE RESTORED SO THAT NORMAL USE OF UTILITIES CAN CONTINUE. WHEN WORKING IN AND AROUND THE EXISTING BUILDING, CARE SHALL BE EXERCISED WITH REGARDS TO PROTECTION OF EXISTING STRUCTURE AND MECHANICAL AND ELECTRICAL SERVICES WHICH SHALL
- . REPAIR, REPLACE, OR RESTORE TO THE SATISFACTION OF THE ENGINEER, ALL EXISTING WORK DAMAGED IN THE PERFORMANCE OF THE DEMOLITION AND/OR NEW WORK.
- EXISTING CONDITIONS (DUCTWORK, PIPING, EQUIPMENT, AND MATERIAL(S) INDICATED ON THE CONTRACT DOCUMENTS ARE NOT WARRANTED TO REPRESENT ALL EXISTING AS-BUILT CONDITIONS. FIELD VERIFY EXACT LOCATIONS OF ALL DUCTWORK, PIPING, EQUIPMENT, AND MATERIALS IN THE FIELD PRIOR TO COMMENCING WITH NEW AND DEMOLITION WORK. EXISTING DUCT, PIPE, AND EQUIPMENT SIZES ARE NOT WARRANTED TO BE COMPLETELY CORRECT. FIELD VERIFY ALL EXISTING CONDITIONS PRIOR TO ORDERING MATERIALS AND INSTALLING NEW WORK.
- EXISTING MECHANICAL AND ELECTRICAL WORK INDICATED TO BE REMOVED (PIPES, VALVES, DUCTS, ETC.), SHALL BE REMOVED TO A POINT BELOW THE FINISHED FLOORS OR BEHIND FINISHED WALLS AND CAPPED. TERMINATION POINTS SHALL BE FAR ENOUGH BEHIND FINISHED SURFACES TO ALLOW FOR THE INSTALLATION OF THE NORMAL THICKNESS OF FINISHED MATERIAL.
- 8. EXISTING PIPING NO LONGER REQUIRED TO REMAIN IN SERVICE SHALL BE DISCONNECTED AND REMOVED BACK TO EXISTING ASSOCIATED SERVICE MAINS UNLESS OTHERWISE INDICATED OR NOTED ON THE CONTRACT DRAWINGS. REMOVED EXISTING PIPE HANGERS, PIPE INSULATION, SUPPORTS, VALVES, ETC. EXISTING PIPING INDICATED OR REQUIRED TO REMAIN IN SERVICE OR IN PLACE SHALL BE CAPPED,
- PLUGGED OR OTHERWISE SEALED. NO EXISTING PIPING SHALL BE LEFT OPEN ENDED. . EXISTING DUCTWORK INDICATED TO BE DISCONNECTED AND REMOVED SHALL INCLUDE RELOCATED AIR DEVICES, DUCT INSULATION, HANGERS, SUPPORTS, ETC. DUCTWORK SHALL BE CAPPED WITH SIMILAR GAGE SHEET METAL. SECURE CAP(S) WITH SHEET METAL SCREWS AND SEAL WITH DUCT SEALER, NO EXISTING DUCTWORK SHALL BE LEFT UNCAPPED. IF CAPPING INSULATED DUCTS, CAP SHALL BE SIMILARLY
- INSULATED TO MATCH EXISTING INSULATION MATERIALS AND THICKNESS. 10. PATCH TO MATCH ALL NEW AND EXISTING OPENINGS IN WALLS, CEILINGS, AND FLOOR SURFACES DAMAGED OR CREATED BY DEMOLITION WORK. PATCHING SHALL MATCH EXISTING ADJACENT SURFACES AS TO THICKNESS, TEXTURES, MATERIALS, AND COLOR. ALL PATCHING SHALL BE PERFORMED TO THE SATISFACTION OF THE ARCHITECT AND AT NO ADDITIONAL CONTRACT COST.

AS-BUILT / REVISION

CONTRACT COMPLETION BOX

BUREAU OF ENGINEERING
AND CONSTRUCTION

REVIEWED BY:

DATE REVIEWED:

- 11. ALL DEMOLISHED EQUIPMENT SHALL BE OFFERED TO THE OWNER PRIOR TO DISPOSAL. EQUIPMENT RETAINED BY THE OWNER SHALL BE STORED WHERE DIRECTED BY THE OWNER. ANY EQUIPMENT THE OWNER DOES NOT WISH TO RETAIN SHALL BE DISPOSED OF, OFF SITE, BY THE CONTRACTOR.
- 12. ALL ABANDONED DUCTWORK, PLUMBING PIPING, MECHANICAL SYSTEMS PIPING, AND ATC CONTROL WIRING LOCATED IN PLENUM CEILING SPACES SHALL BE REMOVED.

PROFESSIONAL CERTIFICATION HEREBY CERTIFY THAT THESE DOCUMENTS WERE PREPARED

R APPROVED BY ME, AND THAT I AM A DULY LICENSED

AS-BUILT PER RECORD PRINT

ROFESSIONAL ENGINEER UNDER THE LAWS OF THE STATE OF

PIRATION DATE 01/11/2026

DWN BY:

CHKD BY: JDM

	MECHANICAL/ P	LUMBING	LEGEND
ABBREVIATION	DESCRIPTION	ABBREVIATION	DESCRIPTION
A/C	AIR CONDITIONING	FFE	FINISHED FLOOR ELEVATION
ADJ.	ADJUSTABLE	FLR.	FLOOR
ALT.	ALTERNATE	GPH	GALLONS PER HOUR
AFF	ABOVE FINISHED FLOOR	GPM	GALLONS PER MINUTE
AFG	ABOVE FINISHED GRADE	HP	HORSE POWER
APD	AIR PRESSURE DROP	LBS/HR	POUNDS PER HOUR
AHU	AIR HANDLING UNIT	LAT	LEAVING AIR TEMPERATURE
ACU	AIR CONDITIONING UNIT	MFGR.	MANUFACTURER
BAS	BUILDING AUTOMATION SYSTEM	MBH	ONE THOUSAND BTU PER HOUR
BFF	BELOW FINISHED FLOOR	MAX.	MAXIMUM
BFG	BELOW FINISHED GRADE	MIN.	MINIMUM
BLDG.	BUILDING	NIC	NOT IN CONTRACT
BS	BIRD SCREEN	NTS	NOT TO SCALE
CONT.	CONTINUATION	OA	OUTSIDE AIR
CU	CONDENSING UNIT	PSIG	POUNDS PER SQUARE INCH GAUGE
CONN.	CONNECTION	RA	RETURN AIR
CFH	CUBIC FEET PER HOUR	RAG	RETURN AIR GRILLE
CLG.	CEILING	RAR	RETURN AIR REGISTER
DTL.	DETAIL	RM.	ROOM
DB	DRY BULB	RX.	REMOVE EXISTING
DWG.	DRAWING	SA	SUPPLY AIR
DN.	DOWN	SAD	SUPPLY AIR DIFFUSER
ESP	EXTERNAL STATIC PRESSURE	SHT.	SHEET
EAT	ENTERING AIR TEMPERATURE	SPEC.	SPECIFICATIONS
EX.	EXISTING	TYP.	TYPICAL
EXTR.	EXISTING TO REMAIN	V/ Ø/HZ	VOLTS/PHASE/HERTZ
EMER.	EMERGENCY	VERT.	VERTICAL
ELEV.	ELEVATION	W/	WITH
FOLL	EANL COTL LINITE	14/0	WET BUILD

WB

WET BULB

FCU | FAN COIL UNIT

BY DATE P.W.A. NO. KEY SHEET POSITION SHT DRAWING SCALE

R.O.W NO.

TRAFFIC HIGHWAYS STRUCTURES STORM DRAINS SEWER

41NE2

PLAN SCALE:

PROFILE SCALE

WATER

<u>12" = 1'-0"</u>

FIELD ENGINE

APPROVED BY

GENERAL MECHANICAL PROJECT NOTES

- TEMPORARILY REMOVE EXISTING LAY-IN TILE CEILING SYSTEMS INCLUDING ALL GUY WIRE SUPPORTS AND ASSOCIATED SUSPENSION SYSTEMS WHERE REQUIRED TO COMPLETE WORK. LAY-IN TILE CEILING SYSTEMS SHALL THEN BE RE-INSTALLED AFTER NEW/DEMOLITION WORK. THE COST OF REPLACING/REPAIRING ANY DAMAGE TO THE EXISTING LAY-IN TILE CEILING SYSTEM SHALL BE INCURRED BY THE CONTRACTOR.
- CAREFULLY REMOVE PLASTER TYPE CEILINGS AS REQUIRED TO FACILITATE THE INSTALLATION/REMOVAL OF ALL EXISTING/NEW DUCTWORK AND ALL EXISTING/NEW PIPING SYSTEMS AND ASSOCIATED APPURTENANCES. NEW PLASTER TYPE CEILINGS SHALL BE INSTALLED TO REPLACE EXISTING REMOVED PORTIONS WHERE INDICATED AND REQUIRED.
- ALL TEMPORARY UTILITY OUTAGES OF ANY TYPE SHALL BE COORDINATED WITH THE USER. PROVIDE TWO WEEKS ADVANCE NOTIFICATION PRIOR TO PERFORMING ANY TEMPORARY OUTAGES.
- ALL DUCTWORK SIZES SHOWN ARE INSIDE CLEAR DIMENSIONS.
- PROVIDE ACCESS DOORS (SIZE AS SPECIFIED) IN DUCTWORK FOR EVERY FIRE DAMPER, FIRE/SMOKE DAMPER, ETC. WHETHER SHOWN OR NOT. COORDINATE ACCESS TO VOLUME DAMPERS.
- COORDINATE THE LOCATION OF ALL AIR DEVICES WITH LIGHT FIXTURES AND THE ARCHITECT'S REFLECTED CEILING PLANS, AND DOCUMENTS.
- COORDINATE THE INSTALLATION OF LIGHTING FIXTURES WITH PIPING, DUCTWORK, AIR DEVICES, SPRINKLERS, AND EQUIPMENT BEING INSTALLED IN THE FACILITY SUCH THAT PIPING, DUCTWORK, AIR DEVICES, AND EQUIPMENT DO NOT BLOCK OR IMPEDE LIGHTING.
- 8. INSTALL DUCTWORK SO THAT VOLUME DAMPERS, V.V.T. / VAV BOX CONTROL PANELS, FANS, DUCT COILS, ETC., ARE ACCESSIBLE. PROVIDE ACCESS PANELS PER SPECIFICATION REQUIREMENTS.
-). REFER TO ARCHITECTURAL DRAWINGS FOR ROOF AND CEILING CONSTRUCTION TYPES AND DETAILS. REFER TO STRUCTURAL DRAWINGS FOR STEEL SIZES AND LOCATIONS.
- 10. LOCATE ALL EQUIPMENT WHICH MUST BE SERVICED, OPERATED, AND MAINTAINED IN A FULLY ACCESSIBLE POSITION. EQUIPMENT SHALL INCLUDE, BUT NOT BE LIMITED TO VALVES, TRAPS, MOTORS, CONTROLLERS, DRAIN POINTS, ETC. IF REQUIRED FOR ACCESSIBILITY, FURNISH ACCESS DOORS FOR THIS PURPOSE. COORDINATE LOCATION OF ACCESS DOORS WITH ARCHITECT. MINOR DEVIATIONS FROM DRAWINGS MAY BE MADE TO ALLOW FOR BETTER ACCESSIBILITY.
- 11. COORDINATE MOUNTING HEIGHTS AND LOCATIONS OF THERMOSTATS AND HUMIDISTATS SERVING EOUIPMENT WITH THE OWNER(S) AND/OR ARCHITECT.
- 12. FIRE STOP ALL PIPING AND DUCT PENETRATIONS THRU FIRE WALLS, PARTITIONS, AND FLOORS. PROVIDE LISTED FIRE DAMPERS IN ALL DUCTS THAT PASS THROUGH FIRE BARRIERS AND PARTITIONS. REFER TO ARCHITECTURAL DRAWINGS FOR FIRE RATED WALL, FLOOR, PARTITION AND BARRIER LOCATIONS.
- 13. REPLACE FILTERS SERVING AIR HANDLING UNIT EQUIPMENT PRIOR TO FINAL BALANCING OF AIR DISTRIBUTION SYSTEMS.
- 14. PROVIDE FLEXIBLE DUCT CONNECTIONS AT ALL DUCTED ROOFTOP TOP UNITS, AIR HANDLING UNITS, FAN COIL UNITS, AND EXHAUST FAN INLET AND OUTLET CONNECTIONS. REFER TO SPECIFICATIONS FOR ADDITIONAL REQUIREMENTS.
- 15. PROVIDE WEATHER TIGHT WALL AND ROOF DUCT AND PIPING PENETRATIONS. ALL SEALING MATERIALS TO BE APPROVED BY ARCHITECT.
- 16. ROUTE DOMESTIC WATER PIPING, SPRINKLER PIPING, HVAC PIPING, GAS PIPING, ETC., IN PIPE CHASES, IN FURRED OUT WALLS AND ABOVE CEILINGS, NO PIPING SHALL BE EXPOSED UNLESS APPROVED BY THE ARCHITECT OR OWNER(S).
- 17. PROVIDE A BALANCING DAMPER ON ALL BRANCH DUCTS SERVING SUPPLY AIR DEVICES AND RETURN AIR DEVICES WHETHER SHOWN ON PLANS OR NOT.
- 18. EXISTING CONDITIONS (DUCTWORK, PIPING, EQUIPMENT, AND MATERIAL(S) INDICATED ON THE CONTRACT DOCUMENTS ARE NOT WARRANTED TO REPRESENT ALL EXISTING AS-BUILT CONDITIONS. FIELD VERIFY EXACT LOCATIONS OF ALL DUCTWORK, PIPING, EQUIPMENT, AND MATERIALS IN THE FIELD PRIOR TO COMMENCING WITH NEW AND DEMOLITION WORK. EXISTING DUCT, PIPE, AND EQUIPMENT SIZES ARE NOT WARRANTED TO BE COMPLETELY CORRECT. FIELD VERIFY ALL EXISTING CONDITIONS PRIOR TO ORDERING MATERIALS AND INSTALLING NEW WORK.
- 19. THE DRAWINGS ARE DIAGRAMMATIC AND DO NOT INDICATE EVERY COMPONENT AND/OR ACCESSORY REQUIRED FOR A COMPLETE INSTALLATION. PROVIDE NECESSARY AND REQUIRED COMPONENTS AND ACCESSORIES TO ENSURE THAT THE ENTIRE SYSTEM IS FUNCTIONAL AND IN COMPLIANCE WITH APPLICABLE CODES, ACCEPTED INDUSTRY STANDARDS, AND MANUFACTURER'S INSTALLATION REQUIREMENTS/RECOMMENDATIONS UPON COMPLETION OF WORK.
- 20. ALL DUCTWORK AND PIPING SHALL RUN AS HIGH AS POSSIBLE AND ABOVE FINISHED CEILINGS UNLESS OTHERWISE NOTED.
- 21. ALL OUTSIDE AIR LOUVERS (INTAKE, EXHAUST, OR RELIEF) SHALL BE FITTED WITH 1/2" MESH BIRD SCREENS MOUNTED BEHIND LOUVERS. ALL UNUSED PORTIONS OF OUTSIDE AIR LOUVERS (INTAKE, EXHAUST, OR RELIEF) SHALL BE BLANKED OFF AIRTIGHT WITH 22-GAUGE GALVANIZED SHEET METAL AND 2 INCH RIGID INSULATION. REFER TO SPECIFICATIONS FOR ADDITIONAL REQUIREMENTS.
- 22. INSTALL VALVES AND COIL ASSEMBLIES IN ACCESSIBLE LOCATIONS, PROVIDE ACCESS PANELS PER SPECIFICATIONS.
- 23. DO NOT RELEASE ANY CFC OR HCFC BASED REFRIGERANT INTO THE ATMOSPHERE DURING INSTALLATION, START-UP, OR SERVICING OF NEW OR EXISTING HVAC EQUIPMENT EITHER DIRECTLY OR INDIRECTLY. UTILIZE AN APPROPRIATE REFRIGERANT PURIFICATION/RECLAMATION SYSTEM THAT IS CAPABLE OF SEPARATION AND REMOVAL OF OIL AND RESIDUAL MOISTURE, AND DOT-APPROVED CONTAINMENT OF
- RECOVERED REFRIGERANT. 24. ALL REFRIGERANT RELIEF DEVICES OR FUSIBLE PLUGS ON ALL SYSTEMS HAVING A REFRIGERANT CHARGE OF 100 LBS. OR GREATER SHALL DISCHARGE TO THE OUTSIDE OF THE BUILDING IN ACCORDANCE WITH
- APPLICABLE CODES. REFER TO SPECIFICATIONS FOR ADDITIONAL REQUIREMENTS. 25. ALL REFRIGERANT PIPING SHALL BE SIZED AND SUPPORTED/INSTALLED IN ACCORDANCE WITH APPLICABLE CODES. REFER TO SPECIFICATIONS FOR ADDITIONAL REQUIREMENTS.
- 26. REFRIGERANT PIPING INSTALLATION: REFRIGERANT PIPING LOCATED IN CONCEALED LOCATIONS WHERE TUBING IS INSTALLED IN STUDS, JOISTS, RAFTERS, OR SIMILAR MEMBERS, AND LOCATED LESS THAN 1.5" FROM THE NEAREST EDGE OF THE MEMBER, SHALL BE CONTINUOUSLY PROTECTED BY SHIELD PLATES. PROTECTIVE STEEL SHIELD PLATES SHALL BE A MINIMUM OF 16 GAGE AND SHALL COVER THE AREA OF THE TUBING PLUS THE AREA EXTENDING NOT LESS THAN 2" BEYOND BOTH SIDES OF THE TUBE.
- 27. REFRIGERANT PIPE LOCATED IN AREAS OTHER THAN THE ROOM OR SPACE WHERE THE REFRIGERATING EQUIPMENT IS LOCATED SHALL BE IDENTIFIED. THE PIPE IDENTIFICATION SHALL BE LOCATED AT INTERVALS NOT EXCEEDING 20 FEET ON THE REFRIGERANT PIPING OR PIPE INSULATION. THE MINIMUM HEIGHT OF LETTERING OF THE IDENTIFICATION LABEL SHALL BE 1/2 INCH. THE IDENTIFICATION SHALL INDICATE THE REFRIGERANT DESIGNATION AND SAFETY GROUP CLASSIFICATION OF REFRIGERANT USED IN THE PIPING SYSTEM. FOR GROUP A2, A3, B2, AND B3 REFRIGERANTS, THE IDENTIFICATION SHALL ALSO INCLUDE THE FOLLOWING STATEMENT: "DANGER - RISK OF FIRE OR EXPLOSION. FLAMMABLE REFRIGERANT." FOR ANY GROUP B REFRIGERANT, THE IDENTIFICATION SHALL ALSO INCLUDE THE FOLLOWING STATEMENT: "DANGER - TOXIC REFRIGERANT."
- 28. PROVIDE REFRIGERANT STOP VALVES AT THE FOLLOWING LOCATIONS:
 - a. FOR SYSTEMS CONTAINING GREATER THAN 6LBS OF REFRIGERANT: SUCTION INLET OF EACH COMPRESSOR, COMPRESSOR UNIT OR CONDENSING UNIT. DISCHARGE OUTLET OF EACH COMPRESSOR, COMPRESSOR UNIT OR CONDENSING UNIT.

INLET AND OUTLET OF EACH CONDENSER WHEN MULTIPLE CONDENSERS.

OUTLET OF EACH LIQUID RECEIVER. b. FOR SYSTEMS CONTAINING >100 LBS OF REFRIGERANT, IN ADDITION TO THOSE ABOVE: EACH INLET OF EACH LIQUID RECEIVER.

MECHA	NICAL/	PLUMBING LEGEND
SYMBOL	ABBREVIATION	DESCRIPTION
	RX.	REMOVE EXISTING
	EX.	EXISTING
10x8		RECTANGULAR DUCT
2 10"∅		ROUND DUCT
		TURNING VANES
R		DUCT RISING UP
		DUCT DROPPING DOWN
\boxtimes	SA	SUPPLY AIR DUCT; UP, DOWN
		SUPPLY AIR DIFFUSER
	RA	RETURN AIR DUCT; UP, DOWN
		RETURN AIR REGISTER OR GRILLE
<u> </u>	MOD	MOTOR OPERATED DAMPER
	VD	VOLUME DAMPER
[UH	UNIT HEATER
T #		TEMPERATURE SENSOR - UNIT NO. CONTROLLED
\otimes		CONNECT TO EXISTING AT THIS POINT
\oslash		REMOVE EXISTING TO THIS POINT
φ	DIA.	DIAMETER
#	NO.	NUMBER
\$	CFM	CUBIC FEET PER MINUTE
<u>SYMBOL</u>	<u>DESCRIPTIO</u>	<u>NC</u>
A	<u>AIR DEVICE REFEREN</u> SIZE CFM	ICE SYMBOL

DRAWING NOTE REFERENCE SYMBOL

REVISION REFERENCE SYMBOL

226 West Market Street, York, Pennsylvania 17401 717-848-8627 voice 717-843-2449 fax 805 North Charles Street, Baltimore, Maryland 2120 410-625-4823 voice 410-625-4674 fax

SHEET DESIGNATION M001

 $\star\star\star\star\star$

25122 PO0

CONTRACT NUMBER

JOB ORDER NUMBER PROJ-10001187 SHEET 20 OF 60 DRAWING NUMBER

2025 - 2131 FILE NO.:

BALTIMORE COUNTY OFFICE OF BUDGET AND FINANCE - PROPERTY MANAGEMENT

MECHANICAL COVER SHEET


BCDC LOBBY RENOVATIONS

RENOVATION

720 BOSLEY AVENUE, TOWSON, MD 21204


SUBDIVISION: TOWSON

ELECTION DIST. NO.: 9C6

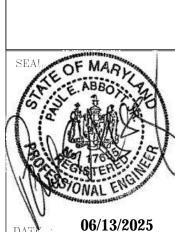

PROPERTY MANAGEMENT

PROPERTY MANAGER

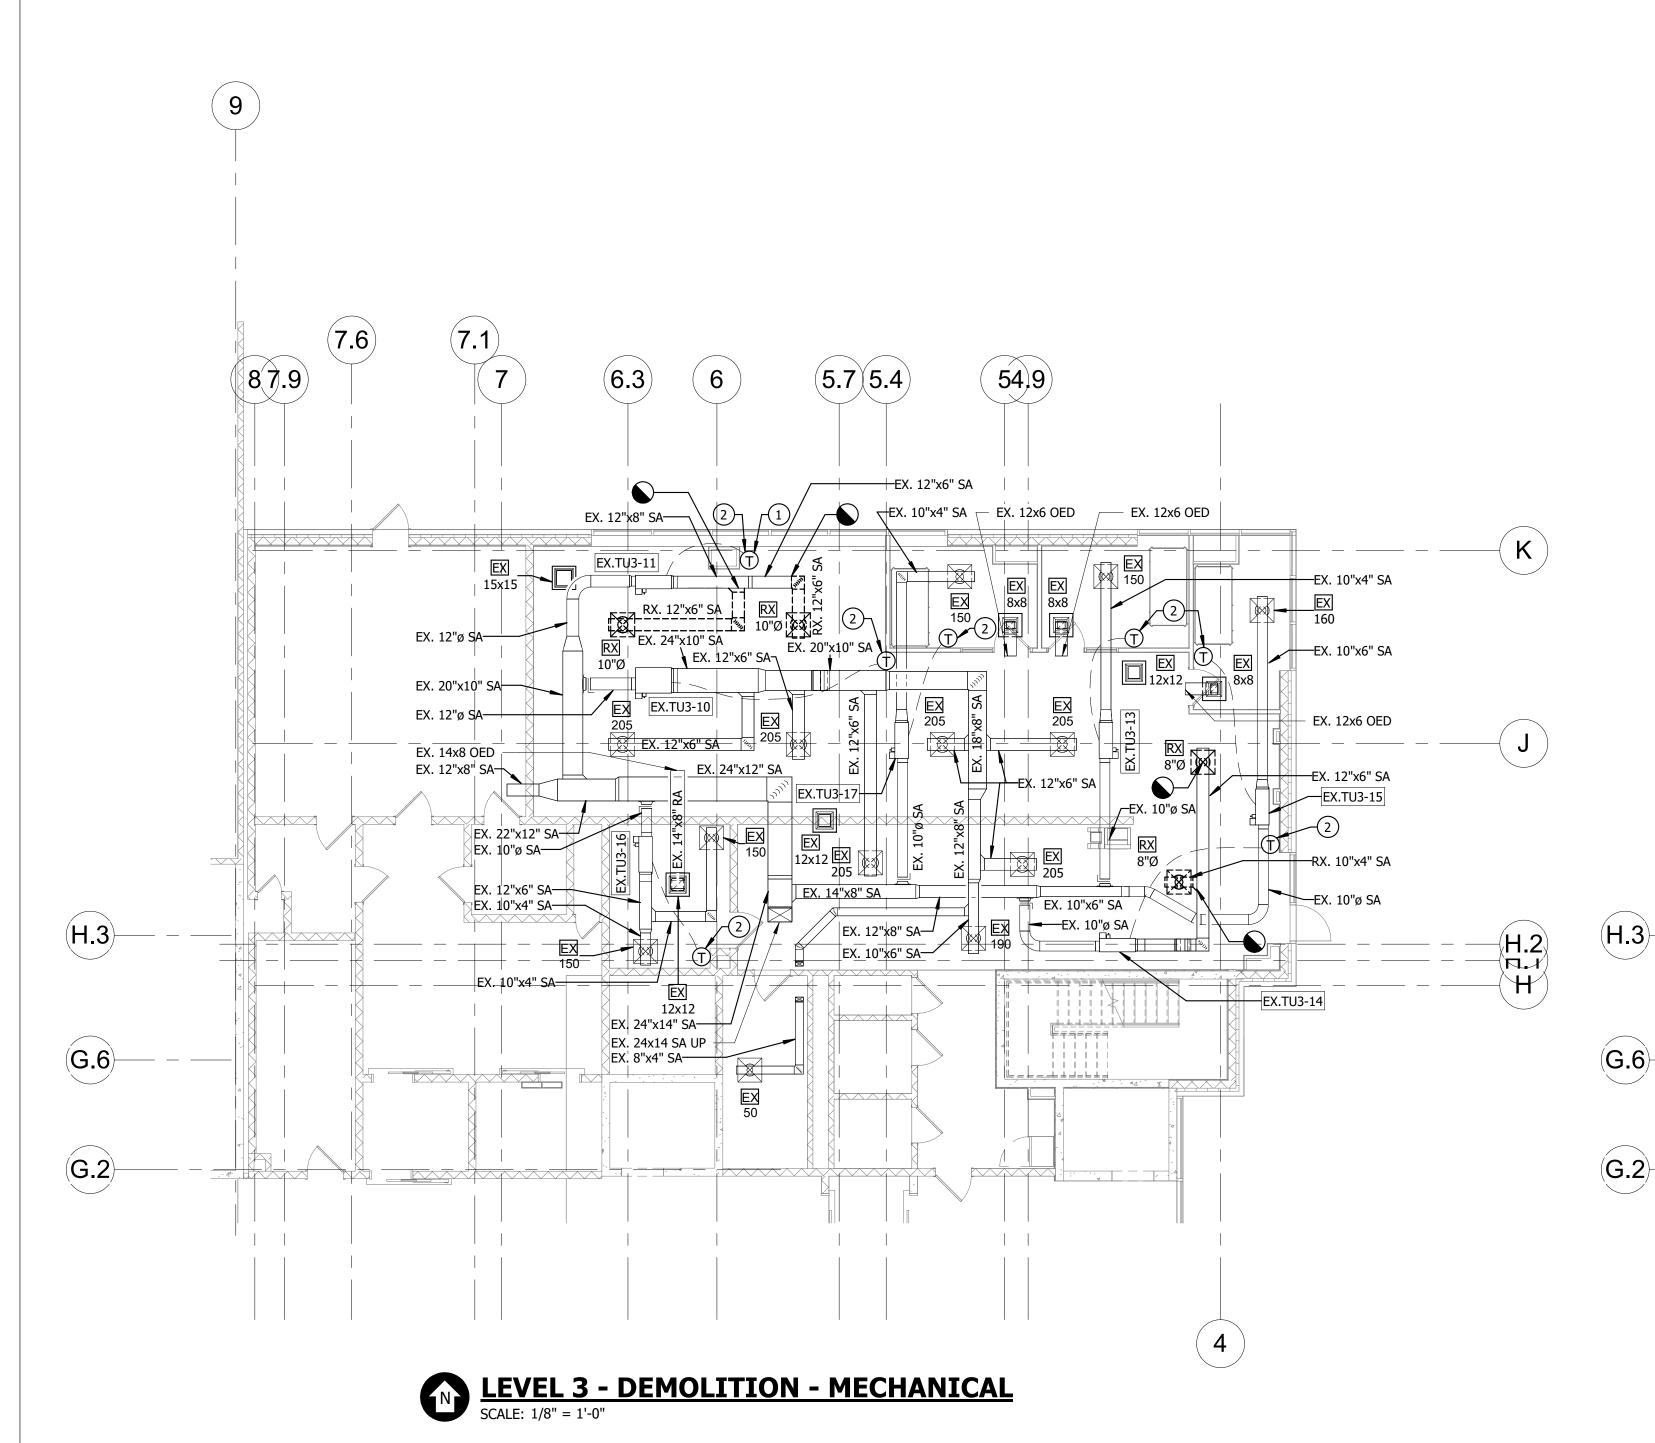

LEVEL 3 - NEW WORK - MECHANICAL

SCALE: 1/8" = 1'-0" **DRAWING NOTES:**

EX. 24"x14" SA———

EX. 12"x8" SA¬


EX. 14x8 OED

EX. 10"ø SA— EX.TU3-16 EX. 12"x6" SA-

EX. 10"x4" SA—

EX. 24"x10" SA

/——12"x6" SA

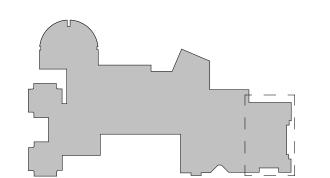

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H.2

KEY PLAN

S	EAL OF MARK	PROFESSIONAL CERTIFICA	ATION	AS-BUILT / REV	ISION	BY DATE	P.W.A. NO.	KEY SHEET	POSITION SHT	DRAWING	SCALE	PROPERTY	MANAGEMENT
	E ABBO	I HEREBY CERTIFY THAT THESE DOCUMENTS OR APPROVED BY ME, AND THAT I AM A DU						NNW	41NE2	PLAN SCALE:	As indicated	APPROVED BY:	
1	S A BANK 9	PROFESSIONAL ENGINEER UNDER THE LAWS					R.O.W NO.	_					PROPERTY MANAGER
TO SECOND		MARYLAND. LICENSE NO. 17655 , EXPIRATION	DATE 01/11/2026	CONTRACT COMPLETIO	N BOX					PROFILE SCALE:		DATE:	
1		ENGINEER:	DGN BY: GHT	BUREAU OF ENGINEERING AND CONSTRUCTION	TRAFFIC	HIGHWAYS	STRUCTURES	STORM DRAINS	SEWER	WATER	FIELD ENGINEER		
//	1007ONAL ENG	P. Edwin Abbott AS-BUILT PER RECORD PRINT	DWN BY: GHT	REVIEWED BY:									
D.	06/13/2025	BY: DATE:	CHKD BY: JDM	DATE REVIEWED:									

DISCONNECT EXISTING THERMOSTAT AND PREPARE FOR REINSTALLATION

VERIFY EXISTING THERMOSTAT CONTROL OF ASSOCIATED VAV BOX.

DRAWING NOTES:

UNDER NEW WORK.

BALTIMORE COUNTY OFFICE OF BUDGET AND FINANCE - PROPERTY MANAGEMENT

RELOCATED THERMOSTAT.

BCDC LOBBY RENOVATIONS

THIRD FLOOR PLAN - MECHANICAL - DEMOLITION AND NEW

RENOVATION

SUBDIVISION: TOWSON

720 BOSLEY AVENUE, TOWSON, MD 21204

ELECTION DIST. NO.: 9C6



PROJ-10001187 SHEET 21 OF 60 DRAWING NUMBER 2025 - 2132

DETAIL - TYPICAL DUCT HANGING SUPPORT

FLEXIBLE DUCT ELBOW SUPPORT. REFER TO A AND B FOR VARIATIONS. PROVIDE INSULATION ON DIFFUSER AND TAPE AIR TIGHT -STRUCTURE ABOVE —— SUSPEND FROM STRUCTURE WITH TIE — SIDE TAP - PROVIDE DRAW BAND RIGID DUCT, SPIN-IN ---6'-0" MAX. - FLEXIBLE DUCT LENGTH — FLEXIBLE DUCT - CEILING DIFFUSER **ELBOW SUPPORT** CEILING 1 X DIAMETER, 2. REFER TO ARCHITECTURAL DRAWINGS FOR CEILING TYPES. MINIMUM -NOTE: INSTALL FLEXIBLE DUCT ELBOW SUPPORTS AT ALL DIFFUSERS. CEILING DIFFUSER CONNECTION SCALE: NONE

NOTE: INSTALL FLEXIBLE DUCT ELBOW SUPPORTS AT ALL FLEXIBLE DUCT 90° BENDS.

HVAC DUCT OR

EQUIPMENT -

FLEXIBLE DUCT

ELBOW SUPPORT

SCALE: NONE

- ROUND SPIN-IN OR SQUARE TO

OR BOTTOM CONNECTION)

ROUND DUCT FITTING (SIDE, TOP,

— FLEXIBLE DUCT

PROVIDE DRAW BAND

1. REFER TO AIR DEVICE SCHEDULE FOR TYPE OF DISCHARGES.

AIR DEVICE SCHEDULE REFERENCE SYMBOL

ROUND SPIN-IN OR SQUARE TO

CEILING DIFFUSER, REFER TO

STZES OPPOSED BLADE DAMPER

FLOOR PLANS FOR LOCATIONS

AND AIR DEVICE SCHEDULE FOR

CUBIC FEET PER MINUTE OF AIR (CFM)

BOTTOM CONNECTION)

ROUND DUCT FITTING (SIDE, TOP

FLEXIBLE DUCT 6'-0" MAXIMUM LENGTH, USE

AS REQUIRED FOR DIFFUSER ALIGNMENT,

REFER TO AIR DEVICE SCHEDULE FOR SIZE

3. WHEN BRANCH DUCT LENGTHS EXCEED 6'-0", UTILIZE HARD DUCT, SAME SIZE AS FLEXIBLE DUCT OR AS INDICATED ON PLANS.

4. MAXIMUM FLEXIBLE DUCT SAG SHALL NOT EXCEED 1/2" PER LINEAR FOOT.

5. FLEXIBLE DUCT ELBOW SUPPORTS SHALL BE ATTACHED TO FLEXIBLE DUCTS UTILIZING MANUFACTURER RECOMMENDED DRAW BANDS.

DETAIL - TYPICAL CEILING DIFFUSER / FLEXIBLE DUCT CONNECTIONS SCALE: NONE

 \vdash 2" MIN. (THREE SIDES) \cdot DUCT WIDTH 4" LARGER THAN DUCT CONNECTION DUCTWORK PER FLOOR PLAN - DUCT SIZES PER AIR DEVICE NECK MANUAL VOLUME DAMPER WITH VOLUME DAMPER MEMORY STOP WITH MEMORY STOP DUCTWORK, SIZES PER FLOOR — AIR DEVICE AS SCHEDULED —

1. RETURN DUCT PERTINENT TO DUCTED RETURN SYSTEM(S) ONLY.

DETAIL - TYPICAL RETURN / EXHAUST AIR DUCT DEVICE CONNECTION

PROVIDE

INSULATION

ON DIFFUSER AND TAPE AIR TIGHT

B FLEXIBLE DUCT CONNECTION TO DUCT BRANCH

	AIR DEVICE SCHEDULE										
TYPE	DUTY	CFM F	RANGE	INLET NECK	54.05.0775	MAYNG	MAX PD	MAX NECK	BASI	Notes	
ТҮРЕ	DUTY	MIN	MAX	SIZE	FACE SIZE	MAX N.C.	(IN. WG)	VELOCITY (FPM)	MFGR.	MODEL	NOTES
А	SUPPLY	0	150	8"ø	24X24	15	0.04	400	TITUS	PAS	1,2,4
В	RETURN	0	220	8X8	24X24	14	0.09	500	TITUS	PAR	1,2,3

1: REFER TO SPECIFICATIONS FOR ADDITIONAL INFORMATION AND ACCESSORIES ASSOCIATED WITH AIR DEVICE.

2: REFER TO ARCHITECTURAL DRAWINGS FOR EXACT CEILING TYPES.

3: ALL RETURN, EXHAUST, TRANSFER, AND RELIEF GRILLES SHALL BE CENTERED IN THE CEILING TILE CLOSEST TO THE LOCATION INDICATED ON THE PLANS.

4: ALL SUPPLY AIR DIFFUSERS ARE 4-WAY BLOW UNLESS OTHERWISE NOTED.

805 North Charles Street, Baltimore, Maryland 21201 410-625-4823 voice 410-625-4674 fax 226 West Market Street, York, Pennsylvania 17401 717-848-8627 voice 717-843-2449 fax CONTRACT NUMBER SHEET DESIGNATION

M801

25122 PO0

JOB ORDER NUMBER PROJ-10001187 SHEET 22 OF 60 DRAWING NUMBER

2025 - 2133 FILE NO.:

													_
SEAL OF MARK	PROFESSIONAL CERTIFICA	AS-BUILT / REV	ISION	BY DATE	P.W.A. NO.	KEY SHEET	POSITION SHT	DRAWING	SCALE	PROPERTY MAN	NAGEMENT		
CAN E ABBOX 9	I HEREBY CERTIFY THAT THESE DOCUMENTS OR APPROVED BY ME. AND THAT I AM A DU					NNW	41NE2 PLAN SCAL		12" = 1'-0"	APPROVED BY:			
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IT'V MANY TH	MARYLAND. LICENSE NO. 17655 , EXPIRATION 1	DATE 01/11/2026	CONTRACT COMPLETION	N BOX					PROFILE SCALE:		DATE:		
The state of the s	ENGINEER:	DGN BY: GHT	BUREAU OF ENGINEERING AND CONSTRUCTION	TRAFFIC	HIGHWAYS	STRUCTURES	STORM DRAINS	SEWER	WATER	FIELD ENGINEER			
BOYONAL ENG	P. Edwin Abbott AS-BUILT PER RECORD PRINT	DWN BY: GHT	REVIEWED BY:										
DATE: 06/13/2025	BY: DATE:	CHKD BY: JDM	DATE REVIEWED:										5

BALTIMORE COUNTY OFFICE OF BUDGET AND FINANCE - PROPERTY MANAGEMENT

BCDC LOBBY RENOVATIONS

MECHANICAL DETAILS AND SCHEDULES

RENOVATION

720 BOSLEY AVENUE, TOWSON, MD 21204

ELECTION DIST. NO.: 9C6

SUBDIVISION: TOWSON

DESCRIPTION # DRAWING NOTE EXISTING OR FUTURE EQUIPMENT, AS NOTED THIN/SOLID EXISTING EQUIPMENT TO BE REMOVED, HEAVY/DASHED NEW EQUIPMENT, AS NOTED HEAVY/SOLID LIGHT FIXTURE, CAPITAL LETTER INDICATES FIXTURE TYPE, LOWER CASE INDICATES SWITCHING, NUMBER (WHERE SHOWN) INDICATES CIRCUIT SURFACE OR RECESSED MOUNTED LIGHT FIXTURE STRIP OR INDUSTRIAL FIXTURE, CEILING MOUNTED; WALL MOUNTED POLE MOUNTED LIGHT FIXTURE EMERGENCY OR NITE-LITE FIXTURE, AS NOTED DIRECT/ INDIRECT LIGHT FIXTURE JUNCTION BOX EXIT SIGN, CEILING OR WALL MOUNTED - DARKENED PORTION INDICATES THE FACE OF EXIT SIGN AND THE ARROW INDICATES DIRECTIONAL FACE									
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SWITCHING, NUMBER (WHERE SHOWN) INDICATES CIRCUIT SURFACE OR RECESSED MOUNTED LIGHT FIXTURE STRIP OR INDUSTRIAL FIXTURE, CEILING MOUNTED; WALL MOUNTED POLE MOUNTED LIGHT FIXTURE EMERGENCY OR NITE-LITE FIXTURE, AS NOTED DIRECT/ INDIRECT LIGHT FIXTURE JUNCTION BOX EXIT SIGN, CEILING OR WALL MOUNTED - DARKENED PORTION INDICATES THE FACE OF EXIT SIGN AND THE ARROW INDICATES DIRECTIONAL FACE									
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POLE MOUNTED LIGHT FIXTURE EMERGENCY OR NITE-LITE FIXTURE, AS NOTED DIRECT/ INDIRECT LIGHT FIXTURE JUNCTION BOX EXIT SIGN, CEILING OR WALL MOUNTED - DARKENED PORTION INDICATES THE FACE OF EXIT SIGN AND THE ARROW INDICATES DIRECTIONAL FACE									
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DIRECT/ INDIRECT LIGHT FIXTURE JUNCTION BOX EXIT SIGN, CEILING OR WALL MOUNTED - DARKENED PORTION INDICATES THE FACE OF EXIT SIGN AND THE ARROW INDICATES DIRECTIONAL FACE									
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EXIT SIGN AND THE ARROW INDICATES DIRECTIONAL FACE									
	F								
S _a , S ³ , S ⁴ 20 AMP SWITCH - LINE VOLTAGE, SINGLE POLE; 3-WAY; 4-WAY. SUBSCRIPT IDENTIFIE FIXTURE CONTROLLED	3								
DIGITAL WALL SWITCH OCCUPANCY SENSOR, DUAL TECHNOLOGY, 0-10V DIMMING, M.H. 48" AFF									
WIRD WALL SWITCH LINE VOLTAGE OCCUPANCY SENSOR, INFRARED, 0-10V DIMMING, M.H. 48" AFF									
NEMA 5-20R RECEPTACLE; M.H. 18"; M.H. COUNTERTOP OUTLET 6" ABOVE COUNTER HEIGHT TO BOTTOM OF OUTLET									
DOUBLE DUPLEX NEMA 5-20R RECEPTACLE. M.H. 18"									
GFI TYPE RECEPTACLE; GFI ONLY WHERE NOTED MAY BE PROTECTED BY UPSTREAM GIPROTECTION. MH 18" AFF	=I								
DISTRIBUTION PANELBOARD									
BRANCH CIRCUIT PANELBOARD; SURFACE MOUNTED, FLUSH MOUNTED									
, CB ENCLOSED CIRCUIT BREAKER									
SPD SURGE PROTECTIVE DEVICE; TYPE PER SPEC									
DISCONNECT SWITCH - 3P-30A UNLESS OTHERWISE NOTED; FUSED, NON-FUSED									
MAGNETIC MOTOR STARTER; COMBINATION STARTER/DISCONNECT									
CONDUIT AND WIRE OR CABLE ROUTED WITHIN WALLS OR CEILING SPACE OR ROUTE EXPOSED ON WALLS OR CEILINGS. CROSSLINES INDICATE THE NUMBER OF CONDUCTORS IF MORE THAN TWO (NOT INCLUDING GROUND))								
HOMERUN TO PANELBOARD. NUMBER OF ARROWS INDICATES THE NUMBER OF CIRCUITS									

	ELECTRICAL A	DDKEV	TAITONS
A	AMPERE	HWH	HOT WATER HEATER
AFF	ABOVE FINISHED FLOOR	IDC	INITIATING DEVICE CIRCUIT
AF	AMPERE FRAME	IMC	INTERMEDIATE METAL CONDUIT
AFG	ABOVE FINISHED GRADE	KV	KILOVOLTS
AIC	AMPS INTERRUPTING CURRENT	KVA	KILOVOLT-AMPERE
AT	AMPERE TRIP	KW	KILOWATT
ATS	AUTOMATIC TRANSFER SWITCH	MAX	MAXIMUM
AWG	AMERICAN WIRE GAUGE	MFG	MANUFACTURER
BLDG	BUILDING	MIN	MINIMUM
С	CONDUIT	MOD	MOTOR OPERATED DAMPER
CAT	CATEGORY	MTD	MOUNTED
СВ	CIRCUIT BREAKER	NAC	NOTIFICATION APPLIANCE CIRCUIT
CKT	CIRCUIT	No.	NUMBER
CLG	CEILING	N.C.	NORMALLY CLOSED
CONC	CONCRETE	N.O.	NORMALLY OPEN
CR	CONTROL RELAY	NFSS	NON-FUSED SAFETY SWITCH
DWG	DRAWING	Р	POLE
EF	EXHAUST FAN	PF	POWER FACTOR
EMERG	EMERGENCY	PNL	PANEL
EMR	ELEVATOR MACHINE ROOM	PR	PAIR
EMT	ELECTRICAL METALLIC TUBING	PVC	POLYVINYL CHLORIDE (SCHEDULE 4
ENCL	ENCLOSURE	PRI	PRIMARY
ETBR	EXISTING TO BE RELOCATED	REL	RELOCATED DEVICE
EWC	ELECTRIC WATER COOLER	Ø	PHASE
EX	EXISTING	QTY	QUANTITY
FAAP	FIRE ALARM ANNUNCIATOR PANEL	RGS	RIGID GALVANIZED STEEL
FACP	FIRE ALARM CONTROL PANEL	RM	ROOM
FLEX	FLEXIBLE	SW	SWITCH
FSS	FUSED SAFETY SWITCH	TEMP	TEMPERATURE
GA	GAUGE	TYP	TYPICAL
GEN	GENERATOR	UH	UNIT HEATER
GFI	GROUND FAULT INTERRUPTING	UTP	UNSHIELDED TWISTED PAIR
GFP	GROUND FAULT PROTECTION	V	VOLTS
GND	GROUND	VAC	VOLTS - ALTERNATING CURRENT
HOA	HAND-OFF-AUTOMATIC (SWITCH)	W	WIRE
HP	HORSEPOWER	WP	WEATHERPROOF
HTR	HEATER	XFMR	TRANSFORMER

GENERAL PROJECT DEMOLITION NOTES

- 1. INFORMATION SHOWN ON THIS DRAWING PERTAINING TO EXISTING CONDITIONS HAS BEEN OBTAINED FROM EXISTING DRAWINGS OR GENERAL FIELD OBSERVATIONS AND MAY NOT INDICATE ACTUAL EXISTING CONDITIONS IN DETAIL OR DIMENSION. CONTRACTOR IS RESPONSIBLE FOR DETERMINING THE ACTUAL CONDITIONS AND EFFECT ON HIS WORK PRIOR TO FABRICATION, ROUGHIN, MATERIAL ORDERS OR PERFORMANCE OF THE WORK. SHOULD CONDITIONS BE DISCOVERED THAT PREVENT EXECUTION OF THE WORK AS INDICATED, IMMEDIATELY NOTIFY THE ARCHITECT IN WRITING FOR DIRECTION BEFORE PROCEEDING WITH THE WORK.
- 2. REMOVE ALL EQUIPMENT INDICATED, INCLUSIVE OF ASSOCIATED CONDUIT, WIRING, BOXES, SUPPORTS, ETC. BACK TO SOURCE OR LAST REMAINING DEVICE ON SAME CIRCUIT, UNLESS NOTED OTHERWISE.
- 3. EXISTING CIRCUITS INTERRUPTED BY DEMOLITION OR RELOCATION WORK, BUT SERVING ITEMS INDICATED TO REMAIN, SHALL BE MADE CONTINUOUS.
- 4. DEMOLITION SHALL INCLUDE REMOVAL OF ELECTRICAL EQUIPMENT AND ASSOCIATED COMPONENTS AND MATERIALS. DO NOT ABANDON IN PLACE ANY ITEMS UNLESS NOTED ON THE DRAWINGS. EQUIPMENT REMOVED SHALL BE OFFERED TO THE OWNER PRIOR TO DISPOSAL, AND IF DESIRED, SHALL BE STORED ON SITE, WHERE INSTRUCTED. ALL MATERIALS NOT TO BE RETAINED BY OWNER SHALL BE REMOVED FOR OFF-SITE, LEGAL DISPOSAL
- 5. UNLESS NOTED OTHERWISE, ELECTRICAL ITEMS SHOWN HEAVY/DASHED (- - - -) SHALL BE REMOVED AND/OR RELOCATED. ELECTRICAL ITEMS SHOWN LIGHT/SOLID (______) ARE EXISTING TO REMAIN. ELECTRICAL ITEMS SHOWN HEAVY/SOLID (_____) REPRESENTS NEW WORK.
- 6. THE EXISTING FACILITY SHALL REMAIN IN OPERATION DURING CONSTRUCTION. ALL INTERRUPTIONS TO UTILITIES OR SERVICES MUST BE COORDINATED WITH THE OWNER OR USING AGENCY TO MINIMIZE DISRUPTIONS. PROVIDE NOTICE TO THE FACILITY AND OWNER 15 DAYS IN ADVANCE OF PLANNED OUTAGES.
- 7. REFER TO PROJECT PHASING DRAWINGS AND/OR REQUIREMENTS FOR COORDINATION OFALL DEMOLITION WORK WITH OVERALL PROJECT PHASING.
- 8. WHENEVER THE BUILDING IS OCCUPIED DURING THE WORK, EXISTING FIRE ALARM AND LIFE SAFETY SYSTEMS SHALL BE KEPT IN OPERATION.
- 9. NOTIFY OWNER OF ANY DAMAGED OR NON-WORKING ITEMS PRIOR TO REMOVAL. ANY EQUIPMENT DAMAGED DURING REMOVAL AND/OR RELOCATION SHALL BE REPLACED AT THE CONTRACTOR'S EXPENSE WITH EQUIPMENT EQUAL TO EXISTING.
- 10. ANY OPENINGS LEFT IN CEILINGS/WALLS SHALL BE PATCHED AND FINISHED TO MATCH EXISTING ADJACENT SURFACES. WHERE DEVICES ARE REMOVED FROM CEILING TILES, PROVIDE REPLACEMENT TILE(S) TO MATCH EXISTING.
- 11. DISCONNECT AND REMOVE ALL ASSOCIATED ELECTRICAL CONNECTIONS FOR EXISTING HVAC AND PLUMBING EQUIPMENT BEING REMOVED, INCLUDING: CONDUIT, WIRING, OUTLETS, DISCONNECTING MEANS, STARTERS, SWITCHES, ETC. REFER TO MECHANICAL DRAWINGS FOR ADDITIONAL INFORMATION.

GENERAL PROJECT NOTES

- 1. DRAWINGS ARE DIAGRAMMATIC AND GENERALLY REPRESENTATIVE OF THE WORK REQUIRED. VERIFY ALL WORK ON SITE AND REPORT ANY CONFLICTS TO THE ENGINEER FOR REVIEW PRIOR TO PROCEEDING WITH WORK OR CHANGES.
- 2. REFER TO ARCHITECTURAL OR PHASING DRAWINGS FOR OVERALL PROJECT PHASING. PLAN AND COORDINATE THE WORK, AS REQUIRED.
- 3. PROVIDE NEW TYPED CIRCUIT DIRECTORIES FOR ALL NEW PANELBOARDS AND ANY EXISTING PANELS IN WHICH CIRCUITS WERE MODIFIED.
- 4. ALL PANELBOARD SCHEDULES ARE BASED ON COPPER CONDUCTORS. ALUMINUM CONDUCTORS ARE NOT PERMITTED.
- 5. ALL CONDUIT, BOXES, CABLE TRAY, ETC. SHALL GENERALLY BE INSTALLED A MINIMUM OF 12" ABOVE CEILINGS. COORDINATE WITH OTHER TRADES PRIOR TO INSTALLATION.
- 6. ALL CEILING MOUNTED DEVICES, INCLUDING FIRE STROBES, SMOKE DETECTORS, SPEAKERS, OCCUPANCY SENSORS, ETC.

DEVICES ARE VISIBLE TO OCCUPANTS AND NOT BLOCKED BY OTHER EQUIPMENT.

- SHALL BE CENTERED IN 2X2 CEILING TILES, OR IN HALF OF 2X4 TILES, AS APPLICABLE. 7. WHERE AREAS HAVE NO FINISHED CEILINGS, INSTALL FIRE STROBES, EXIT LIGHTS, OCCUPANCY SENSORS, ETC. AT A HEIGHT EQUAL TO THE BOTTOM OF THE GENERAL LIGHTING FIXTURES, OR DUCTWORK, AS APPLICABLE SO THAT SUCH
- 8. ALL PROJECT CONDUIT AND CABLING SHALL BE INSTALLED ABOVE FINISHED CEILINGS, WHERE POSSIBLE TO MINIMIZE VISIBILITY OF SUCH ITEMS IN AREAS WITH EXPOSED STRUCTURE. ALL CABLING INSTALLED IN EXPOSED STRUCTURE AREAS, SHALL BE IN EMT CONDUIT INSTALLED TIGHT TO DECK ABOVE, EXCEPT FOR SHORT FINAL CONNECTIONS TO FIRE ALARM DEVICES, LIGHT FIXTURES, ETC. MC CABLE SHALL BE PERMITTED WHERE INSTALLED ABOVE FINISHED CEILINGS OR CONCEALED IN PARTITION WALLS.
- 9. REFER TO ARCHITECTURAL DRAWINGS FOR CEILING TYPES, FINISHES, ETC. COORDINATE ALL LIGHT FIXTURE MOUNTING, FRAME KITS, ETC. AS REQUIRED.
- 10. MAKE MINOR ADJUSTMENTS TO LIGHT FIXTURE LOCATIONS AND/OR ELEVATIONS IN UTILITY ROOMS, TO COORDINATE WITH FINAL INSTALLED PIPING, CONDUITS, AND LARGE EQUIPMENT. DO NOT INSTALL LIGHTS ABOVE PIPING OR
- 11. ALL BRANCH CIRCUITS SHALL UTILIZE INDIVIDUAL NEUTRAL CONDUCTORS. SHARED NEUTRALS AND MULTI-WIRE CIRCUITS ARE NOT PERMITTED.
- 12. ALL BRANCH CIRCUITS AND FEEDERS SHALL INCLUDE AN EQUIPMENT GROUNDING CONDUCTOR. CONDUIT IS NOT PERMITTED AS THE SOLE GROUND PATH.
- 13. ALL EMERGENCY AND EGRESS LIGHTING FIXTURES SHALL BE CONNECTED TO LIFE SAFETY EMERGENCY SYSTEM BRANCH
- 14. PROVIDE ACCESS PANELS FOR ALL DUCT SMOKE DETECTORS, JUNCTION BOXES, AND OTHER EQUIPMENT REQUIRING
- ACCESS OR ADJUSTMENT, AND LOCATED ABOVE HARD CEILINGS OR BEHIND WALL PARTITIONS, IN CHASES, ETC. 15. UNLESS LARGER GAUGE IS INDICATED ON PANEL SCHEDULES, BRANCH CIRCUIT WIRING SHALL COMPENSATE FOR
- VOLTAGE DROP, AS FOLLOWS: a. 120V, 0-90LF: #12AWG 277V, 0-150LF: #12 AWG

SUBDIVISION: TOWSON

CIRCUITS AHEAD OF ALL SWITCHING, UNLESS INDICATED OTHERWISE.

- b. 120V, 91-140LF:#10 AWG 277V, 151-240LF: #10 AWG c. 120V, >140LF: #8 AWG 277V, >240LF:
- 20. UNLESS NOTED OTHERWISE, ALL WIRING & CONDUIT/CABLING SHOWN ON FLOOR PLANS IS FOR DIAGRAMMATIC PURPOSES ONLY. COORDINATE EXACT INSTALLATION REQUIREMENTS WITH FIELD CONDITIONS AND INSTALL PER SPECIFICATIONS.
- 21. MINIMUM INTERIOR RIGID CONDUIT SIZE SHALL BE ¾" UNLESS NOTED OTHERWISE.
- 22. MULTIPLE SWITCHES IN THE SAME LOCATION SHALL USE A SINGLE MULTI-GANG DEVICE BOX AND COVER PLATE.

SEAL	PROFESSIONAL CERTIFIC.	ATION	AS-BUILT / REV	ISION	BY DA	ATE	P.W.A. NO.	KEY SHEET	POSITION SHT	DRAWING	SCALE	PROPERTY MANAGEMENT	
OF MAR	I HEREBY CERTIFY THAT THESE DOCUMENTS OR APPROVED BY ME, AND THAT I AM A DU							NNW	41NE2	PLAN SCALE:	12" = 1'-0"	APPROVED BY:	
S. 4. 0	PROFESSIONAL ENGINEER UNDER THE LAWS						R.O.W NO.					PROPERTY MANAG	ΞR
0 2/25	MARYLAND. LICENSE NO. 51627, EXPIRATION	DATE 12/06/2026	CONTRACT COMPLETIO	N BOX						PROFILE SCALE:		DATE:	-
P. Company	ENGINEER:	DGN BY: DJT	BUREAU OF ENGINEERING AND CONSTRUCTION	TRAFFIC	HIGHWA	AYS	STRUCTURES	STORM DRAINS	SEWER	WATER I	FIELD ENGINEER		
51621C.		DWN BY: DJT	REVIEWED BY:										
DATE:6/12/25	BY: DATE:	CHKD BY: DJT	DATE REVIEWED:										

BALTIMORE COUNTY OFFICE OF BUDGET AND FINANCE - PROPERTY MANAGEMENT

BCDC LOBBY RENOVATIONS

ELECTRICAL COVER SHEET

RENOVATION

720 BOSLEY AVENUE, TOWSON, MD 21204

ELECTION DIST. NO.: 9C6

226 West Market Street, York, Pennsylvania 17401 717-848-8627 voice 717-843-2449 fax SHEET DESIGNATION CONTRACT NUMBER


> 25122 PO0 JOB ORDER NUMBER ****

805 North Charles Street, Baltimore, Maryland 21201 410-625-4823 voice 410-625-4674 fax

E001

PROJ-10001187 SHEET 23 OF 60 DRAWING NUMBER 2025 - 2134

FILE NO.:

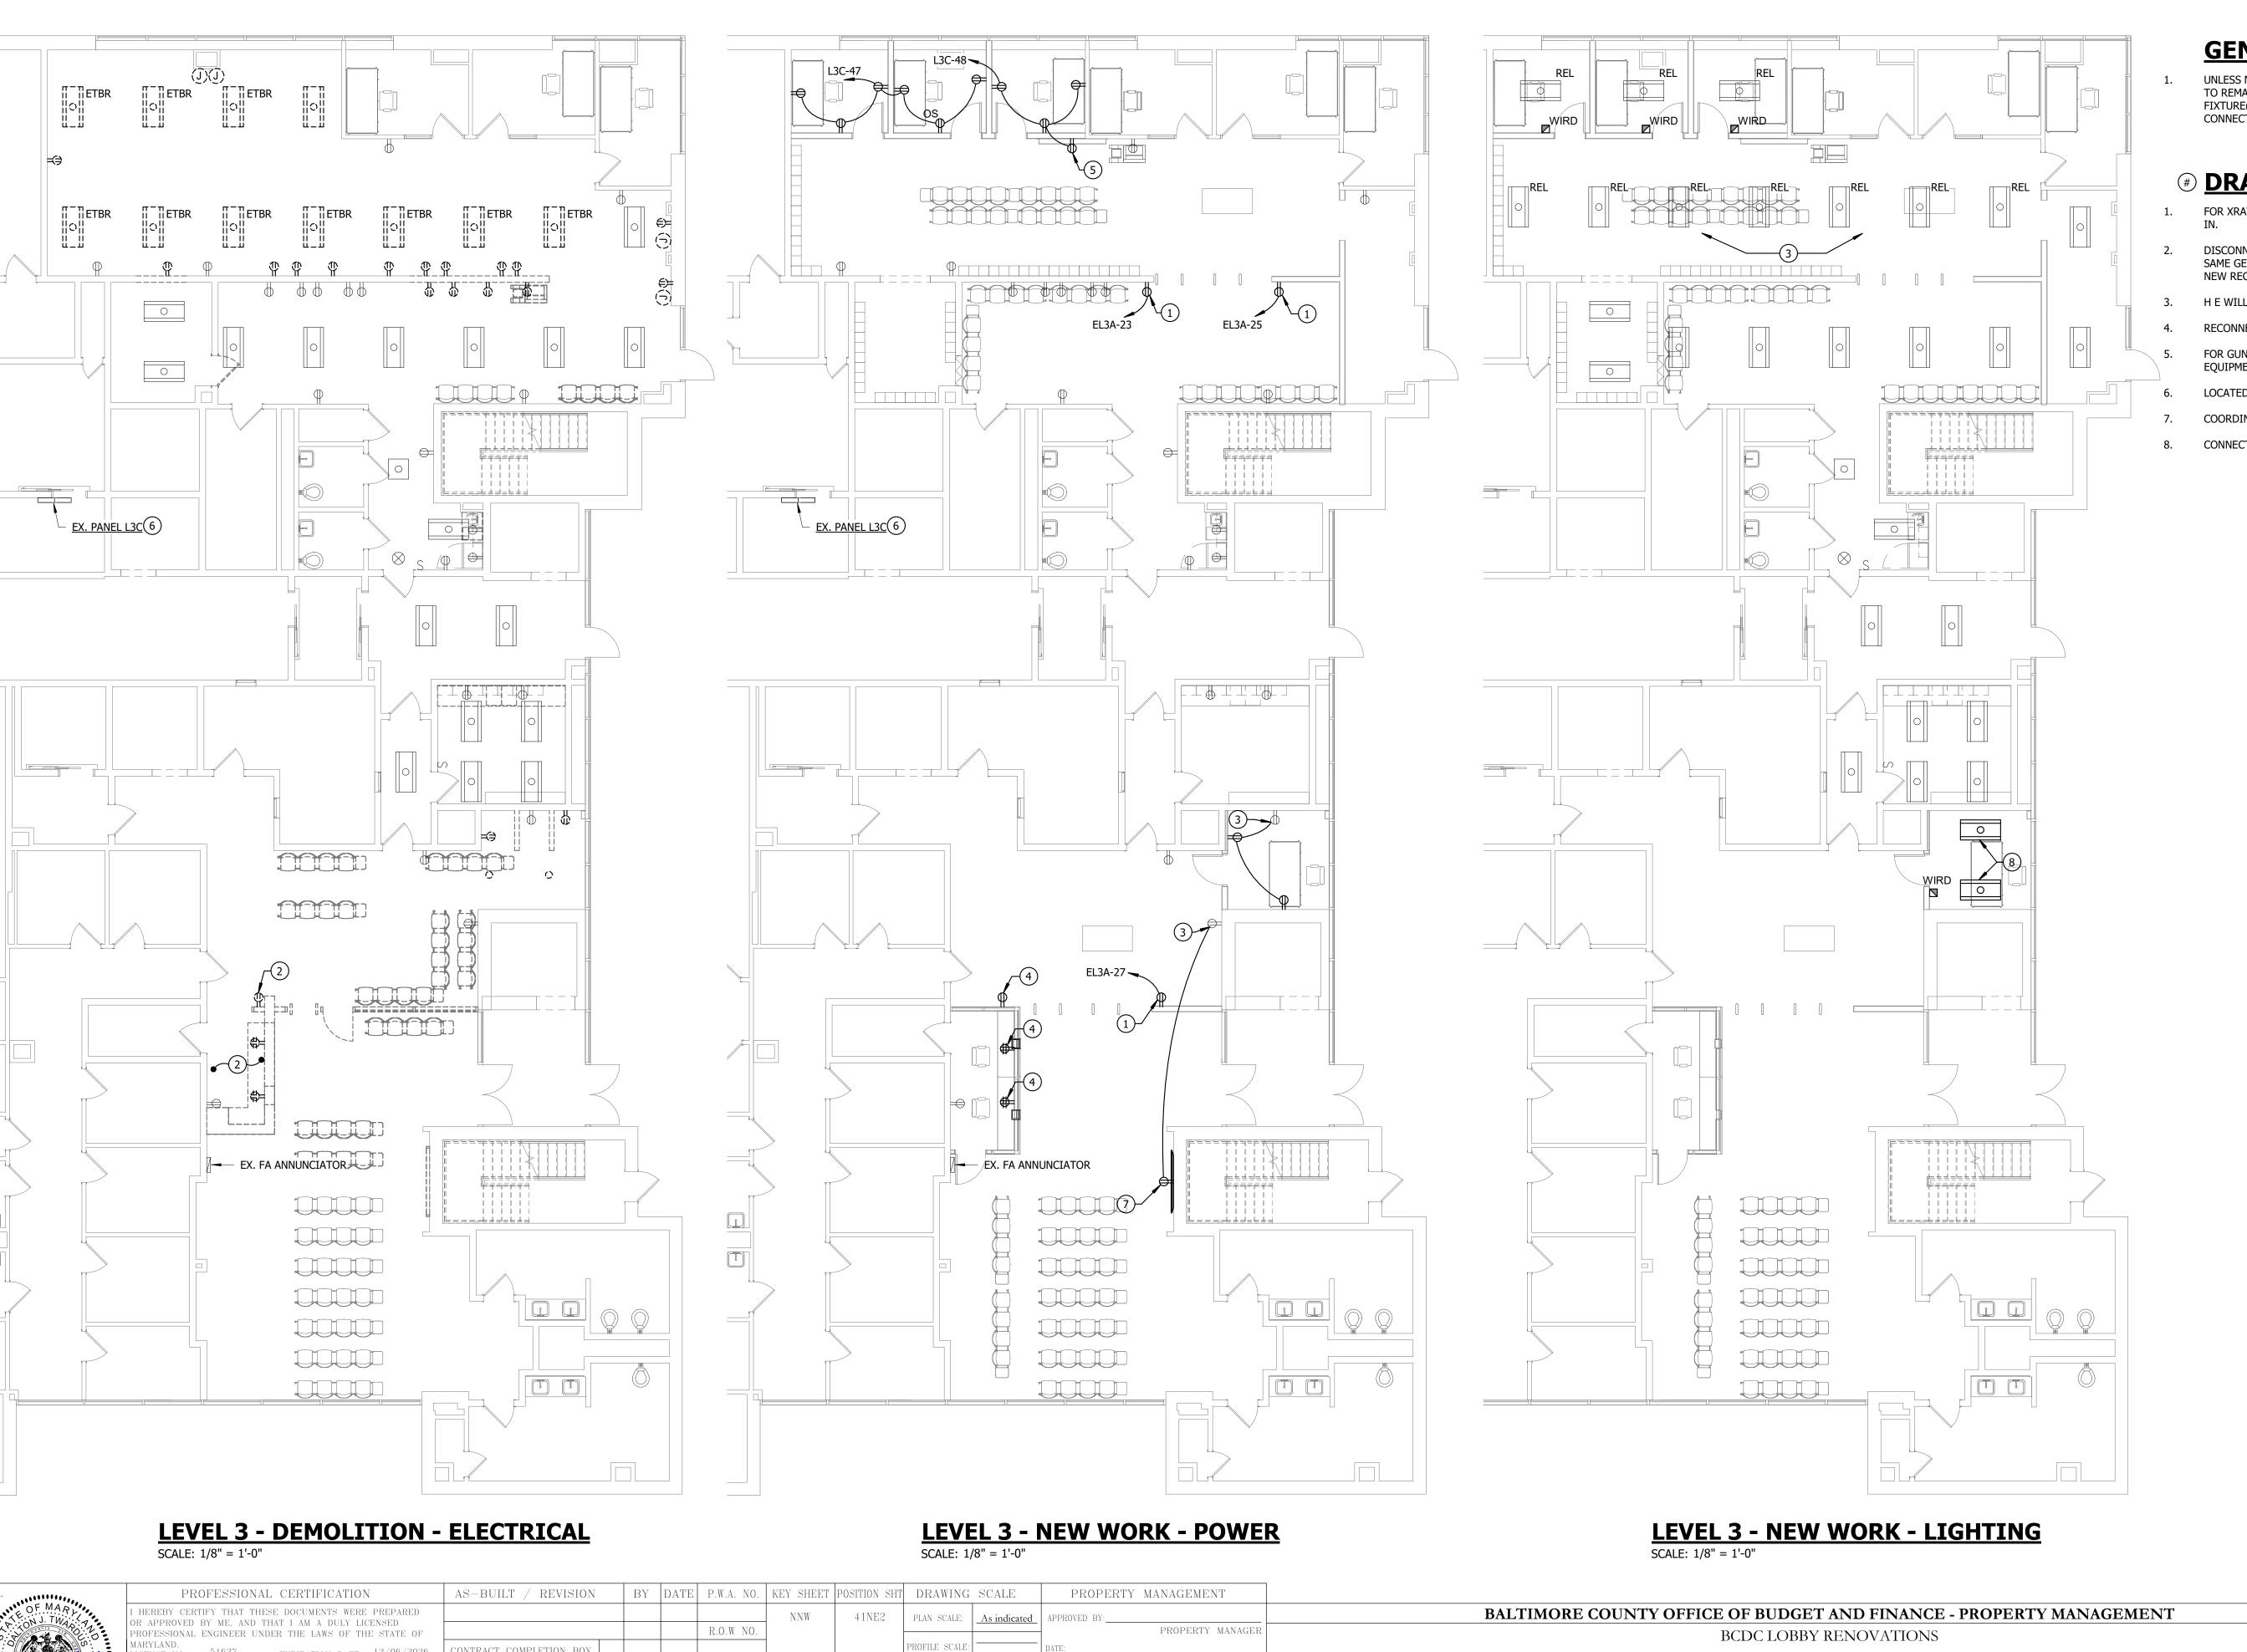

CONTRACT COMPLETION BOX

TRAFFIC

HIGHWAYS STRUCTURES STORM DRAINS

FIELD ENGINE

SUBDIVISION: TOWSON

WATER

SEWER

BUREAU OF ENGINEERING AND CONSTRUCTION

REVIEWED BY:

DATE REVIEWED:

CHKD BY: DJT


S-BUILT PER RECORD PRINT

GENERAL NOTES

UNLESS NOTED OTHERWISE, EXISTING LIGHTING CIRCUITRY(NORMAL POWER AND EMERGENCY) TO REMAIN. EXTEND CIRCUITS TO NEW AND/OR RELOCATED FIXTURES AS REQUIRED IF NEW FIXTURE(S) IS NOT IN SAME LOCATION. MODIFY EXISTING CIRCUITRY AS REQUIRED FOR CONNECTION OF NEW LIGHTING CONTROLS.

DRAWING NOTES

- FOR XRAY AND SCANNER MACHINE. COORDINATE FINAL LOCATION IN FIELD PRIOR TO ROUGH-
- DISCONNECT AND RETAIN EXISTING CIRCUITING FOR CONNECTION TO NEW RECEPTACLE IN SAME GENERAL LOCATION. MODIFY/EXTEND CIRCUITRY AS REQUIRED FOR CONNECTION TO NEW RECEPTACLE.
- H E WILLIAMS MODEL PT-24-L49/835-RA-(L40)-DIM-UNV, OR EQUAL.
- RECONNECT RELOCATED LIGHTING FIXTURES IN THIS AREA TO EXISTING CIRCUIT.
- FOR GUN LOCKERS. COORDINATE FINAL ROUGH-IN LOCATION AND CONNECTION WITH EQUIPMENT PRIOR TO ROUGH-IN.
- LOCATED IN ELEC ROOM MC365M ON LEVEL 3M ABOVE IN THIS GENERAL AREA.
- COORDINATE ROUGH-IN HEIGHT AND LOCATION WITH TA SERIES DRAWINGS.
- CONNECT TO EXISTING BRANCH CIRCUIT SERVING LIGHTING IN THIS AREA.

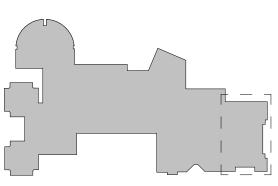

KEY PLAN

SHEET DESIGNATION

* * * *

CONTRACT NUMBER 25122 PO0

JOB ORDER NUMBER

PROJ-10001187 SHEET 24 OF 60

DRAWING NUMBER 2025 - 2135 FILE NO.:

BCDC LOBBY RENOVATIONS

THIRD FLOOR PLAN - ELECTRICAL - DEMOLITION AND NEW

RENOVATION

720 BOSLEY AVENUE, TOWSON, MD 21204

FIRE ALARM GENERAL DEMOLITION NOTES WHERE EXISTING WALL MOUNTED FIRE ALARM DEVICES ARE REMOVED, THE CONTRACTOR SHALL PROVIDE METAL COVER PLATES SIZED AS REQUIRED TO SUFFICIENTLY COVER THE AREA OF THE HOLE IN WHICH THE EXISTING DEVICE WAS LOCATED. THE COVER PLATE SHALL BE OF A MODERN DESIGN WITH ROUNDED EDGES AND MOUNTING SCREWS TO MATCH ADJACENT FINISH COLOR. THE PLATES SHALL BE APPROVED BY BCDC. 2. WHERE EXISTING DUCT SMOKE DETECTORS ARE REMOVED, THE EXISTING OPENINGS IN THE DUCTWORK SHALL BE PATCHED AND SEALED. 3. EXISTING WALLS OR FLOOR CEILINGS CUT OR DAMAGED DURING THE CONSTRUCTION PROCESS SHALL BE REPAIRED BACK. TO ITS ORIGINAL CONDITION. 4. EXISTING WALL, CEILING AND FLOOR PENETRATIONS SHALL BE FILLED WITH AN APPROVED MATERIAL FOR PENETRATIONS IN FIRE RATED WALLS, UL LISTED FIRE STOPPING SHALL BE PROVIDED. REFER TO THE PLAN FOR LOCATION OF FIRE RATED WALLS. 5. THE EXISTING FIRE ALARM SYSTEM SHALL REMAIN FULLY OPERATIONAL DURING THE COURSE OF THE CONSTRUCTION. 6. WHEN THE EXISTING FIRE ALARM SYSTEM IS OUT OF SERVICE FOR MORE THAN 4-HOURS IN A 24-HOUR PERIOD, AN APPROVED FIRE WATCH SHALL BE PROVIDED UNTIL THE SYSTEM IS RETURNED TO SERVICE. 7. NOTIFICATION TO AUTHORITIES/COORDINATION WITH FIRE MARSHAL:

- A. THE CONTRACTOR SHALL COORDINATE WITH THE LOCAL AUTHORITY HAVING JURISDICTION (AHJ) AND NOTIFY THE FIRE MARSHAL BEFORE ANY IMPAIRMENT, TESTING, OR SHUTDOWN OF THE FIRE ALARM SYSTEM.
- 8. TESTING AFTER MODIFICATIONS:
- A. ALL NEWLY INSTALLED OR MODIFIED PORTIONS OF THE FIRE ALARM SYSTEM SHALL BE FULLY TESTED IN ACCORDANCE WITH NFPA 72. TEST RESULTS SHALL BE DOCUMENTED AND SUBMITTED TO THE ENGINEER AND AHJ FOR APPROVAL.
- 9. LABELING AND DOCUMENTATION UPDATES:
- A. THE CONTRACTOR SHALL UPDATE ALL FIRE ALARM DRAWINGS, ZONE MAPS, AND PANEL LABELS TO REFLECT THE NEW SYSTEM CONFIGURATION UPON COMPLETION OF THE WORK.
- 10. TEMPORARY DETECTION OR COVERAGE (IF APPLICABLE):
- A. IF DEVICES MUST BE REMOVED BEFORE NEW DEVICES ARE INSTALLED, PROVIDE TEMPORARY SMOKE DETECTION COVERAGE IN AFFECTED AREAS AS REQUIRED TO MAINTAIN LIFE SAFETY.
- 11. DEVICE MOUNTING STANDARDS (FOR RE INSTALLATION OR REPLACEMENT):
- A. NEW OR RELOCATED DEVICES SHALL BE MOUNTED IN ACCORDANCE WITH ADA REQUIREMENTS AND NFPA 72 GUIDELINES FOR HEIGHT, SPACING, AND VISIBILITY.

FIRE ALARM GENERAL NOTES

- 1. INSTALLATION OF ALL WORK SHALL BE IN ACCORDANCE WITH THE FOLLOWING REGULATIONS, CODES, ETC.:
- A. LOCAL CODES AND ORDINANCES. B. PRACTICES AND PROCEDURES FOLLOWING OSHA STANDARDS.
- C. THE EDITION OF THE NATIONAL ELECTRICAL CODE NFPA 72 (NEC) IN EFFECT. D. THE EDITION OF THE INTERNATIONAL BUILDING CODE IN EFFECT.
- 2. BEFORE SUBMITTING BIDS, THE CONTRACTOR SHALL VISIT THE SITE AND EXAMINE ALL ADJOINING EXISTING BUILDINGS, EQUIPMENT, AND SPACE CONDITIONS ON WHICH HIS WORK IS IN ANY WAY DEPENDENT FOR THE BEST WORKMANSHIP AND OPERATION ACCORDING TO THE INTENT OF THE SPECIFICATIONS AND DRAWINGS. CONTRACTOR SHALL REPORT TO THE ARCHITECT/ENGINEER ANY CONDITION WHICH MIGHT PREVENT HIM FROM INSTALLING HIS EQUIPMENT IN THE MANNER SPECIFIED OR AS SHOWN IN CONTRACT DOCUMENTS TEN BUSINESS DAYS PRIOR TO SUBMISSION OF BIDS. NO CONSIDERATION OR ALLOWANCE WILL BE GRANTED FOR FAILURE TO VISIT THE SITE, NOR FOR ANY ALLEGED MISUNDERSTANDING OF MATERIALS TO BE FURNISHED OR WORK TO BE PERFORMED. THE CONTRACTOR SHALL INCLUDE IN HIS BID PRICE ALL LABOR AND MATERIAL THAT MAY AFFECT HIS WORK.
- 3. CONTRACTOR TO PROVIDE SUFFICIENT NOTICE TO THE OWNER'S REPRESENTATIVE PRIOR TO ANY WORK TO ALLOW ADEQUATE TIME FOR COORDINATION OF EXISTING BUILDING ACTIVITIES WITH THE CONSTRUCTION WORK.
- 4. CONTRACTOR TO INCLUDE IN THEIR SCOPE ALL LABOR, MATERIALS, SERVICES, APPARATUS AND SHOP DRAWINGS IN ADDITION TO THE CONTRACT DOCUMENTS AS REQUIRED TO COMPLY WITH ALL APPLICABLE GOVERNING LAWS, CODES AND JURISDICTION REQUIREMENTS, PROVIDE FIRE ALARM EQUIPMENT WITH ALL ASSOCIATED ACCESSORIES, BRANCH CIRCUIT WIRING AND CONDUIT INFRASTRUCTURE AS REQUIRED TO ENSURE A COMPLETE AND OPERATIONAL SYSTEM.
- 5. ALL MATERIALS AND WORK SHALL BE ACCORDING TO BASE BUILDING SPECIFICATIONS UNLESS OTHERWISE NOTED.
- 6. IF MATERIAL OR EQUIPMENT IS INSTALLED BEFORE IT IS APPROVED, THE CONTRACTOR SHALL BE LIABLE FOR ITS REMOVAL AND REPLACEMENT AT NO ADDITIONAL CHARGE OR IF IN THE OPINION OF THE ARCHITECT OR ENGINEER, THE MATERIAL OR EQUIPMENT DOES NOT MEET THE INTENT OF THE DRAWINGS AND SPECIFICATIONS.
- 7. ALL ADDRESSABLE CONTROL MODULES SHALL BE LOCATED WITHIN FEET OF THE DEVICES BEING CONTROLLED.
- 8. CONTRACTOR SHALL BE RESPONSIBLE TO PROVIDE ANY ADDITIONAL ACCESSORIES AND COMPONENTS INCLUDING BUT NOT LIMITED TO CABLES, CONDUITS, CONTROL AND RELAY MODULES CONTRACTOR TO INCLUDE AN ALLOWANCE IN THEIR BID DOCUMENT TO PROVIDE AN ADDITIONAL EXTENDER BOOSTER PANEL WITH ALL ASSOCIATED ACCESSORIES IF REQUIRED TO ENSURE A COMPLETE AND OPERATIONAL SYSTEM.
- 9. PROVIDE BOOSTER PANELS (NAC PANELS) AS REQUIRED BASED ON CONTRACTOR'S FINAL LOAD CALCULATIONS.
- 10. DUCT SMOKE DETECTORS SHALL BE POWERED FROM BOOSTER PANELS, NOT THE MAIN FIRE ALARM CONTROL PANEL.
- 11. BATTERIES FOR THE FIRE ALARM SYSTEM SHALL BE CALCULATED AT 60 HOURS STANDBY AND 15 MINUTES ALARM.
- 12. ELECTRICAL CIRCUITS FEEDING FIRE ALARM SYSTEM COMPONENTS SHALL BE DEDICATED TO THE FIRE ALARM AND IDENTIFIED AS SUCH WITH BREAKER HANDLE LOCKS.
- 13. JUNCTION BOXES AND COVERS SHALL BE RED IN COLOR.
- 14. WIRING FOR FIRE ALARM DEVICES SHALL BE 14 AWG THHN STRANDED IN 3/4 INCH CONDUIT MINIMUM. HORN CIRCUITS SHALL BE WEST PENN 60990BS (OR EQUAL) IN 3/4 INCH CONDUIT MINIMUM.
- 15. SURGE PROTECTION SHALL BE PROVIDED FOR THE FIRE ALARM SYSTEM. SURGE SUPPRESSION INC MODEL S-SPT 120-15 SHALL BE PROVIDED FOR THE A/C PROTECTION. SURGE SUPPRESSION INC MODEL CL24-2 OR S-CL 48-2 OR DITEK MODEL DTK-120SRD SHALL BE PROVIDED FOR SIGNAL CURRENT LOOP CIRCUIT PROTECTION.
- 16. THE FIRE ALARM SYSTEM SHALL HAVE ITS DEVICES LABELED SO THEY CAN BE IDENTIFIED BY ITS ID NUMBER THAT MATCHES THE PANEL VISIBLE FROM THE FLOOR. LABELS FOR DETECTORS SHALL BE INSTALLED ON THE BASE. NAC AND HORN DEVICES SHALL BE LABELED WITH CIRCUIT NUMBER AND PANEL NUMBER AND EOL.
- 17. THE FIRE ALARM ZONE DATA SHEETS SHALL BE FILLED OUT COMPLETELY BY THE CONTRACTOR AND TURNED OVER TO AACPS ELECTRICAL MAINTENANCE DEPARTMENT ELECTRONICALLY FIFTEEN DAYS PRIOR TO THIRD PARTY TESTING.
- 18. PRIOR TO REQUESTING AHJ ACCEPTANCE TESTING, THE CONTRACTOR SHALL PERFORM SYSTEM COMMISSIONING TESTING. THIS TESTING SHALL BE PERFORMED UNDER THE SUPERVISION OF A REGISTERED FIRE PROTECTION ENGINEER PROVIDED BY AACPS. THE FIRE ALARM SYSTEM SHALL HAVE EVERY (100%) INITIATING DEVICE TESTED FOR ACTIVATION OF THE AUDIO VISUAL DEVICES AS WELL AS SENDING A SIGNAL TO THE MONITORING COMPANY TO VERIFY CORRECT SIGNAL IDENTIFICATION FOR EACH DEVICE. A FUNCTIONAL TEST SHALL BE DONE ON ALL ASSOCIATED MONITORING AND RELAY MODULES TO INCLUDE BUT NOT LIMITED TO, SPRINKLER TAMPER AND FLOW SWITCHES, FAN INTERLOCKS, AND SMOKE DAMPER OPERATION.
- 19. NO INSTALLER OR PROGRAMMER INFORMATION SHALL BE INSTALLED ON ANY FIRE ALARM DEVICES OR PANELS.
- 20. ONE SPACE AGE BRAND OR EQUAL ELECTRONIC FIRE ALARM DOCUMENT BOX AND ONE DRAWING STORAGE BOX SHALL BE INSTALLED NEXT TO FACP.
- 21. ALL FIRE ALARM CONDUIT, CONNECTORS, AND COUPLINGS SHALL BE FACTORY PAINTED RED.

PROPERTY MANAGEMENT

- 22. CONDUITS INSTALLED OVER 10 FEET MEASURED FROM THE FINISHED FLOOR SHALL BE EMT AND COLOR SHALL MATCH FINISHED SURFACES.
- 23. CONDUITS INSTALLED LESS THAN 10 FEET MEASURED FROM THE FINISHED FLOOR SHALL BE PROVIDED WITH WIREMOLD SERIES 700 MINIMUM WITH 2-HOLE STRAPS OR APPROVED EQUAL.
- 24. CONDUITS INSTALLED IN FINISHED SPACES SHALL BE CONCEALED BEHIND WALLS OR ABOVE CEILINGS.
- A. TEST AND ADJUST EQUIPMENT AND SYSTEMS INSTALLED AND DEMONSTRATE PROPER OPERATION TO OWNER'S REPRESENTATIVE NO EQUIPMENT SHALL BE TESTED OR OPERATED FOR ANY PURPOSE UNTIL IT HAS BEEN FULLY PREPARED FOR OPERATION IN ACCORDANCE WITH MANUFACTURER'S INSTRUCTIONS.
- B. SHOW, BY DEMONSTRATION IN SERVICE, THAT ALL CIRCUITS AND DEVICES ARE IN GOOD OPERATING CONDITION. EACH PIECE OF EQUIPMENT AND COMPONENT OF THE FIRE ALARM SYSTEM SHALL FUNCTION NOT LESS THAN FIVE TIMES IN COURSE OF THE ACCEPTANCE TESTS.

FIRE ALARM SYMBOL LIST

(STANDARD SYMBOLS, ALL SYMBOLS MAY NOT APPEAR ON THE DRAWINGS)

 $\langle H \rangle / \langle H \rangle$ CEILING/WALL MOUNTED FIRE ALARM HEAT DETECTOR F WALL MOUNTED FIRE ALARM SYSTEM MANUAL PULL STATION AT 48" AFF

CEILING/WALL MOUNTED FIRE ALARM SMOKE DETECTOR, DEVICES MAY HAVE THE FOLLOWING SUBSCRIPTS: : DEVICE DEDICATED FOR ELEVATOR RECALL FUNCTION : BEAM SMOKE DETECTOR TRANSMITTER/RECEIVER : BEAM SMOKE DETECTOR REFLECTOR

CEILING/WALL MOUNTED FIRE ALARM COMBINATION AUDIO (HORN)/VISUAL DEVICE, ADA COMPLIANT NUMBER DENOTES CANDELA INTENSITY RATING, MINIMUM 15cd, MOUNTING HEIGHT FROM 80" UP TO A MAXIMUM OF 96"

CEILING/WALL MOUNTED FIRE ALARM VISUAL DEVICE (STROBE), ADA COMPLIANT NUMBER DENOTES CANDELA INTENSITY RATING, MINIMUM 15cd, MOUNTING HEIGHT FROM 80" UP TO A MAXIMUM OF 96" AFF

FIRE ALARM ANNUNCIATOR PANEL

FIRE ALARM TERMINAL CABINET

FIRE ALARM CONTROL PANEL

ABBREVIATIONS

(STANDARD ABBREVIATIONS, ALL ABBREVIATIONS MAY NOT APPEAR ON THE DRAWINGS)

A	AMPERE	KCMIL	THOUSANDS OF CIRCULAR MILS
ADA AF	AMERICANS WITH DISABILITIES ACT FUSE RATING IN AMPS	MISC	MISCELLANEOUS
AFF	ABOVE FINISHED FLOOR	IVIIOC	MIGGELLANLOGG
AHJ	AUTHORITY HAVING JURISDICTION	Ν	NEW
AL	ALUMINUM	NEC	NATIONAL ELECTRICAL CODE
ANSI	AMERICAN NATIONAL STANDARDS	NEMA	NATIONAL ELECTRICAL MANUFACTURERS
ASHRAE	INSTITUTE AMERICAN SOCIETY OF HEATING.	NFPA	ASSOCIATION NATIONAL FIRE PROTECTION ASSOCIATION
AOITIAL	REFRIGERATING AND AIR-CONDITIONING	NTS	NOT TO SCALE
	ENGINEERS		
AT	TRIP RATING IN AMPS	OSHA	OCCUPATIONAL SAFETY AND HEALTH
AWG	AMERICAN WIRE GAUGE		ADMINISTRATION
С	CONDUIT	Р	POLE
CB	CIRCUIT BREAKER	PH, Ø	PHASE
CU	COPPER	PNL	PANEL
D	EXISTING TO BE DEMOLISHED	R	RELOCATED AT NEW LOCATION
DIV.	DIVISION	RR	REMOVE AND RELOCATE
DWG	DRAWING		NEWS VE / INS NEES S/ IVE
		S/N	SOLID NEUTRAL
E, EX	EXISTING TO REMAIN	SPD SSD	SURGE PROTECTIVE DEVICE
EM EMT	DEVICE ON EMERGENCY CIRCUIT ELECTRICAL METALLIC TUBING	22D	SMOKE SAMPLING DETECTOR SMOKE SENSING DEVICE
LIVII	ELECTRICAL METALLIC TOBING		SWOKE SENSING BEVIOL
FAAP	FIRE ALARM ANNUNCIATOR PANEL	TYP.	TYPICAL
FACP	FIRE ALARM CONTROL PANEL		LINDED MOTERIA LABORATORIES
FASP FATC	FIRE ALARM SMOKE PURGE PANEL FIRE ALARM TERMINAL CABINET	UL UON	UNDERWRITER'S LABORATORIES UNLESS OTHERWISE NOTED
FSS	FUSIBLE SAFETY SWITCH	OON	ONLESS OTTENWISE NOTED
. 55		V	VOLTS
G	GROUND		
GFI GRS	GROUND FAULT INTERRUPTER GALVANIZED RESISTIVE CONDUIT	W WP	WATTS WEATHERPROOF
ans	GALVANIZED RESISTIVE CONDUIT	VVF	WEATHERFROOF
IBC	INTERNATIONAL BUILDING CODE		
IECC	INTERNATIONAL ENERGY CONSERVATION		
	CODE		

	FIRE ALARM DRAWING LIST								
	SHEET DRAWING TITLE								
ĺ	25	FA-001	GENERAL NOTES, SYMBOLS AND ABBREVIATIONS						
	26	FAD-100	LEVEL 3 FLOOR PLAN - FIRE ALARM DEMOLITION						
	27	FA-100	LEVEL 3 FLOOR PLAN - FIRE ALARM						
ĺ	28	FA-501	FIRE ALARM RISER DIAGRAM						
ĺ	29	FA-701	FIRE ALARM DETAILS						

145 W. OSTEND STREET, SUITE 537 BALTIMORE, MD 21230 P: 667-309-6036 www.**SETTY**com

ELECTION DIST. NO.: 9C6



SHEET DESIGNATION PROJECT NUMBER: SIPQ241913.03

FA-001

CONTRACT NUMBER 25122 PO0

JOB ORDER NUMBER PROJ-10001187 SHEET 25 OF 60 $\star\star\star\star\star$ DRAWING NUMBER

2025-2136

BALTIMORE COUNTY OFFICE OF BUDGET AND FINANCE - PROPERTY MANAGEMENT BCDC LOBBY RENOVATIONS

GENERAL NOTES, SYMBOLS AND ABBREVIATIONS

RENOVATION

SUBDIVISION: TOWSON

720 BOSLEY AVENUE, TOWSON, MD 21204

ORIGINAL DRAWING SIZE IS 24"x 36"; SCALE ENTITIES ACCORDINGLY IF REDUCED/ENLARGED

PROFESSIONAL CERTIFICATION


CHKD BY: SM

IEREBY CERTIFY THAT THESE DOCUMENTS WERE PREPARED 41NE2 PLAN SCALE: NTS APPROVED BY ME, AND THAT I AM A DULY LICENSED R.O.W NO. PROPERTY MANAGER DFESSIONAL ARCHITECT UNDER THE LAWS OF THE STATE OF PROFILE SCALE CONTRACT COMPLETION BOX BUREAU OF ENGINEERING AND CONSTRUCTION ENGINEER: TRAFFIC HIGHWAYS STRUCTURES STORM DRAINS SEWER FIELD ENGINE WATER SOMANNA MOODERA REVIEWED BY: S-BUILT PER RECORD PRINT

BY DATE P.W.A. NO. KEY SHEET POSITION SHI DRAWING SCALE

AS-BUILT / REVISION

DATE REVIEWED:

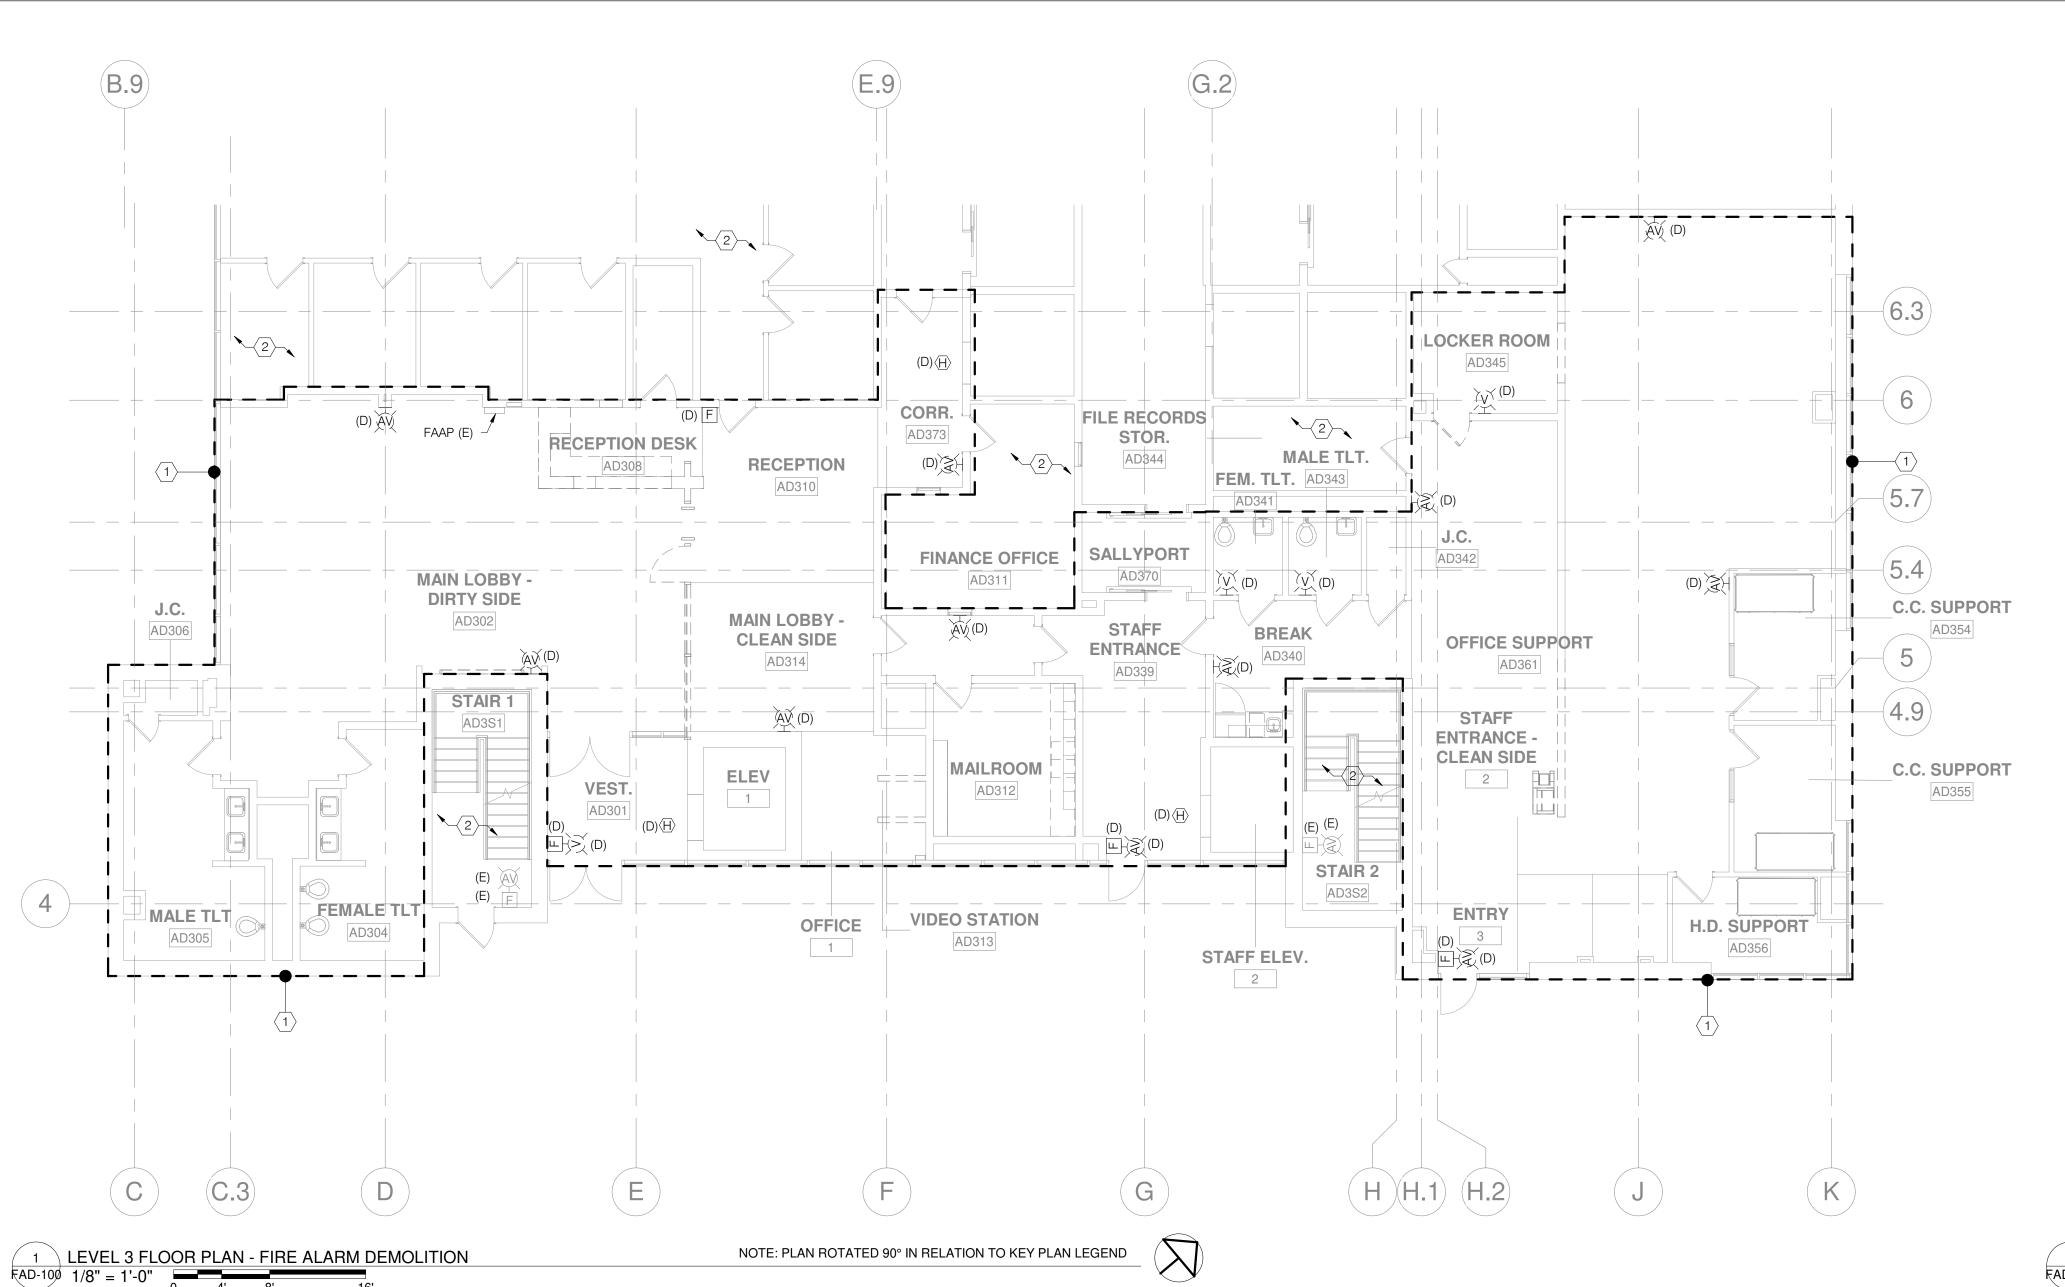

BY DATE P.W.A. NO. KEY SHEET POSITION SHT DRAWING SCALE

R.O.W NO.

TRAFFIC HIGHWAYS STRUCTURES STORM DRAINS SEWER

41NE2 PLAN SCALE: As indicated

PROFILE SCALE

WATER

FIELD ENGINEE

PROPERTY MANAGEMENT

PROPERTY MANAGER

SUBDIVISION: TOWSON

AS-BUILT / REVISION

CONTRACT COMPLETION BOX

BUREAU OF ENGINEERING AND CONSTRUCTION

REVIEWED BY:

DATE REVIEWED:

PROFESSIONAL CERTIFICATION

R APPROVED BY ME, AND THAT I AM A DULY LICENSED

SOMANNA MOODERA

AS-BUILT PER RECORD PRINT

HEREBY CERTIFY THAT THESE DOCUMENTS WERE PREPARED



- 1. REFER TO THE FIRE ALARM COVER SHEET DRAWING FOR GENERAL NOTES, LEGEND AND ABBREVIATIONS.
- 2. REFER TO MECHANICAL AND PLUMBING DEMOLITION DRAWINGS FOR ADDITIONAL EQUIPMENT TO BE DEMOLISHED.
- 3. COORDINATE WITH ARCHITECT TO CONFIRM EXTENT OF DEMOLITION ASSOCIATED WITH IT, AV, TELECOM, SECURITY AND MISCELLANEOUS LOW VOLTAGE SYSTEMS.
- 4. UNLESS OTHERWISE NOTED, DEMOLISH ALL EXISTING FIRE ALARM DEVICES AND EQUIPMENT SHOWN OR NOT SHOWN ON PLANS AT DEMOLISHED WALL, CEILING AND FLOOR SECTIONS THROUGHOUT THE AREA OF WORK. ABANDON CONCEALED EXISTING CONDUITS INSTALLED IN CONCRETE WALLS OR SLABS.
- 5. FOR ALL DEMOLISHED DEVICES, REMOVE ALL ASSOCIATED ACCESSORIES, BRANCH CIRCUIT WIRING AND CONDUIT BACK TO SOURCE OF SUPPLY.
- 6. COORDINATE WITH THE BUILDING ENGINEER TO VERIFY THE DEMOLISHED LIGHT FIXTURES, EXIT SIGNS, EQUIPMENT AND DEVICES WHICH ARE TO BE RETURNED TO BUILDING OWNER FOR STORAGE.
- 7. ALL EXISTING DEVICES TO REMAIN ARE TO BE PROTECTED FROM DAMAGE THROUGHOUT THE CONSTRUCTION PROCESS.
- 8. THE CONTINUITY OF EXISTING CIRCUITS SERVING EXISTING DEVICES AND EQUIPMENT TO REMAIN SHALL BE MAINTAINED.
- 9. UNLESS OTHERWISE NOTED, IN THE SCOPE OF WORK AREA, ALL FIRE ALARM DEVICES SHOWN WITH A DASHED LINE INDICATE EXISTING EQUIPMENT TO BE DEMOLISHED. DEVICES SHOWN WITH A CONTINUOUS LINE INDICATE EXISTING EQUIPMENT TO REMAIN.

SHEET KEY NOTES

- 1. UNLESS OTHERWISE NOTED, ALL FIRE ALARM DEVICES, INCLUDING ASSOCIATED ELECTRICAL COMPONENTS, CONDUITS, AND WIRING/BOXES SERVING THIS AREA, ARE TO BE DEMOLISHED. ALL FIRE ALARM DEVICES SHALL BE DEMOLISHED, ONLY AFTER NEW DEVICES ARE INSTALLED.
- 2. UNLESS OTHERWISE NOTED, ALL EXISTING FIRE ALARM DEVICES, INCLUDING ASSOCIATED CONDUITS, WIRING, AND BOXES SERVING THIS AREA, ARE TO REMAIN.


2 FIRST FLOOR MAIN ELECTRICAL ROOM - DEMOLITION - FOR REFERENCE ONLY

MAIN

ELECTRICAL

ROOM

AUDIO AMPLIFIER (E) —

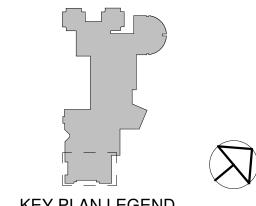

BALTIMORE, MD 21230 P: 667-309-6036 www.**SETTY**com

226 West Market Street, York, Pennsylvania 17401 717-848-8627 voice 717-843-2449 fax

SHEET DESIGNATION

CONTRACT NUMBER 25122 PO0

2025-2137

FAD-100

JOB ORDER NUMBER PROJ-10001187 SHEET 26 OF 60 $\star\star\star\star\star$ DRAWING NUMBER


ELECTION DIST. NO.: 9C6



BCDC LOBBY RENOVATIONS LEVEL 3 FLOOR PLAN - FIRE ALARM DEMOLITION

720 BOSLEY AVENUE, TOWSON, MD 21204

RENOVATION

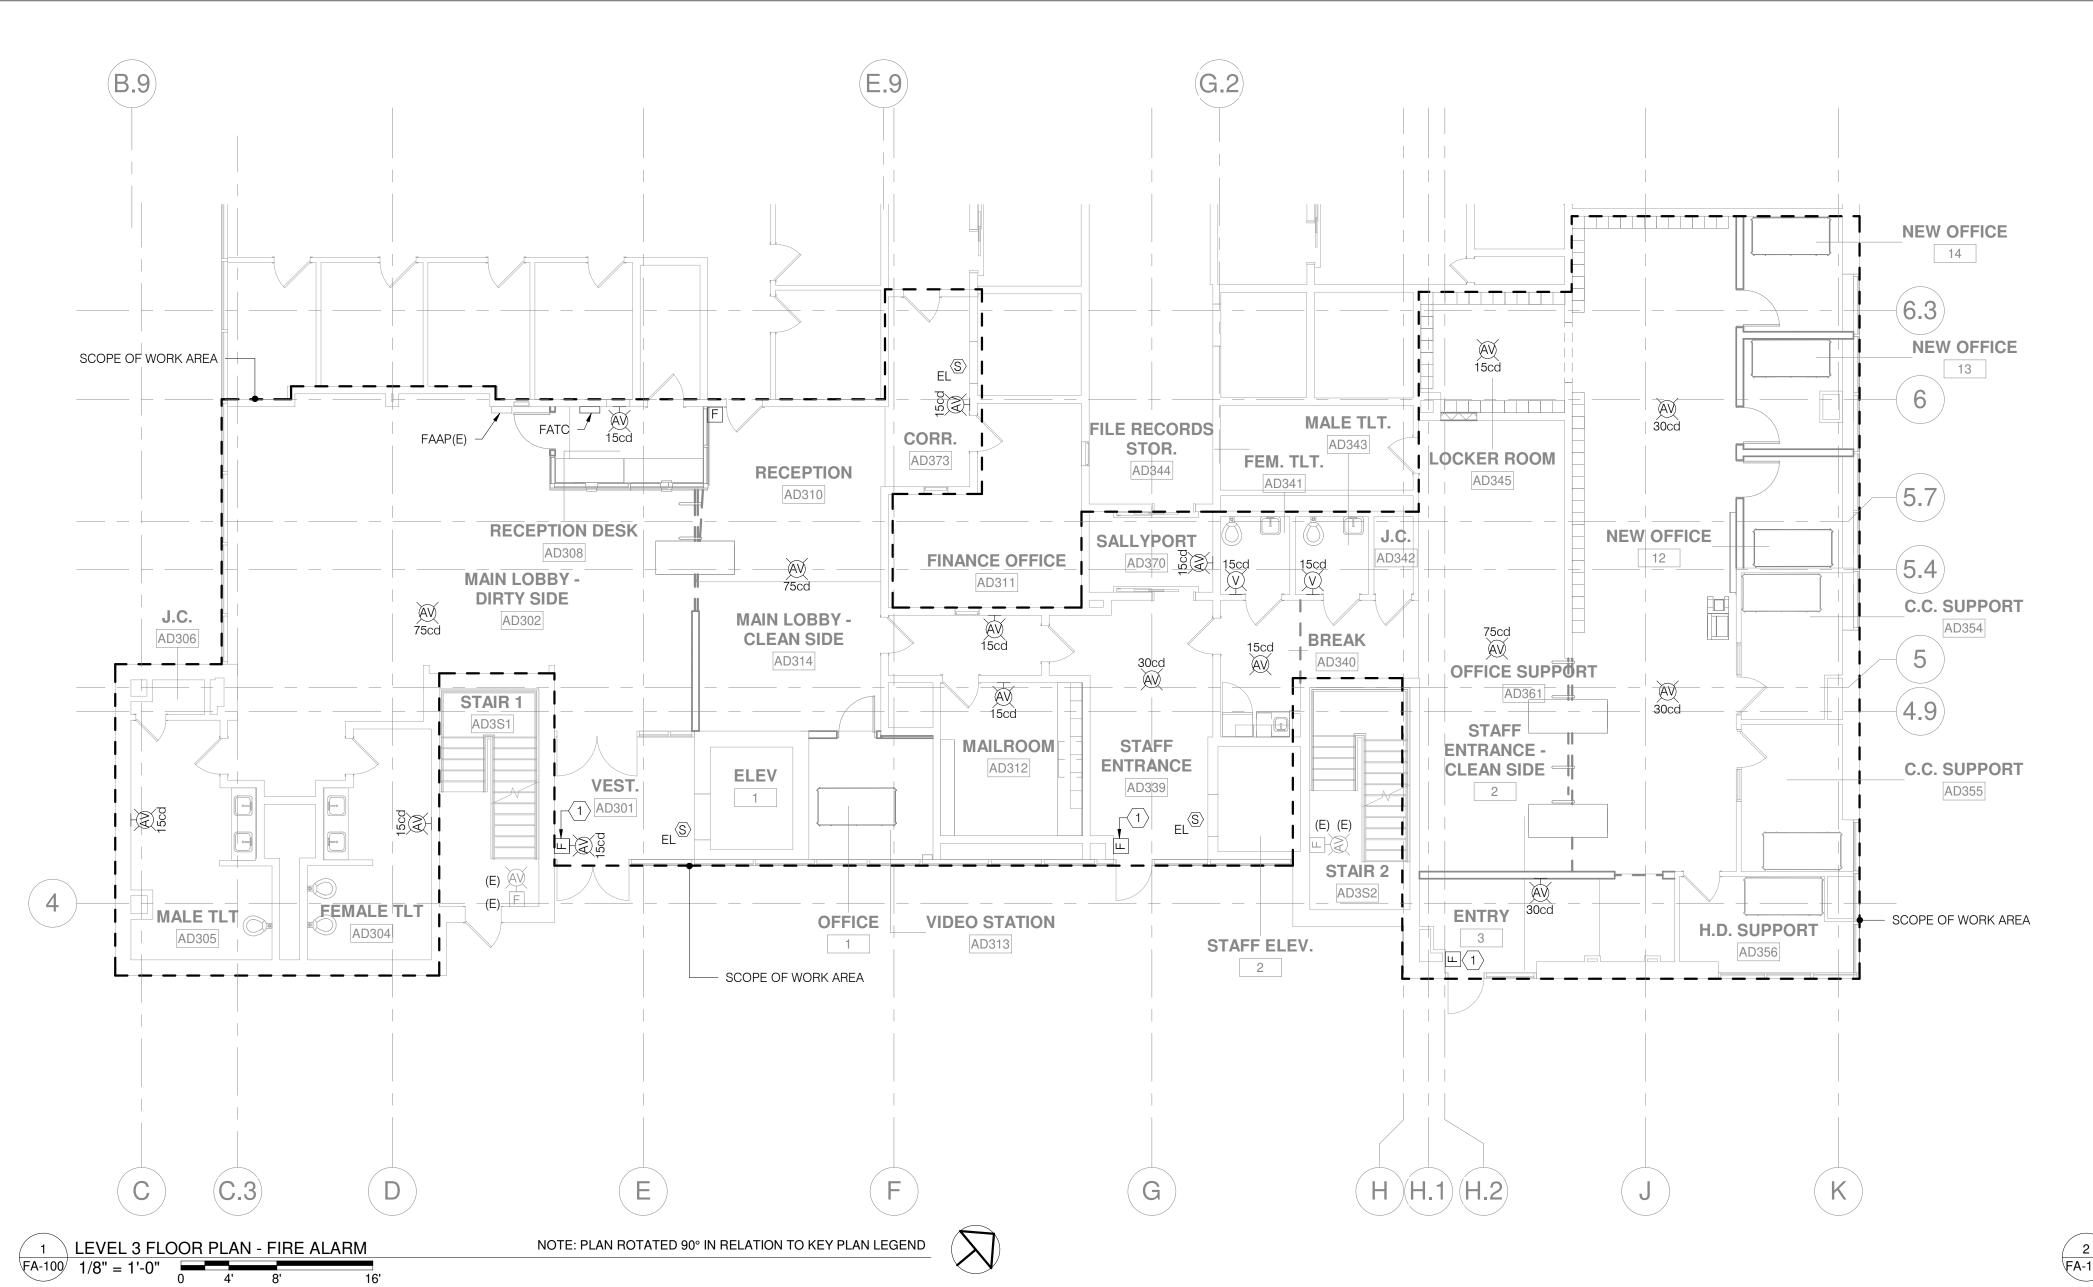

GENERAL NOTES

- 1. REFER TO FIRE ALARM COVER SHEET DRAWING FOR GENERAL NOTES, LEGEND AND ABBREVIATIONS. REFER TO DETAIL DRAWINGS FOR THE PROPOSED MOUNTING REQUIREMENTS OF TYPICAL FIRE ALARM DEVICES.
- 2. REFER TO ARCHITECTURAL DRAWINGS TO COORDINATE AND VERIFY AGAINST THE CEILING PLANS, ELEVATIONS AND DETAILS AT THE PROPOSED FIRE ALARM DEVICE INSTALLATION LOCATIONS PRIOR TO THE ROUGH-IN.
- 3. COORDINATE WITH MECHANICAL AND FIRE PROTECTION CONTRACT DOCUMENTS TO VERIFY THE EXACT LOCATION AND QUANTITY OF DUCT SMOKE DETECTORS AND ALL FLOW AND TAMPER SWITCHES RESPECTIVELY.
- 4. THE CONTINUITY OF ALL EXISTING FIRE ALARM INITIATING DEVICE, NOTIFICATION APPLIANCE AND SIGNALING LINE CIRCUITS TO REMAIN SHALL BE MAINTAINED.
- 5. ALL NEW FIRE ALARM DEVICES SHALL BE INSTALLED AS FLUSH MOUNTED WITH CONCEALED CONDUITS. ANY SURFACE MOUNTED DEVICES AND CONDUITS IN THE SCOPE OF WORK AREA MUST BE APPROVED BY THE ARCHITECT PRIOR TO INSTALLATION.
- 6. ALL NEW AND RELOCATED FIRE ALARM DEVICES MUST BE COMPATIBLE WITH AND CONNECTED TO THE EXISTING FIRE ALARM SYSTEM, ZONED BY FLOOR. EXTEND EXISTING WIRING AND CONDUIT FOR RELOCATED DEVICES TO NEW LOCATIONS AS REQUIRED.
- 7. WHERE MORE THAN TWO VISUAL (STROBE) NOTIFICATION APPLIANCES ARE IN THE FIELD OF VIEW, THEY SHALL FLASH IN SYNCHRONIZATION. PROVIDE EXTERNAL SYNC MODULE OR SYNC PROTOCOL BUILT IN TO THE FIRE ALARM CONTROL PANEL.
- 8. UNLESS OTHERWISE NOTED, IN THE SCOPE OF WORK AREA, ALL FIRE ALARM DEVICES SHOWN WITH A SUBSCRIPT "N" OR WITHOUT ANY SUBSCRIPT ARE NEW TO BE PROVIDED. DEVICES SHOWN WITH A SUBSCRIPT "E" INDICATE EXISTING DEVICES TO REMAIN.

SHEET KEY NOTES

1. PROVIDE PULL STATION WITH PROTECTIVE COVER.


FIRST FLOOR MAIN ELECTRICAL ROOM - FIRE ALARM - FOR REFERENCE ONLY

MAIN

ELECTRICAL

AUDIO AMPLIFIER (E)

ROOM

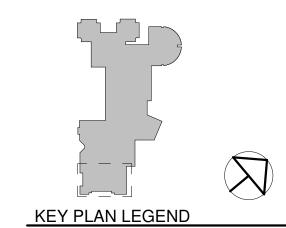

BALTIMORE, MD 21230 P: 667-309-6036

www.**SETTY**com

PROJECT NUMBER: SIPQ241913.03

226 West Market Street, York, Pennsylvania 17401 717-848-8627 voice 717-843-2449 fax

SHEET DESIGNATION

CONTRACT NUMBER 25122 PO0

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JOB ORDER NUMBER PROJ-10001187 SHEET 27 OF 60 DRAWING NUMBER

LEVEL 3 FLOOR PLAN - FIRE ALARM

BCDC LOBBY RENOVATIONS

BALTIMORE COUNTY OFFICE OF BUDGET AND FINANCE - PROPERTY MANAGEMENT

720 BOSLEY AVENUE, TOWSON, MD 21204

RENOVATION

BY DATE P.W.A. NO. KEY SHEET POSITION SHT DRAWING SCALE

R.O.W NO.

PLAN SCALE: As indicated

PROPERTY MANAGEMENT

PROPERTY MANAGER


SUBDIVISION: TOWSON

AS-BUILT / REVISION

PROFESSIONAL CERTIFICATION

R APPROVED BY ME, AND THAT I AM A DULY LICENSED

HEREBY CERTIFY THAT THESE DOCUMENTS WERE PREPARED

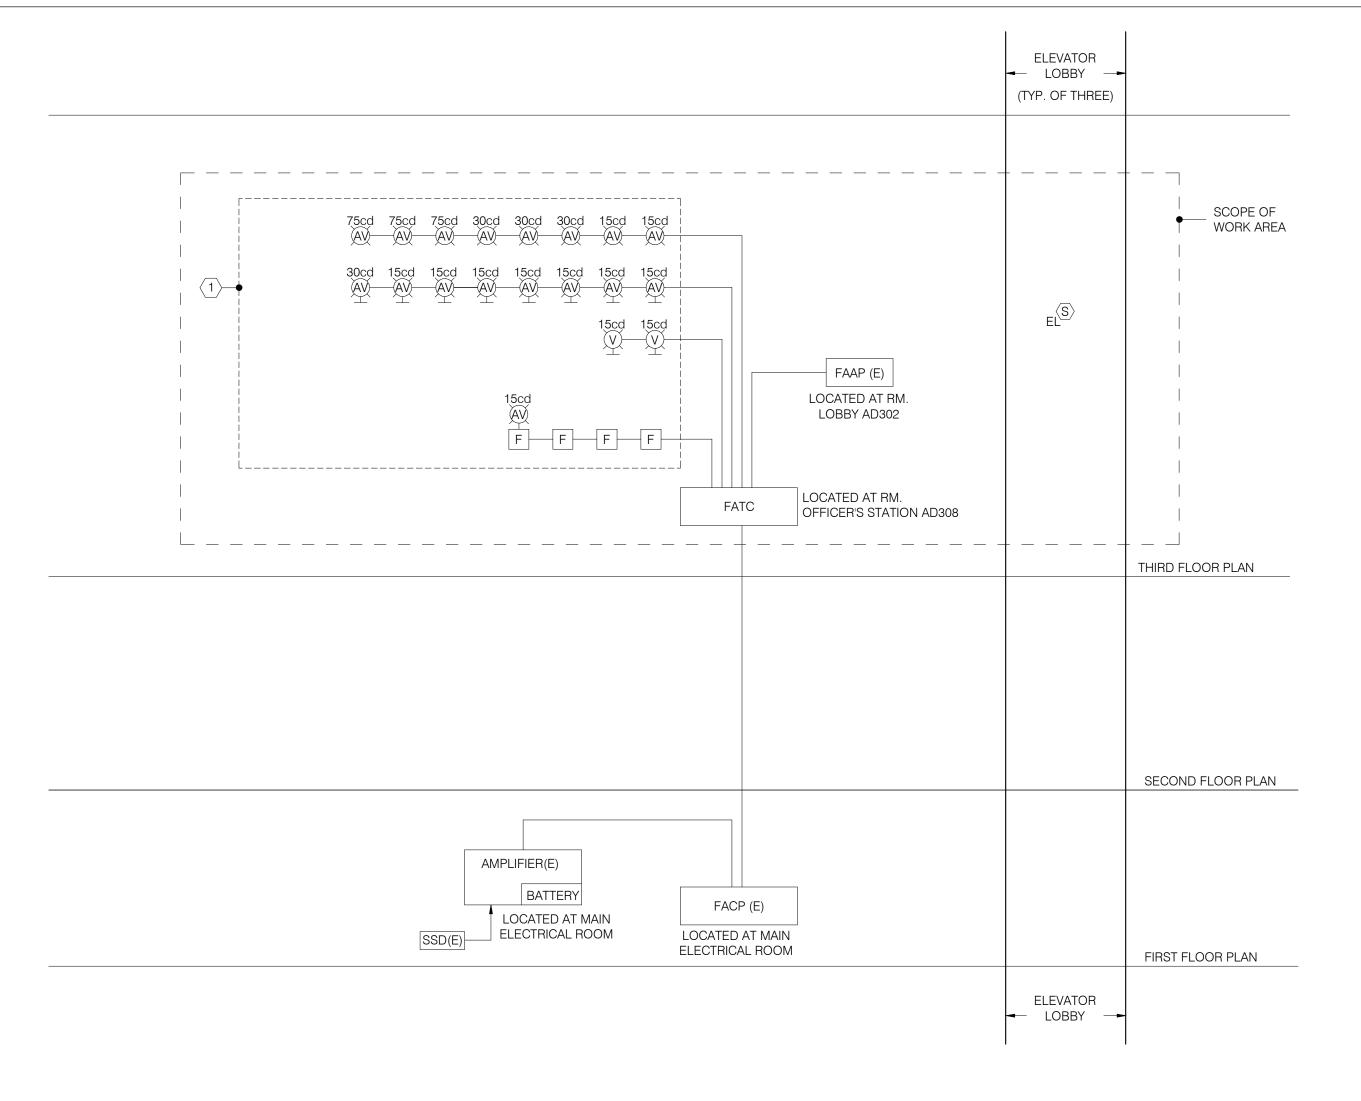

PARTIAL FIRE ALARM RISER DIAGRAM FA-501 NOT TO SCALE

EXISTING SYSTEM COMPATIBILITY:

• THE EXISTING FIRE ALARM SYSTEM INSTALLED IN THE FACILITY IS A SIEMENS FIREFINDER SYSTEM. ALL NEW FIRE ALARM COMPONENTS, INCLUDING BUT NOT LIMITED TO INITIATING DEVICES, NOTIFICATION APPLIANCES, ADDRESSABLE MODULES, ANNUNCIATORS, AND PANELS, SHALL BE FULLY COMPATIBLE WITH THE EXISTING SIEMENS SYSTEM.

APPROVED DEVICES ONLY:

• ALL FIRE ALARM DEVICES AND SYSTEM COMPONENTS SHALL BE MANUFACTURED BY SIEMENS OR A MANUFACTURER APPROVED IN WRITING BY SIEMENS AS COMPATIBLE WITH THE EXISTING SYSTEM.

 ALL ANNUNCIATOR PANELS PROVIDED UNDER THIS SCOPE SHALL BE SIEMENS-MANUFACTURED AND COMPATIBLE WITH THE EXISTING FIREFINDER CONTROL PANEL. THEY SHALL MATCH THE FUNCTIONALITY AND APPEARANCE OF EXISTING ANNUNCIATORS WHERE APPLICABLE.

SYSTEM INTEGRATION:

1. THE CONTRACTOR SHALL VERIFY THE COMPATIBILITY OF ALL NEW DEVICES WITH THE EXISTING SIEMENS SYSTEM AND SHALL BE RESPONSIBLE FOR ENSURING FULL INTEGRATION, PROGRAMMING, AND COMMISSIONING WITHOUT CAUSING FAULTS OR OPERATIONAL ISSUES WITHIN THE CURRENT FIRE ALARM INFRASTRUCTURE.

• CONTRACTOR SHALL SUBMIT COMPLETE DEVICE LISTS, CUT SHEETS, AND SIEMENS COMPATIBILITY LETTERS WITH SHOP DRAWINGS FOR REVIEW AND APPROVAL PRIOR TO INSTALLATION.

GENERAL NOTES

- 1. THE FIRE ALARM RISER DIAGRAM IS PROVIDED FOR REFERENCE ONLY AND IS NOT INTENDED TO DESCRIBE THE SYSTEM ARCHITECTURE AND DOES NOT INCLUDE ALL NECESSARY INFORMATION TO INSTALL THE SYSTEM. THE INSTALLED SYSTEM MUST MEET ALL REQUIREMENTS OF THE FP 72 AND AHJ.
- 2. THE FIRE ALARM SYSTEM IS DESIGNED TO UTILIZE HORN MODULES FOR AUDIBLE NOTIFICATIONS.
- 3. ALL NEW FIRE ALARM VISUAL NOTIFICATION DEVICES IN THE SCOPE OF WORK AREA MUST BE ADA COMPLIANT.
- 4. THE FIRE ALARM AUDIBLE DEVICE SHALL HAVE A SOUND LEVEL AT LEAST 15 dBA ABOVE THE AVERAGE AMBIENT SOUND LEVEL OR 5 dBA ABOVE THE MAXIMUM SOUND LEVEL HAVING A DURATION OF AT LEAST 60 SECONDS, WHICHEVER IS GREATER, THROUGHOUT THE AREA OF WORK.
- 5. ALL FIRE ALARM DEVICES INSTALLED IN THE AREA OF WORK SHALL CONFORM WITH ALL STANDARDS AND REQUIREMENTS OF ADA, UL, ANSI AND NFPA 72. EXISTING NON-COMPLIANT DEVICES IN THE SCOPE OF WORK AREA SHALL BE REPLACED IN PLACE WITH NEW COMPLIANT DEVICES. VISUAL (STROBE) DEVICES SHALL BE EQUIPPED WITH FIELD SELECTABLE WITH MINIMUM 15 AND MAXIMUM 110 CANDELA RATED LIGHT OUTPUT OPTION AND SIMULTANEOUS FLASH RATE OF 1 TO 3 Hz.
- 6. CONTRACTOR TO PROVIDE ADDRESSABLE MONITOR INTERFACE/RELAY MODULES AS REQUIRED TO ENSURE A COMPLETE AND OPERATIONAL SYSTEM FOR ALL APPLICABLE EQUIPMENT AND DEVICES INCLUDING BUT NOT LIMITED TO THE FOLLOWING:
 - FLOW SWITCHES TAMPER SWITCHES
 - DRY PIPE SYSTEM
 - ELEVATORS
 - FIRE PUMP GENERATOR
 - IT, AV AND SECURITY SYSTEMS HVAC UNITS
- 7. THE FIRE ALARM SYSTEM IS TO BE CLEAR OF ALL TROUBLE AND ALARM SIGNALS AT THE END OF EACH DAY INCLUDING ANY REPROGRAMMING REQUIRED BY THE TEMPORARY OR PERMANENT REMOVAL OF EXISTING DEVICES.
- 8. CONTRACTOR TO REPROGRAM THE EXISTING FIRE ALARM SYSTEM UPON COMPLETION OF ANY MODIFICATIONS TO THE SYSTEM AS REQUIRED. UNLESS OTHERWISE NOTED, MAINTAIN AND MATCH EXISTING SEQUENCE OF OPERATIONS.
- 9. ALL FIRE ALARM WORK MUST BE COORDINATED WITH THE OWNER AND BUILDING ENGINEER AT LEAST 3 DAYS PRIOR TO INSTALLATION. THE FIRE ALARM SYSTEM MUST REMAIN OPERATIONAL AS THE BUILD OUT OCCURS. OBTAIN WRITTEN PERMISSION FROM THE OWNER PRIOR TO THE INTERRUPTION OF THE BUILDING FIRE ALARM SYSTEM. THE CONTRACTOR MUST FOLLOW ALL BUILDING OWNER PROTOCOLS AND CODE REQUIREMENTS FOR A FIRE ALARM INTERRUPTION.
- 10. CONTRACTOR TO PREPARE AND SUBMIT FIRE ALARM SHOP DRAWINGS TO THE ENGINEER AND THE FIRE MARSHAL FOR REVIEW AND FINAL APPROVAL. CONTRACTOR TO BE PRESENT DURING FINAL INSPECTION AND TESTING BY THE FIRE MARSHALL.
- SHOP DRAWINGS SHALL INCLUDE: SYSTEM RISER DIAGRAM AND FLOOR PLAN WITH DEVICE ADDRESSES, CONDUIT SIZES AND WIRE TYPE AND SIZES
- FIRE ALARM EXTENDER PANEL, IF REQUIRED COMPONENT WIRING DIAGRAMS
- PRODUCT DATA SHEETS AND EQUIPMENT DESCRIPTION BATTERY SIZE CALCULATIONS
- DETAIL OF MODIFIED ANNUNCIATOR PANEL ANY REVISIONS AND ADDITIONS REQUIRED BY THE AHJ PRIOR TO OBTAINING THE CERTIFICATE OF OCCUPANCY ARE THE RESPONSIBILITY OF THE CONTRACTOR.

SHEET KEY NOTES

1. CONTRACTOR TO PROVIDE ADDITIONAL BOOSTER PANEL FOR THE NEW FIRE ALARM STROBES IF REQUIRED. FIELD COORDINATE THE BOOSTER PANEL LOCATION. PROVIDE 120V CIRCUIT FROM NEAREST EXISTING 120/208V PANEL SERVING THAT AREA.



PROJECT NUMBER: SIPQ241913.03



SHEET DESIGNATION

FA-501

CONTRACT NUMBER

25122 PO0

2025-2139

JOB ORDER NUMBER PROJ-10001187 SHEET 28 OF 60 DRAWING NUMBER


FIRE ALARM RISER DIAGRAM


BCDC LOBBY RENOVATIONS

RENOVATION


BALTIMORE COUNTY OFFICE OF BUDGET AND FINANCE - PROPERTY MANAGEMENT

720 BOSLEY AVENUE, TOWSON, MD 21204

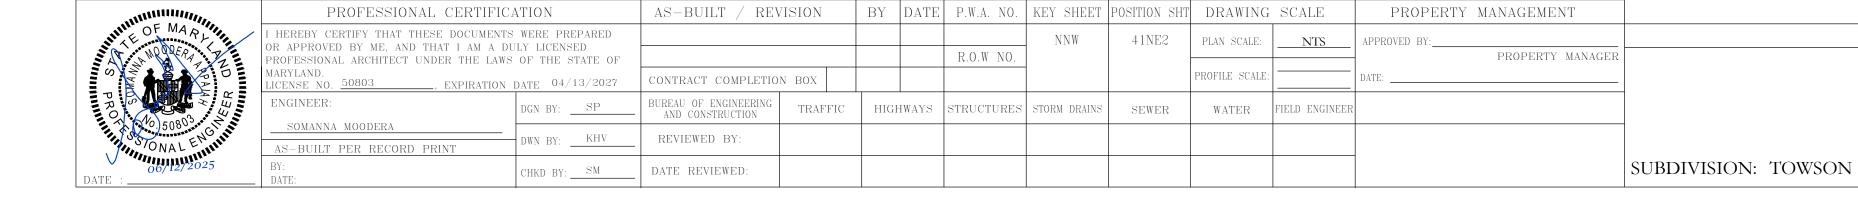

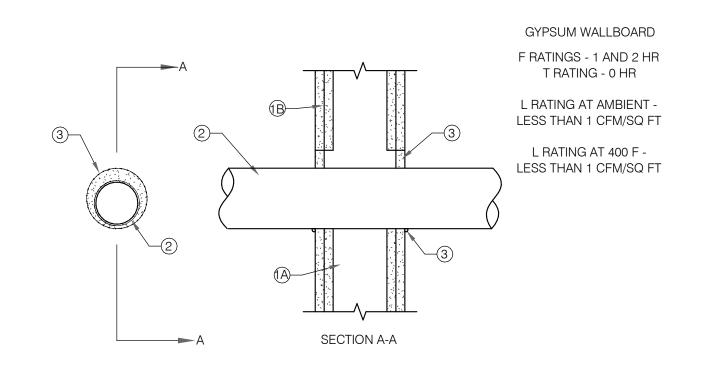

- 1. WALL ASSEMBLY THE FIRE-RATED GYPSUM WALLBOARD/STUD WALL ASSEMBLY SHALL BE CONSTRUCTED OF THE MATERIALS AND IN THE MANNER SPECIFIED IN THE INDIVIDUAL U300 OR U400 SERIES WALL AND PARTITION DESIGNS IN THE UL FIRE RESISTANCE DIRECTORY AND SHALL INCLUDE THE FOLLOWING CONSTRUCTION FEATURES:
- 1.1. STUDS WALL FRAMING MAY CONSIST OF EITHER WOOD STUDS OR STEEL CHANNEL STUDS. WOOD STUDS TO CONSIST OF NOM 2 BY 4 IN. LUMBER SPACED 16 IN. OC. STEEL STUDS TO BE MIN 3-5/8 IN. WIDE AND SPACED MAX 24 IN. OC.
- 1.2. GYPSUM BOARD* THICKNESS, TYPE, NUMBER OF LAYERS AND FASTENERS AS REQUIRED IN THE INDIVIDUAL WALL AND PARTITION DESIGN. MAX DIAM OF OPENING IN WOOD STUD WALLS IS 8 IN. MAX DIAM OF OPENING IN STEEL STUD WALLS IS 14 IN. THE HOURLY F RATING OF THE FIRESTOP SYSTEM IS EQUAL TO THE HOURLY FIRE RATING OF THE WALL ASSEMBLY IN WHICH IT IS INSTALLED.
- 2. THROUGH PENETRANT ONE METALLIC PIPE, CONDUIT OR TUBING TO BE INSTALLED WITHIN THE FIRESTOP SYSTEM. THE SPACE BETWEEN PIPE, CONDUIT OR TUBING AND PERIPHERY OF OPENING SHALL BE A MIN 0 IN. (POINT CONTACT) TO A MAX 2 IN. PIPE, CONDUIT OR TUBING TO BE RIGIDLY SUPPORTED ON BOTH SIDES OF WALL ASSEMBLY. THE FOLLOWING TYPES AND SIZES OF METALLIC PIPES, CONDUITS OR TUBING MAY BE USED:
- 2.1. STEEL PIPE NOM 12 IN. DIAM (OR SMALLER) SCHEDULE 5 (OR HEAVIER STEEL PIPE).
- 2.2. IRON PIPE NOM 12 IN. DIAM (OR SMALLER) CAST OR DUCTILE IRON PIPE. 2.3. CONDUIT - NOM 4 IN. DIAM (OR SMALLER) ELECTRICAL METALLIC TUBING, NOM 6 IN. DIAM (OR
- SMALLER) STEEL CONDUIT OR NOM 1 IN. DIAM (OR SMALLER) FLEXIBLE STEEL CONDUIT.
- 2.4. COPPER TUBING NOM 6 IN. DIAM (OR SMALLER) TYPE L (OR HEAVIER) COPPER TUBING.
- 2.5. COPPER PIPE NOM 6 IN. DIAM (OR SMALLER) REGULAR (OR HEAVIER) COPPER PIPE.
- 3. FILL, VOID OR CAVITY MATERIAL* CAULK MIN 5/8 IN. THICKNESS OF FILL MATERIAL APPLIED WITHIN THE ANNULUS, FLUSH WITH BOTH SURFACES OF WALL. MIN 3/8 IN. DIAM BEAD OF FILL MATERIAL APPLIED AT POINT CONTACT LOCATION AT THE PENETRANT/GYPSUM BOARD INTERFACE ON BOTH SIDES OF WALL. PENETRATIONS THROUGH STRUCTURE SHALL MAINTAIN FIRE RESISTANCE AND COMPLY WITH SECTION 714.4 OF THE IBC 2021. ALL ANNULAR SPACES BETWEEN RATED STRUCTURE/ENCLOSURE SHALL BE FILLED WITH APPROVED MATERIAL COMPLYING WITH REQUIREMENTS OF UL1479.

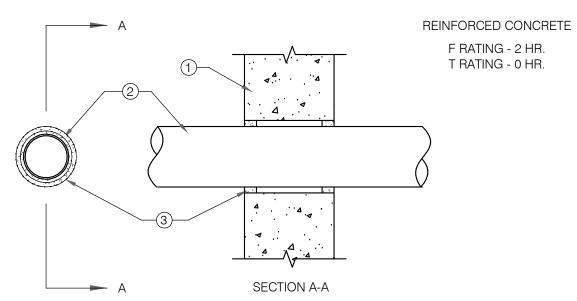

- 1. WALL ASSEMBLY MIN 6 IN. (152 MM) THICK REINFORCED LIGHTWEIGHT OR NORMAL WEIGHT (100-150 PCF OR 1600-2400 KG/M3) CONCRETE. WALL MAY ALSO BE CONSTRUCTED OF ANY UL CLASSIFIED CONCRETE BLOCKS*. MAX DIAM OF OPENING IS 25 IN. (635 MM). SEE CONCRETE BLOCKS (CAZT) CATEGORY IN THE FIRE RESISTANCE DIRECTORY FOR THE NAMES OF MANUFACTURERS.
- 2. THROUGH PENETRANT ONE METALLIC PIPE, TUBING OR CONDUIT TO BE INSTALLED EITHER CONCENTRICALLY OR ECCENTRICALLY WITHIN THE FIRESTOP SYSTEM. THE ANNULAR SPACE BETWEEN PIPES, TUBING OR CONDUITS AND PERIPHERY OF OPENING IS DEPENDENT UPON THE TYPE AND MAX DIAM OF THE THROUGH PENETRANT AS TABULATED BELOW. PIPE, TUBING OR CONDUIT TO BE RIGIDLY SUPPORTED ON BOTH SIDES OF WALL ASSEMBLY. THE FOLLOWING TYPES AND SIZES OF METALLIC PIPES, TUBING OR CONDUITS MAY BE
- 2.1. STEEL PIPE NOM 24 IN. (610 MM) DIAM (OR SMALLER) SCHEDULE 10 (OR HEAVIER) STEEL PIPE. 2.2. IRON PIPE - NOM 24 IN. (610 MM) DIAM (OR SMALLER) CAST OR DUCTILE IRON PIPE.
- 2.3. COPPER TUBING NOM 6 IN. (152 MM) DIAM (OR SMALLER) TYPE L (OR HEAVIER) COPPER TUBING.
- 2.4. COPPER PIPE NOM 6 IN. (152 MM) DIAM (OR SMALLER) REGULAR (OR HEAVIER) COPPER PIPE.
- 2.5. CONDUIT NOM 4 IN. (102 MM) DIAM (OR SMALLER) STEEL ELECTRICAL METALLIC TUBING, NOM 6 IN. (152MM) DIAM GALV STEEL CONDUIT OR NOM 1 IN. DIAM FLEXIBLE STEEL CONDUIT.

TYPE OF THROUGH PENETRANT	MAX DIAM OF THROUGH PENETRANT, IN. (MM)	MIN & MAX ANNULAR SPACE, IN. (MM)
STEEL OR IRON PIPE	4 (102)	0, 1-1/2 (38)
STEEL TUBING OR CONDUIT	4 (102)	0, 1-1/2 (38)
STEEL CONDUIT	6 (152)	1/8 (3), 1/2 (13)
STEEL OR IRON PIPE	24 (610)	1/8 (3), 1/2 (13)
COPPER TUBING OR PIPE	6 (152)	1/8 (3), 1/2 (13)

3. FILL, VOID OR CAVITY MATERIAL* - SEALANT - MIN 5/8 IN. (16 MM) THICKNESS OF FILL MATERIAL APPLIED WITHIN ANNULUS, FLUSH WITH BOTH SURFACES OF WALL. AT THE POINT CONTACT LOCATION BETWEEN THROUGH PENETRANT AND CONCRETE, A MIN 3/8 IN. (10 MM) DIAM BEAD OF FILL MATERIAL SHALL BE APPLIED AT THE CONCRETE/THROUGH PENETRANT INTERFACE ON BOTH SURFACES OF WALL.

PENETRATIONS THROUGH STRUCTURE SHALL MAINTAIN FIRE RESISTANCE AND COMPLY WITH SECTION 714.4 OF THE IBC 2021 . ALL ANNULAR SPACES BETWEEN RATED STRUCTURE/ENCLOSURE SHALL BE FILLED WITH APPROVED MATERIAL COMPLYING WITH REQUIREMENTS OF UL 1479.



PROFESSIONAL CERTIFICATION

R APPROVED BY ME, AND THAT I AM A DULY LICENSED

ENGINEER:

SOMANNA MOODERA

S-BUILT PER RECORD PRINT


HEREBY CERTIFY THAT THESE DOCUMENTS WERE PREPARED

OFESSIONAL ARCHITECT UNDER THE LAWS OF THE STATE OF

CHKD BY: SM

NOTES:

- 1. DEVICES SHALL BE INSTALLED ON A COMMON VERTICAL LINE WHEREVER POSSIBLE.
- 2. REFER TO THE PROPER DEVICE INSTALLATION INSTRUCTIONS FOR BACKBOX MOUNTING HEIGHTS. 3. COORDINATE WITH ARCHITECT TO VERIFY ALL PROJECT SPECIFIC STANDARD DEVICE MOUNTING HEIGHTS PRIOR TO INSTALLATION. ARCHITECTURAL DRAWINGS TO TAKE PRECEDENCE OVER THE

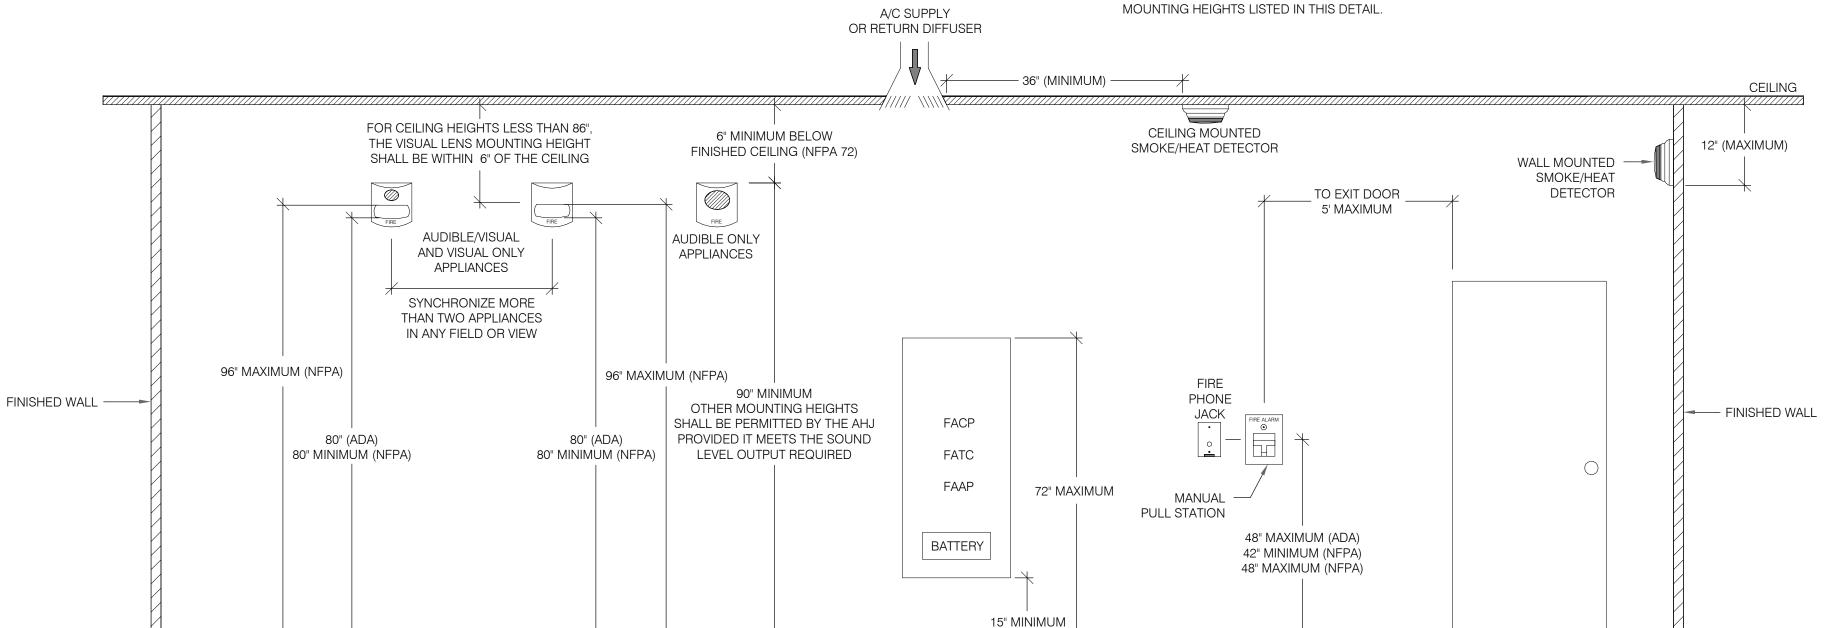

MOUNTING HEIGHT - FIRE ALARM DEVICES

145 W. OSTEND STREET, SUITE 537 BALTIMORE, MD 21230 P: 667-309-6036 www.**SETTY**com PROJECT NUMBER: SIPQ241913.03



FINISHED FLOOR


SHEET DESIGNATION FA-701

CONTRACT NUMBER 25122 PO0

> JOB ORDER NUMBER PROJ-10001187 SHEET 29 OF 60 DRAWING NUMBER

> > 2025-2140

ELECTION DIST. NO.: 9C6

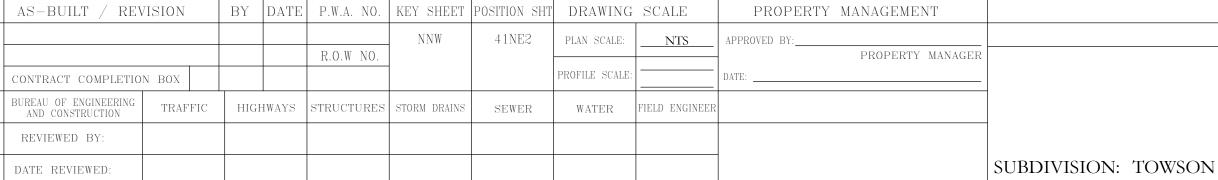

BALTIMORE COUNTY OFFICE OF BUDGET AND FINANCE - PROPERTY MANAGEMENT

BCDC LOBBY RENOVATIONS

FIRE ALARM DETAILS

RENOVATION 720 BOSLEY AVENUE, TOWSON, MD 21204

 $\star\star\star\star\star$

SYMBOLS **ABBREVIATIONS** FIRE PROTECTION GENERAL NOTES SPRINKLERS AND ASSOCIATED PIPING IN THE SCOPE OF WORK AREA SHALL BE REMOVED AND REPLACED WITH THE CODES AND STANDARDS LISTED BELOW. REFER TO ARCHITECTURAL DRAWINGS FOR COMPLETE SCOPE OF **AUTO AIR VENT** ABV PHASE (ELECTRICAL) ABOVE PIPE REPRESENTATION AREA DRAIN PRESSURE REDUCING VALVE 2. IT IS THE INTENT OF THESE DOCUMENTS TO PROVIDE DESIGN, MATERIALS, AND EQUIPMENT FOR A FULLY FUNCTIONING AND COORDINATION WITH MECHANICAL, ELECTRICAL, PLUMBING, ARCHITECTURAL, AND STRUCTURAL SYSTEMS. ABOVE FINISHED FLOOR POUNDS PER SQUARE INCH AUTHORITY HAVING JURISDICTION 3. IT IS THE RESPONSIBILITY OF THE SPRINKLER CONTRACTOR TO OBTAIN ALL NECESSARY PERMITS AND APPROVALS OF THE AUTHORITY HAVING JURISDICTION. ACCESS PANEL FIRE PROTECTION PIPING ARCH QUICK RESPONSE ARCHITECTURAL QR I. IT IS THE RESPONSIBILITY OF THE SPRINKLER CONTRACTOR TO COORDINATE LOCATIONS OF SPRINKLERS AND PIPING WITH LIGHTING FIXTURES, DUCTWORKS, CLEARANCE REQUIRED FOR EQUIPMENT ACCESS, CONDUITS, PIPES, STRUCTURAL MEMBERS, AND ALL OTHER OBSTRUCTIONS FOR A CODE ASME AMERICAN SOCIETY OF MECHANICAL COMPLIANT COVERAGE IN ACCORDANCE WITH NFPA 13. **ENGINEERS** DEMOLITION PIPING AMERICAN SOCIETY OF PLUMBING REVOLUTIONS PER MINUTE 5. STRUCTURAL MEMBERS SHALL NOT BE CUT OR PENETRATED UNLESS APPROVED BY THE PROJECT ARCHITECT AND STRUCTURAL ENGINEER. **ENGINEERS** ASSE AMERICAN SOCIETY OF SANITARY 6. PIPING LAYOUTS, WHERE SHOWN, ARE DIAGRAMMATIC AND SHOWS SYSTEM INTENT ONLY. THE SPRINKLER CONTRACTOR SHALL PROVIDE FINAL LAYOUT AND HYDRAULIC CALCULATIONS IN ACCORDANCE WITH THE STATE BUILDING CODE AND REFERENCED NFPA 13. **ENGINEERS** SANITARY/WASTE PIPE SQUARE FEET 7. SPRINKLER PIPING SHALL BE INSTALLED SO THAT ALL PORTIONS OF THE SYSTEM CAN BE DRAINED THROUGH THE MAIN DRAIN VALVES FOR THE SYSTEM. WHERE TRAPPED SECTIONS OF PIPING CANNOT BE AVOIDED, AUXILIARY DRAINS SHALL BE PROVIDED IN ACCORDANCE WITH NFPA 13. SS STAINLESS STEEL **BACKFLOW PREVENTER** STP STANDPIPE 8. DO NOT INSTALL PIPING BELOW HVAC EQUIPMENT OR THAT INTERFERES WITH ANY TYPE OF ACCESS PANELS. STRUC BLDG STRUCTURAL BUILDING BLW **BELOW** PIPE FITTINGS 9. SPRINKLERS SHALL BE PROVIDED BELOW DUCTWORK OR EQUIPMENT GREATER THAN 4 FEET IN WIDTH AND COMPLY WITH ALL APPLICABLE OBSTRUCTION RULES OF NFPA 13. TEST AND DRAIN ASSEMBLY WITH 10. WHERE CEILING TILES ARE PROVIDED, SPRINKLERS SHALL BE CENTERED IN CEILING TILES. **CUBIC FEET PER MINUTE** PRESSURE RELIEF VALVE CLG TEMPERATURE CEILING 11. SPRINKLER GUARDS SHALL BE PROVIDED ON SPRINKLERS IN AREAS SUBJECT TO MECHANICAL DAMAGE AND ON SPRINKLERS LOCATED LESS THAN 7 FEET ABOVE FINISHED FLOOR. CONN CONNECTION **TYPICAL** CONT CONTINUATION **ECCENTRIC** 12. PROVIDE ORDINARY TEMPERATURE SPRINKLERS IN ALL AREAS EXCEPT WHERE INTERMEDIATE OR HIGH TEMPERATURE SPRINKLERS ARE SPECIFICALLY REQUIRED BY NFPA 13. CW COLD WATER CONCENTRIC WATT 13. PROVIDE QUICK-RESPONSE SPRINKLERS IN LIGHT HAZARD SPACES IN ACCORDANCE WITH NFPA 13. WATER METER DCWASA D.C. WATER AND SEWER AUTHORITY WTR WATER CAPPED CONNECTION 14. SPRINKLERS THAT HAVE BEEN PAINTED OVER WITH PAINT FROM OTHER THAN THE SPRINKLER MANUFACTURER SHALL BE REPLACED WITH NEW. DIA DIAMETER WITH DN DOWN W/O WITHOUT PIPE UNION 15. ALL PIPING SHALL BE HYDROSTATICALLY TESTED IN ACCORDANCE WITH NFPA 13. DWG DRAWING ELBOW TURNED UP 16. COORDINATE NEW SPRINKLER INSTALLATION TO MAINTAIN TEMPORARY COVERAGE UNTIL PERMANENT COVERAGE IS IN PLACE. UPON COMPLETION OF NEW SPRINKLER SYSTEM INSTALLATION REMOVE TEMPORARY SPRINKLER COVERAGE. NOTE: ALL ABBREVIATIONS MAY NOT APPEAR ON THE **EXISTING** DRAWINGS. **ELBOW TURNED DOWN** EACH **EQUIP EQUIPMENT** TEE DOWN FIRE PROTECTION DEMOLITION NOTES ETR EXISTING TO REMAIN SHUT-OFF VALVE IN RISER FP-W FIRE PROTECTION WET PIPE VALVES AND ACCESSORIES **FCVA** FLOOR CONTROL VALVE ASSEMBLY REFER TO ARCHITECTURAL DEMOLITION DRAWINGS FOR FULL EXTENT OF DEMOLITION SCOPE OF WORK FD FLOOR DRAIN FDC FIRE DEPARTMENT CONNECTION 2. CONTRACTOR SHALL VISIT THE SITE AND BECOME FAMILIAR WITH ALL EXISTING CONDITIONS AND SCOPE OF WORK PRIOR TO SUBMITTING BIDS. FHC FIRE HOSE CABINET FHV FIRE HOSE VALVE 3. EXISTING CONDITIONS, WHERE SHOWN, IS BASED ON AVAILABLE AS-BUILT DOCUMENTATION FROM THE OWNER. CONTRACTOR SHALL FIELD VERIFY ALL EXISTING CONDITIONS AS ACTUAL CONDITIONS MAY VARY. **FLOOR** BUTTERFLY VALVE W/ TAMPER SWITCH FOB FLAT ON BOTTOM 4. EXISTING FIRE PROTECTION SYSTEM COMPONENTS IN THE SCOPE OF WORK AREA THAT ARE FOUND TO BE DAMAGED OR NOT IN REUSABLE CONDITION SHALL BE BROUGHT TO THE ATTENTION OF THE OWNER AND REPLACED WITH NEW. FOT FLAT ON TOP FLOW SWITCH FS 5. CONTRACTOR SHALL COORDINATE ALL REMOVAL, DISPOSAL, AND STORAGE OF EXISTING EQUIPMENT WITH THE OWNER. OS&Y VALVE W/ TAMPER SWITCH FEET 6. SHUTDOWN OF SPRINKLER SYSTEM TO PERFORM REQUIRED WORK SHALL BE KEPT TO A MINIMUM AND COORDINATED WITH THE OWNER AT LEAST THREE DAYS IN ADVANCE. SPRINKLER SYSTEM SHALL NOT BE SHUTDOWN WITHOUT OWNER APPROVAL. DOUBLE CHECK VALVE / DETECTOR GALLON BACKFLOW PREVENTER (ASSE 1015, EXISTING SPRINKLER SYSTEMS LOCATED OUTSIDE OF THE WORK AREA SHALL NOT BE AFFECTED AND REMAIN FULLY OPERATIONAL DURING THE COURSE OF THE RENOVATION. WHERE THIS CANNOT BE AVOIDED, TEMPORARY FIRE PROTECTION MEASURES SHALL BE PROVIDED IN THE AFFECTED AREAS IN THE GPM GALLONS PER MINUTE FORM OF AN APPROVED FIRE WATCH OR OTHER APPROVED METHODS ACCEPTABLE TO THE AHJ. BALL VALVE SPRINKLER AND FIRE PROTECTION REMOVAL WORK SHALL CONSIST OF REMOVAL OF ALL SPRINKLER HEADS AND BRANCH PIPING WITHIN THE RENOVATED AREA. PROVIDE NEW SPRINKLER HEADS IN ALL AFFECTED AREAS WITH PROPER SPRINKLER COVERAGE. LOCATIONS SHALL BE DESIGNED BY THE SPRINKLER HIGH DENSITY POLYETHYLENE CONTRACTOR IN ACCORDANCE WITH NFPA 13 REQUIREMENTS. COORDINATE NEW SPRINKLER HEAD LOCATIONS WITH WALL, EQUIPMENT, LIGHTING, FURNITURE, AND ALL OTHER TRADES. CHECK VALVE HORSE POWER 9. REMOVE AND RELOCATE EXISTING SPRINKLER MAIN AND BRANCH PIPING TO ACCOMMODATE NEW WORK INSTALLATION. RISER CHECK VALVE (SHOTGUN RISER) INCH INV INVERT ALARM CHECK VALVE KILOWATT **DESIGN CRITERIA** DRY PIPE VALVE LIGHT HAZARD SPRINKLER SYSTEM SHALL BE DESIGNED IN ACCORDANCE WITH NFPA 13 HAZARD CLASSIFICATIONS AND THEIR CORRESPONDING DESIGN DENSITY, DESIGN DENSITY, DESIGN AREA, AND HOSE STREAM REQUIREMENTS. PIPE SCHEDULE METHOD IS NOT PERMITTED TO BE USED. MINIMUM SAFETY FACTOR OF 10 PSI SHALL BE PROVIDED. MAX MAXIMUM MECH MECHANICAL PRESSURE SWITCH MFR MANUFACTURER 1. LIGHT HAZARD: OFFICES, LOBBIES, CONFERENCE ROOMS, CLASSROOMS, RESTROOMS, AND SIMILAR SPACES SHALL BE DESIGNED USING 0.1 GPM/SF OVER 1500 SF WITH 100 GPM HOSE STREAM. MAXIMUM SPRINKLER PROTECTION AREA SHALL NOT EXCEED 225 SF. MIN MINIMUM MTD MOUNTED 2. ORDINARY HAZARD GROUP 1: ELECTRICAL, TELECOM, MECHANICAL, GENERAL STORAGE ROOMS, KITCHENS, AND SIMILAR SPACES SHALL BE DESIGNED USING 0.15 GPM/SF OVER 1500 SQUARE FEET. FLOW SWITCH 3. DESIGN AREA REDUCTION FOR USE OF QUICK RESPONSE SPRINKLERS IS PERMITTED IN ACCORDANCE WITH NFPA 13. NATIONAL FIRE PROTECTION 4. DESIGN AREA WILL BE INCREASED BY 30% FOR ROOF PITCH EXCEEDING 2 IN 12. ASSOCIATION NOT IN CONTRACT NUMBER FLOOR CONTROL VALVE ASSEMBLY APPLICABLE CODES AND STANDRADS TDA ^刊 OUTSIDE STEM AND YOLK OH 1 ORDINARY HAZARD GROUP 1 ORDINARY HAZARD GROUP 2 FIRE PUMP TEST CONNECTION . 2021 MARYLAND BUILDING CODE ICC IBC 2. 2021 MARYLAND EXISTING BUILDING CODE (IEBC) FIRE PROTECTION DRAWING LIST 3. 2018 NFPA 101 - LIFE SEFTY CODE. FIRE HOSE CONNECTION (IN RISER) FIRE PIPING SHEET DRAWING 4. 2020 STATE OF MARYLAND FIRE PREVENTION CODE. GENERAL NOTES, SYMBOLS & ABBREVIATIONS FD-100 LEVEL 3 FLOOR PLAN - FIRE PROTECTION DEMOLITION 5. NFPA 13, 2019 STANDARD FOR THE INSTALLATION OF SPRINKLER SYSTEMS. FIRE HOSE CONNECTION (IN PLAN) F-100 LEVEL 3 FLOOR PLAN - FIRE PROTECTION F-701 FIRE PROTECTION DETAILS NOTE: WHERE THERE ARE CONFLICTING REQUIREMENTS BETWEEN CODES AND STANDARDS, THE MOST STRINGENT REQUIREMENT SHALL TAKE PRECEDENCE. FREE STANDING FIRE DEPARTMENT CONNECTION NOTE: ALL SYMBOLS MAY NOT APPEAR ON THE DRAWINGS.


PROPERTY MANAGEMENT

PROPERTY MANAGER

SUBDIVISION: TOWSON

NTS

FIELD ENGINE

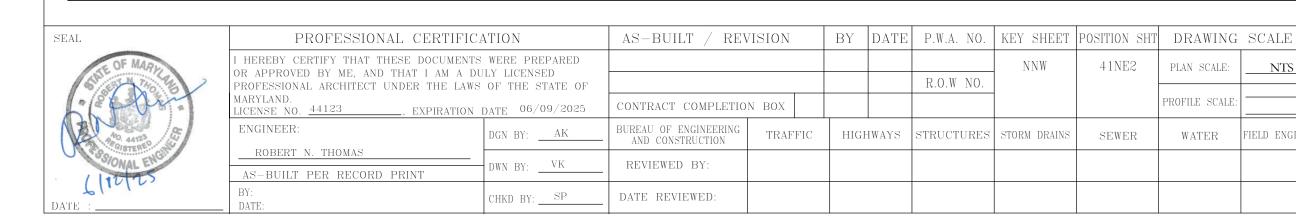


BALTIMORE COUNTY OFFICE OF BUDGET AND FINANCE - PROPERTY MANAGEMENT

BCDC LOBBY RENOVATIONS

GENERAL NOTES, SYMBOLS & ABBREVIATIONS

RENOVATION 720 BOSLEY AVENUE, TOWSON, MD 21204

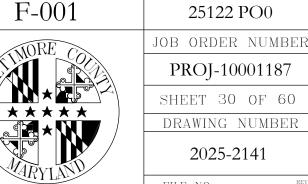


226 West Market Street, York, Pennsylvania 17401 717-848-8627 voice 717-843-2449 fax

CONTRACT NUMBER

ELECTION DIST. NO.: 9C6

BALTIMORE, MD 21230 P: 667-309-6036

www.**SETTY**com PROJECT NUMBER: SIPQ241913.03 SHEET DESIGNATION

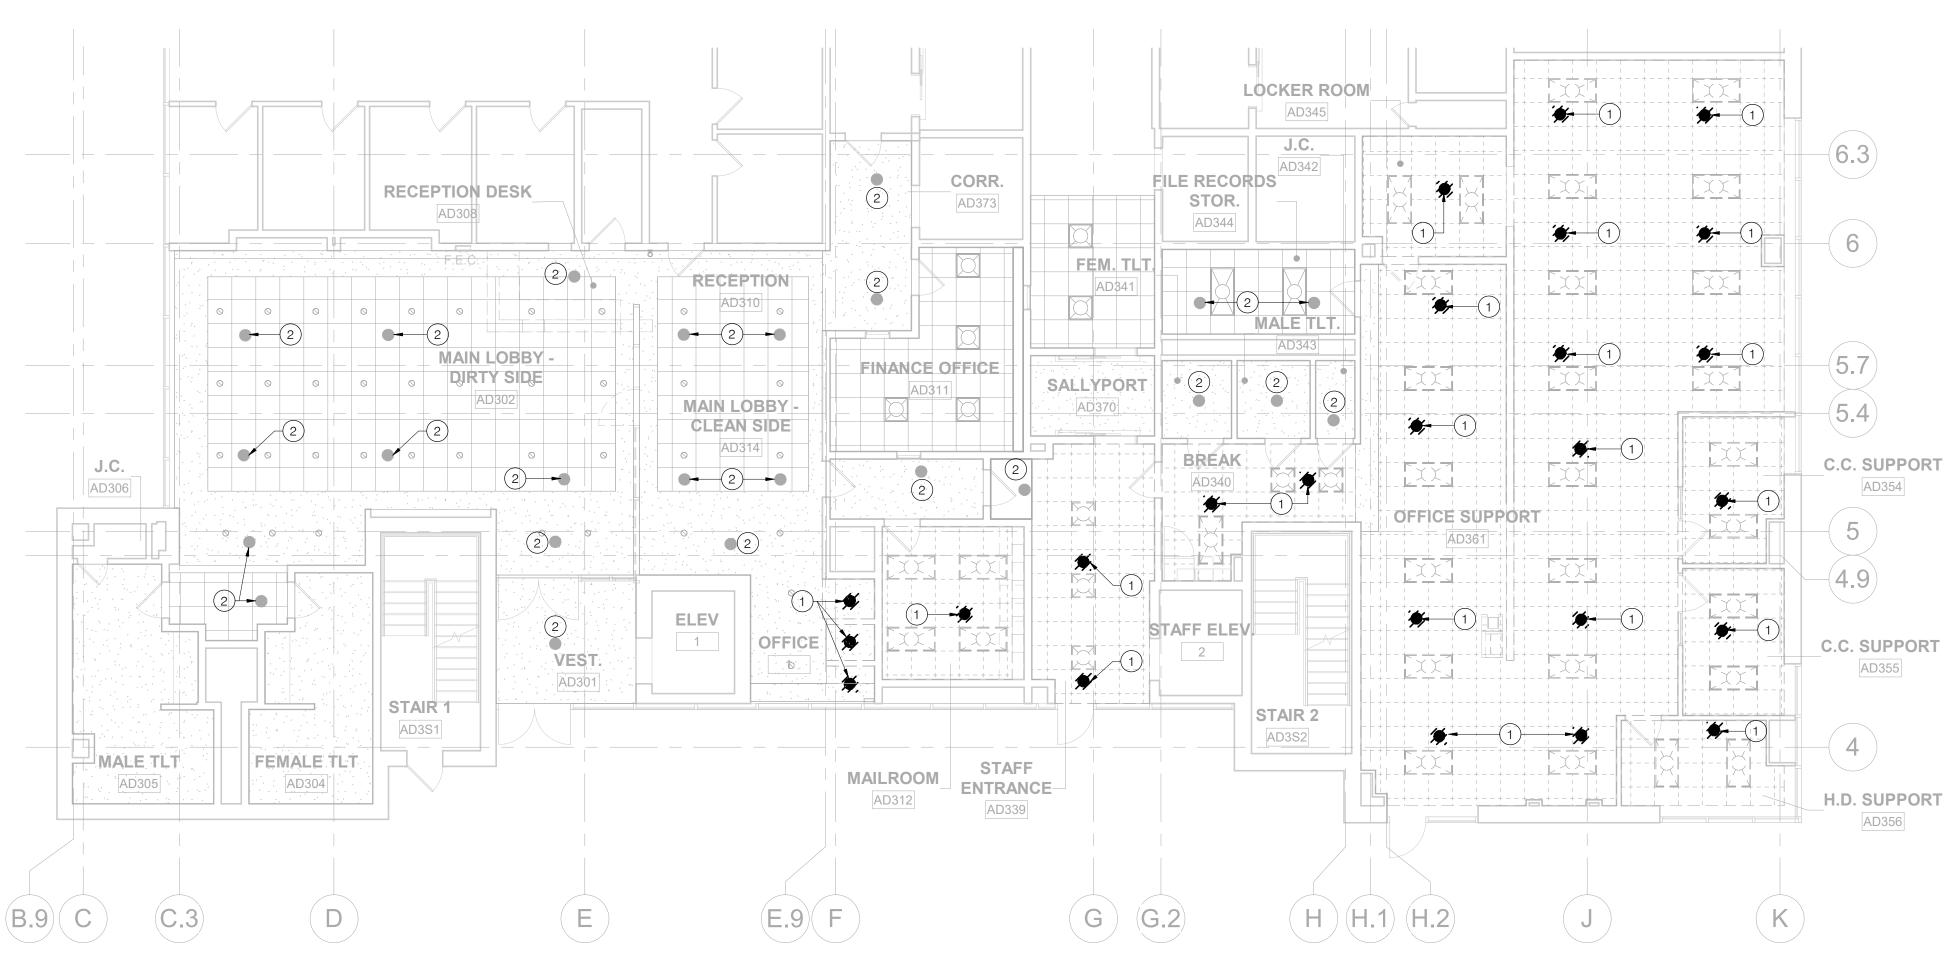

KEY PLAN LEGEND

BALTIMORE, MD 21230 P: 667-309-6036

www.**SETTY**com

226 West Market Street, York, Pennsylvania 17401 717-848-8627 voice 717-843-2449 fax

SHEET DESIGNATION PROJECT NUMBER: SIPQ241913.03

GENERAL NOTES

1. INFORMATION SHOWN ON DRAWING PERTAINING TO EXISTING CONDITIONS HAS BEEN OBTAINED FROM AVAILABLE BUILDING DRAWINGS OR GENERAL FIELD OBSERVATIONS AND MAY NOT INDICATE EXISTING CONDITIONS IN DETAIL OR DIMENSION. DETERMINE EXISTING CONDITIONS PRIOR TO FABRICATION OR PERFORMANCE OF ANY WORK. SHOULD CONDITIONS BE DISCOVERED THAT PREVENT EXECUTION OF THE WORK AS

INDICATED, IMMEDIATELY NOTIFY THE ARCHITECT/ ENGINEER IN WRITING AND AWAIT DIRECTION BEFORE PROCEEDING WITH THE

2. CONTRACTOR IS RESPONSIBLE TO PROTECT THE EXISTING ITEMS TO REMAIN AND RESTORE THE UTILITIES BACK TO THEIR ORIGINAL

FUNCTION. CONTRACTOR SHALL BE RESPONSIBLE FOR REPAIR

3. MODIFY EXISTING SPRINKLER SYSTEM SERVING THE RENOVATED AREA. PROVIDE NEW SPRINKLER HEADS IN ALL AREAS WITH PROPER SPRINKLER COVERAGE. LOCATIONS SHALL BE DESIGNED BY THE SPRINKLER CONTRACTOR IN ACCORDANCE WITH NFPA 13

AND THE OWNER'S INSURANCE CARRIER'S HAZARD OCCUPANCY

DIFFUSER AND ALL OTHER TRADES. SPRINKLER HEADS SHALL BE

THE AREA OF WORK TO REMAIN UNTOUCHED. THESE SPRINKLERS

DURING WORK. FOR ALL PERIODS OF SYSTEM DEACTIVATION, FIRE WATCH OR ALTERNATIVE PROTECTION METHOD APPROVED BY THE

4. ALL EXISTING SPRINKLERS NOT SHOWN IN THE PLAN/ OUTSIDE

SHALL BE MAINTAINED IN SERVICE TO THE EXTENT PRACTICAL

DEMOLITION KEY NOTES

1. REMOVE EXISTING SPRINKLER HEAD, CUT AND CAP THE BRANCH PIPE AND PREPARE FOR NEW WORK TO MATCH NEW LAYOUT.

CONTRACTOR TO FIELD VERIFY THE EXACT LOCATION.

REQUIREMENTS. COORDINATE HEAD LOCATIONS WITH EQUIPMENT, LIGHTING, FURNITURE, SUPPLY AND RETURN

LOCATED IN CENTER OF CEILING TILES.

AHJ SHALL BE IMPLEMENTED.

2. EXISTING SPRINKLER HEAD TO REMAIN.

AND REPLACEMENT OF ANY DAMAGED EQUIPMENT.

25122 PO0

CONTRACT NUMBER

JOB ORDER NUMBER

PROJ-10001187 SHEET 31 OF 60 DRAWING NUMBER 2025-2142

LEVEL 3 FLOOR PLAN - FIRE PROTECTION DEMOLITION


720 BOSLEY AVENUE, TOWSON, MD 21204

BCDC LOBBY RENOVATIONS

BALTIMORE COUNTY OFFICE OF BUDGET AND FINANCE - PROPERTY MANAGEMENT


RENOVATION

ELECTION DIST. NO.: 9C6

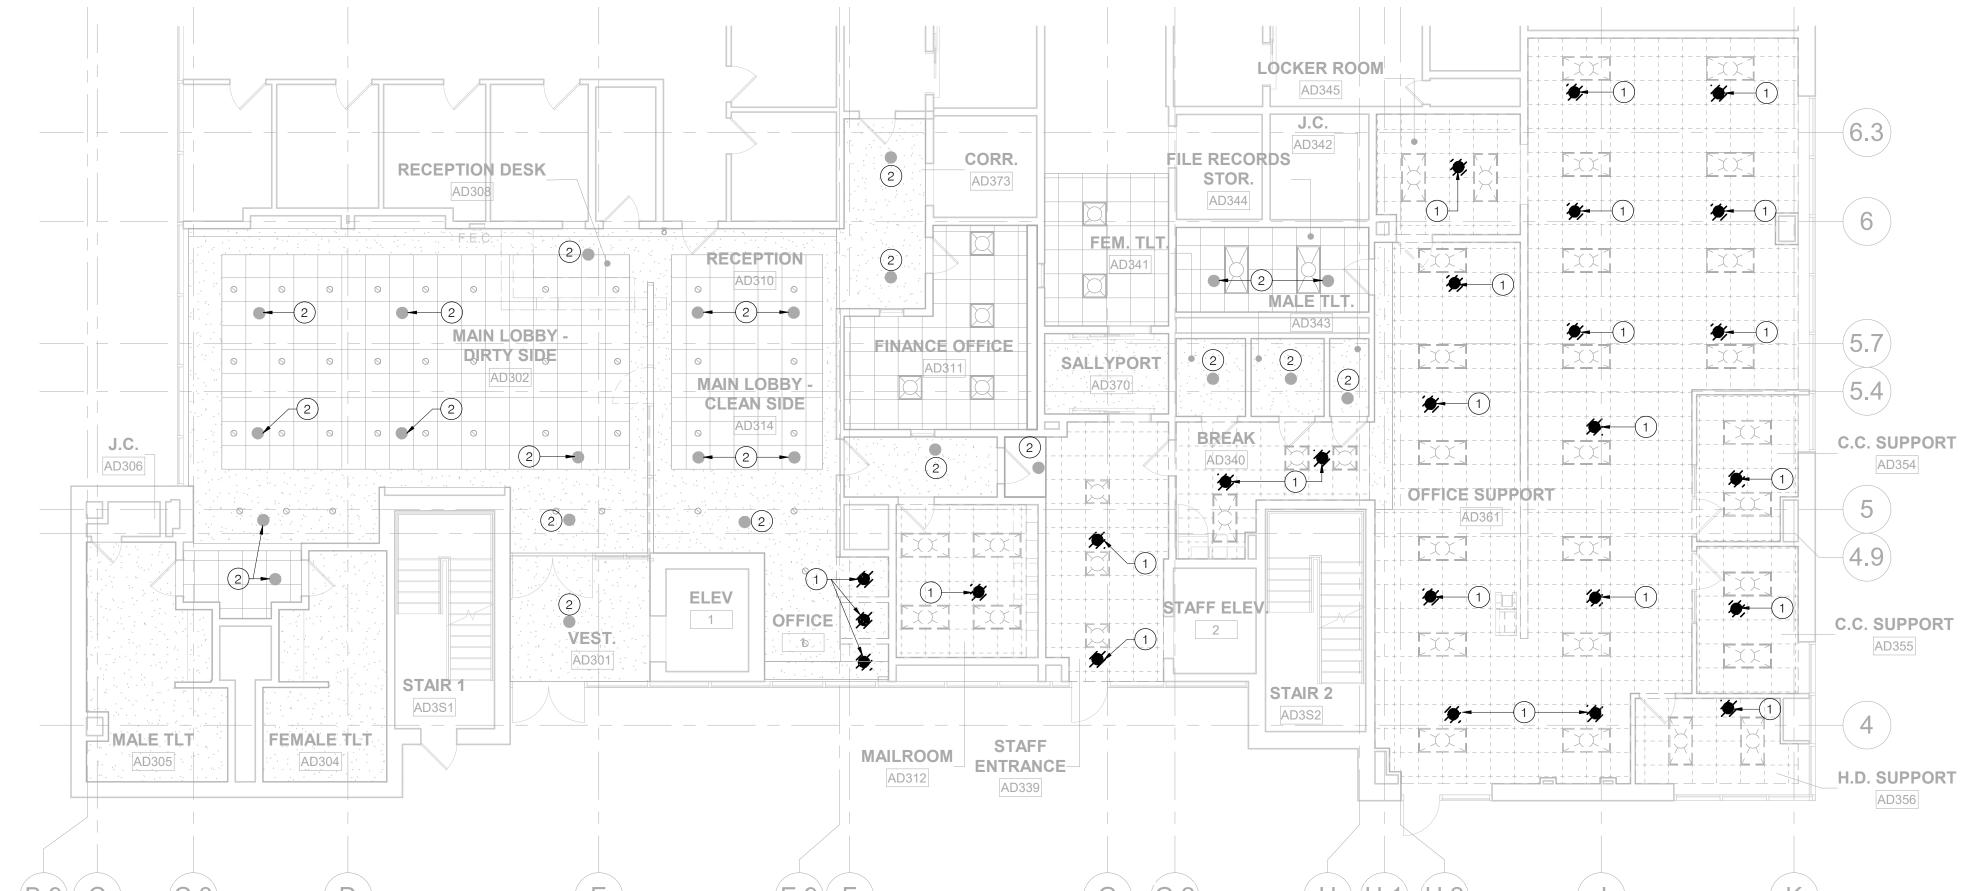






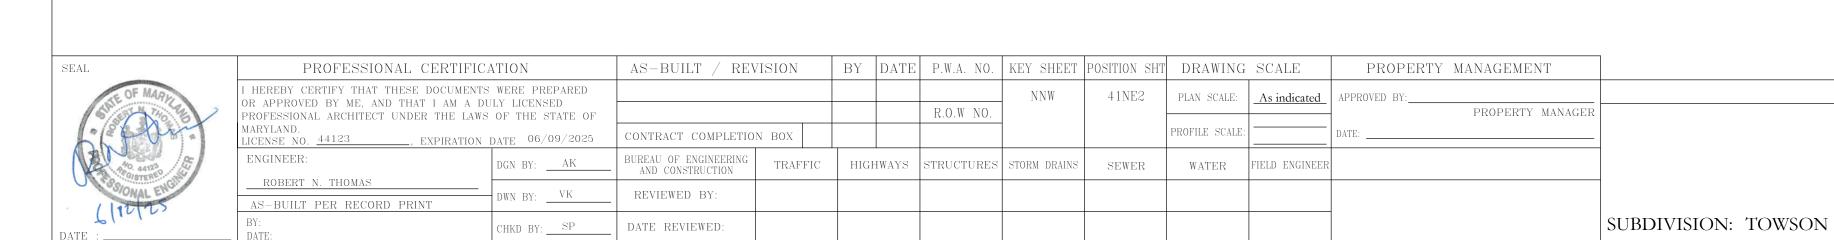

ORIGINAL DRAWING SIZE IS 24"x 36"; SCALE ENTITIES ACCORDINGLY IF REDUCED/ENLARGED

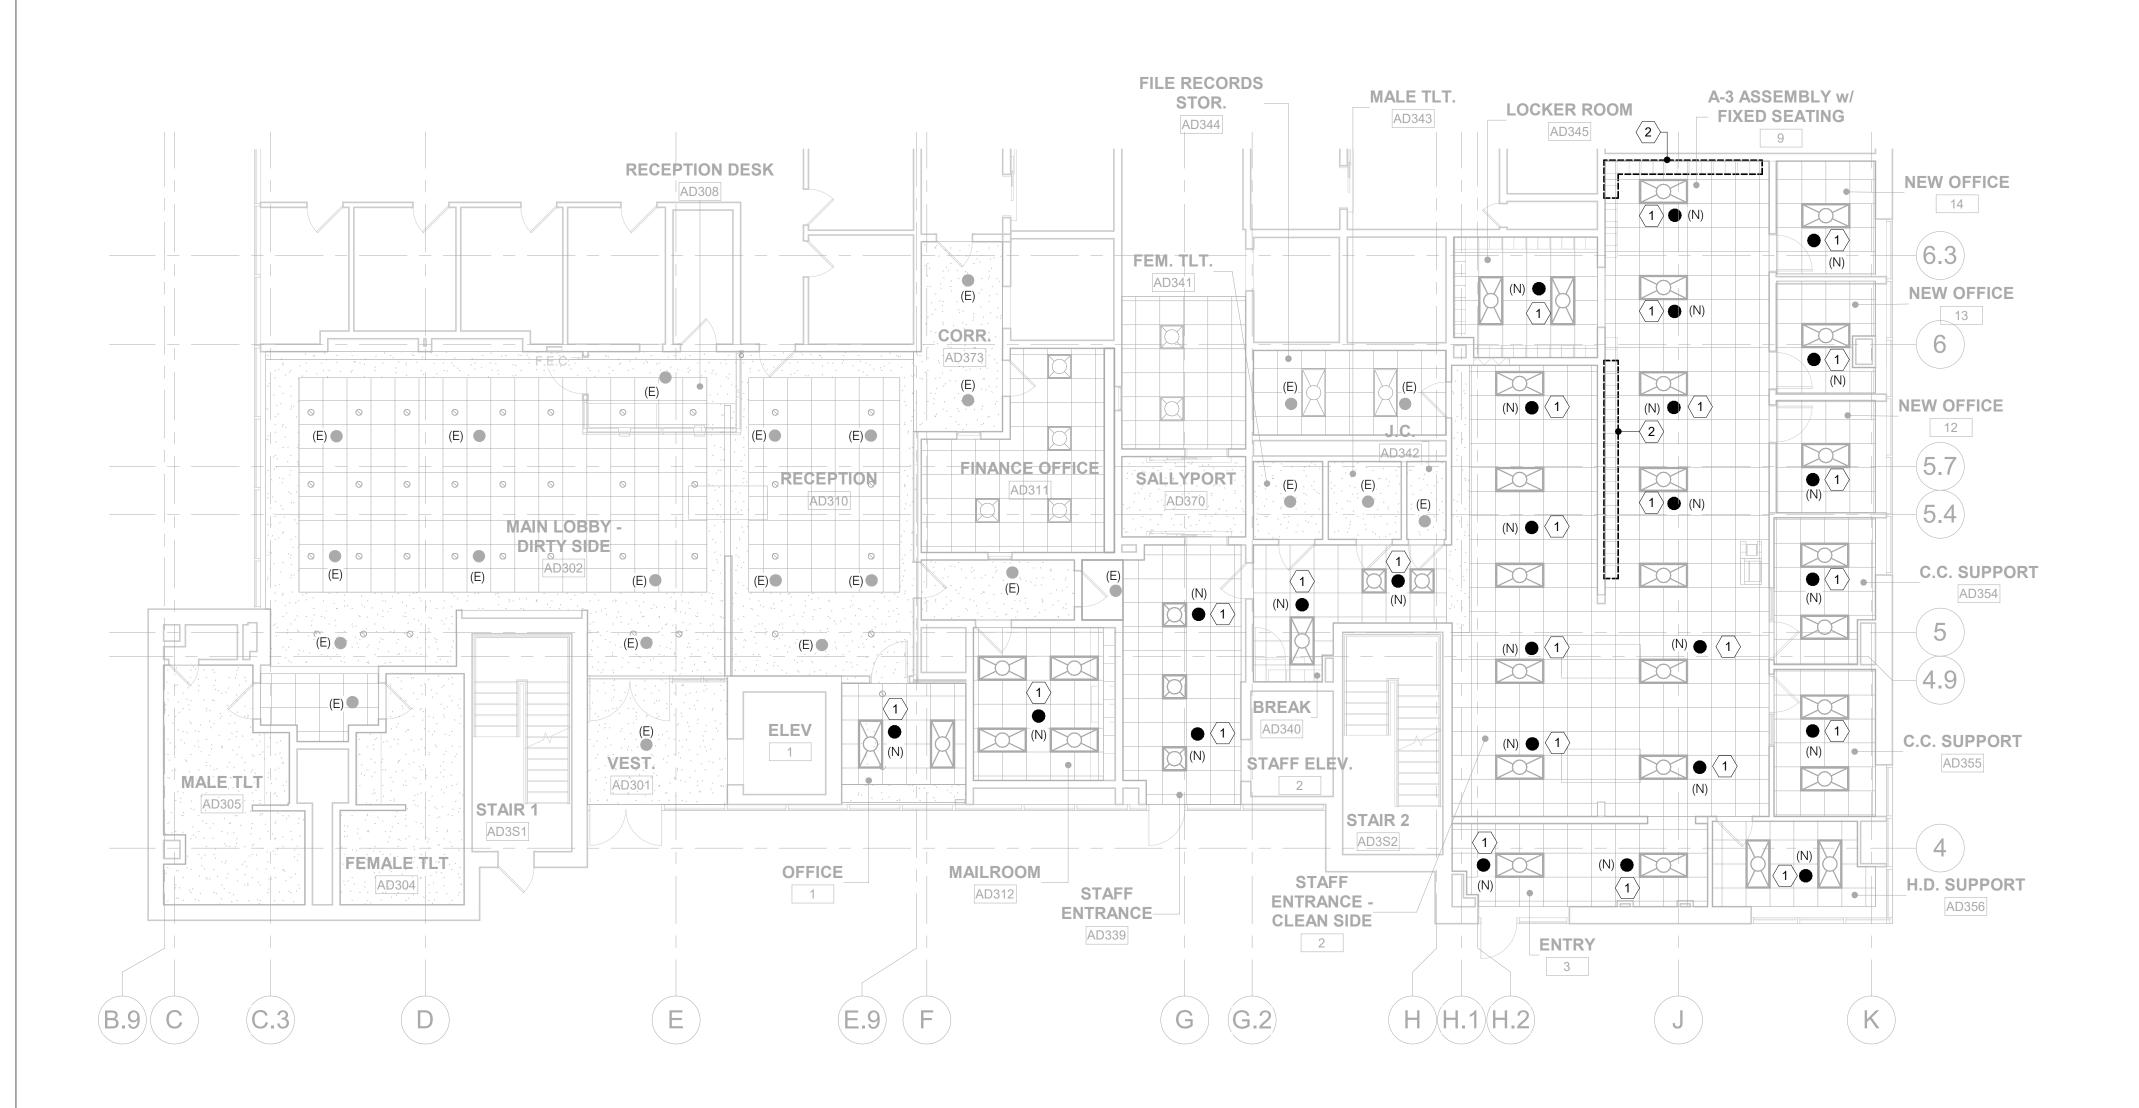



PROFESSIONAL CERTIFICATION

R APPROVED BY ME, AND THAT I AM A DULY LICENSED


HEREBY CERTIFY THAT THESE DOCUMENTS WERE PREPARED

SEAL



PROPERTY MANAGEMENT

PROPERTY MANAGER

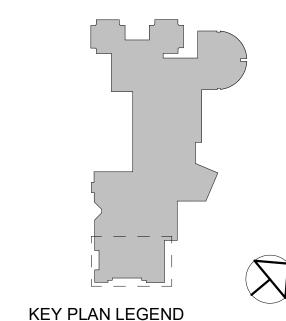

BALTIMORE, MD 21230 P: 667-309-6036

www.**SETTY**com

PROJECT NUMBER: SIPQ241913.03

226 West Market Street, York, Pennsylvania 17401 717-848-8627 voice 717-843-2449 fax SHEET DESIGNATION CONTRACT NUMBER

F-100

GENERAL NOTES

1. INFORMATION SHOWN ON DRAWING PERTAINING TO EXISTING

CONDITIONS HAS BEEN OBTAINED FROM AVAILABLE BUILDING

DRAWINGS OR GENERAL FIELD OBSERVATIONS AND MAY NOT

DETERMINE EXISTING CONDITIONS PRIOR TO FABRICATION OR PERFORMANCE OF ANY WORK. SHOULD CONDITIONS BE

INDICATED, IMMEDIATELY NOTIFY THE ARCHITECT/ ENGINEER IN WRITING AND AWAIT DIRECTION BEFORE PROCEEDING WITH THE

2. CONTRACTOR IS RESPONSIBLE TO PROTECT THE EXISTING ITEMS

3. MODIFY EXISTING SPRINKLER SYSTEM SERVING THE RENOVATED AREA. PROVIDE NEW SPRINKLER HEADS IN ALL AREAS WITH PROPER SPRINKLER COVERAGE. LOCATIONS SHALL BE DESIGNED

BY THE SPRINKLER CONTRACTOR IN ACCORDANCE WITH NFPA 13 AND THE OWNER'S INSURANCE CARRIER'S HAZARD OCCUPANCY

AND REPLACEMENT OF ANY DAMAGED EQUIPMENT.

REQUIREMENTS. COORDINATE HEAD LOCATIONS WITH

LOCATED IN CENTER OF CEILING TILES.

AHJ SHALL BE IMPLEMENTED.

EQUIPMENT, LIGHTING, FURNITURE, SUPPLY AND RETURN DIFFUSER AND ALL OTHER TRADES. SPRINKLER HEADS SHALL BE

4. ALL EXISTING SPRINKLERS NOT SHOWN IN THE PLAN/ OUTSIDE

SHALL BE MAINTAINED IN SERVICE TO THE EXTENT PRACTICAL DURING WORK. FOR ALL PERIODS OF SYSTEM DEACTIVATION, FIRE

SHEET KEY NOTES

1. INSTALL NEW PENDENT SPRINKLER HEAD & CONNECT TO EXISTING SPRINKLER PIPING. MODIFY EXISTING BRANCH PIPING AND EXTEND TO THE NEW LOCATION OF SPRINKLER AS NECESSARY.

CONTRACTOR IS RESPONSIBLE TO FIELD VERIFY AND COORDINATE

EXACT LOCATION OF SPRINKLER AND PIPE ROUTING WITH OTHER

TRADES PRIOR TO INSTALLATION. SPRINKLER HEAD SHALL BE

FULLY COORDINATED WITH STRUCTURE AND MEP TO PROVIDE UNOBSTRUCTED PROTECTION IN AREA AND SPRINKLER HEADS

2. NO STORAGE ON TOP OF LOCKERS PERMITTED TO MAINTAIN MINIMUM 18" DISTANCE BETWEEN STORAGE AND SPRINKLERS.

SHALL BE LOCATED IN CENTER OF CEILING TILES.

THE AREA OF WORK TO REMAIN UNTOUCHED. THESE SPRINKLERS

WATCH OR ALTERNATIVE PROTECTION METHOD APPROVED BY THE

TO REMAIN AND RESTORE THE UTILITIES BACK TO THEIR ORIGINAL FUNCTION. CONTRACTOR SHALL BE RESPONSIBLE FOR REPAIR

INDICATE EXISTING CONDITIONS IN DETAIL OR DIMENSION.

DISCOVERED THAT PREVENT EXECUTION OF THE WORK AS

25122 PO0

JOB ORDER NUMBER PROJ-10001187 SHEET 32 OF 60 DRAWING NUMBER

2025-2143

BALTIMORE COUNTY OFFICE OF BUDGET AND FINANCE - PROPERTY MANAGEMENT BCDC LOBBY RENOVATIONS

LEVEL 3 FLOOR PLAN - FIRE PROTECTION

RENOVATION

720 BOSLEY AVENUE, TOWSON, MD 21204

ELECTION DIST. NO.: 9C6

R.O.W NO.


BY DATE P.W.A. NO. KEY SHEET POSITION SHT DRAWING SCALE


41NE2

PLAN SCALE: As indicated

AS-BUILT / REVISION

ORIGINAL DRAWING SIZE IS 24"x 36"; SCALE ENTITIES ACCORDINGLY IF REDUCED/ENLARGED

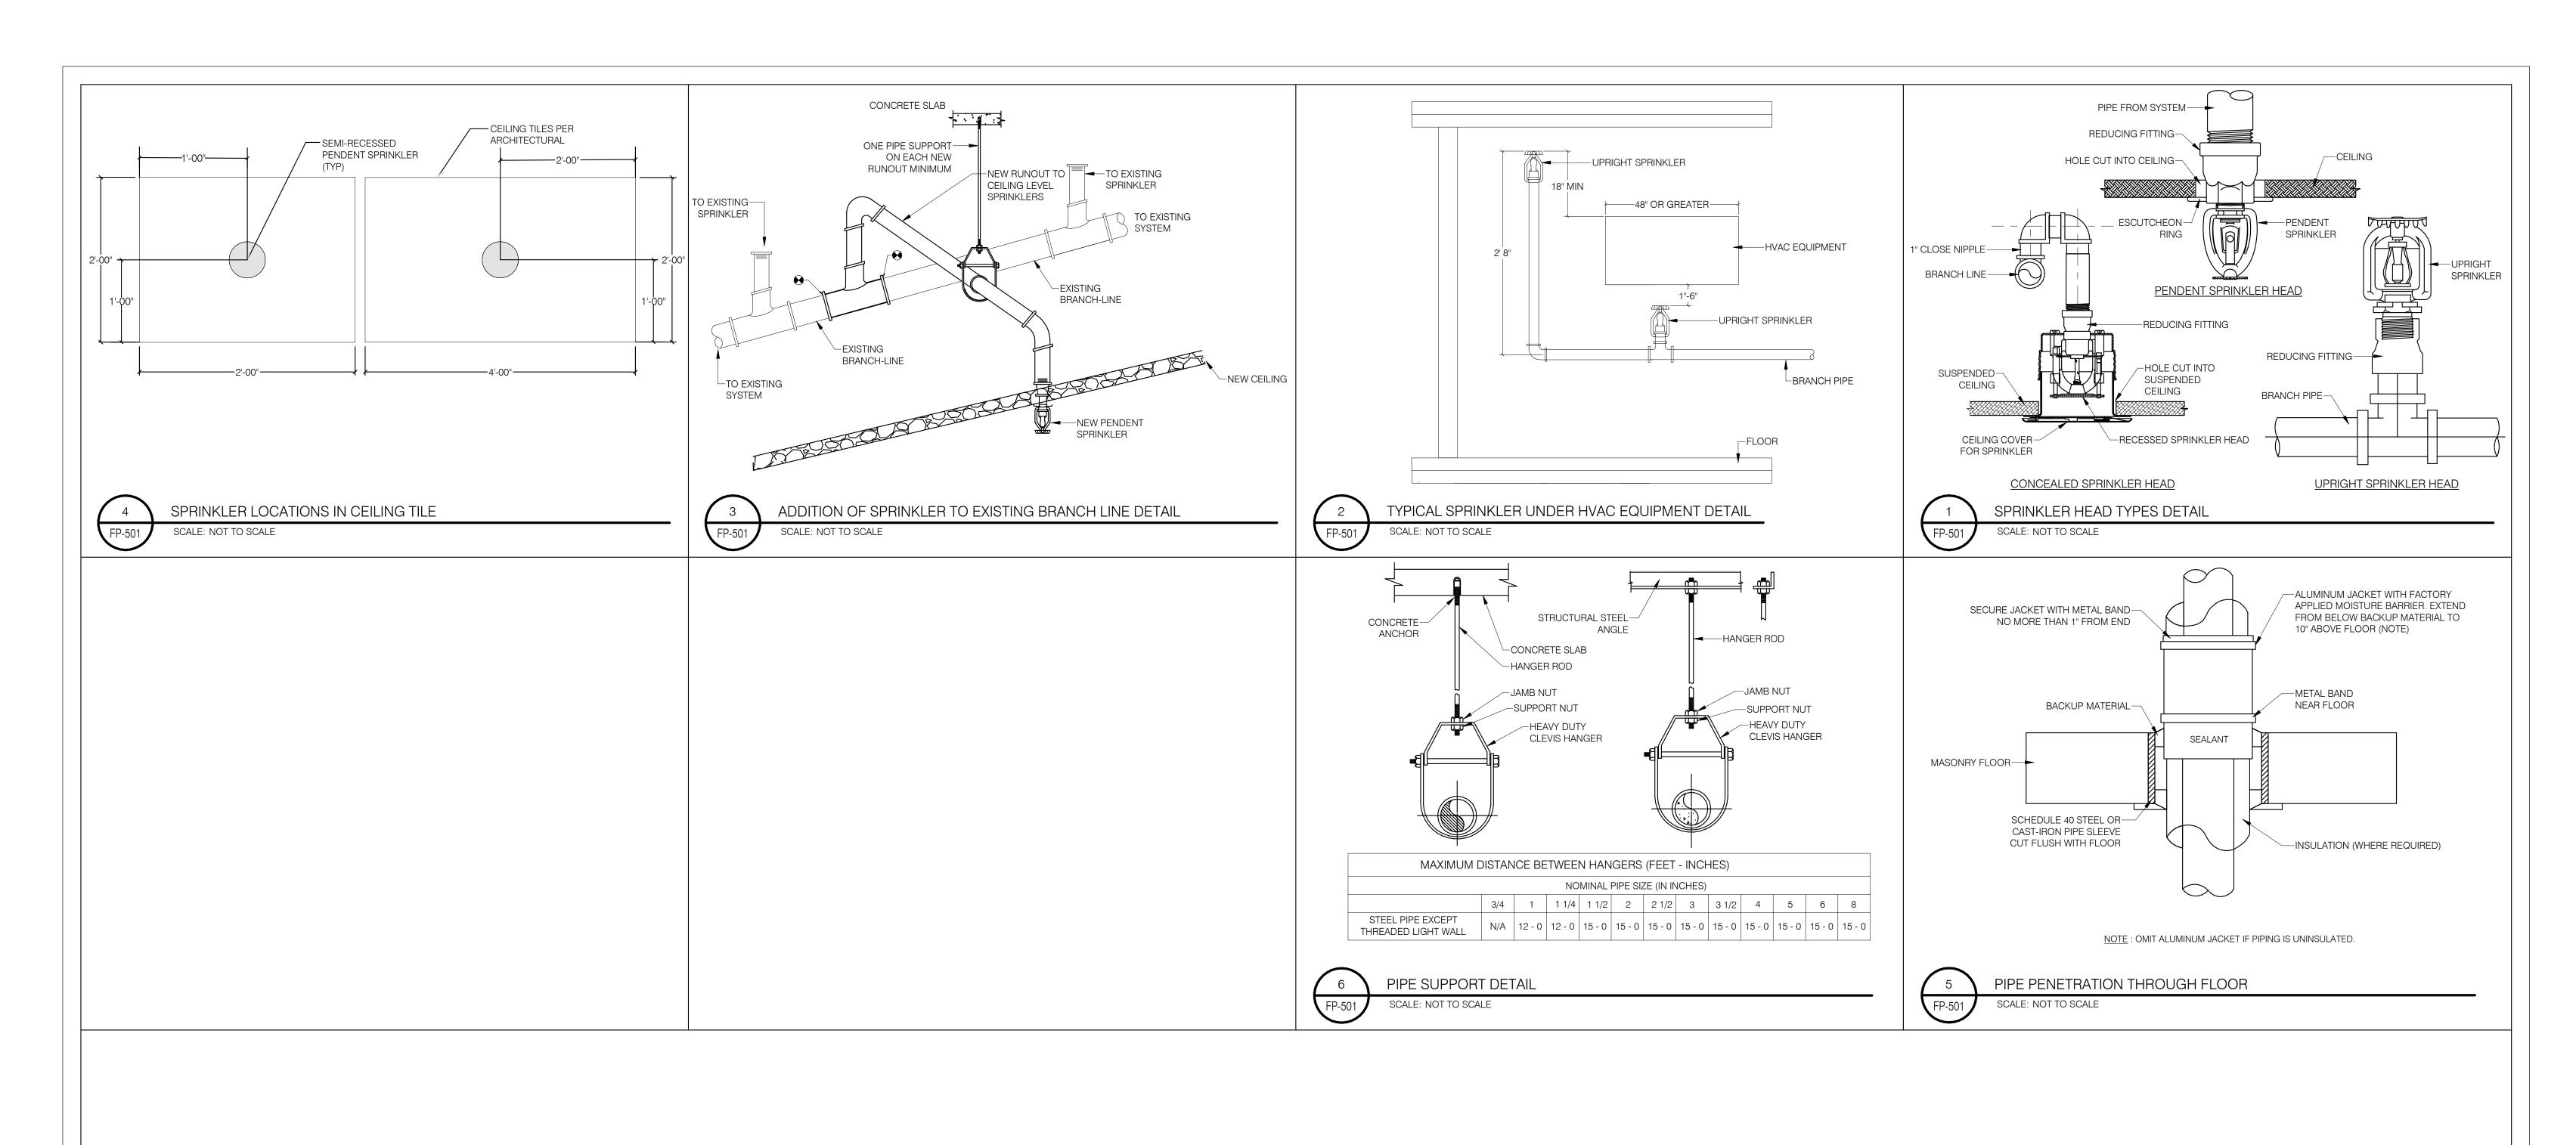

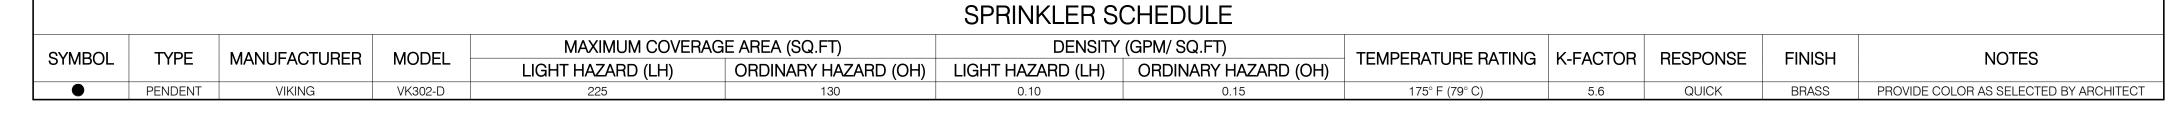


BY DATE P.W.A. NO. KEY SHEET POSITION SHT DRAWING SCALE

R.O.W NO.

41NE2

PLAN SCALE:

NTS

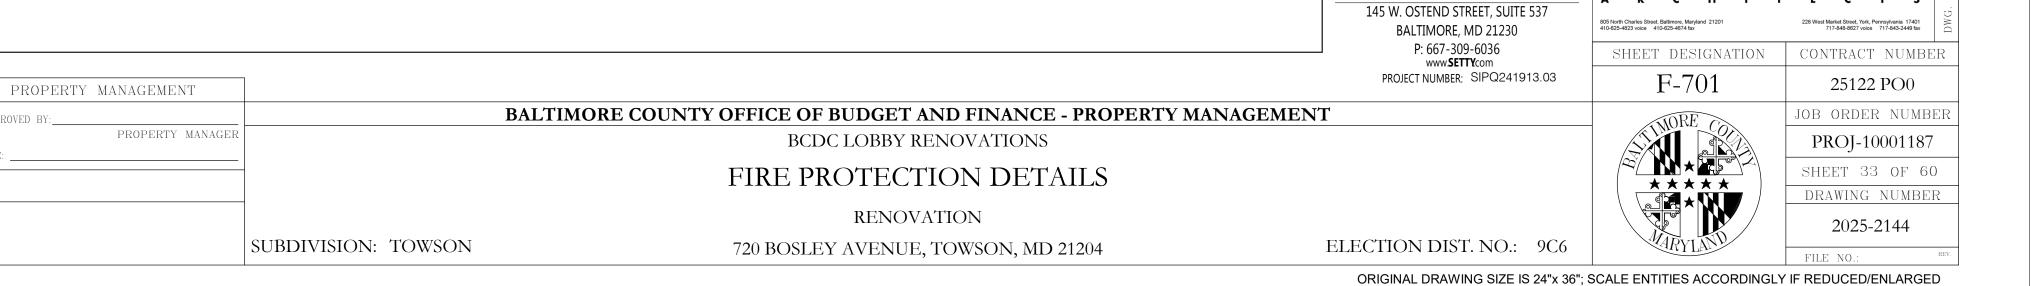

AS-BUILT / REVISION

PROFESSIONAL CERTIFICATION

R APPROVED BY ME, AND THAT I AM A DULY LICENSED

HEREBY CERTIFY THAT THESE DOCUMENTS WERE PREPARED

LOW VOLTAGE SYSTEMS SYMBOL LEGEND

SYMBOL:	DESCRIPTION:	BACKBOX:	CONDUITS:	MOUNTING HEIGHT:	ELECTRONICS:	TELECOM CABLE REQUIREMENTS:	POWER REQUIREMENTS:
D	FLAT PANEL DISPLAY	ONE (1) 2-GANG BOX WITH SINGLE GANG TRIM RING	ONE (1) 1" EC	126" AFF TO CENTER OF BACKBOX	OFOI FLAT PANEL DISPLAY	TWO (2) CATEGORY CABLES (OFOI)	120VAC DUPLEX RECEPTACLE
X	STANDARD TELECOMMUNICATION OUTLET	2-GANG BOX WITH SINGLE GANG TRIM RING	ONE (1) 1" EC	OUTLET HEIGHT	N/A	"X" CATEGORY CABLES (OFOI)	N/A
	FLOORBOX	WIREMOLD EFB8S	THREE (3) 1-1/4" EC	IN FLOOR	N/A	FOUR (4) CATEGORY CABLES (OFOI)	120VAC DUPLEX RECEPTACLE
WAP	WIRELESS ACCESS POINT	SURFACE MOUNTED BISCUIT BOX	N/A	CEILING MOUNTED	OFOI WIRELESS ACCESS POINT	TWO (2) CATEGORY CABLES (OFOI)	REMOTE LOW VOLTAGE POWER
	RATED PASS-THRU ASSEMBLY	N/A	N/A	ABOVE ACCESSIBLE CEILING	N/A	N/A	N/A
D #	ELECTRONIC ACCESS CONTROL DOOR	REFER TO ACCESS CONTROL DOOR DETAILS	REFER TO ACCESS CONTROL DOOR DETAILS	REFER TO ACCESS CONTROL DOOR DETAILS	REFER TO ACCESS CONTROL DOOR DETAILS	N/A	REMOTE LOW VOLTAGE POWER
CR	CARD READER	2-GANG BOX WITH SINGLE GANG TRIM RING	ONE (1) 1" EC	REFER TO ACCESS CONTROL DOOR DETAILS	OFOI CARD READER	N/A	REMOTE LOW VOLTAGE POWER
DR	DOOR RELEASE BUTTON	2-GANG BOX WITH SINGLE GANG TRIM RING	ONE (1) 1" EC	OUTLET HEIGHT	OFOI DOOR RELEASE BUTTON	N/A	N/A
\bigcirc	FIXED SURVEILLANCE VIDEO CAMERA CEILING MOUNTED	SURFACE MOUNTED BISCUIT BOX	N/A	CEILING MOUNTED	OFOI FIXED VIDEO CAMERA	ONE (1) CATEGORY CABLE (OFOI)	REMOTE LOW VOLTAGE POWER
$\stackrel{W}{\bigcirc}$	FIXED SURVEILLANCE VIDEO CAMERA WALL MOUNTED	2-GANG BOX WITH SINGLE GANG TRIM RING	ONE (1) 1" EC	9' AFF	OFOI FIXED VIDEO CAMERA	ONE (1) CATEGORY CABLE (OFOI)	REMOTE LOW VOLTAGE POWER
$\stackrel{E}{(C)}\!$	EXTERIOR SURVEILLANCE VIDEO CAMERA	2-GANG BOX INTERIOR TO BUILDING	ONE (1) 1" EC	9' AFF	OFOI FIXED VIDEO CAMERA	ONE (1) CATEGORY CABLE (OFOI)	REMOTE LOW VOLTAGE POWER

LOW VOLTAGE SYSTEM SHEET LIST

	LOVV VOLTAGE OTOTENTOTILET LIGT								
Sheet Number	Sheet Name								
TA001	LOW VOLTAGE SYSTEMS TITLESHEET								
TA002	LOW VOLTAGE RESPONSIBILITIES MATRIX								
TA100	LOW VOLTAGE FLOOR PLAN								
TA120	LOW VOLTAGE REFLECTED CEILING PLAN								
TA200	FLAT PANEL DISPLAY ELEVATION DETAILS								
TA500	LOW VOLTAGE SYSTEMS INFRASTRUCTURE DETAILS (1 OF 2)								
TA501	LOW VOLTAGE SYSTEMS INFRASTRUCTURE DETAILS (2 OF 2)								
TA510	ELECTRONIC ACCESS CONTROL DOORS								

TA SERIES SHEET NOTES

- ALL CONDUIT, BACK BOXES, AND AC POWER REQUIREMENTS SHALL BE PROVIDED BY THE ELECTRICAL CONTRACTOR.
- 2. ANY CONDUIT TERMINATIONS AT CONSOLE OR EQUIPMENT RACK LOCATIONS SHOULD BE ACCESSIBLE.
- 3. EACH LOW VOLTAGE OUTLET SHALL INCLUDE A 200lb TEST PULL WIRE TO ACCESSIBLE AFC OR CABLE TRAY UNLESS OTHERWISE NOTED.
- 4. REFERENCE ELECTRICAL DIVISION 26 00 00 SPECIFICATION FOR CONDUIT SPECIFICATIONS.
- 5. COORDINATE CEILING MOUNTED ELEMENTS WITH ARCHITECTURAL CEILING PLANS.
- 6. REFERENCE ARCHITECTURAL DRAWINGS FOR ALL BOX LOCATIONS AND DIMENSIONS.
- 7. ALL TELECOM CONDUITS ARE TO RUN FROM BACK BOX TO ACCESSIBLE AFC UNLESS DETAILED OTHERWISE.
- 8. NOTES ON INDIVIDUAL DRAWING SHEETS SUPERSEDE THE ABOVE REQUIREMENTS.

ABBREVIATIONS

AFF = ABOVE FINISHED FLOOR

EC = ELECTRICAL CONDUIT N/A = NOT APPLICABLE

OFOI = OWNER FURNISHED & OWNER INSTALLED

AS-BUILT / REVISION BY DATE P.W.A. NO. KEY SHEET POSITION SHT DRAWING SCALE PROFESSIONAL CERTIFICATION PROPERTY MANAGEMENT SEAL HEREBY CERTIFY THAT THESE DOCUMENTS WERE PREPARED 41NE2 PLAN SCALE: As indicated OR APPROVED BY ME, AND THAT I AM A DULY LICENSED R.O.W NO. PROPERTY MANAGER PROFESSIONAL ARCHITECT UNDER THE LAWS OF THE STATE OF MARYLAND. PROFILE SCALE: CONTRACT COMPLETION BOX ICENSE NO. BUREAU OF ENGINEERING AND CONSTRUCTION TRAFFIC HIGHWAYS STRUCTURES STORM DRAINS SEWER ARCHITECT: WATER FIELD ENGINEE AS-BUILT PER RECORD PRINT DATE REVIEWED:

BALTIMORE COUNTY OFFICE OF BUDGET AND FINANCE - PROPERTY MANAGEMENT


BCDC LOBBY RENOVATIONS

SUBDIVISION: TOWSON

LOW VOLTAGE SYSTEMS TITLESHEET

RENOVATION
720 BOSLEY AVENUE, TOWSON, MD 21204

ELECTION DIST. NO.: 9C6

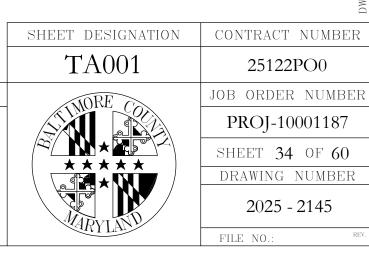

DWG. FILENAME: C:\Users\

LOW VOLTAGE SYSTEMS RESPONSIBILITIES MATRIX

	ITEM	FURNISHED BY	INSTALLED BY	NOTES
1	RECESSED ELECTRICAL JUNCTION WALL BOXES, CONDUIT, FITTINGS, BUSHINGS, RACEWAYS, BONDING, MULTIMEDIA CONNECTION WALL BOXES AND FLOOR BOXES	GC	GC	TO BE INSTALLED BY SUB-CONTRACTOR AT DISCRESSION OF GC
2	AC POWER RECEPTACLES & RELATED EQUIPMENT	GC	GC	TO BE INSTALLED BY SUB-CONTRACTOR AT DISCRESSION OF GC
3	TELECOMM STRUCTURED CABLING & RELATED HARDWARE	OWNER	OWNER	
4	IN-WALL PLYWOOD BLOCKING FOR ALL FLAT PANEL DISPLAY LOCATIONS	GC	GC	TO BE INSTALLED BY SUB-CONTRACTOR AT DISCRESSION OF GC
5	AUDIOVISUAL SYSTEM EQUIPMENT	OWNER	OWNER	
6	WIRELESS PRESENTATION GATEWAY	OWNER	OWNER	
7	ALL AUDIOVISUAL CABLING TO INTERCONNECT DEVICES	OWNER	OWNER	
8	FLAT PANEL DISPLAY MOUNTS	OWNER	OWNER	
9	NETWORK ELECTRONICS AND PROGRAMMING	OWNER	OWNER	
10	ELECTRONIC ACCESS CONTROL SYSTEM	OWNER	OWNER	
11	VIDEO SURVEILLANCE SYSTEM CAMERA AND ELECTRONICS.	OWNER	OWNER	

SUBDIVISION: TOWSON

	ABBREVIATIONS
OWNER	BALTIMORE COUNTY GOVERNMENT
GC	GENERAL CONTRACTOR

	PROFESSIONAL CERTIFICATION		AS-BUILT / REV	ISION	BY DATE	P.W.A. NO.	KEY SHEET	POSITION SHT	DRAWING	SCALE	PROPERTY M	ANAGEMENT
	I HEREBY CERTIFY THAT THESE DOCUMENTS WERE PREPARED OR APPROVED BY ME, AND THAT I AM A DULY LICENSED PROFESSIONAL ARCHITECT UNDER THE LAWS OF THE STATE OF MARYLAND. LICENSE NO, EXPIRATION DATE					R.O.W NO.	NNW	41NE2	PLAN SCALE:		APPROVED BY:	PROPERTY MANAGER
			CONTRACT COMPLETION BOX		10.0.11				PROFILE SCALE:		DATE:	
	ARCHITECT:	DGN BY: BW	BUREAU OF ENGINEERING AND CONSTRUCTION	TRAFFIC	HIGHWAYS	STRUCTURES	STORM DRAINS	SEWER	WATER	FIELD ENGINEER		
	AS-BUILT PER RECORD PRINT	DWN BY: JM	REVIEWED BY:									
	BY: DATE:	CHKD BY: BH	DATE REVIEWED:									

BALTIMORE COUNTY OFFICE OF BUDGET AND FINANCE - PROPERTY MANAGEMENT BCDC LOBBY RENOVATIONS


LOW VOLTAGE RESPONSIBILITIES MATRIX

RENOVATION

ELECTION DIST. NO.: 9C6 720 BOSLEY AVENUE, TOWSON, MD 21204

TA002
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SHEET DESIGNATION CONTRACT NUMBER 25122PO0 JOB ORDER NUMBER PROJ-10001187 SHEET **35** OF **60** DRAWING NUMBER 2025 - 2146

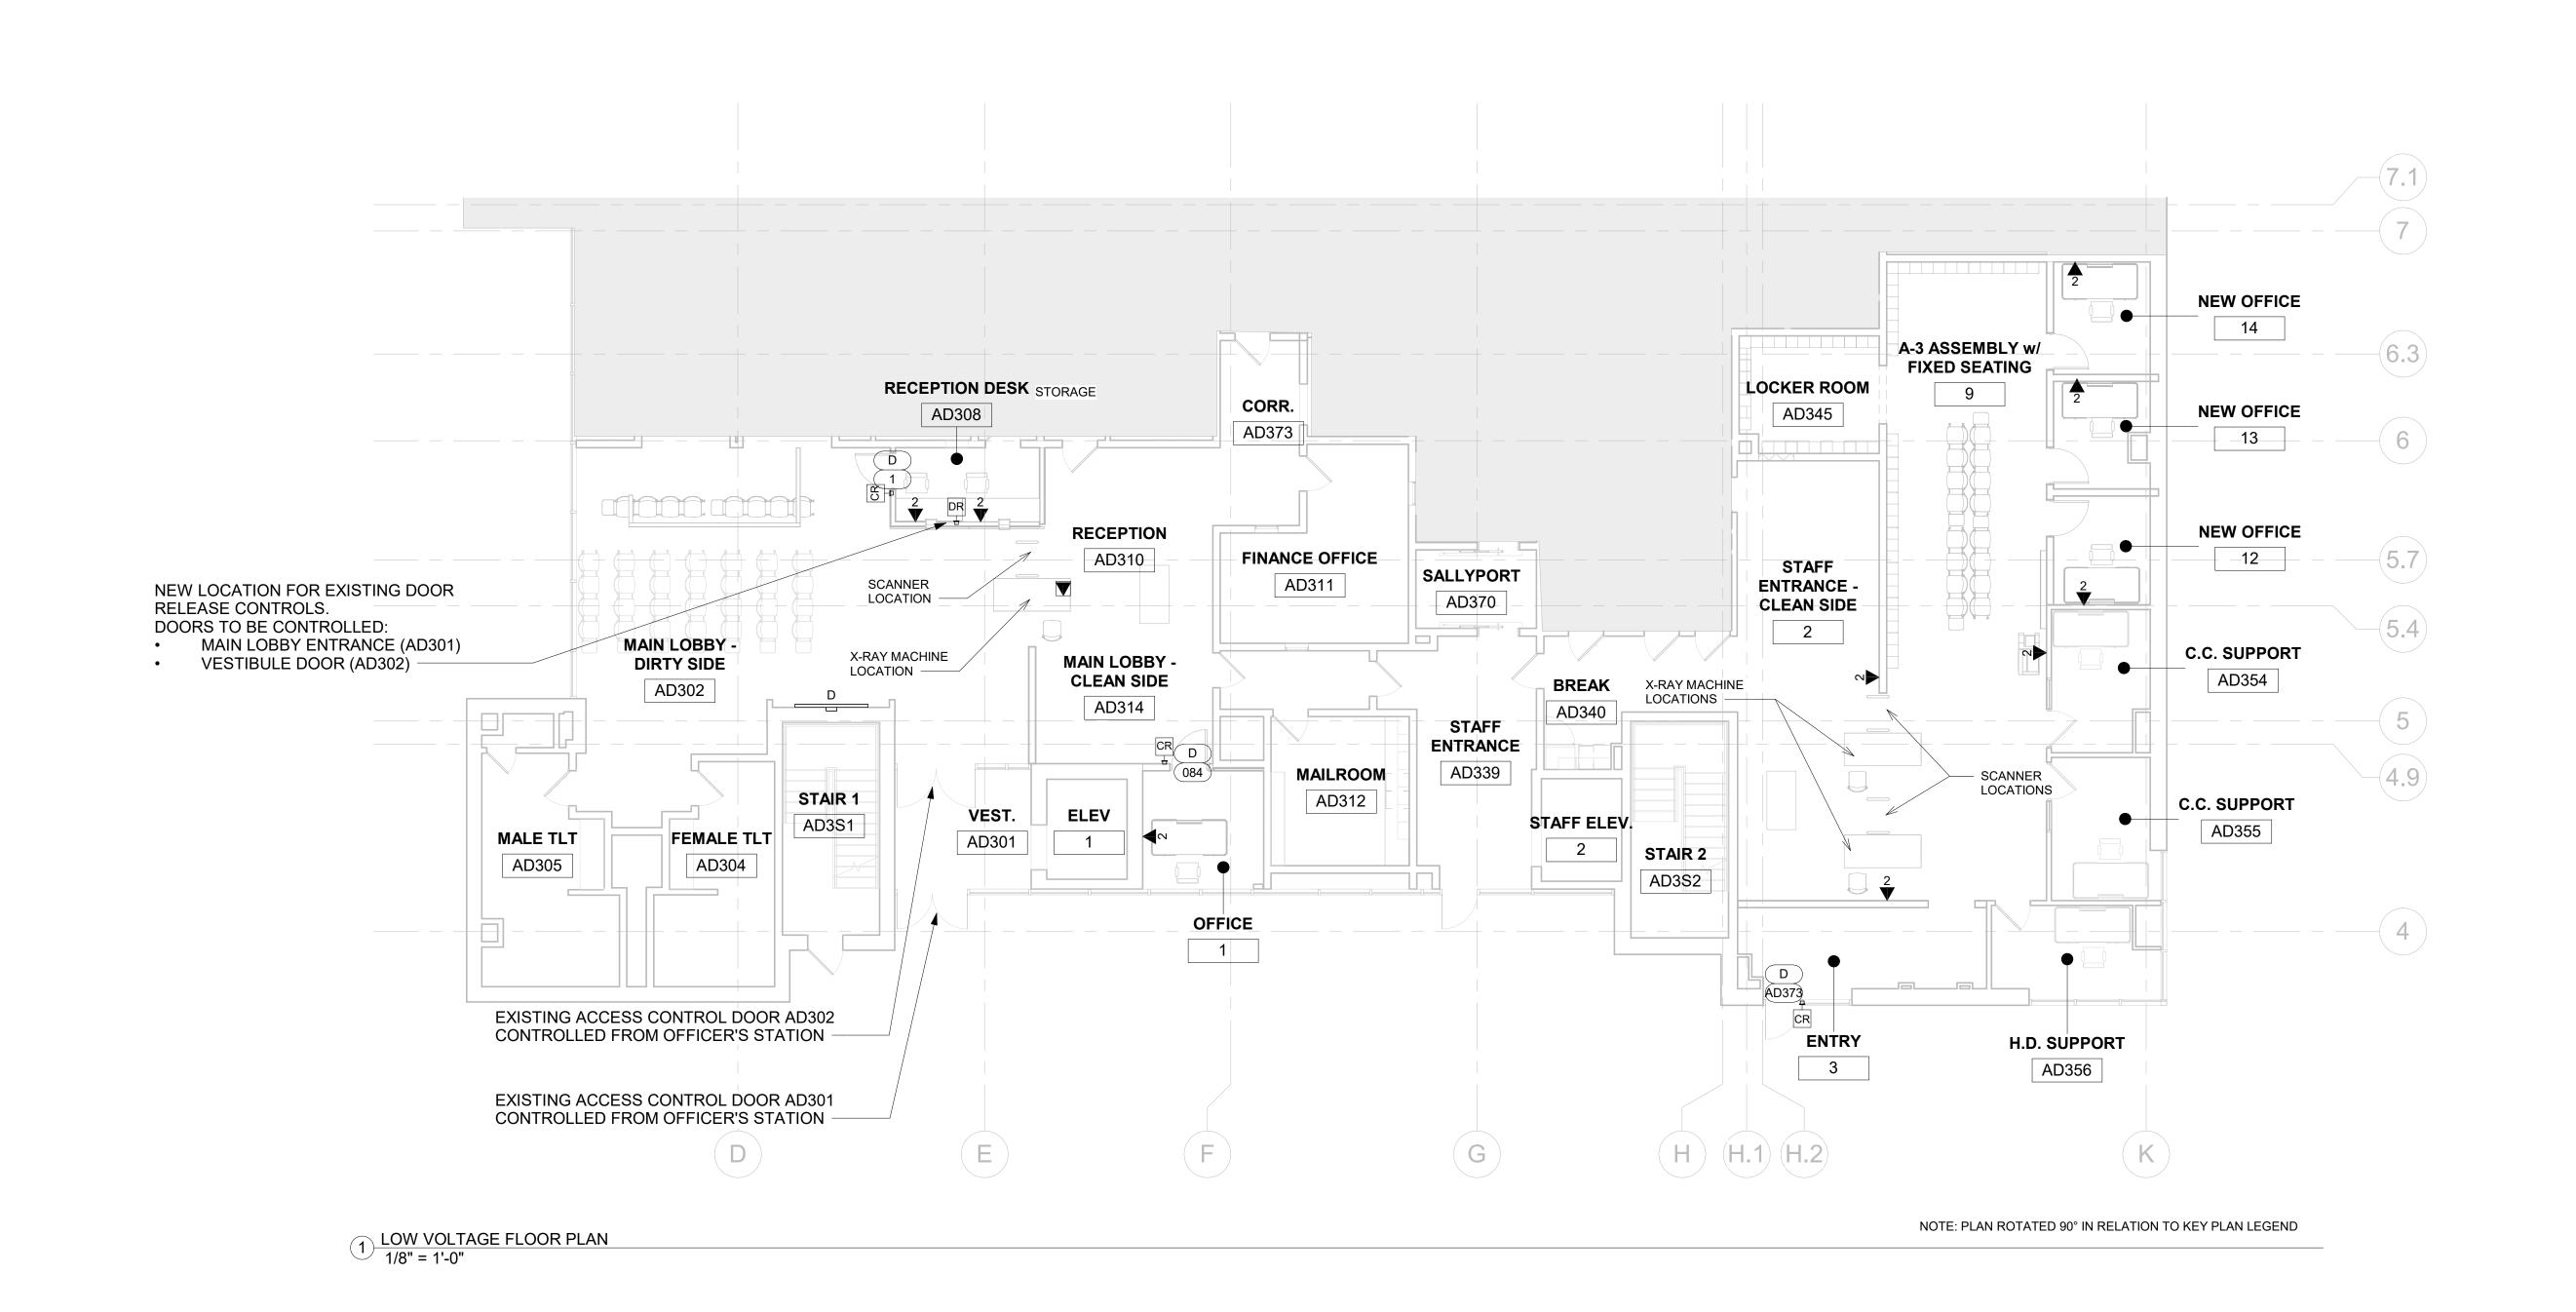

SUBDIVISION: TOWSON

KEY PLAN LEGEND

LEGEND	SHEET DESIGNATION
	TA100
	WORE CO

25122PO0 JOB ORDER NUMBER PROJ-10001187 SHEET 36 OF 60 DRAWING NUMBER 2025 - 2147

CONTRACT NUMBER

PROFESS	PROFESSIONAL CERTIFICATION		AS-BUILT / REV	ISION	BY	DATE	P.W.A. NO.	KEY SHEET	POSITION SHT	DRAWING	SCALE	PROPERTY MANAGEMENT	
I	I HEREBY CERTIFY THAT THESE DOCUMENTS WERE PREPARED OR APPROVED BY ME, AND THAT I AM A DULY LICENSED PROFESSIONAL ARCHITECT UNDER THE LAWS OF THE STATE OF								NNW	41NE2	PLAN SCALE:	As indicated	APPROVED BY:
· · · · · · · · · · · · · · · · · · ·								R.O.W NO.					PROPERTY MANAGER
MARYLAND. LICENSE NO.			CONTRACT COMPLETIO	N BOX						PROFILE SCALE:		DATE:	
ARCHITECT:		DGN BY:	BW	BUREAU OF ENGINEERING AND CONSTRUCTION	TRAF	FIC HIGI	HWAYS	STRUCTURES	STORM DRAINS	SEWER	WATER	FIELD ENGINEER	
AS-BUILT PER REC	ORD PRINT	DWN BY:	JM	REVIEWED BY:									
BY: DATE:		CHKD BY:	ВН	DATE REVIEWED:									


SEAL

LOW VOLTAGE FLOOR PLAN

RENOVATION 720 BOSLEY AVENUE, TOWSON, MD 21204

BALTIMORE COUNTY OFFICE OF BUDGET AND FINANCE - PROPERTY MANAGEMENT

BCDC LOBBY RENOVATIONS

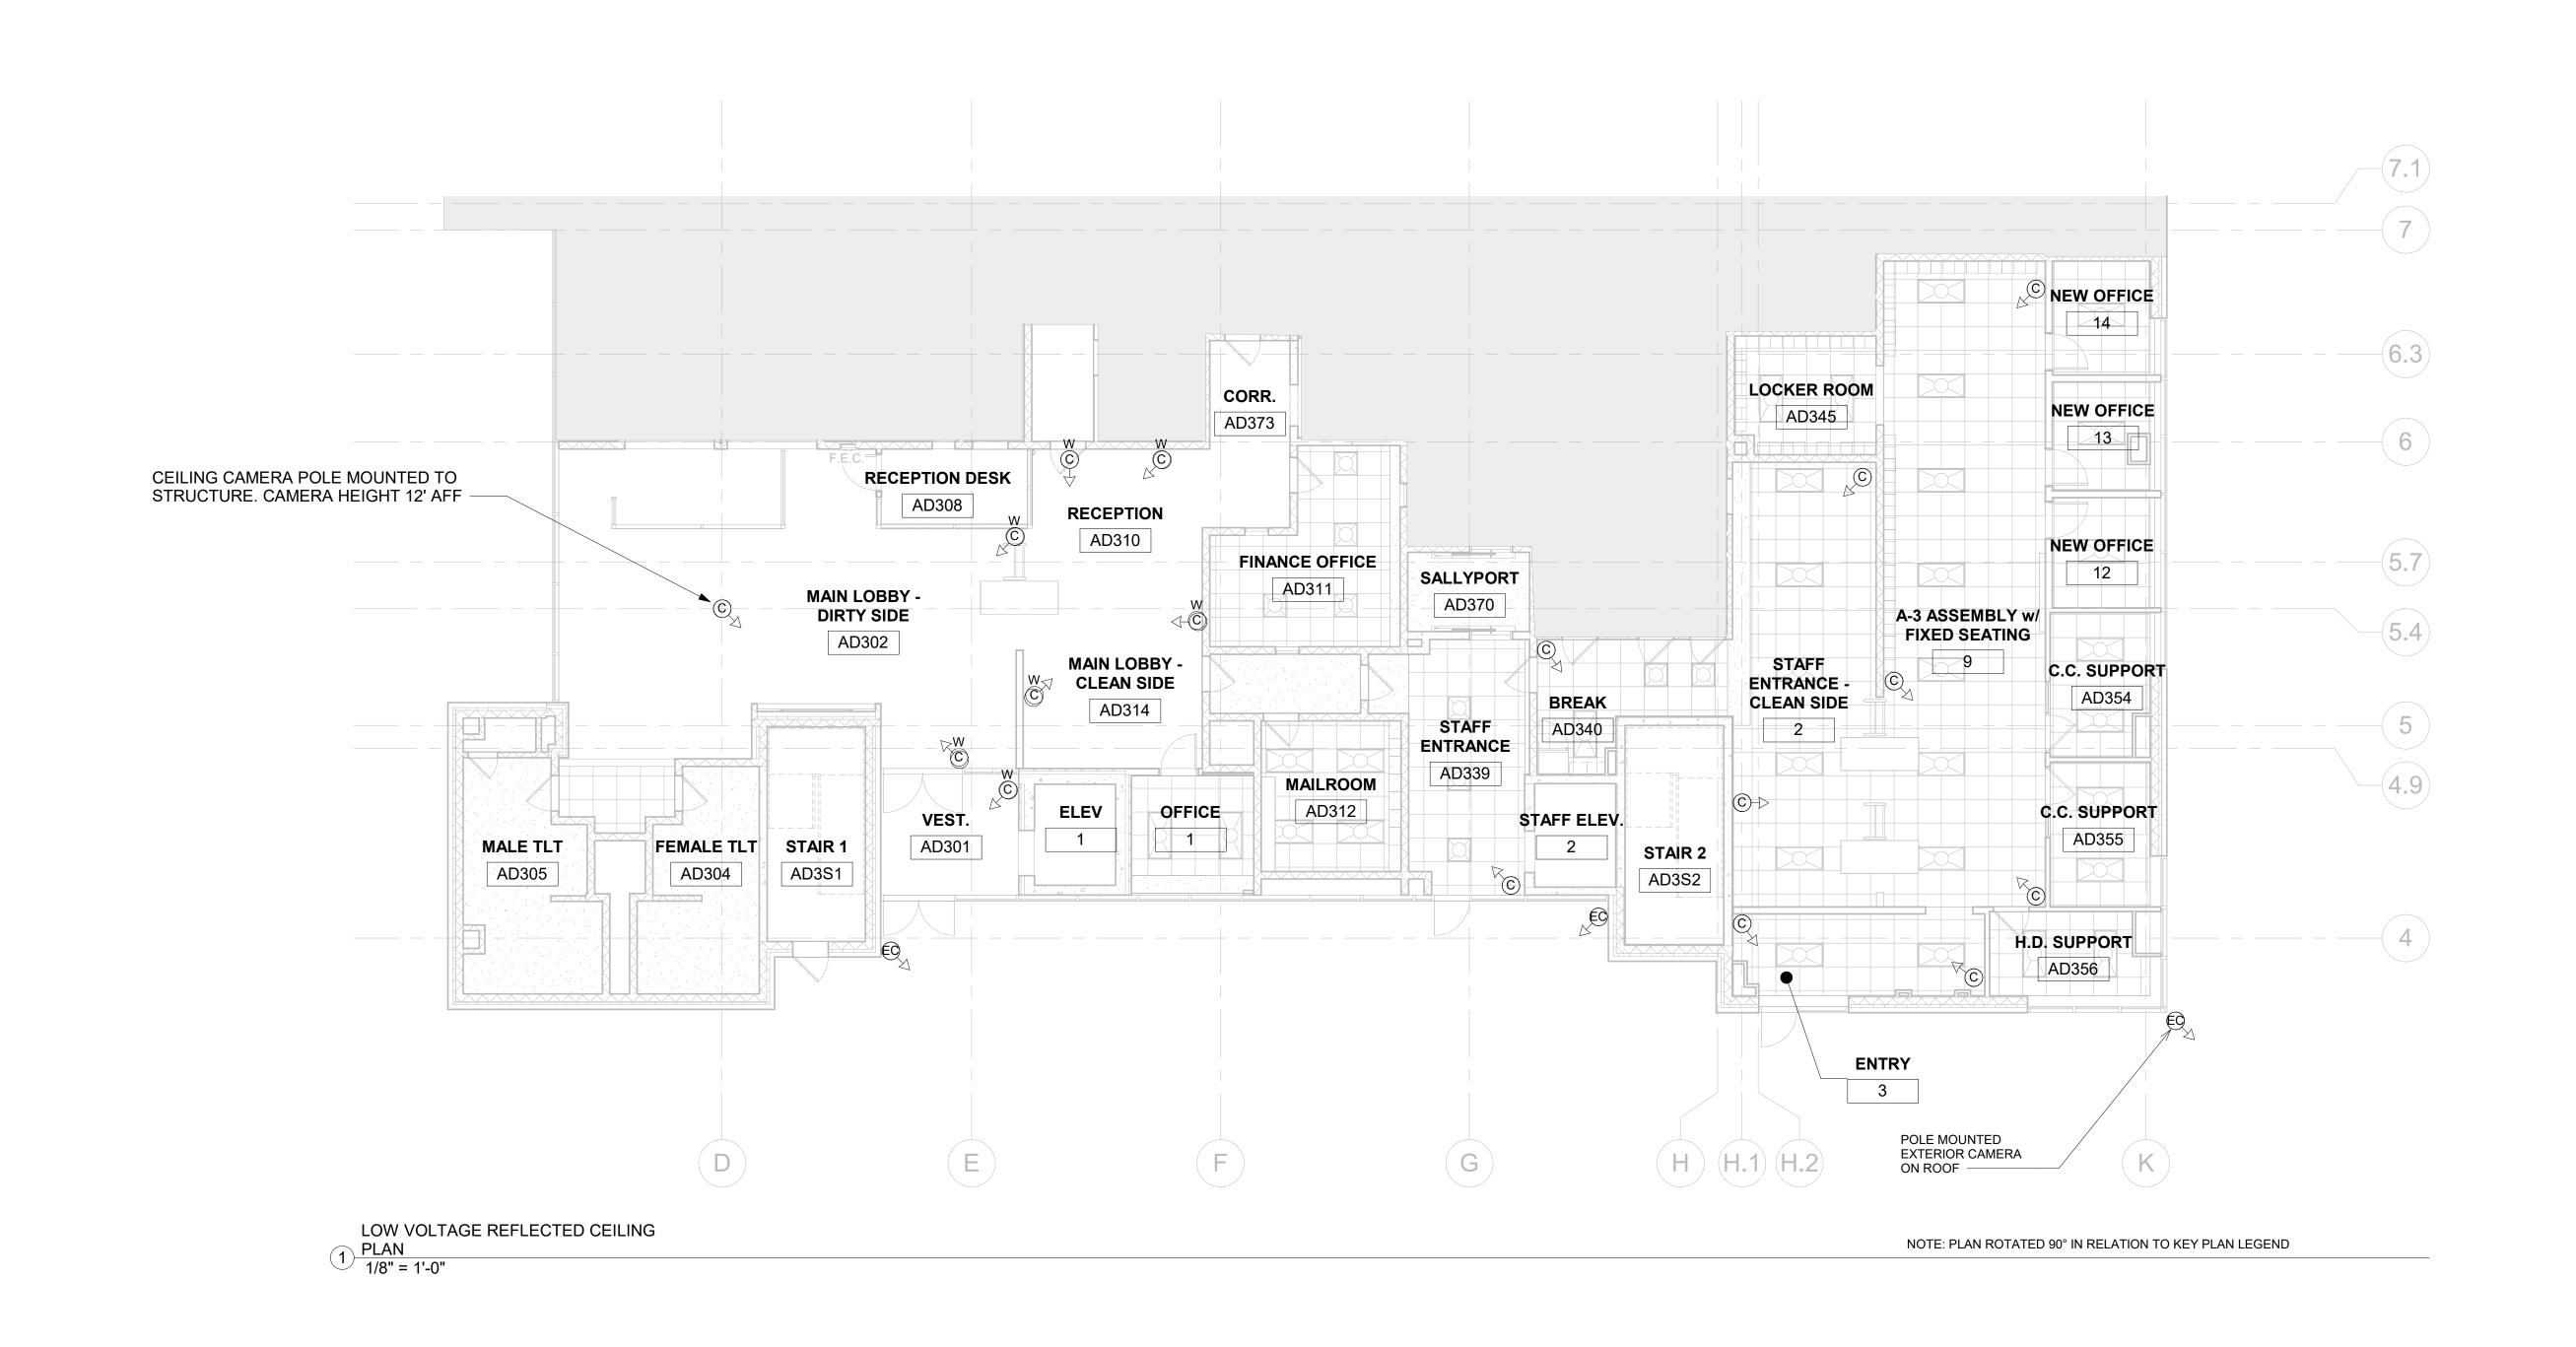

SUBDIVISION: TOWSON

KEY PLAN LEGEND

BALTIMORE COUNTY OFFICE OF BUDGET AND FINANCE - PROPERTY MANAGEMENT
BCDC LOBBY RENOVATIONS


LOW VOLTAGE REFLECTED CEILING PLAN

RENOVATION

720 BOSLEY AVENUE, TOWSON, MD 21204

	D
SHEET DESIGNATION	CONTRACT NUMBER
TA120	25122PO0
NORE	JOB ORDER NUMBER
	PROJ-10001187
	SHEET 37 OF 60
	DRAWING NUMBER
MARVIAND	2025 - 2148
	FILE NO.:

SEAL	PROFESSIONAL CERTI	PROFESSIONAL CERTIFICATION			BY DATE	P.W.A. NO.	KEY SHEET	POSITION SH	T DRAWING	SCALE	PROPERTY MANAGEMENT	
		I HEREBY CERTIFY THAT THESE DOCUMENTS WERE PREPARED OR APPROVED BY ME, AND THAT I AM A DULY LICENSED					NNW	41NE2	PLAN SCALE:	As indicated	APPROVED BY:	
	PROFESSIONAL ARCHITECT UNDER THE LAWS OF THE STATE OF MARYLAND. LICENSE NO, EXPIRATION DATE					R.O.W NO.					PROPERTY MANA	
			CONTRACT COMPLETION BOX					PROFILE SCALE:		DATE:		
	ARCHITECT:	DGN BY: BW	BUREAU OF ENGINEERING AND CONSTRUCTION	TRAFFIC	HIGHWAYS	STRUCTURES	STORM DRAINS	SEWER	WATER	FIELD ENGINEER		
	AS-BUILT PER RECORD PRINT	DWN BY: JM	REVIEWED BY:									
D.188	BY:	CHKD BY: BH	DATE REVIEWED:									

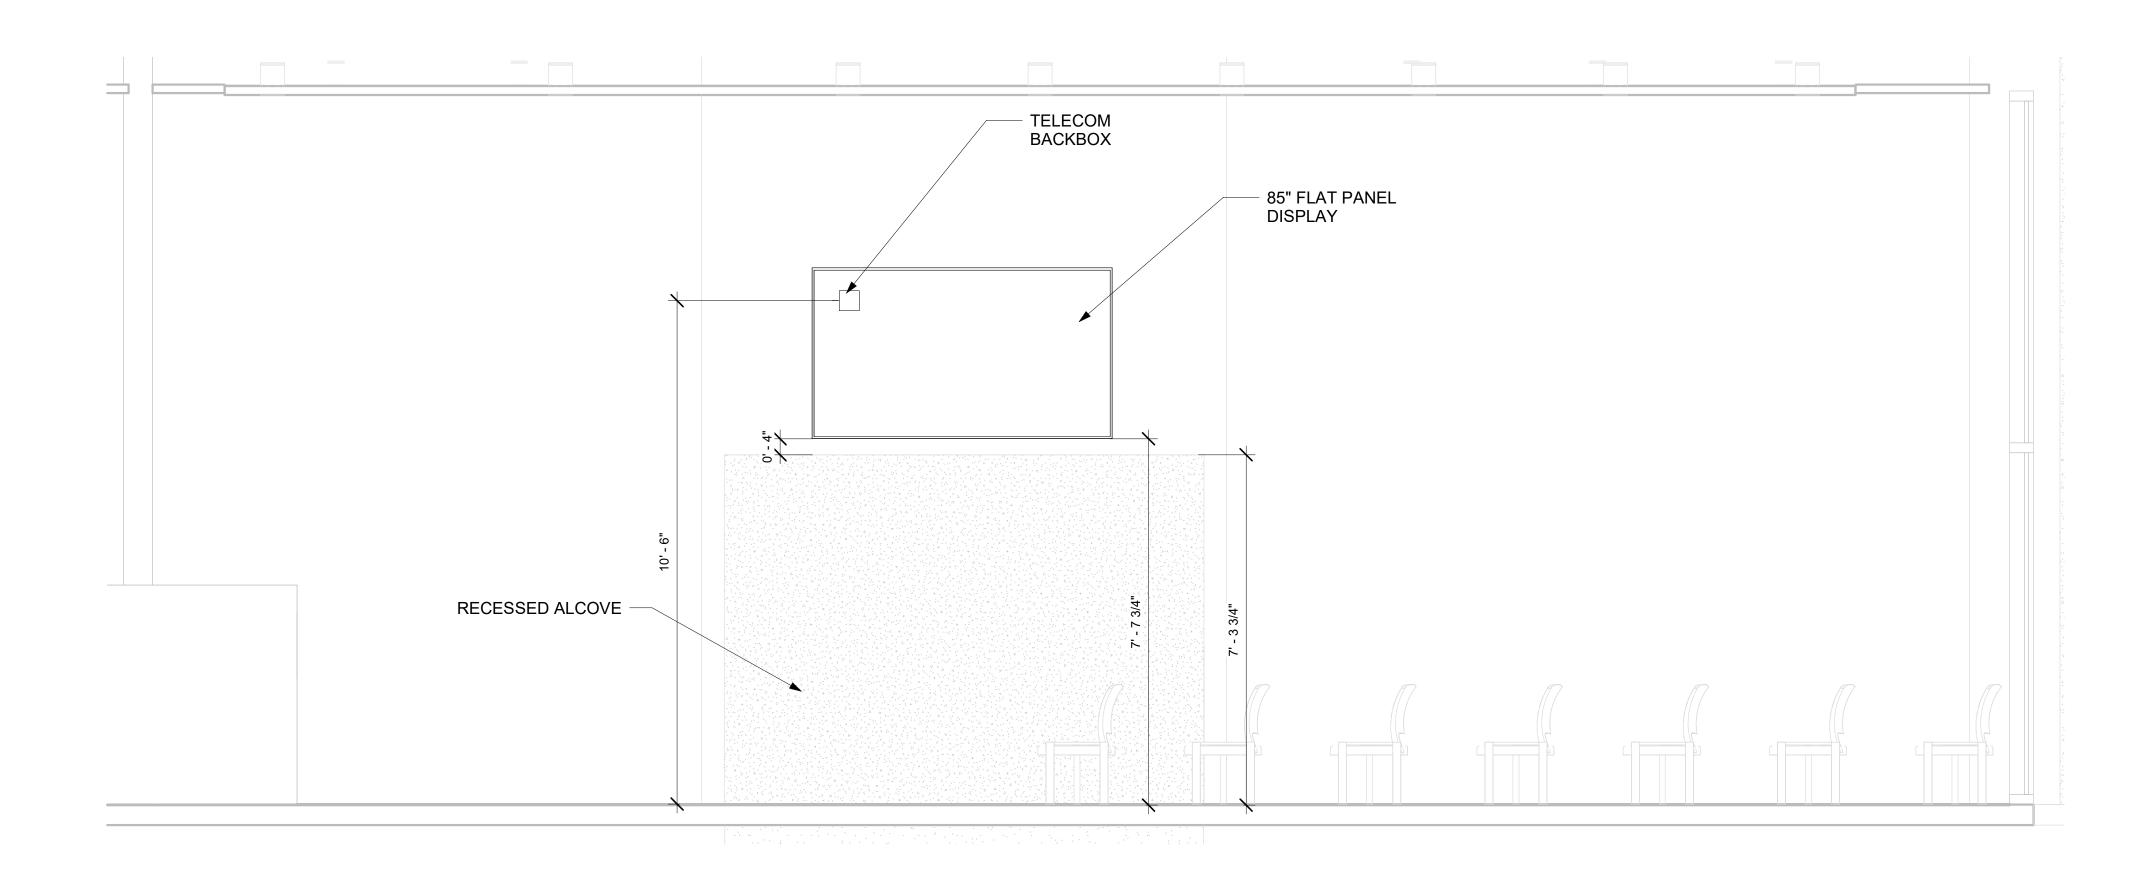

1 LOBBY DISPLAY ELEVATION 1/2" = 1'-0"

SEAL

AS-BUILT / REVISION BY DATE P.W.A. NO. KEY SHEET POSITION SHT DRAWING SCALE PROFESSIONAL CERTIFICATION PROPERTY MANAGEMENT 41NE2 PLAN SCALE: 1/2" = 1'-0" APPROVED BY:____ HEREBY CERTIFY THAT THESE DOCUMENTS WERE PREPARED OR APPROVED BY ME, AND THAT I AM A DULY LICENSED R.O.W NO. PROPERTY MANAGER PROFESSIONAL ARCHITECT UNDER THE LAWS OF THE STATE OF MARYLAND. LICENSE NO. PROFILE SCALE: CONTRACT COMPLETION BOX BUREAU OF ENGINEERING AND CONSTRUCTION TRAFFIC HIGHWAYS STRUCTURES STORM DRAINS SEWER WATER FIELD ENGINEED REVIEWED BY: AS-BUILT PER RECORD PRINT SUBDIVISION: TOWSON DATE REVIEWED:

BALTIMORE COUNTY OFFICE OF BUDGET AND FINANCE - PROPERTY MANAGEMENT BCDC LOBBY RENOVATIONS

FLAT PANEL DISPLAY ELEVATION DETAILS

RENOVATION 720 BOSLEY AVENUE, TOWSON, MD 21204

ELECTION DIST. NO.: 9C6

TA200
* * * * * * * * * * * * * * * * * * *

SHEET DESIGNATION CONTRACT NUMBER 25122PO0 JOB ORDER NUMBER PROJ-10001187 SHEET **38** OF **60** DRAWING NUMBER 2025 - 2149 FILE NO.:

AS-BUILT / REVISION BY DATE P.W.A. NO. KEY SHEET POSITION SHT DRAWING SCALE PROFESSIONAL CERTIFICATION PROPERTY MANAGEMENT HEREBY CERTIFY THAT THESE DOCUMENTS WERE PREPARED 41NE2 PLAN SCALE: 3" = 1'-0" OR APPROVED BY ME, AND THAT I AM A DULY LICENSED R.O.W NO. PROPERTY MANAGER PROFESSIONAL ARCHITECT UNDER THE LAWS OF THE STATE OF MARYLAND. PROFILE SCALE: CONTRACT COMPLETION BOX BUREAU OF ENGINEERING AND CONSTRUCTION TRAFFIC HIGHWAYS STRUCTURES STORM DRAINS SEWER WATER FIELD ENGINEED REVIEWED BY: DATE REVIEWED:

TYPICAL TELECOM INFRASTRUCTURE

DETAILS

3" = 1'-0"

SUBDIVISION: TOWSON

RENOVATION 720 BOSLEY AVENUE, TOWSON, MD 21204

LOW VOLTAGE SYSTEMS INFRASTRUCTURE DETAILS (1 OF 2)

SHEET DESIGNATION | CONTRACT NUMBER 25122PO0 JOB ORDER NUMBER PROJ-10001187 SHEET **39** OF **60** DRAWING NUMBER 2025 - 2150

BCDC LOBBY RENOVATIONS

TA500

BALTIMORE COUNTY OFFICE OF BUDGET AND FINANCE - PROPERTY MANAGEMENT

TYPICAL DISPLAY INFRASTRUCTURE

DETAIL

3" = 1'-0"

ONE (1) 1" EC TO ACCESSIBLE CABLE MANAGEMENT SYSTEM

TELECOMMUNICATIONS


OUTLET

			PASS-THRU SLEEVE	UCTURE
CORRIDOR CABLE — TRAY SYSTEM		CORRIDOR	TERMINATE ALL CONDUITS WITH PLASTIC BUSHINGS IN ACCESSIBLE CEILING SPACE CEIL	L ING
			ONE (1) 3/4" EC TO ACCESSIBLE CABLE MANAGEMENT SYSTEM	
			ONE (1) 1" EC TO ACCESSIBLE CABLE MANAGEMENT SYSTEM	
	ONE (1) 1-1/4" EC TO ACCESSIBLE CABLE MANAGEMENT SYSTEM		TYPICAL WALL PHONE OUTLET	
			STANDARD TELECOM OUTLET	
			TELECOM FLOORBOX	ELOOR
			- MAINTAIN BEND RADII PER 270000	7 · · · · · · · · · · · · · · · · · · ·

J-HOOK SUPPORTS

ELECTION DIST. NO.: 9C6

CEILING

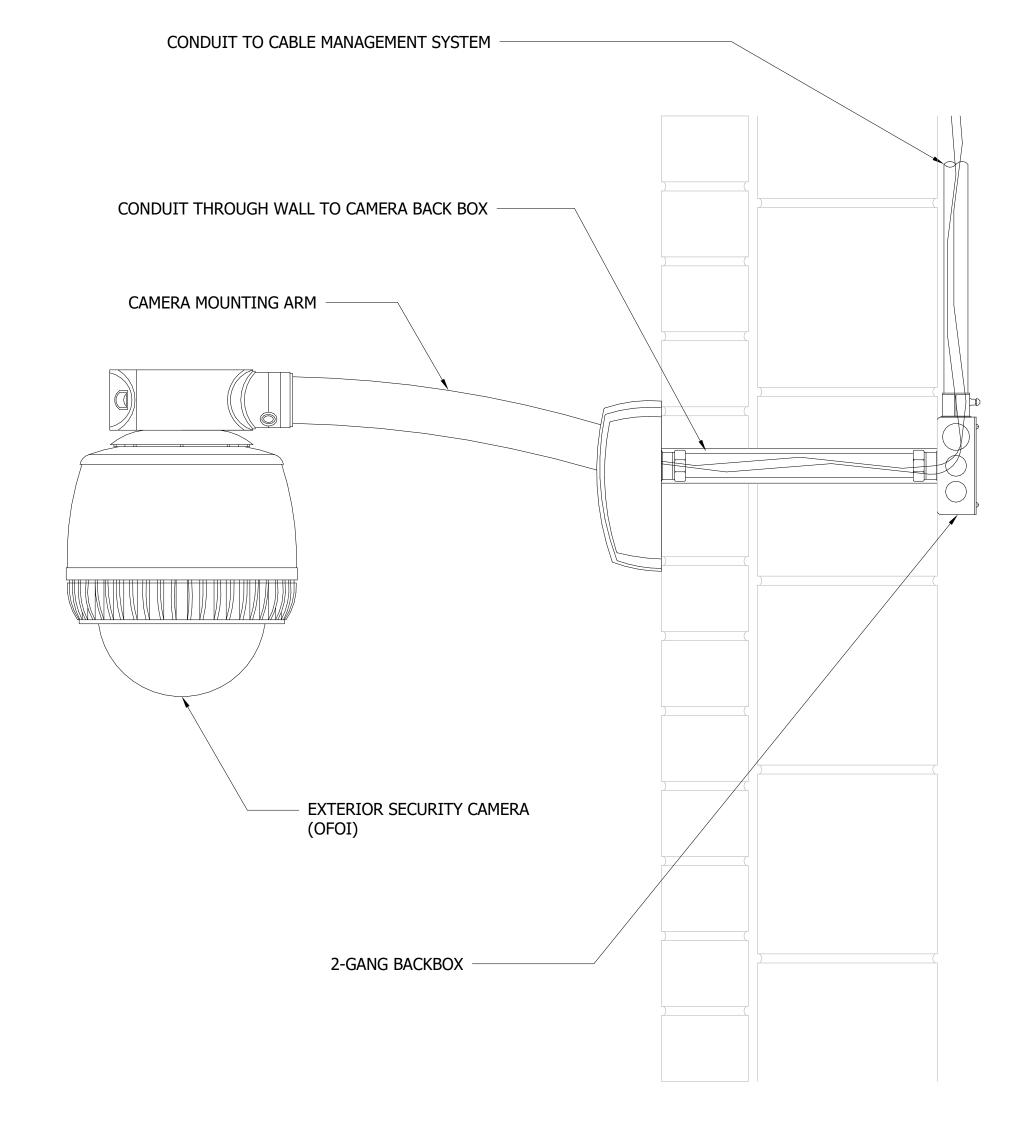


WALL MOUNTED SECURITY CAMERA 2-GANG BACKBOX

WALL MOUNTED CAMERA

2 INFRASTRUCTURE DETAILS 3" = 1'-0"

SECURITY CAMERA CABLING TO CABLE MANAGEMENT SYSTEM

CONDUIT TO CABLE MANAGEMENT SYSTEM

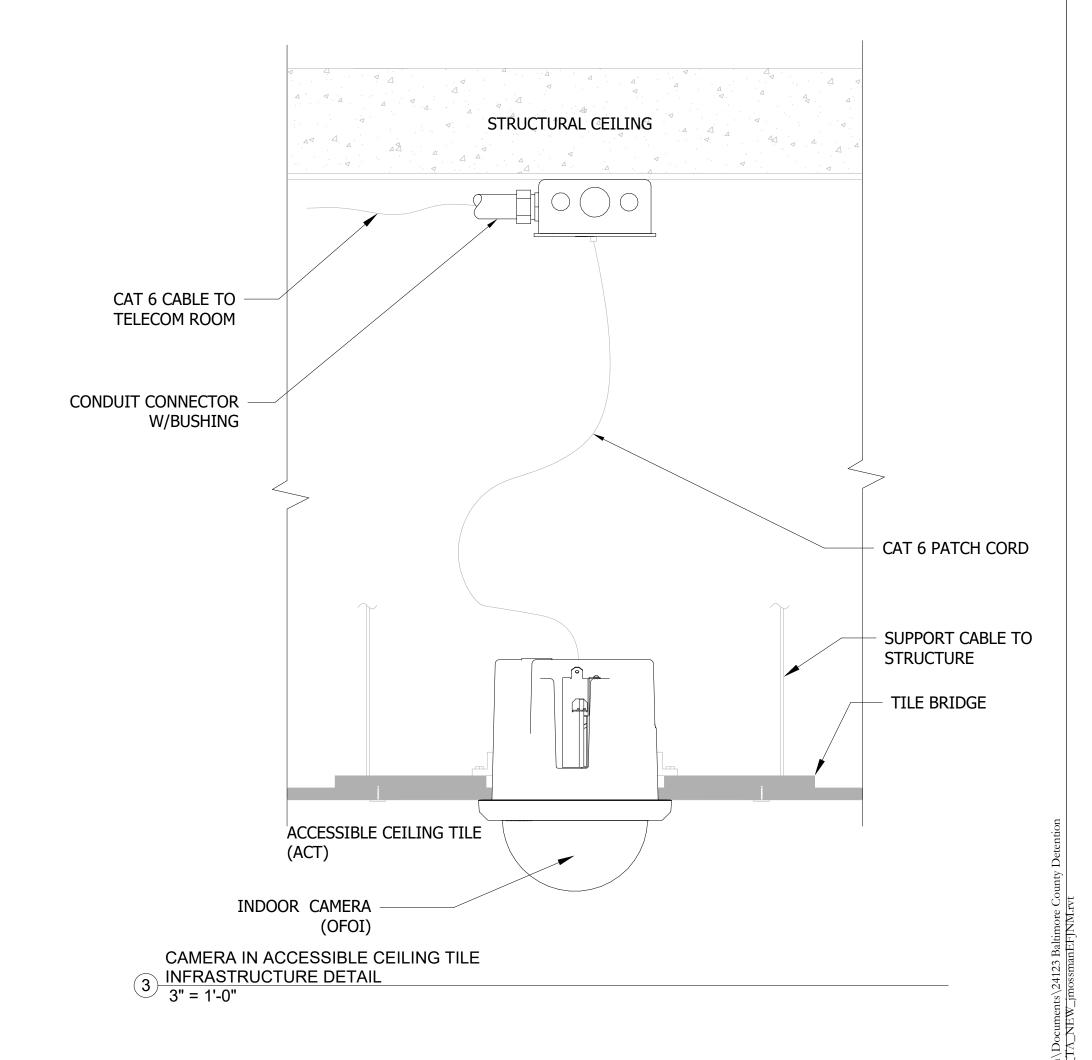

EXTERIOR CAMERA WITH MOUNTING

AS-BUILT / REVISION BY DATE P.W.A. NO. KEY SHEET POSITION SHT DRAWING SCALE PROFESSIONAL CERTIFICATION PROPERTY MANAGEMENT SEAL 41NE2 | PLAN SCALE: 3" = 1'-0" HEREBY CERTIFY THAT THESE DOCUMENTS WERE PREPARED OR APPROVED BY ME, AND THAT I AM A DULY LICENSED R.O.W NO. PROPERTY MANAGER PROFESSIONAL ARCHITECT UNDER THE LAWS OF THE STATE OF MARYLAND. PROFILE SCALE: CONTRACT COMPLETION BOX BUREAU OF ENGINEERING AND CONSTRUCTION TRAFFIC HIGHWAYS STRUCTURES STORM DRAINS SEWER WATER FIELD ENGINEE REVIEWED BY: AS-BUILT PER RECORD PRINT

DATE REVIEWED:

BCDC LOBBY RENOVATIONS LOW VOLTAGE SYSTEMS INFRASTRUCTURE DETAILS (2 OF 2)

BALTIMORE COUNTY OFFICE OF BUDGET AND FINANCE - PROPERTY MANAGEMENT

ELECTION DICT NO. 000	
ELECTION DIST. NO.: 9C6	\


SHEET DESIGNATION | CONTRACT NUMBER 25122PO0 JOB ORDER NUMBER PROJ-10001187 SHEET 40 OF 60 DRAWING NUMBER 2025 - 2151


RENOVATION


SUBDIVISION: TOWSON

720 BOSLEY AVENUE, TOWSON, MD 21204

TA501

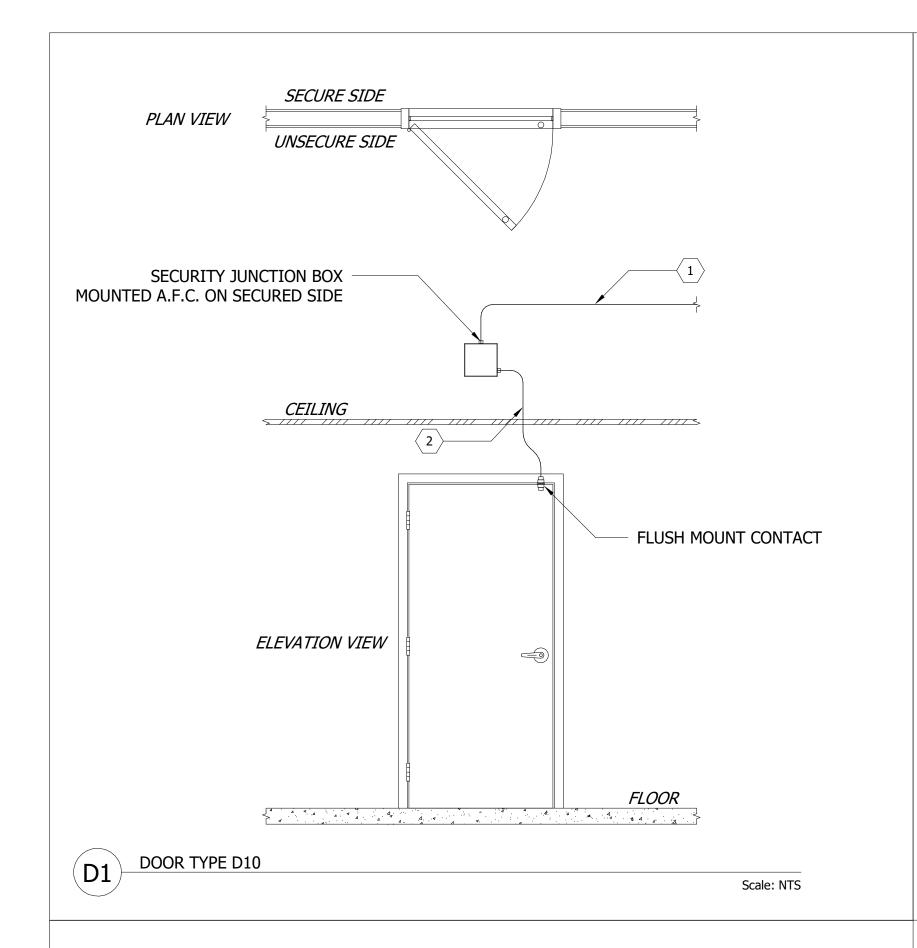

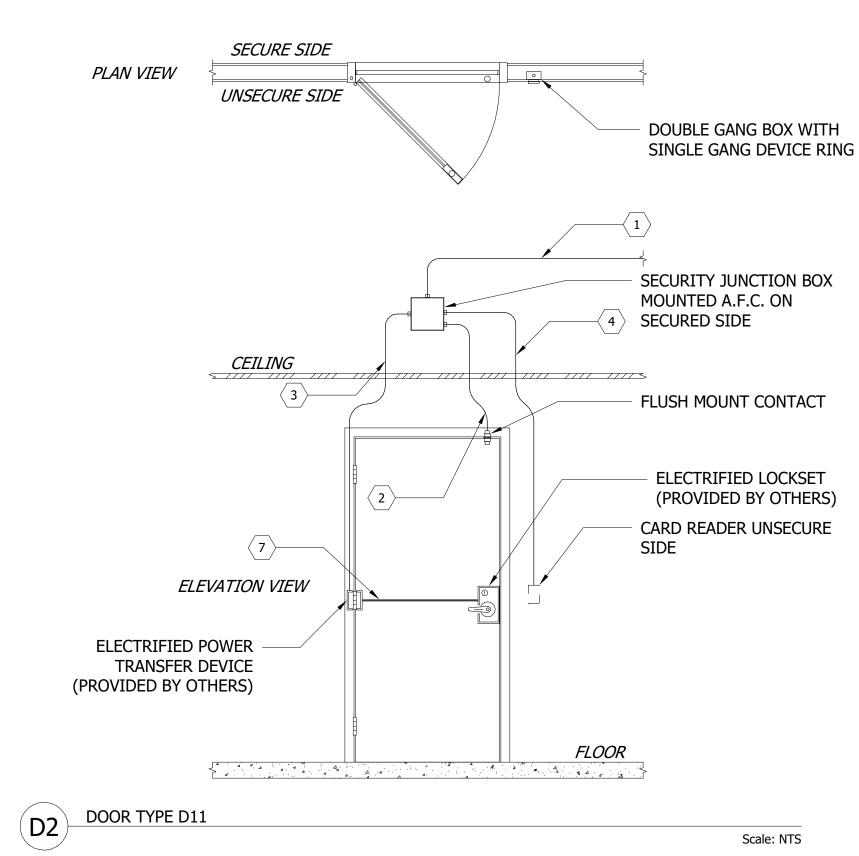

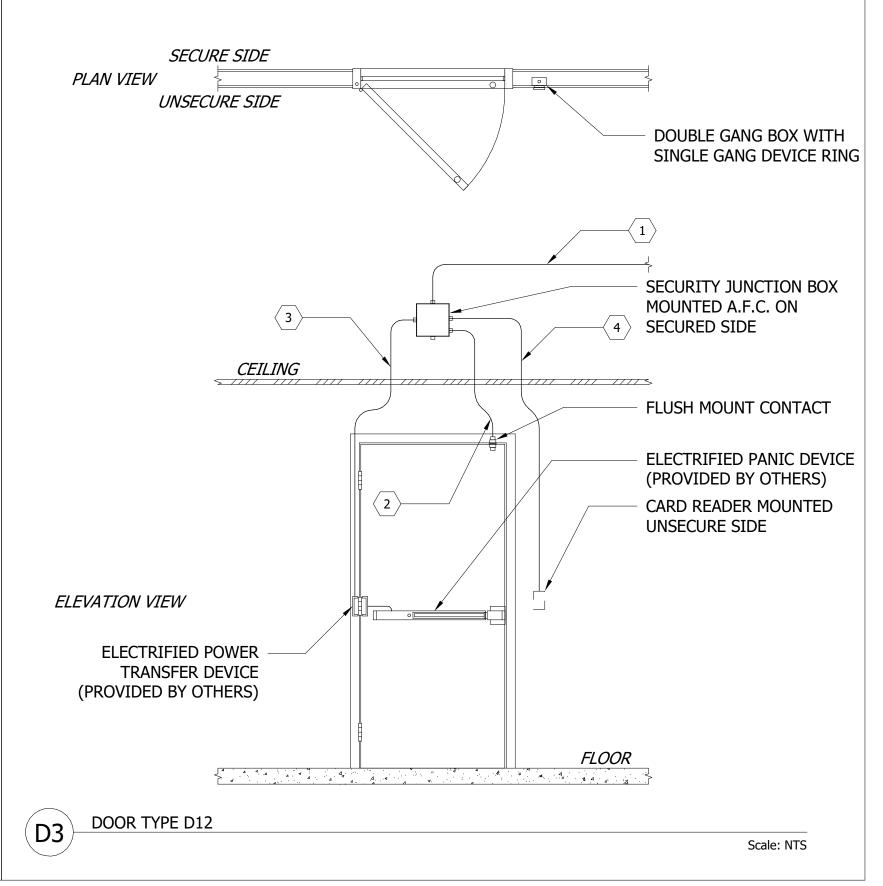

KEY LEGEND

- = ONE (1) 1" EC FROM SECURITY JUNCTION BOX TO ACCESS CONTROL
- 2 = ONE (1) 3/4" EC FROM SECURITY JUNCTION BOX TO DOOR CONTACT MOUNT LOCATION.
- 3 = ONE (1) 3/4" EC FROM SECURITY JUNCTION BOX STUBBED BEHIND DOOR FRAME TO ELECTRIFIED POWER TRANSFER DEVICE.
- = DOUBLE GANG BOX WITH SINGLE GANG DEVICE RING MOUNTED 42" A.F.F. WITH ONE (1) 3/4" TO SECURITY JUNCTION BOX.
- = DOUBLE GANG BOX WITH SINGLE GANG DEVICE RING MOUNTED 42" A.F.F. WITH ONE (1) 3/4" TO ADJACENT DOUBLE GANG BOX.
- = AUTOMATIC DOOR OPERATOR (PROVIDED BY OTHERS).
- = ONE (1) 3/8" CORE DRILL THROUGH DOOR TO LOCKSET. (PROVIDED BY OTHERS).

ELECTRONIC ACCESS CONTROL DOOR SCHEDULE								
Hardware	ardware Door Integrated Card						Card Reader	Card Reader
Set	Door Type	Number	Single/Double	Auto Operator	Reader	Door Contact	(Secure Side)	(Unsecure Side)
	D	084	Single	No	No	Yes	Yes	Yes
	D D	084 1	Single Single	No No	No No	Yes Yes	Yes Yes	Yes Yes

Grand total: 3

ELECTRONIC ACCESS CONTROL DOOR

1 DETAILS 1/2" = 1'-0"

SEAL

	.,,2											
	PROFESSIONAL CERTIFICATION		AS-BUILT / REV	ISION	BY DATE	P.W.A. NO.	KEY SHEET	POSITION SHT	DRAWING	SCALE	PROPERTY MANAGEMENT	
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			CONTRACT COMPLETIO	N BOX					PROFILE SCALE:		DATE:	
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	AS-BUILT PER RECORD PRINT	DWN BY: JM	REVIEWED BY:									
	BY: DATE:	CHKD BY: BH	DATE REVIEWED:									SUBDIVISION: TOWSON

BALTIMORE COUNTY OFFICE OF BUDGET AND FINANCE - PROPERTY MANAGEMENT BCDC LOBBY RENOVATIONS

ELECTRONIC ACCESS CONTROL DOORS

RENOVATION

ELECTION DIST. NO.: 9C6 720 BOSLEY AVENUE, TOWSON, MD 21204

